
HOMESTEAD ROAD SAFETY IMPROVEMENTS PROJECT 12-19 CITY OF LOS ALTOS, CALIFORNIA

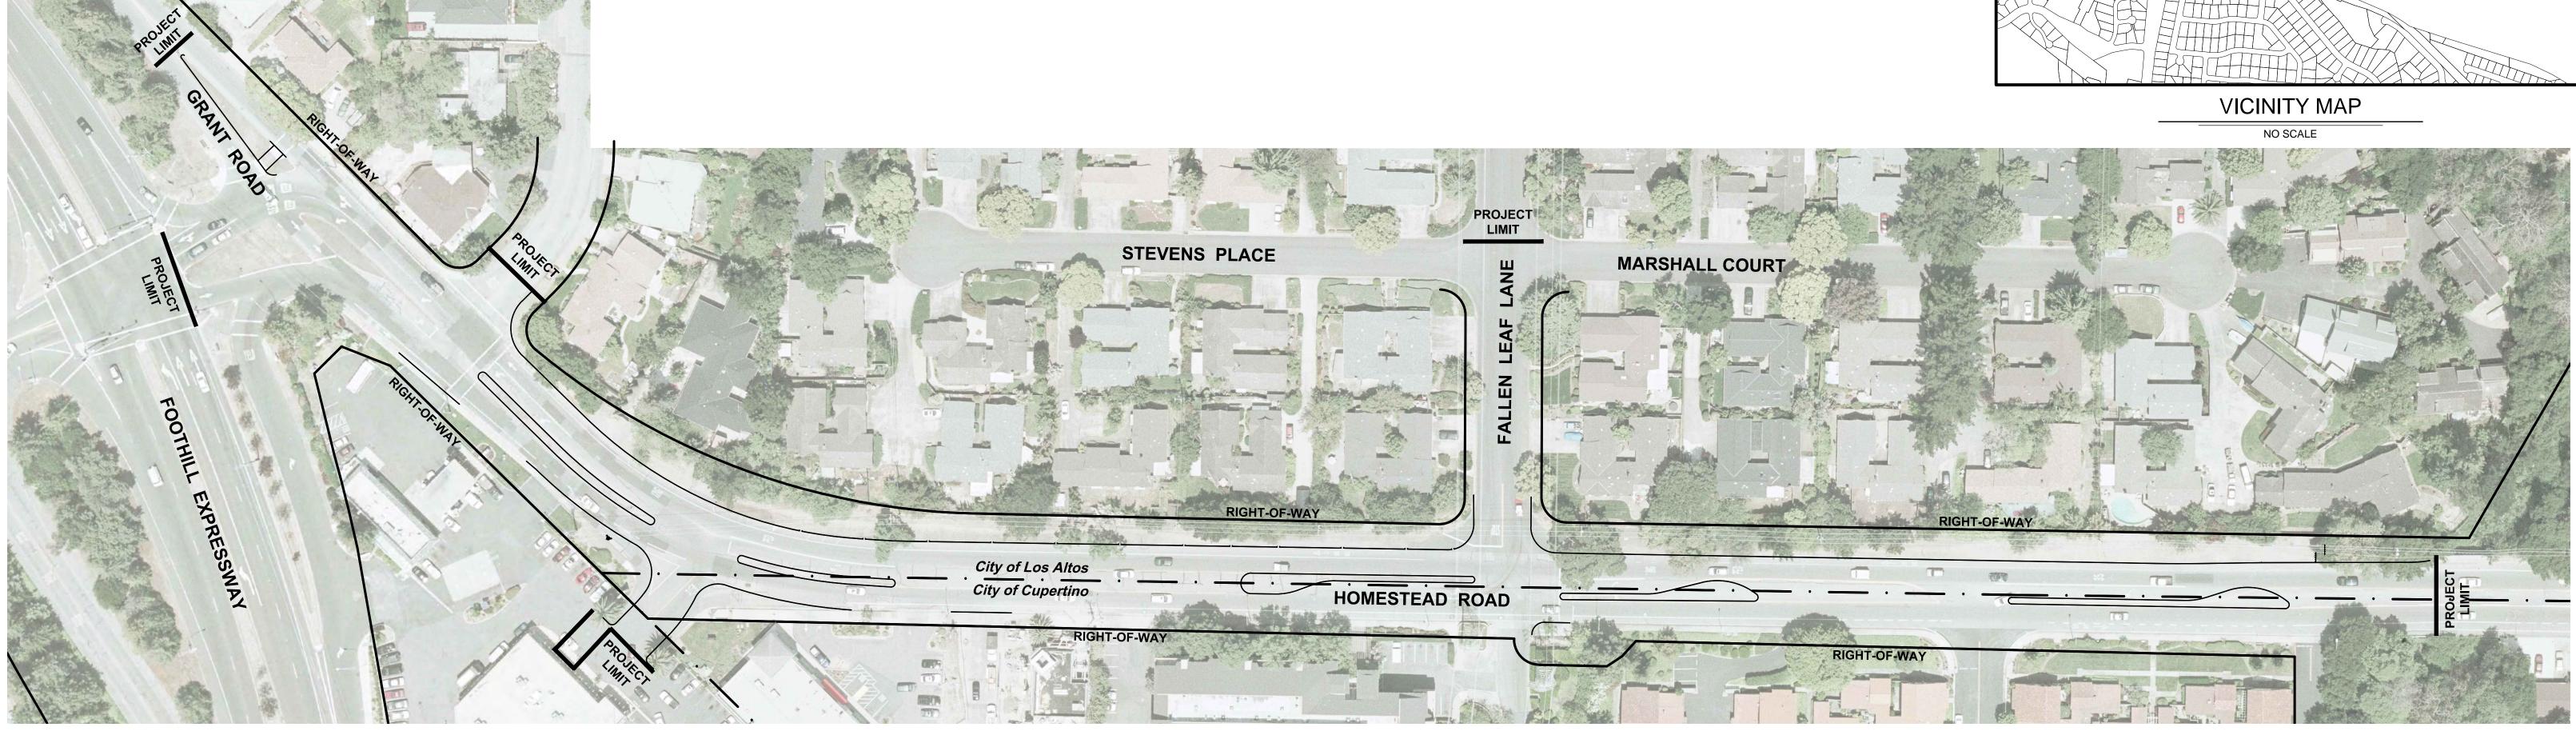

ABBREVIATIONS

C	BEGINNING OF CURVE
WY	DRIVEWAY
C	END OF CURVE
C	EDGE OFPAVEMENT
X	EXISTING
	FLOWLINE
ND	GROUND
DPE	HIGH DENSITY POLYETHYLENE PIPE
P	HIGH POINT
V	INVERT ELEVATION
-	LINEAR FEET
H WIRE	OVERHEAD WIRE
٩V	PAVEMENT
CC	PORTLAND CEMENT CONCRETE
ED	PEDESTRIAN
2	POWER POLE
RC	POINT OF REVERSE CURVATURE
CP	REINFORCED CONCRETE PIPE
P	RADIUS POINT
W	RIGHT OF WAY
D	STORM DRAIN
S	SANITARY SEWER
NK	SIDEWALK
3	TOP OF BERM
VC	TOP OF VERTICAL CURB
C	TOP OF CURB
1	WATER

	LEGEND
DESCRIPTION	EXISTING
WATER LINE	— w — — w —
WATER VALVE	\bowtie
FIRE HYDRANT	Q
FENCE	-00
STORM DRAIN	S D
GAS LINE	G
ELECTRIC LINE OVERHEAD	P
ELECTRIC LINE UNDERGROUND	— — E — —
MANHOLE	0
STORM DRAIN INLET	in the second seco
CURB	
CURB & GUTTER	
CURVE LABEL	
SURVEY CONTROL POINT	🕂 OR 🔺
STREET LIGHT	•—X
HANDICAP RAMP	
POWER POLE	ص
CITY LIMITS	_ · · · _
PACIFIC BELL MANHOLE	6

DRAWN	DESIGNED	HORIZONTAL SCALE	ENGINEER OF RECORD	PREPARED BY:					RΕV	ISIONS			NTOS .	
LW Checked LS	JS DATE CHECKED NOV. 28, 2012	1"=60' VERTICAL SCALE		RA	NO.	DATE	E B	3Y	DES	CRIPTION	APPR	DATE		
APPROVED		CONTRACT NO.		RUGGERI-JENSEN-AZAR ENGINEERS • PLANNERS • SURVEYORS 8055 CAMINO ARROYO PHONE: (408) 848-0300 FAX: (408) 848-0302									D A A	
ENGINEER	DATE												HELLAN F	PREPARED


LOCATION MAP

NEW

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EXISTING UTILITY NOTE:

EXISTING UNDERGROUND UTILITIES AND IMPROVEMENTS ARE SHOWN IN THEIR APPROXIMATE LOCATIONS BASED UPON RECORD INFORMATION AVAILABLE TO THE ENGINEER AT THE TIME OF PREPARATION OF THESE PLANS. LOCATIONS MAY NOT HAVE BEEN VERIFIED IN THE FIELD AND NO GUARANTEE IS MADE AS TO THE ACCURACY OR COMPLETENESS OF THE INFORMATION SHOWN. THE CONTRACTOR SHALL NOTIFY UTILITY COMPANIES AT LEAST 2 WORKING DAYS IN ADVANCE OF CONSTRUCTION TO FIELD LOCATE UTILITIES. CALL UNDERGROUND SERVICE ALERT (U.S.A.), AT 1-800-227-2600. IT SHALL BE THE RESPONSIBILITY OF THE CONTRACTOR TO DETERMINE THE EXISTENCE AND LOCATION OF UTILITIES SHOWN ON THESE PLANS, INDICATED IN THE FIELD BY LOCATING SERVICES, OR EVIDENCED BY FACILITIES VISIBLE AT OR ADJACENT TO THE JOBSITE. ANY ADDITIONAL COST INCURRED AS A RESULT OF THE CONTRACTOR'S FAILURE TO VERIFY LOCATIONS OF EXISTING UTILITIES PRIOR TO BEGINNING CONSTRUCTION SHALL BE BORNE BY THE CONTRACTOR AND IS DEEMED INCLUDED AND MERGED IN THE CONTRACT UNIT PRICE.

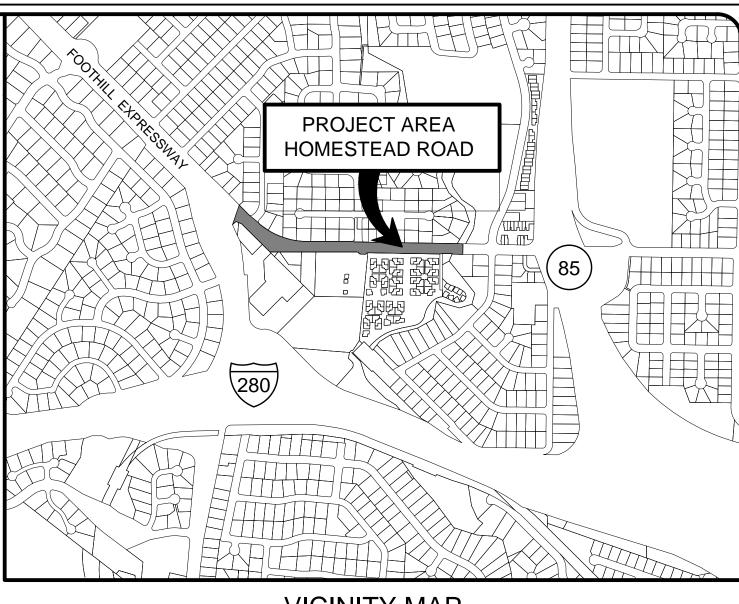


SHEET INDEX


		TRAFFIC CIONAL RUANC RREPARED RY
SHEET NO. 1 2 3 4 5 6 7 8 9 10 11 12 13 14 15 16 17 18 19 20 21	TITLE TITLE SHEET EXISTING TOPOGRAPHY & SURVEY CONTROL W. END EXISTING TOPOGRAPHY & SURVEY CONTROL E. END DEMOLITION PLAN WESTERN END DEMOLITION PLAN WESTERN END PROJECT LAYOUT WESTERN END PROJECT LAYOUT FOINT COORDINATES GRADING PLAN WESTERN END MICROSURFACING AND SIGNING AND STRIPING PLAN W. END MICROSURFACING AND SIGNING AND STRIPING PLAN E. END DETAILS SHEET BLUEPRINT FOR A CLEAN BAY E-1 TRAFFIC SIGNAL INSTALLATION E-2 TRAFFIC SIGNAL NOTES & SCHEDULES E-3 IN-ROADWAY WARNING LIGHTS L-1 IRRIGATION PLAN - WESTERN END L-2 IRRIGATION PLAN - KASTERN END L-3 PLANTING PLAN - WESTERN END L-4 PLANTING PLAN - WESTERN END	TRAFFIC SIGNAL PLANS PREPARED BY: HEXAGON TRANSPORTATION CONSULTANTS INC. 11 WEST ST. JOHN STREET, SUITE 850 SAN JOSE CALIFORNIA 951113 H (408) 971-6100LANDSCAPE PLANS PREPARED BY: BELLINGER, FOSTER & STEINMETZ 45 SHERMAN AVENUE, SUITE W PALO ALTO CALIFORNIA 93406 H (650) 326-6622
22 23–25	L-4 PLANTING PLAN – EASTERN END L-5 TO L-7 IRRIGATION DETAILS	SCALE IN FEET: 1"= 60'
	CITY OF LOS ALTOS	DRAWING NO.
HO	MESTEAD ROAD SAFETY IMPROVEMENTS PROJECT 12-19	³ 1
	TITLE SHEET	SHT 1 OF 25

ED FOR: CITY OF LOS ALTOS

25.25 RIGHT-OF-WA EX 36" W SCVWD NCE ENCE CE A Ă. Y III шш RIGHT OF - WAY <> EX 8" GAS 12.15 × 272.62 GND $\overline{}$ Ο 273.53 273.98 -272.163 N ×272.85 T- \neg 273.60 274.21 I M 274.31 × 274.19 U T × 274.58 SWL × 274.51 SWL × 274.58 ×274.65 PAV ΨШ EX 18," W × 274.87 PAV ×274.83 PAV ЧШ ×274.81 PAV EX 8 W × PAV EX 8 W ×274.82×274.88 PAV $\times^{274.80}_{PAV}$ ΣS 274.74 $\times^{273.99}_{WV} \times^{274.08}_{WV}$ 274.58 ×274.21 EX 8" SS 274.16 ×274.16 274.58 BOW TC FLUS EX AREA DRAIN ×274.48 ×274.37 DRAWN DESIGNED ORIZONTAL SCALE ENGINEER OF RECORD PREPARED BY: LW 1"=20' JS DATE CHECKED VERTICAL SCALE CHECKED LS NOV. 28, 2012 APPROVED **RUGGERI-JENSEN-AZAR** ENGINEERS ■ PLANNERS ■ SURVEYORS CONTRACT NO. 8055 CAMINO ARROYO GILROY, CA 95020 PHONE: (408) 848–0300 FAX: (408) 848–0302 DATE ENGINEER

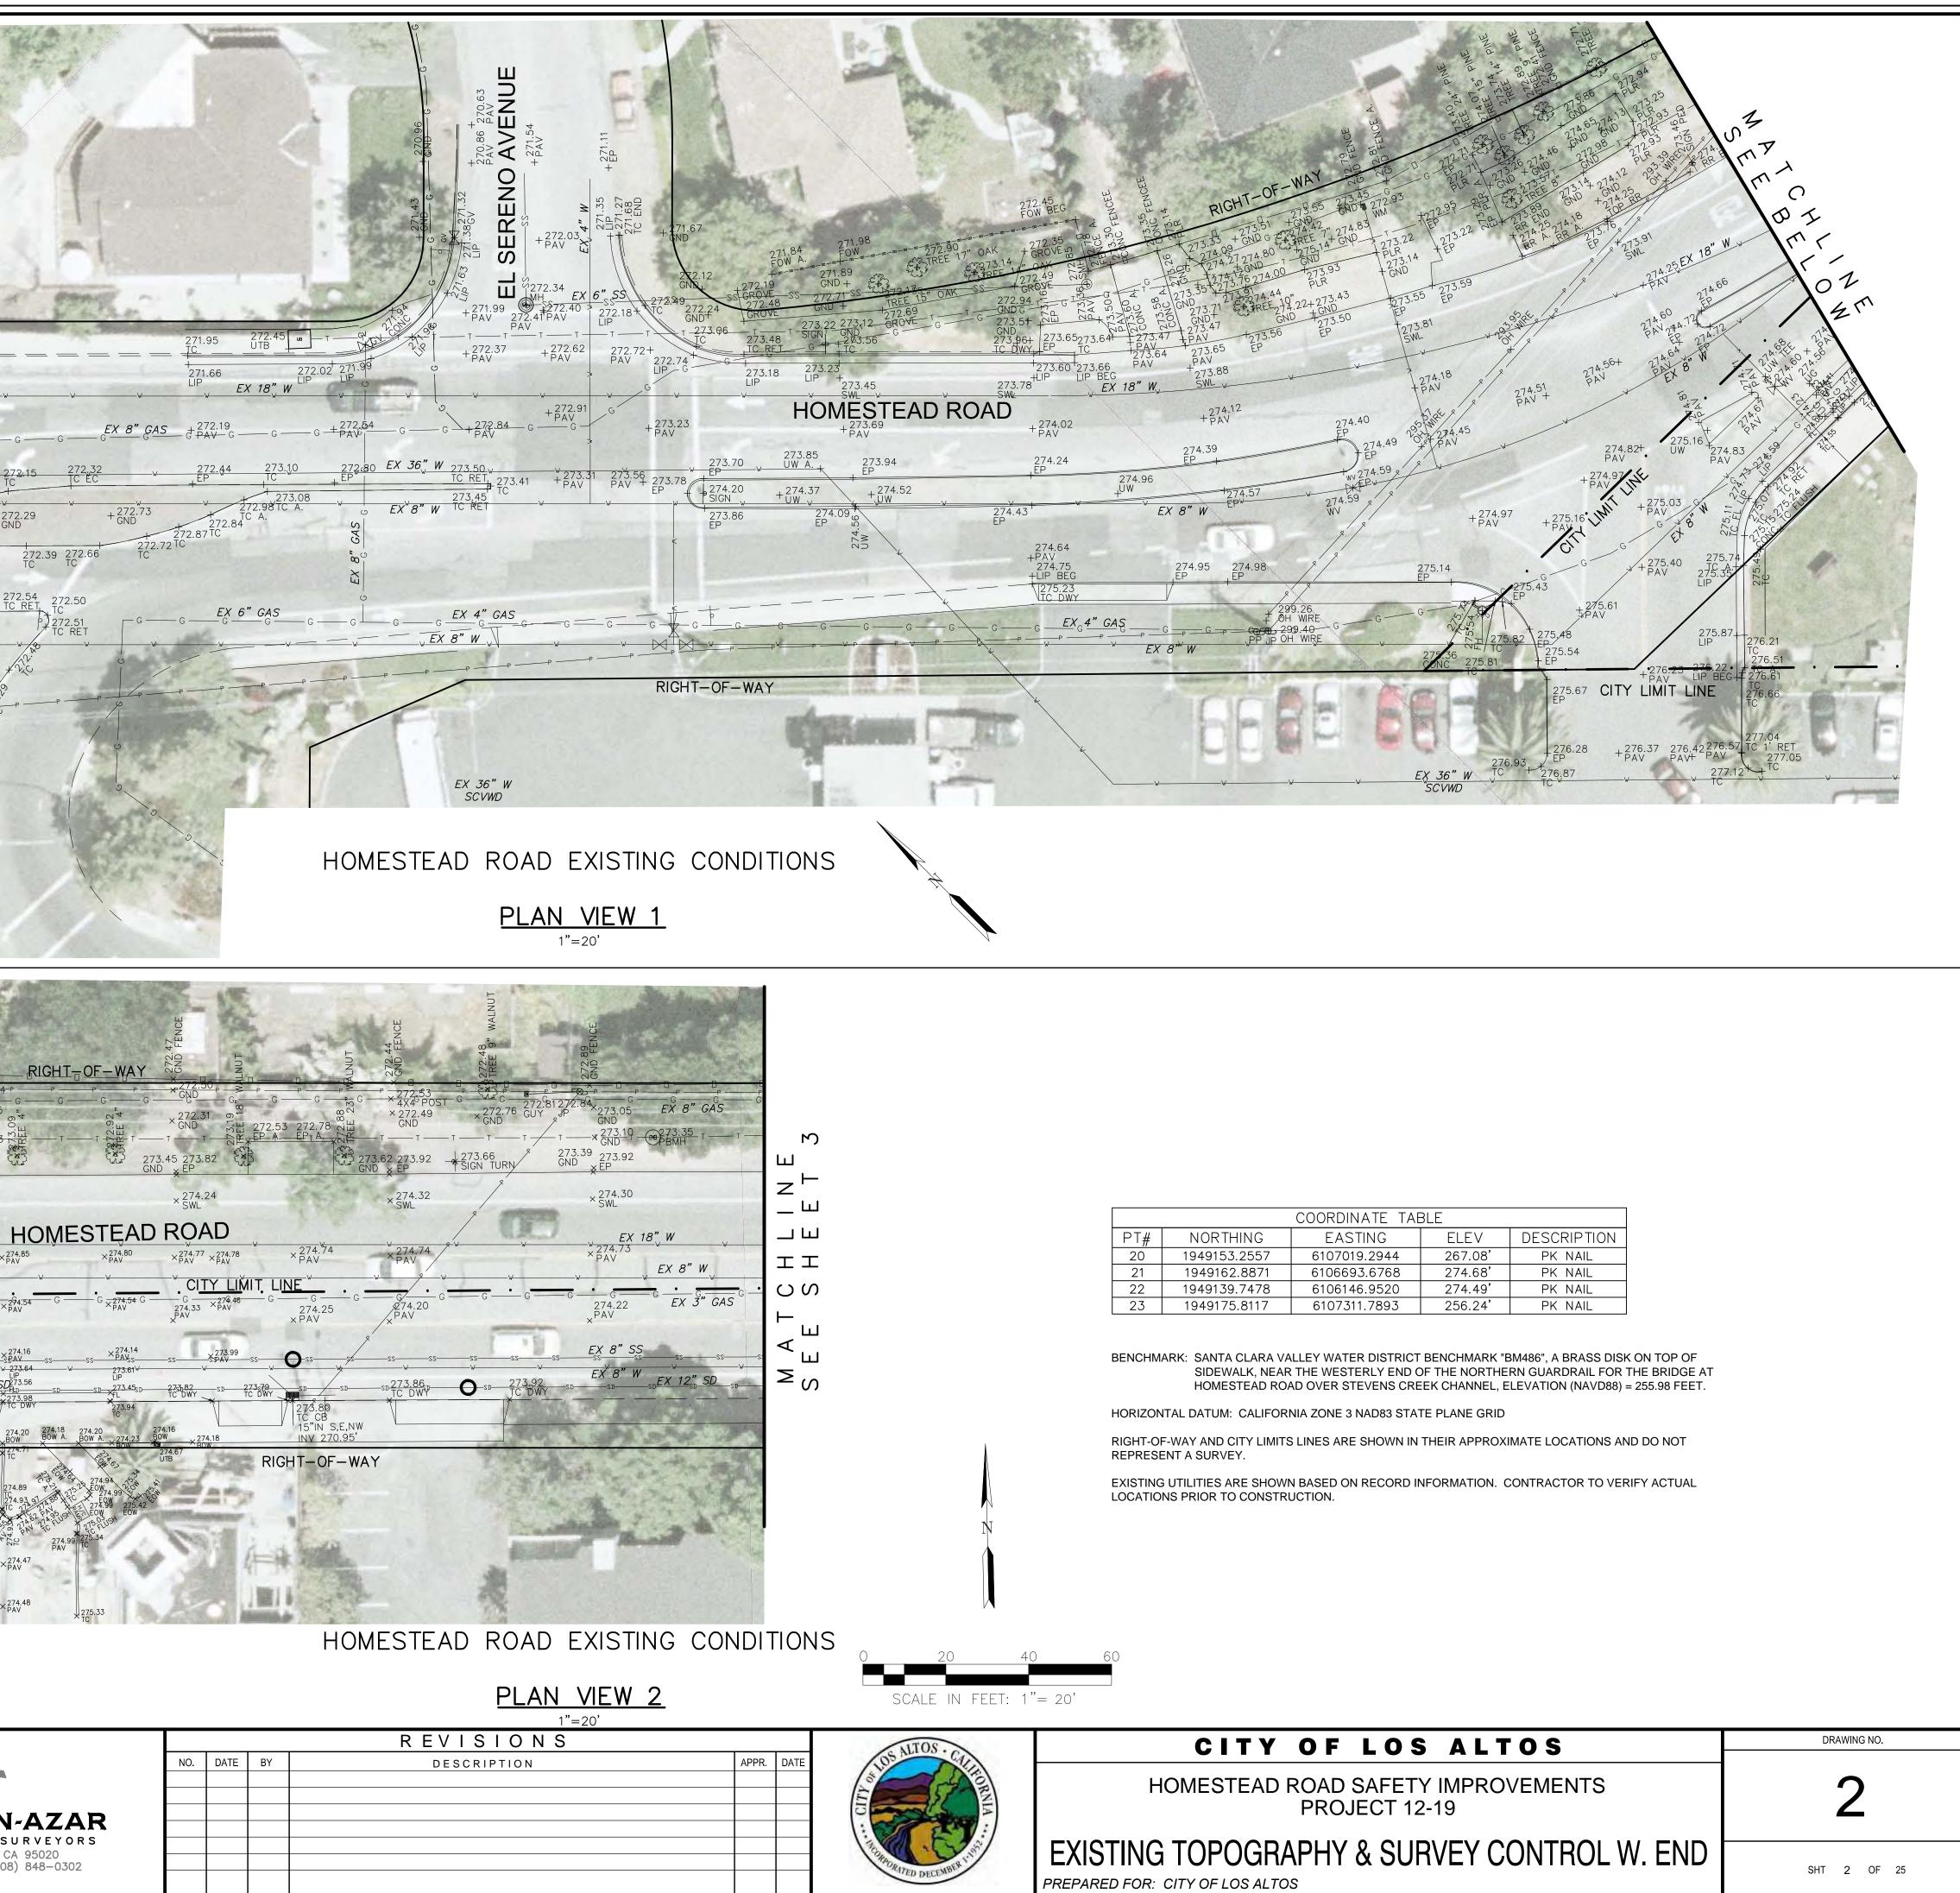

COORDINATE TABLE								
PT#	NORTHING	EASTING	ELEV	DESCRIPTION				
20	1949153.2557	6107019.2944	267.08'	PK NAIL				
21	1949162.8871	6106693.6768	274.68'	PK NAIL				
22	1949139.7478	6106146.9520	274.49'	PK NAIL				
23	1949175.8117	6107311.7893	256.24'	PK NAIL				

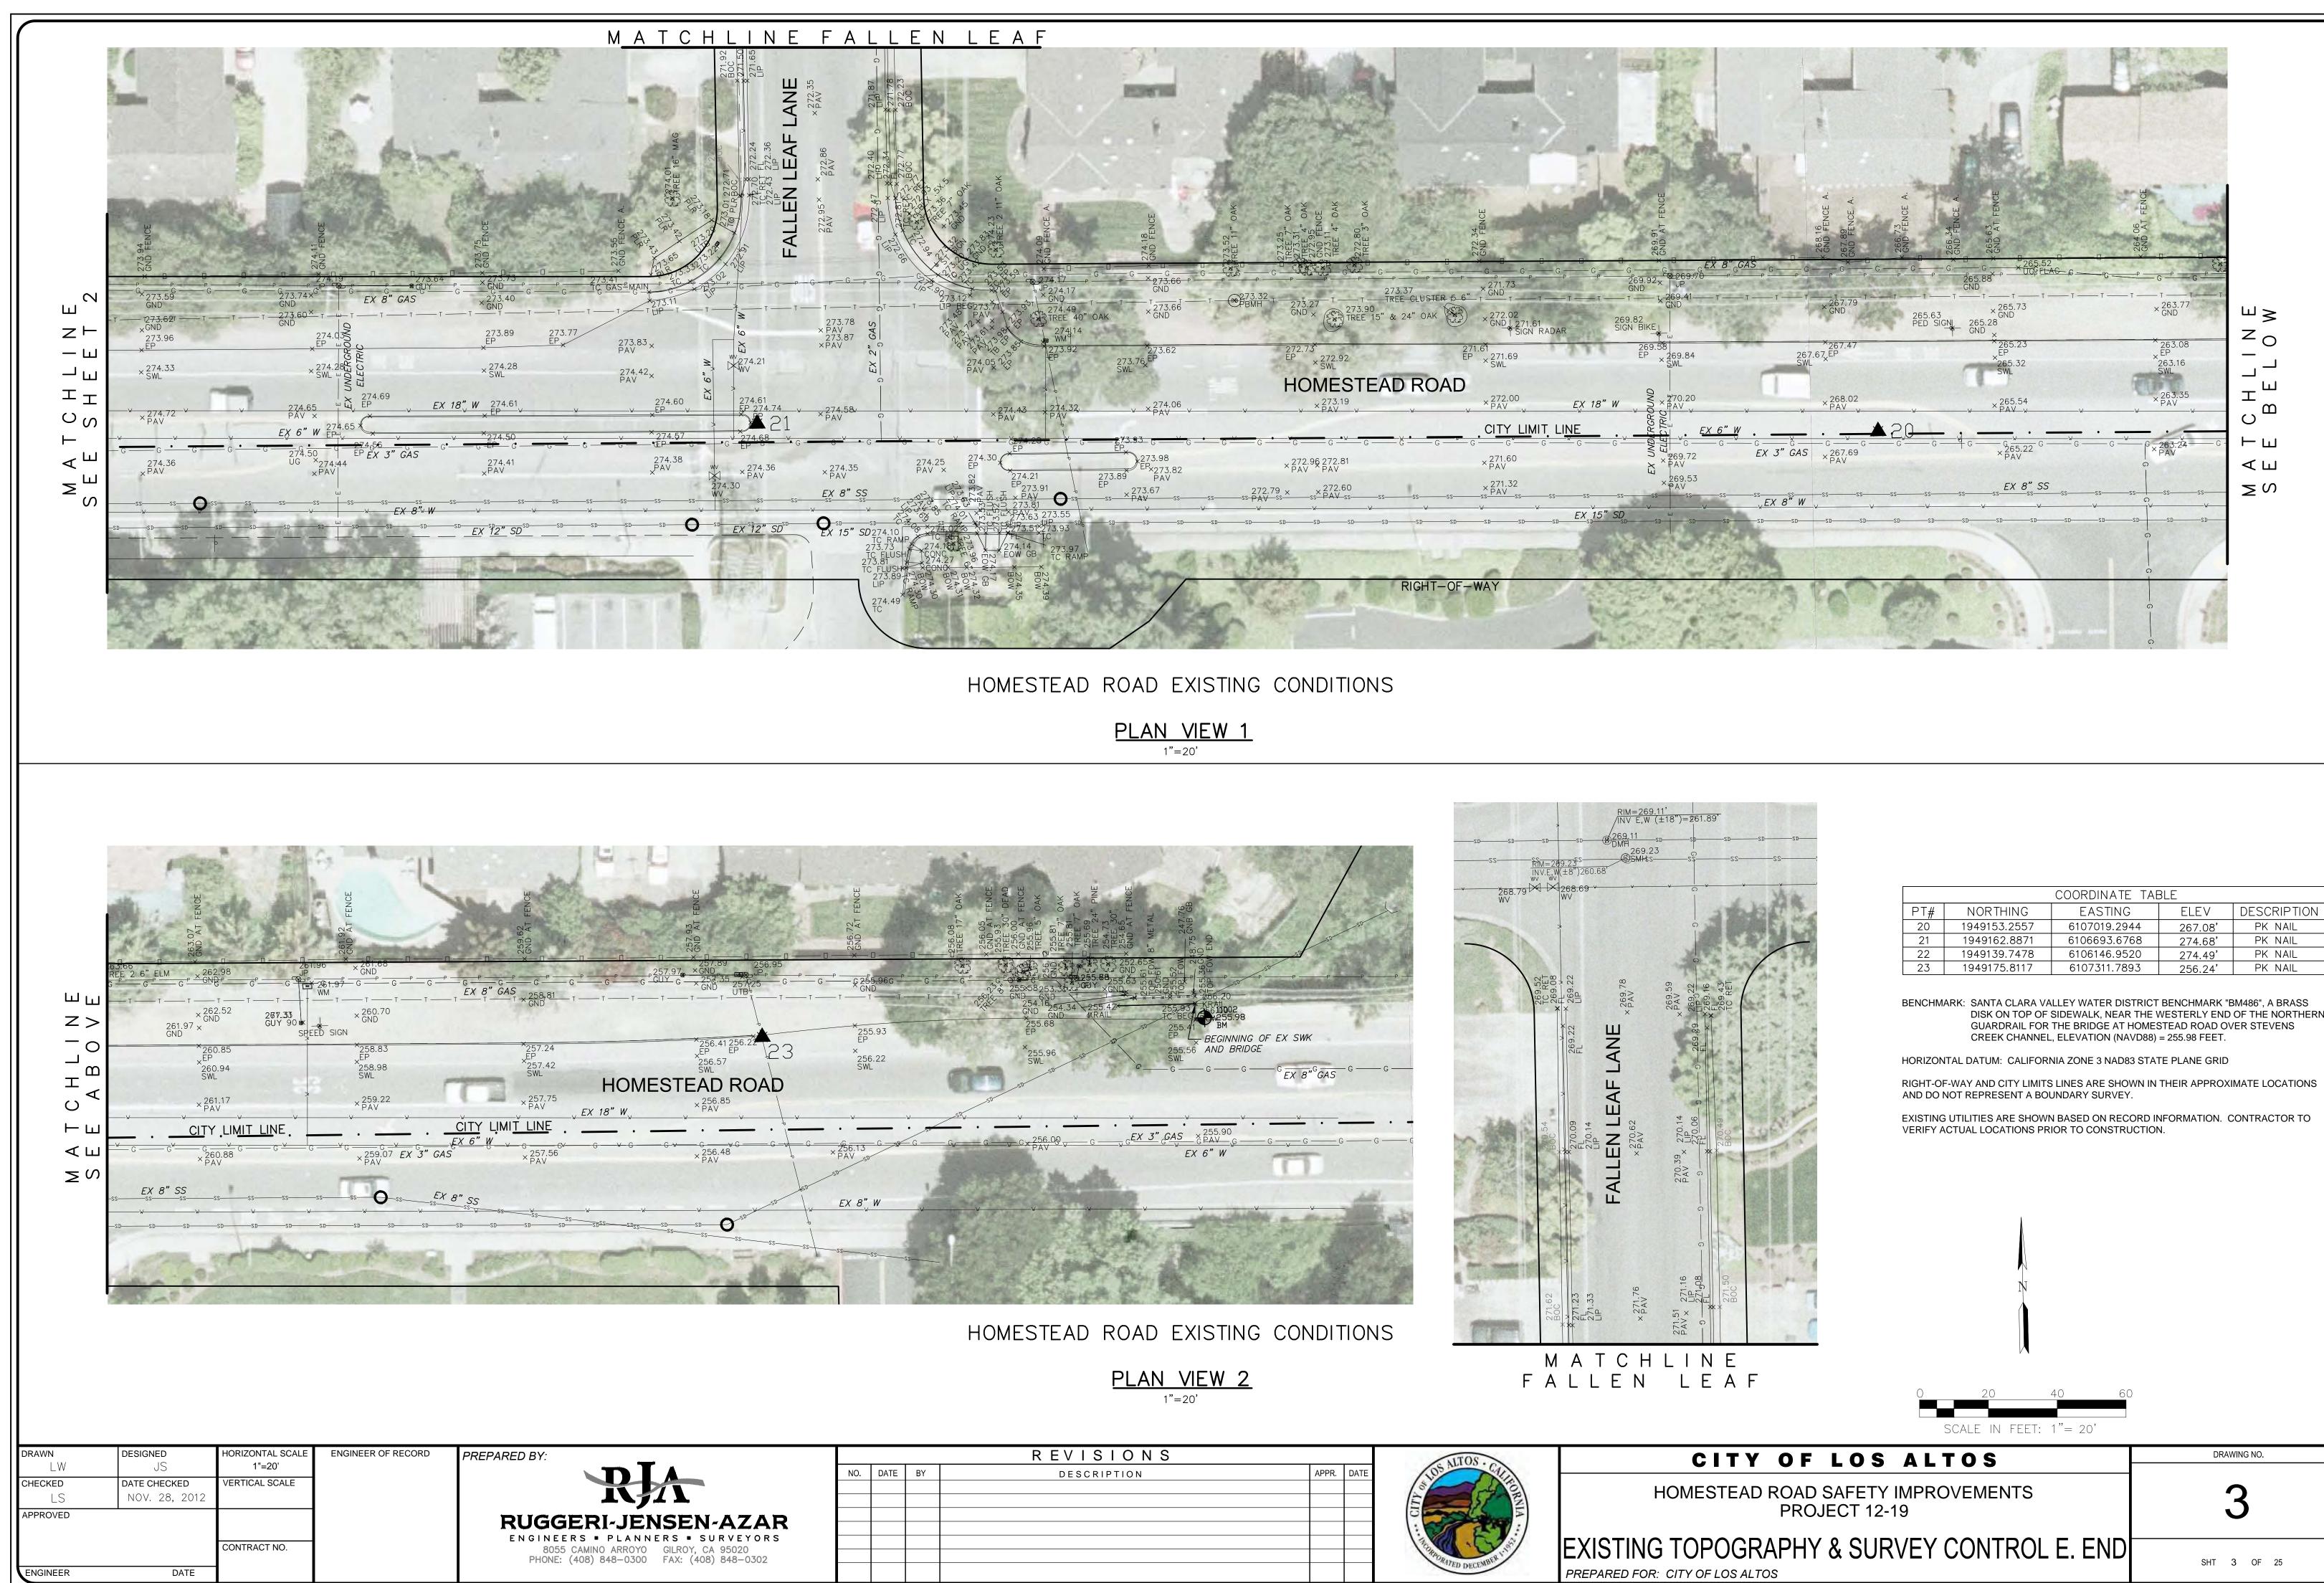

11	sp ss	SD	SDS:	S2D
	, , , , , , , , , , , , , , , , , , ,			
	269.59 × PAV 0 269.89 269.32 FL × × 269.16	FE ¹ 269.43 TC RET	のの日にあった	
x 270.04	$\begin{array}{c} 270.39 \\ PAV \\ PAV \\ LP \\ LP \\ 270.06 \\ 8 \\ Fc \\ 270.06 \\ 0 \\ - 0 \\ - \end{array}$	\$270.49 BOC	A DECEMBER OF A	No.
x 271.76 PAV	271.51 PAV × 271.16 - 0 271908 0	* 271.50 BOC	10 10 m	

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DISK ON TOP OF SIDEWALK, NEAR THE WESTERLY END OF THE NORTHERN

