370 YERBA SANTA AVE.

LOS ALTOS, CA 94022

A New Vibrant & Sustainable Residence

PROPOSED SCOPE OF GREEN DESIGN

Environmental Innovations in Design, on behalf of the Owners, is pleased to present this new single family residence at 370 Yerba Santa Avenue in the City of Los Altos. This French Provincial two story residence has been designed in a highly attractive and sustainable manner to responsibly addresses the surrounding environment with care and sensitivity.

The home is designed to accommodate the owner's lifestyle, while responding to site and solar orientation, and also contextually to the surrounding neighborhood. This includes respecting the neighbors privacy through the use of generous setbacks and by limiting second story views into adjacent property. Nighttime privacy, light and glare issues are addressed through the use of motorized venetian blinds to preserve the nocturnal tranquility of the community.

The new home will be built to exceed current energy efficiency requirements, while fostering the overall goal of creating an architecturally pleasing, aesthetic and progressively sustainable design. Green programming features will include:

- ♦ Near-zero energy net consumption
- ◆ Recycled, Re-used materials at walls, roofs, floors.
- ◆ Recycling of 85% of Construction Waste ♦ High Efficiency Heating and Cooling Systems
- ◆ Passive & Mechanical Ventilation for Indoor Air Quality
- ◆ Plentiful, well oriented Daylighting
- ◆ Tankless or High Efficiency Water Heaters
- ♦ On-Demand Hot Water Recirculation Pumps ◆ Photovoltaic and/or Hot Water Panels on Roofs
- ◆ Southerly Oriented Roofs for Solar Efficiency
- ◆ Use of Fly Ash and Recycled Rebar in Concrete
- ♦ Heat dissipating technologies at exterior walls ◆ Low-E, thermally insulated Windows
- ◆ Drought Tolerant, Water Efficient Landscaping
- ◆ Electrical Vehicle charging stations
- ◆ Improved Energy Performance above

Title-24 Energy Compliance Requirements

The Architect will provide professional services of this under California Architect license number C-26427.



STRUCTURAL ENGINEER:

GENERAL CONTRACTOR:

TBD

Address

Phone:

Mobile:

Email:

T.B.D.

Phone:

Mobile

ZONING COMPLIANCE

	Existing	Proposed	Allowed/Required
LOT COVERAGE: Land area covered by all structures that are over 6 feet in height	2679 square feet (19_%)	3,672.2 square feet (26.5 %)	4156.5 square feet (30 %)
FLOOR AREA: Measured to the outside surfaces of exterior walls	2142.3 square feet (15.5%)	4,131.3 square feet (29.8 %)	4,135.5 square feet (29.8 %)
SETBACKS: Front Rear Right side (1st/2nd) Left side (1st/2nd)	28.3 feet 39.2 feet 5.7 feet/NA feet 47.7 feet/NA feet	29.46 feet 43.6 feet 10 feet/28.75 feet 24.6 feet/22.67 feet	25 feet 25 feet 10 feet/17.5 feet 10 feet/17.5 feet
НЕІGHT:	_15 _feet	feet	_27feet

SQUARE FOOTAGE BREAKDOWN

	Existing	Change in	Total Proposed
HABITABLE LIVING AREA: Includes habitable basement areas	square feet	3,354 square feet	5,496square feet
NON- HABITABLE AREA: Does not include covered porches or open structures	square feet	square feet	769.2 * square feet


LOT CALCULATIONS

NET LOT AREA:		13,855 square feet				
FRONT YARD HARDSCAPE AREA: Hardscape area in the front yard setback shall not exceed 50%		<u>1,276</u> square feet (49.6%) TOTAL FRONT YARD = 103' X 25' = 2,575 SF				
LANDSCAPING BREAKDOWN:	Existing softscape (und	r replaced landscaping) area:xsq ft				

* NON-HABITABLE AREAS INCLUDE THE GARAGE AND BASEMENT STORAGE AREA

NOTE: SEE SHEET A-0.7 FOR AREA DIAGRAMS

VICINITY MAP

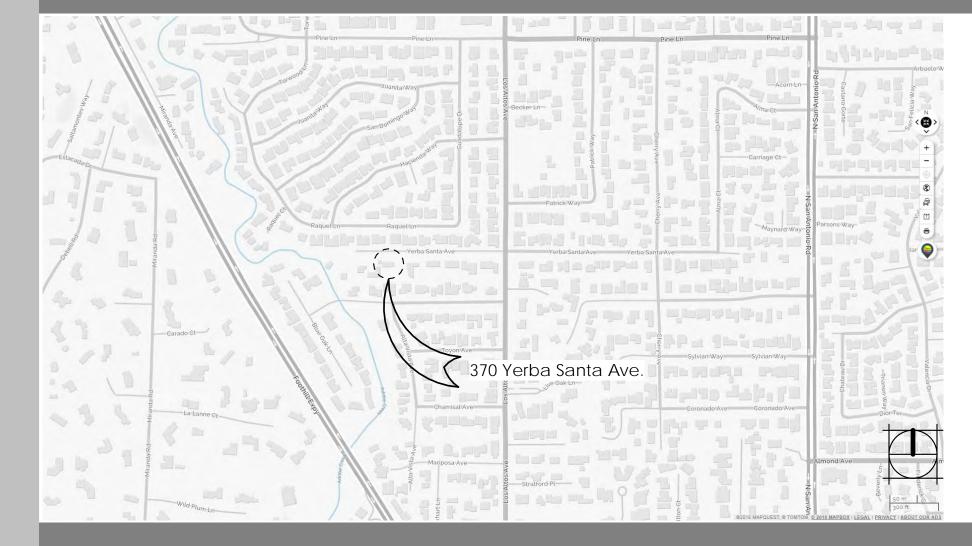

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A-3.0	BASEMENT PLAN	Landscape	
A-3.1	FIRST FLOOR PLAN	L-1.0	LANDSCAPE CONCEPT
A-3.2	SECOND FLOOR PLAN	L-1.1	LANDSCAPE PLAN NOTES
A-3.4	ROOF PLAN	L-2.0	PLANT LIST AND IMAGES
A-4.1	ELEVATIONS - NORTH & SOUTH	Total Sheet	s: 31
A-4.2	ELEVATIONS - EAST & WEST		

PROJECT DATA SUMMARY

ZONING = R1-10 DISTRICT

OCCUPANCY = R-3/U - SINGLE FAMILY RESIDENCE WITH GARAGE CONSTRUCTION = TYPE VB

PLANNING PERMIT # 1291480 BUILDING PERMIT NUMBER: TBD

APN# 167 - 33 - 051 LOT AREA: 17,975 SF GROSS

13,855 SF NET Jurisdiction - Los Altos

NFPA 13D AUTOMATIC FIRE SPRINKLERS AND INTERIOR SMOKE ALARMS PROVIDED AT DWELLING PER FIRE PROTECTION DISTRICT. BASEMENT THEATER/MEDIA ROOM SHALL HAVE INTERCONNECTED SMOKE DETECTION AND VISUAL STROBE INSTALLED WITH THE ENTIRE BUILDING.

ALL CONSTRUCTION SHALL COMPLY WITH 2016 CRC, CBC, CPC, CMC, CEC and 2016 California Energy Code, LOS ALTOS HILLS MUNICIPAL CODE, ALL LOCAL AMENDMENTS / ORDINANCES, and ALL LOCAL SUB-TRADE CODES. CONTRACTOR SHALL COMPLY WITH 2016 CALIFORNIA GREEN BUILDING STANDARDS CODE, REFER TO GB SHEETS.

◆ The Geotechnical aspects of the construction including demolition and rough site grading, at-grade foundation excavations, subgrade preparation and the installation of surface drainage control systems, should be performed in accordance with the recommendations presented in the geotechnical report prepared by Engineers. Engineers should be provided at least 48 hours advance notification of any geotechnical aspects of the construction and should be present to observe and test, as necessary, the earthwork, foundation, and drainage installation phases of the project.

DEFERRED SUBMITTALS:

DEFERRED SUBMITTALS FOR THIS PROJECT INCLUDE: FIRE SPRINKLERS.

SEPARATE PERMITS:

SEPARATE PERMITS FOR THIS PROJECT INCLUDE:

DEMOLITION PERMIT, PHOTOVOLTAIC ARRAY, EVSE (electric vehicle charging stations), ACCESSORY STRUCTURES SWIMMING POOL

SPECIAL INSPECTIONS:

SPECIAL INSPECTIONS REQUIRED:

HIGH STRENGTH CONCRETE, FIELD WELDING, HIGH STRENGTH SHEAR WALLS. REFER TO SHEET SN1 FOR COMPLETE

CONDITIONS OF APPROVAL:

SEE SHEET A0.1 FOR CONDITIONS OF APPROVAL AND COUNTY FIRE DEPARTMENT COMMENT

SCOPE OF WORK:

THE SCOPE OF WORK FOR THIS PROJECT INCLUDES THE CONSTRUCTION OF A NEW 2 STORY ABOVE GRADE SINGLE FAMILY RESIDENCE OF TYPE VB CONSTRUCTION WITH A FULL BASEMENT. THE WORK INCLUDES SITE GRADING, UTILITY CONNECTIONS AND VEHICULAR AND PEDESTRIAN PAVING AND LANDSCAPING.

CONSTRUCTION SITE FIRE SAFETY:

CONSTRUCTION SITE SHALL COMPLY WITH APPLICABLE PROVISIONS OF CFC SHAPTER 33 AND SANTA CLARA COUNTY FIRE DEPARTMENT STANDARD DETAILS AND SPECIFICATIONS SI-7, CONSTRUCTION SITE FIRE SAFETY.

OWNER:

Phone:

Mobile:

Email:

Wei Xiong & Doris Sun

370 Yerba Santa Ave. Los Altos, CA 94022

412 Olive Avenue

Palo Alto, CA 94306-2225

Phone: Mobile: (650) 862-8312

dnbladexw@gmail.com

PROJECT TEAM

ARCHITECT: EID Architects

Environmental Innovations in Design

stuart@EIDarchitects.com

(650) 226-8770

(650) 793-2856

SHEET TITLE

SHEET NUMBER

ENVIRONMENTAL INNOVATIONS IN DESIGN

MECHANICAL: ARBORIST:

TBD Address

Mobile:

ELECTRICAL: TBD

Address Mobile

Phone: (650) 559-9980 Mobile: (650) 315-6001 jason@emurrayengineers.com

(650) 839-9539

(650) 537-0172 rweather@pacbell.net

Advanced Tree Care

Redwood City, CA 94063

P.O.Box 5326

Phone:

Mobile:

Email:

GEOTECHNICAL:

Murray Engineers 935 Fremont Avenue Los Altos, CA 94024

> (510) 887-4086 Phone: (510) 760-8727 Mobile: Email:

T24/ GREEN RATER:

TBD Address

Phone: Mobile: Email:

SURVEYOR:

2495 Industrial Parkway West

Hayward, CA 94545

Lea & Braze Engineering, Inc

pcarlino@leabraze.com callison@leabraze.com

901 Waltermire Street Belmont, CA 94002 Phone:

(650) 226-8640 (650) 637-1059 Travis@Precision-EC.com

370 YERBA SANTA AVE.

LANDSCAPE ARCHITECT:

ZAC Landscape Architects, Inc.

(707) 696-2967

CIVIL ENGINEER:

Construction, Inc.

Precision Engineering and

sr@zaclandscape.com

145 Keller Street

Phone:

Mobile

Email:

Petaluma, CA 94952

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COVER SHEET

412 OLIVE AVE. PALO ALTO, CA 94306 PHONE: 650-226-8770 WWW.EIDARCHITECTS.COM

DATE



1 RENDERING - FRONT VIEW 1





<u>Date</u>

07/23/2019


LOS ALTOS, CALIFORNIA 94022

SHEET TITLE RENDERING 3

SHEET NUMBER A-0.5c

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1 RENDERING BED 2 - VIEW 1

2 RENDERING BED 2 - VIEW 2

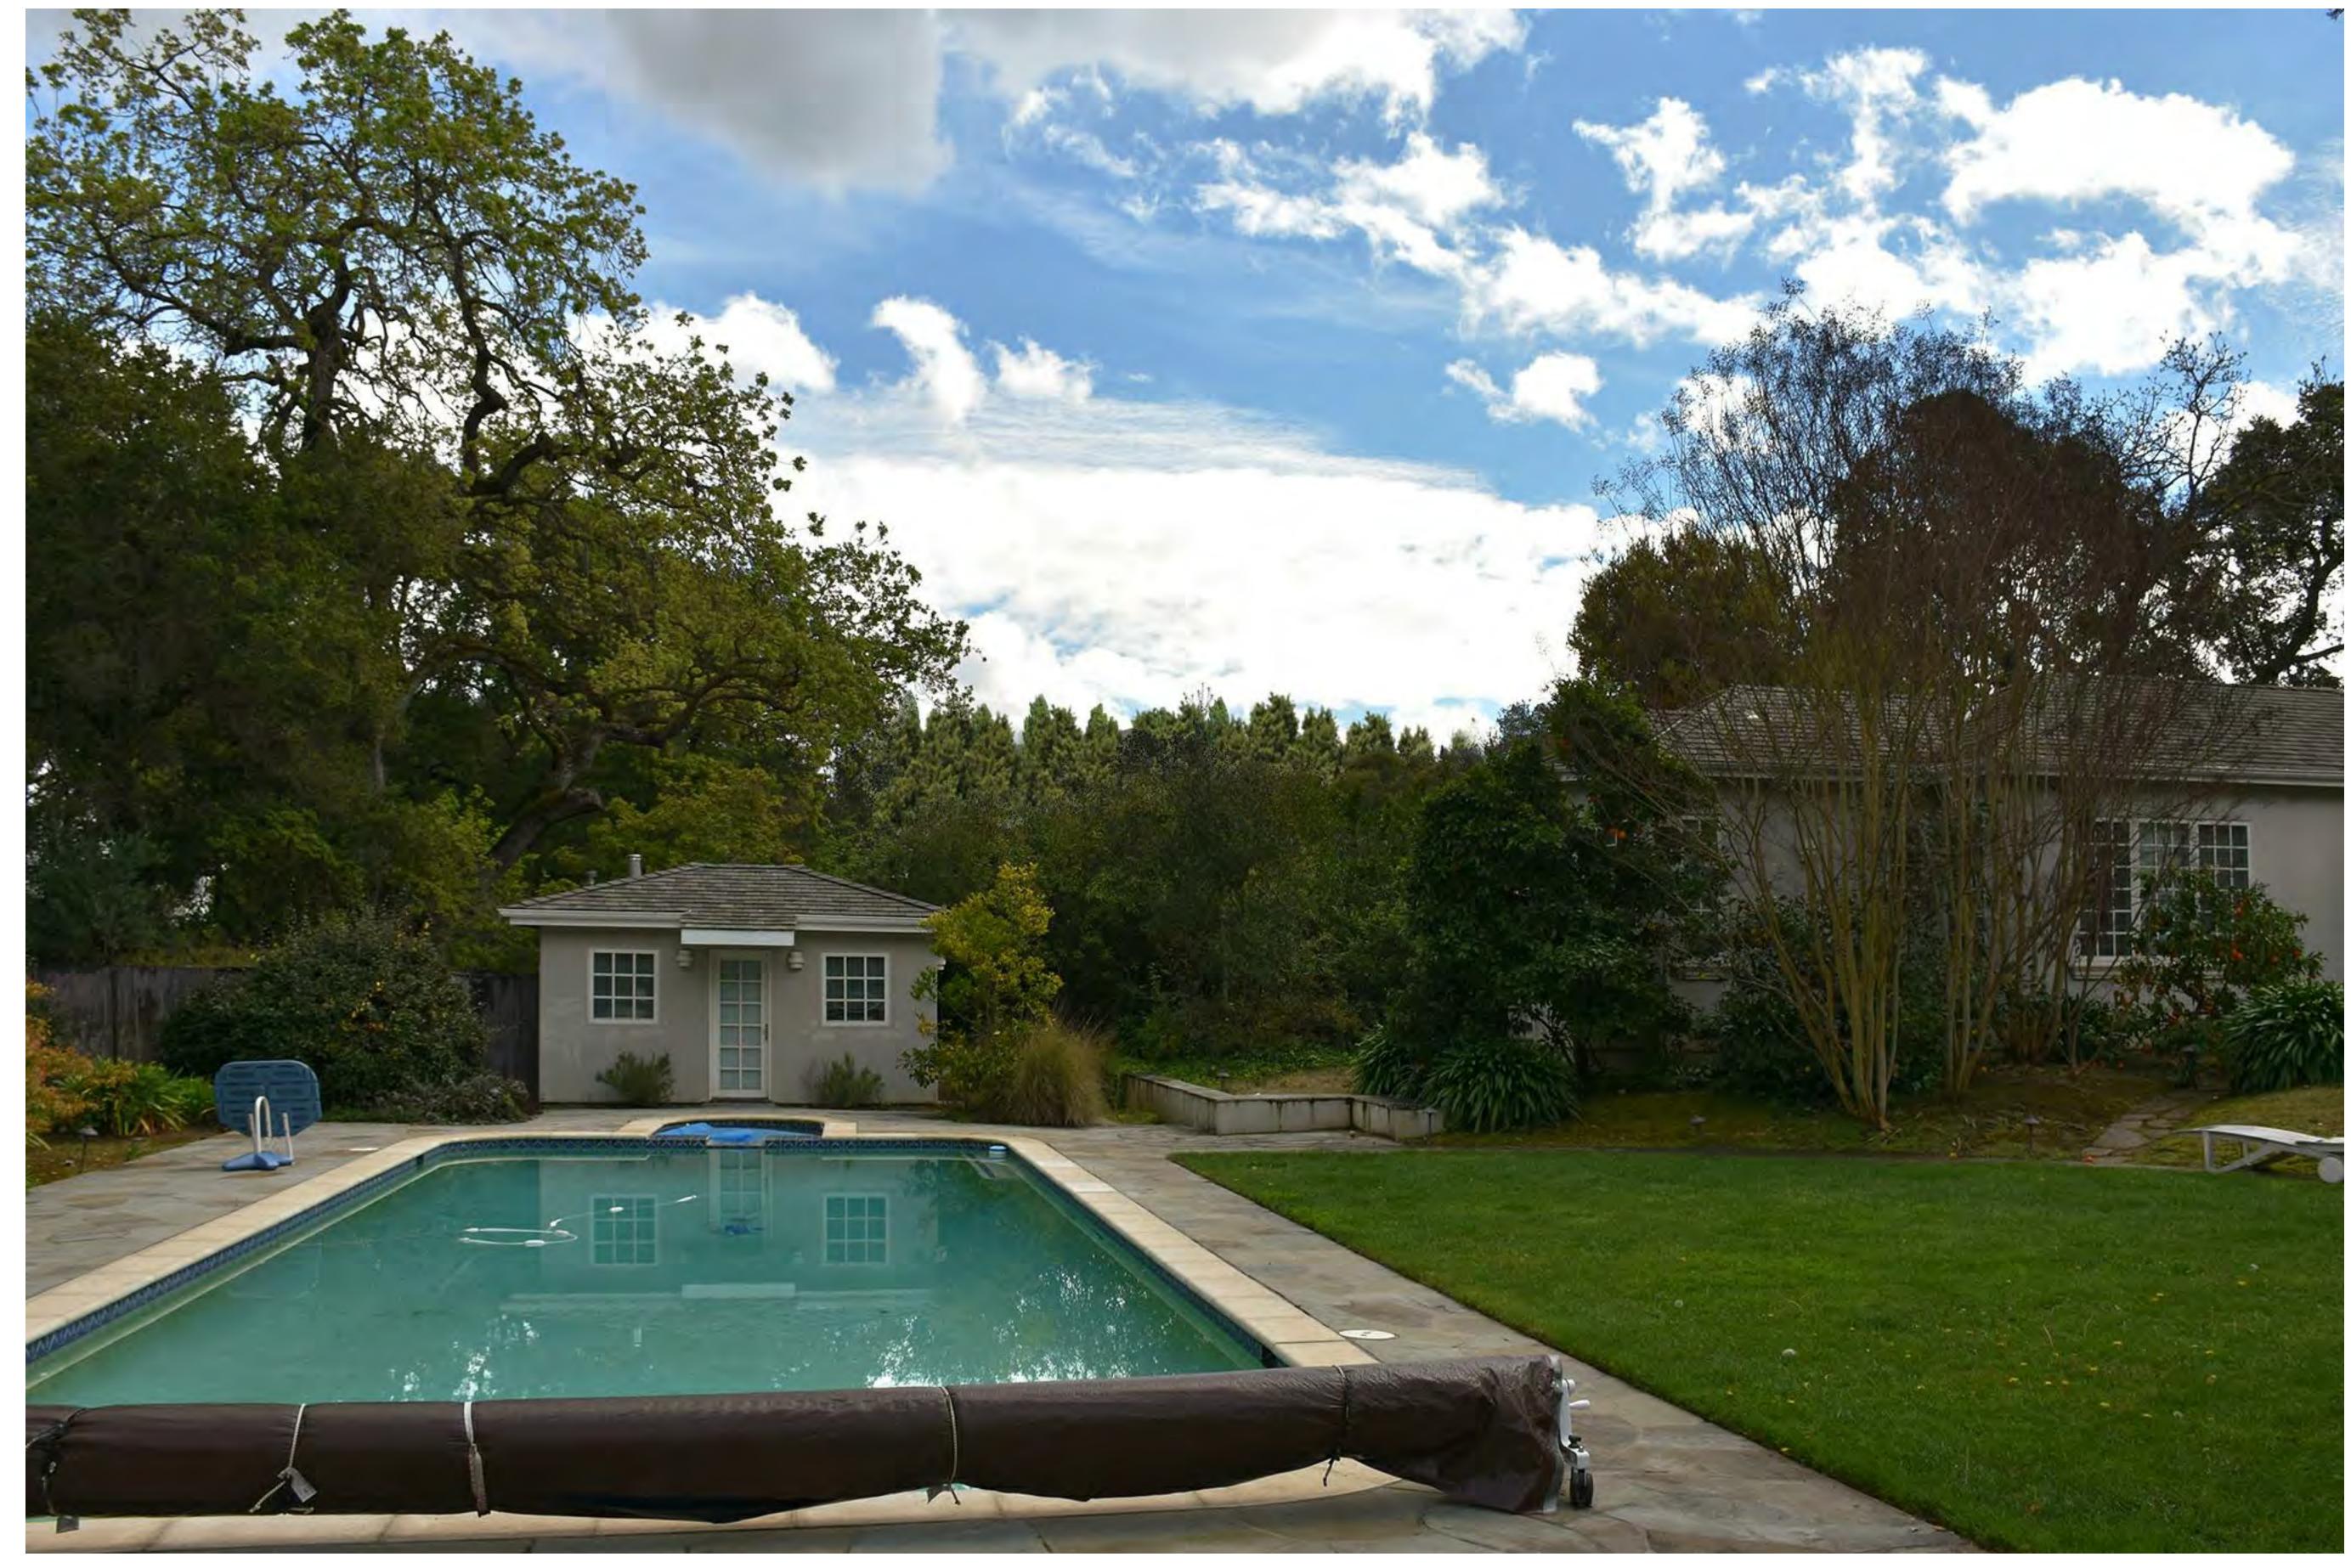
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<u>Date</u>


SHEET TITLE



EXISTING FLOOR PLAN




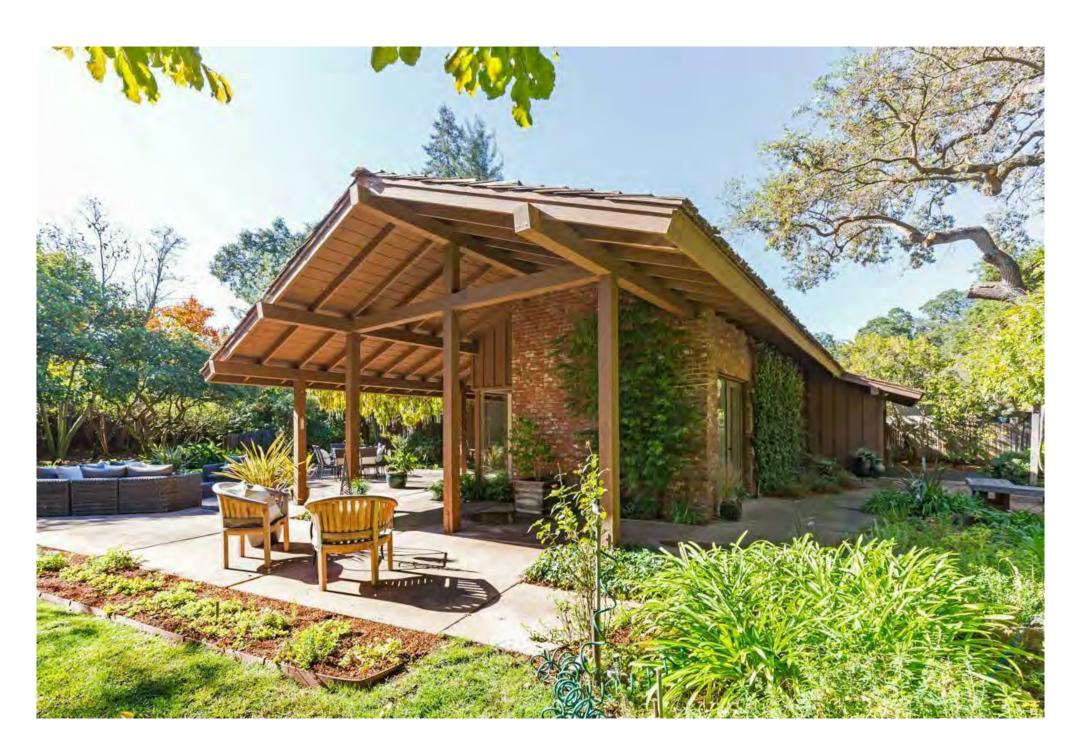

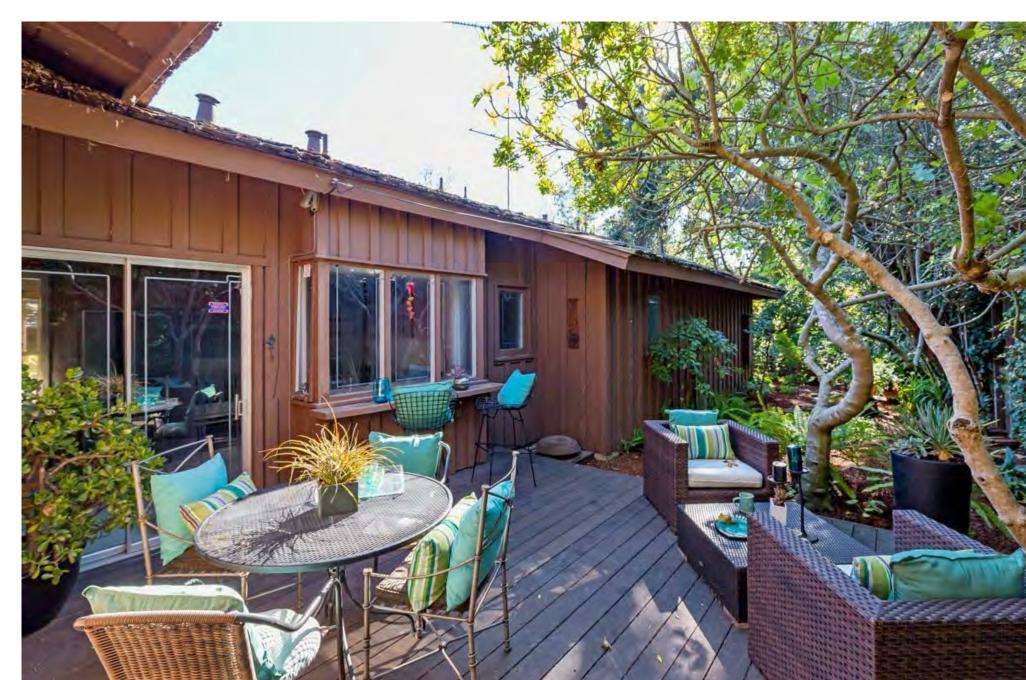


LEFT SIDE / FRONT ELEVATION RIGHT SIDE ELEVATION FRONT ELEVATION

ENVIRONMENTAL INNOVATIONS IN DESIGN 412 OLIVE AVE. PALO ALTO, CA 94306

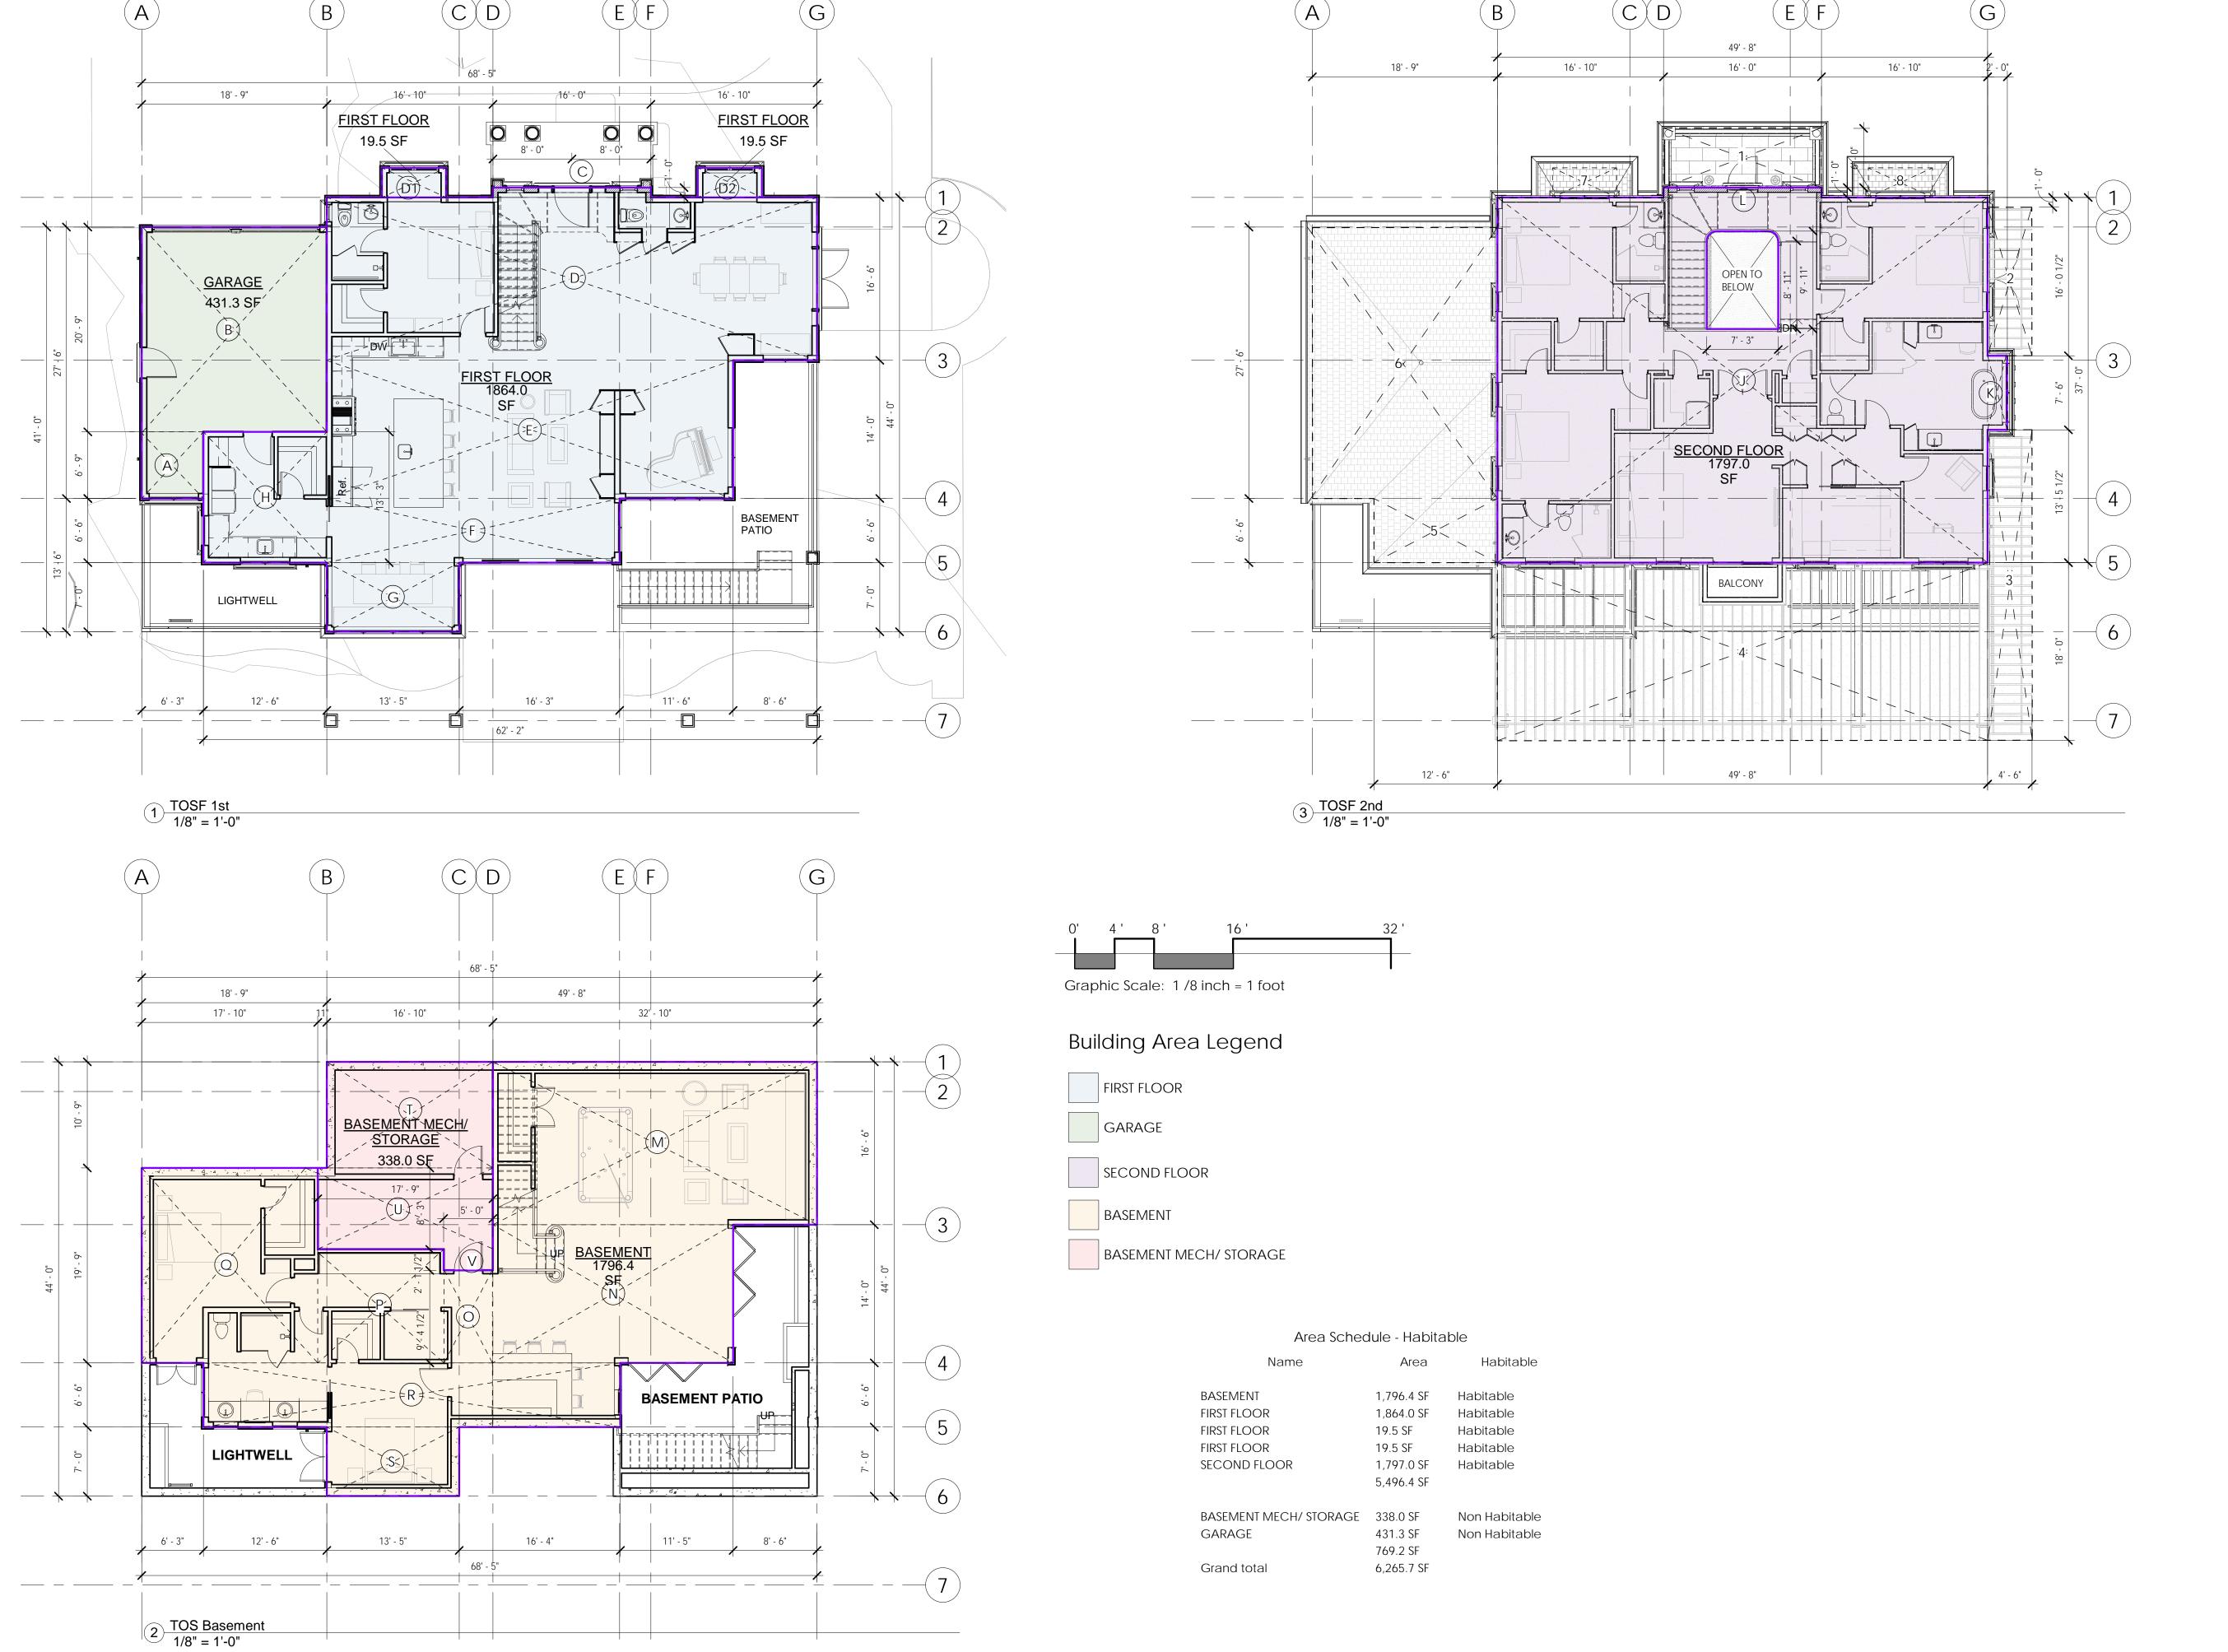

MAXIMUM PERMITTED FAR & COVERAGE CALCULATIONS:

GROSS LOT AREA = 17,975 SF NET LOT AREA = 13,855 SF 11,000 X 35% = 3,850.0 SF $(13,855 - 11,000) \times 10\% = 285.5 \text{ SF}$ MAXIMUM FAR: = 4,135.5 SF $13,855 \times 30\% = 4,156.5$ MAXIMUM COVERAGE = 4,156.5 SF MAX.

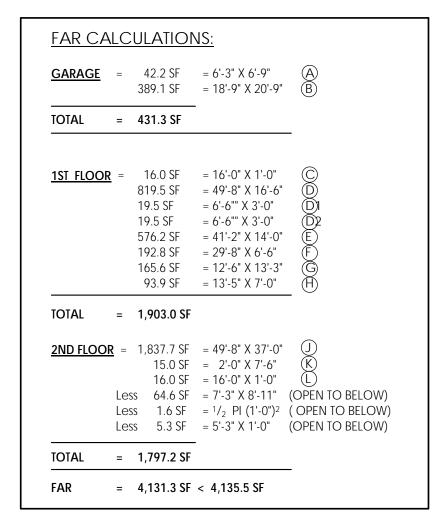

SECOND FLOOR AREA =	1.797.0 SF	
OPEN TO BELOW =	,	
AREA 1 =	96.0 SF	= 16' X 6'
AREA 2 =	72.0 SF	= 15' X 4.5'
AREA 3 =	141.8 SF	= 31.5' X 4.5'
AREA 4 =	894.0 SF	= 49.67' X 18.0
AREA 5 =	81.2 SF	= 12.5' X 6.5'
AREA 6 =	515.6 SF	= 18.75' X 27.5
AREA 7 =	19.5 SF	$= 6.5' \times 3.0'$
AREA 8 =	19.5 SF	$= 6.5' \times 3.0$

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<u>DATE</u> 07/23/2019

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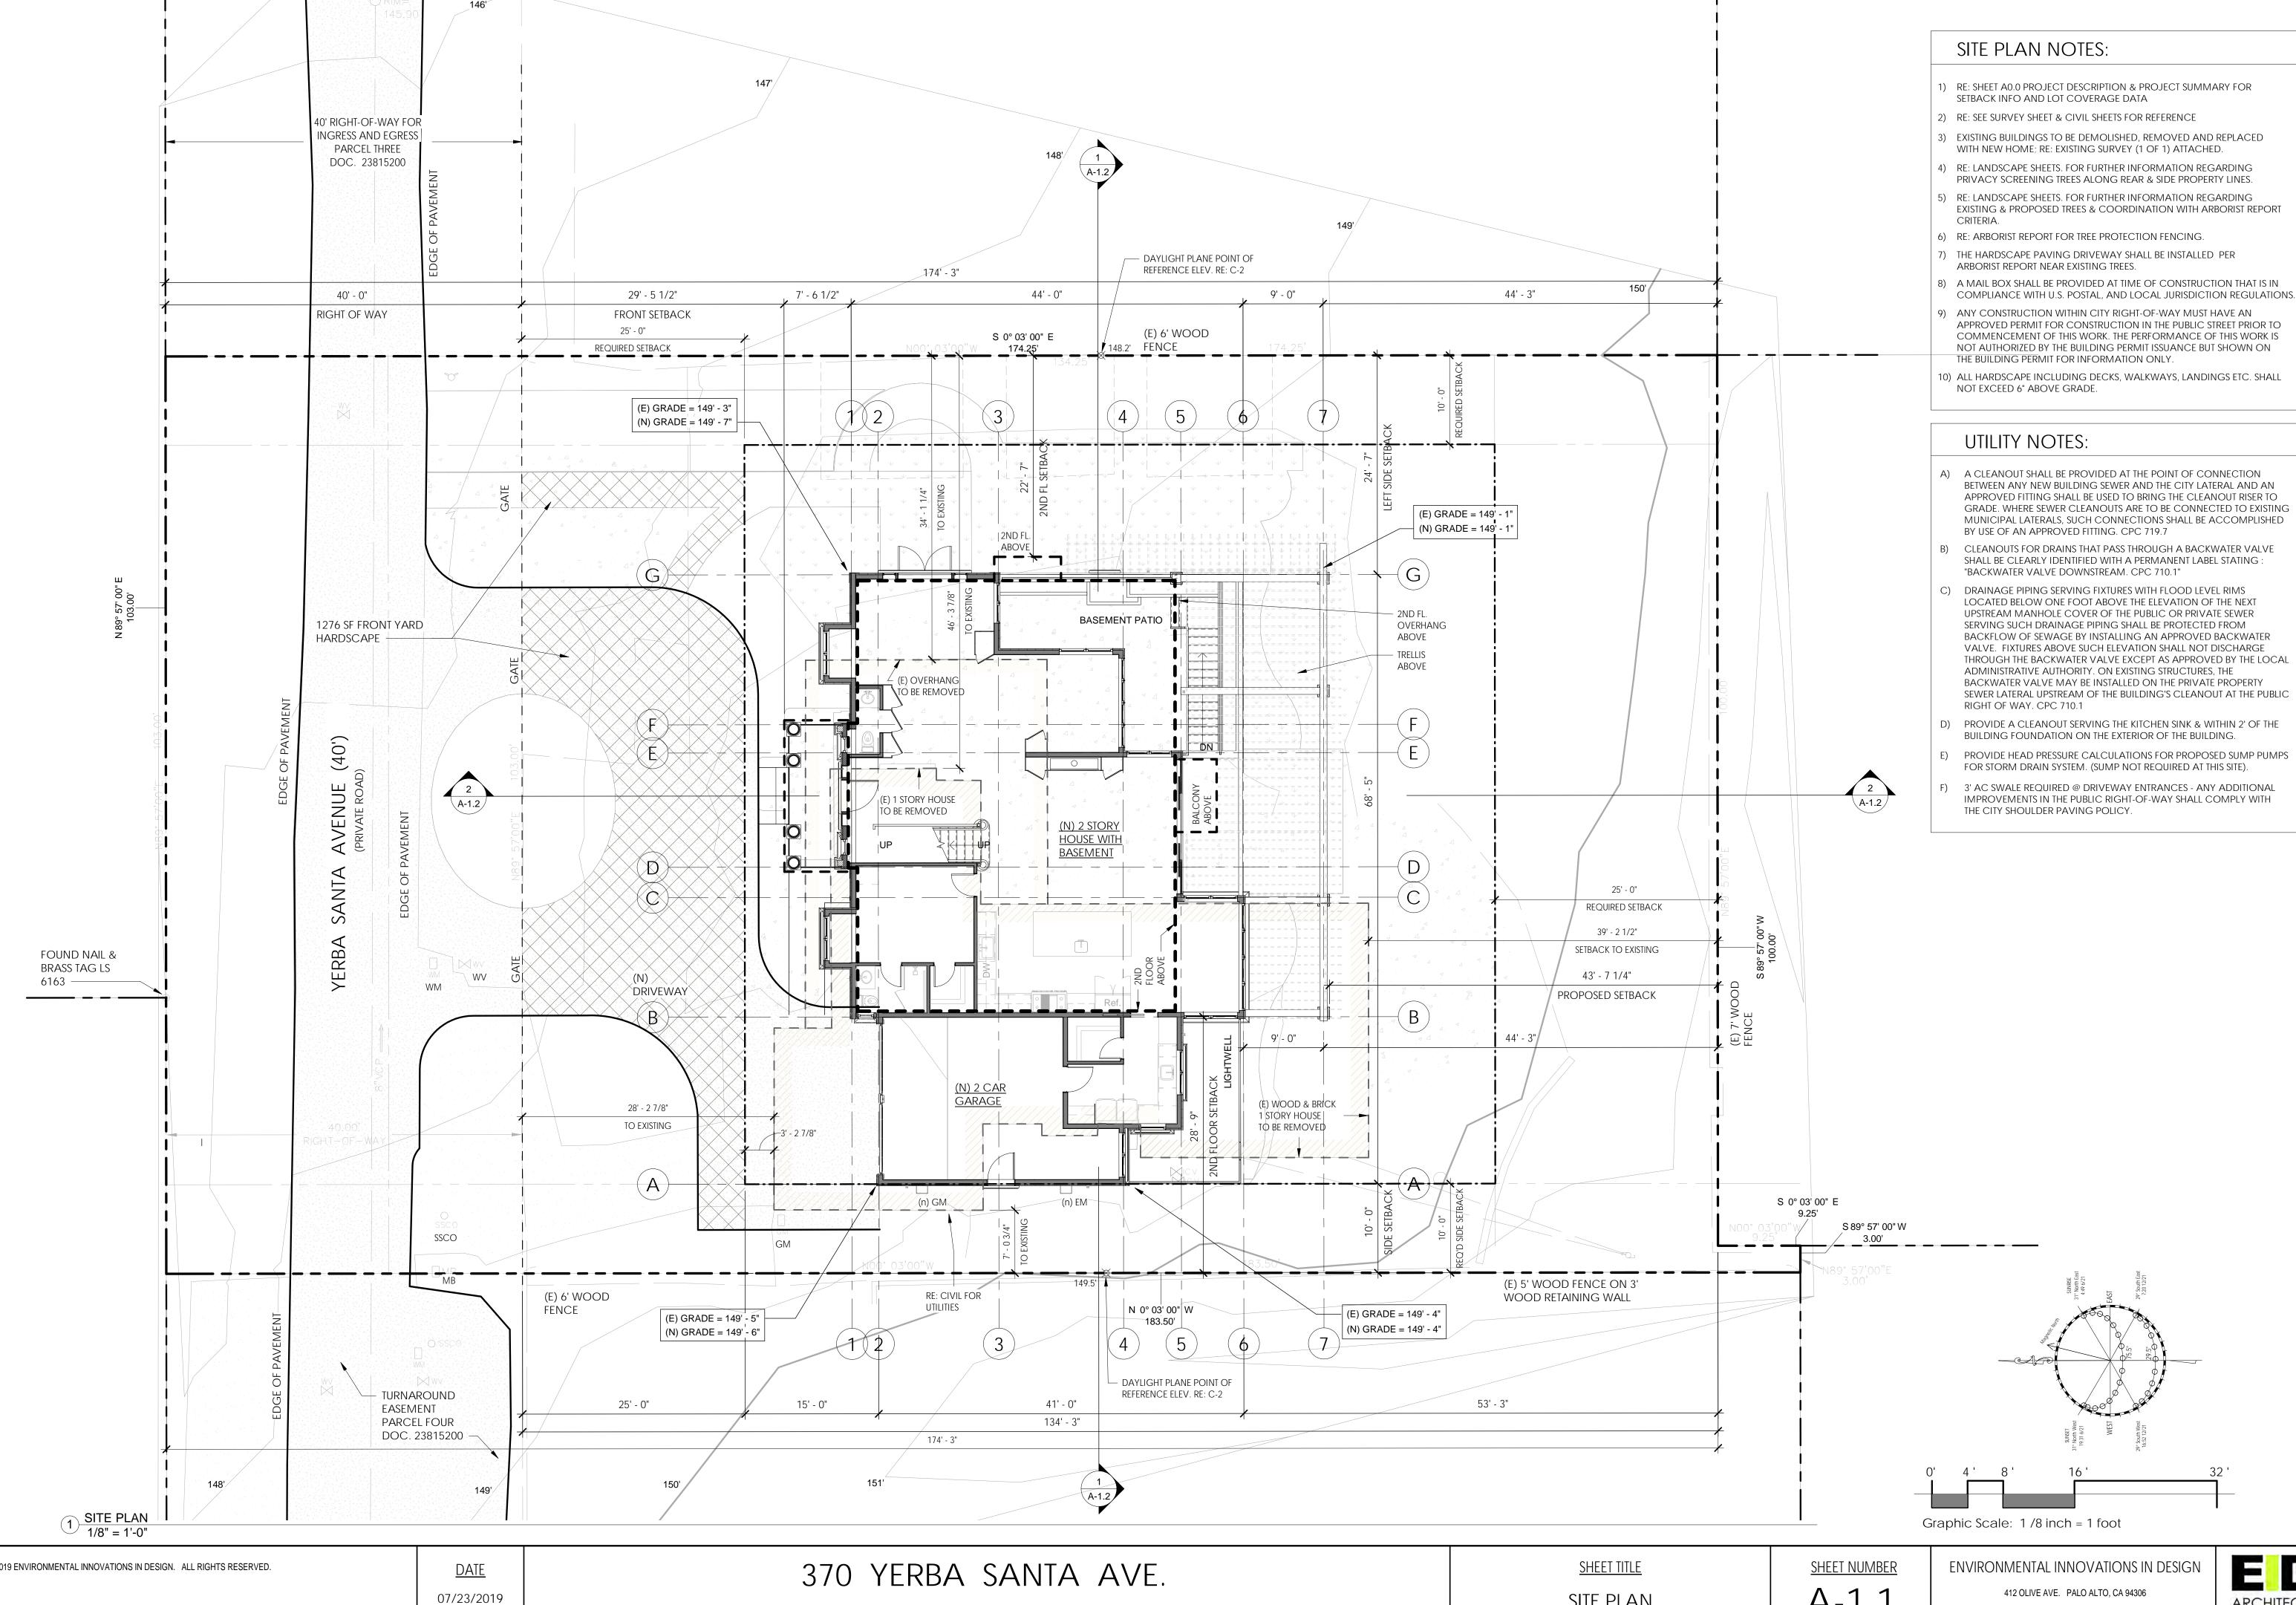
SHEET TITLE PROPOSED AREA BLOCK DIAGRAM

SHEET NUMBER

ENVIRONMENTAL INNOVATIONS IN DESIGN 412 OLIVE AVE. PALO ALTO, CA 94306

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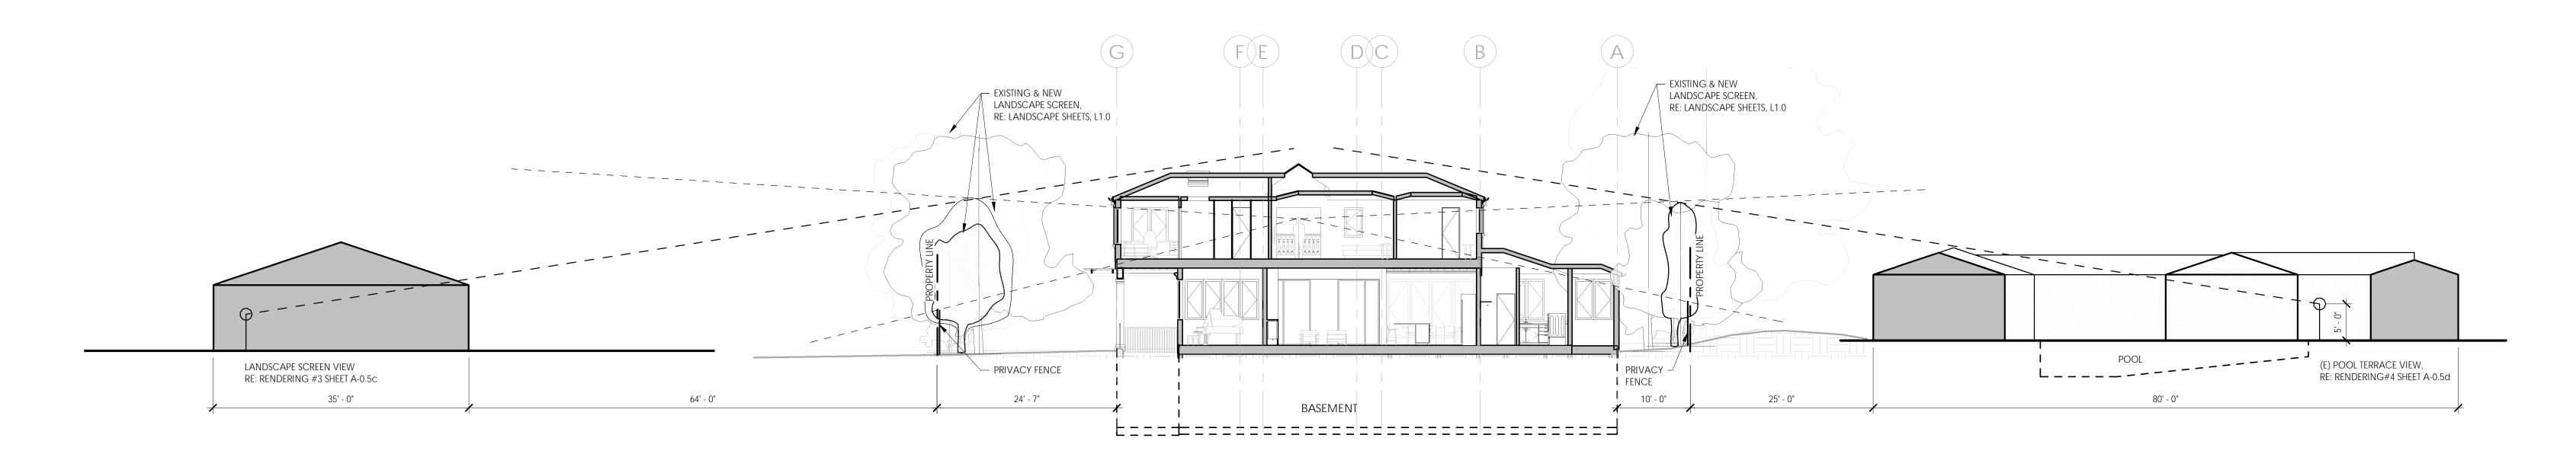


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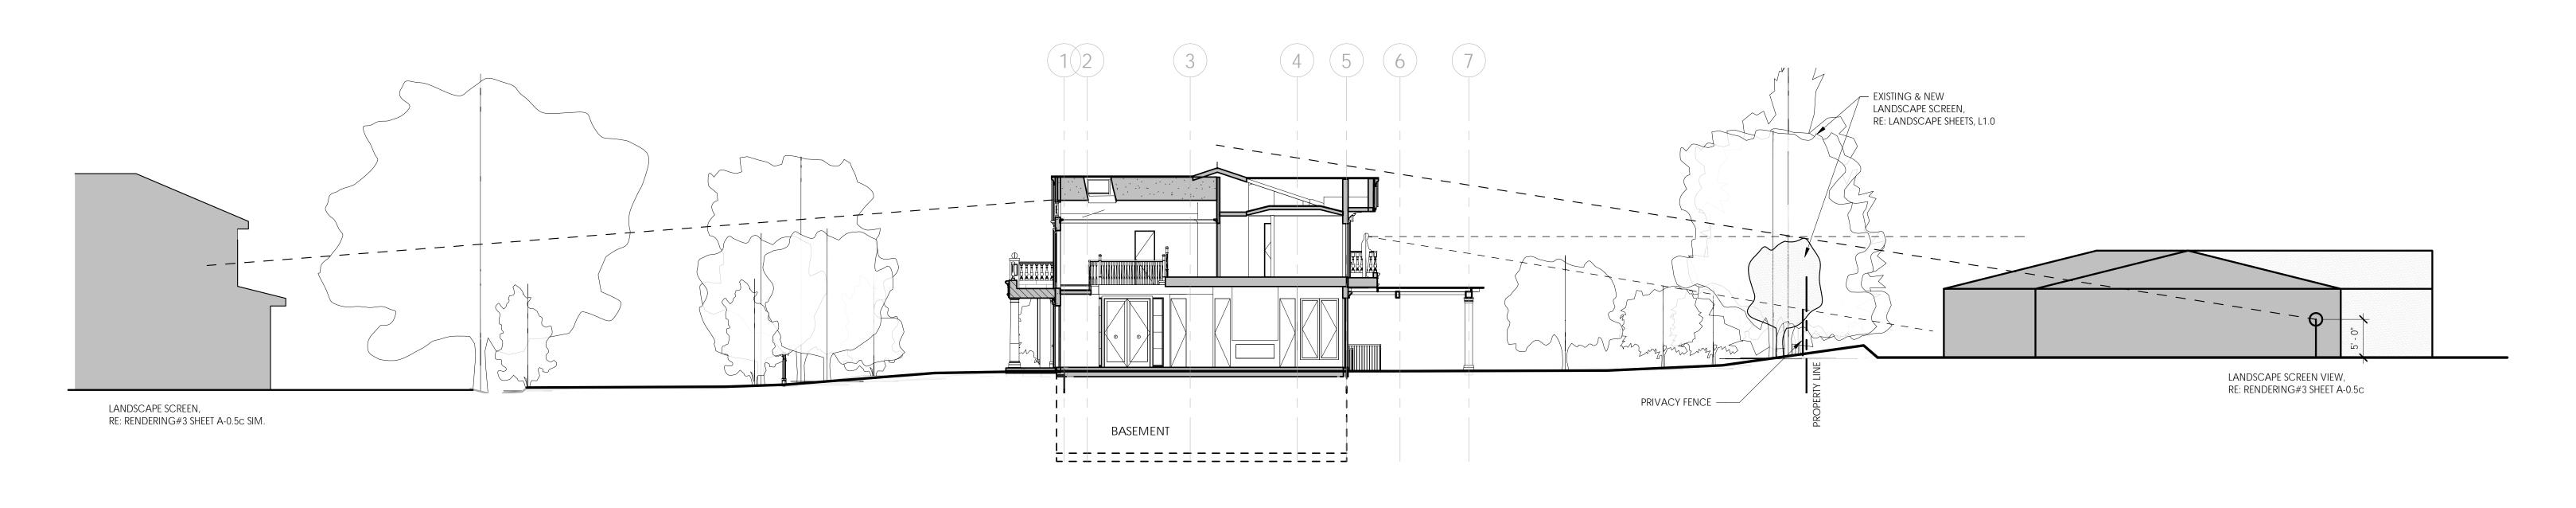
SITE PLAN

A-1.1

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1 SITE SECTION 1 1" = 10'-0"




2 SITE SECTION 2 1" = 10'-0"

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<u>Date</u>

07/23/2019

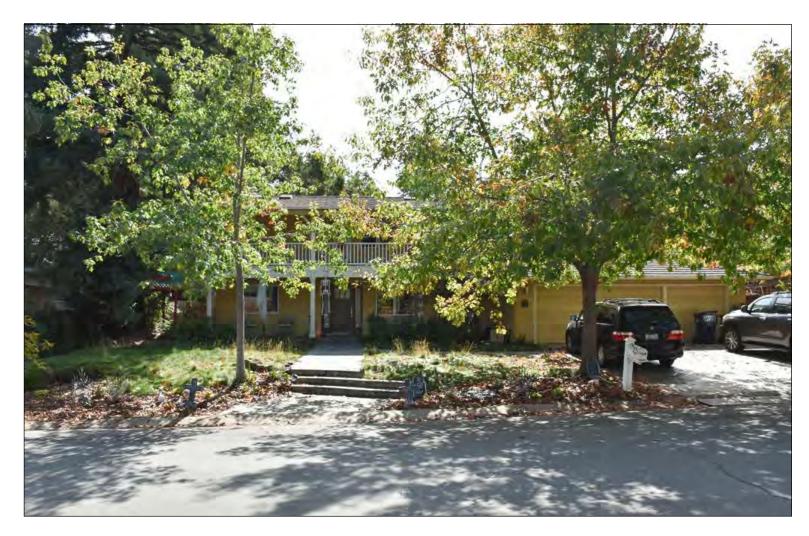

420 RAQUEL LANE



400 RAQUEL LANE (8)



380 RAQUEL LANE (7)



360 RAQUEL LANE



420 YERBA SANTA AVE.



350 YERBA SANTA AVE.




370 YERBA SANTA AVE.

418 YERBA SANTA AVE.








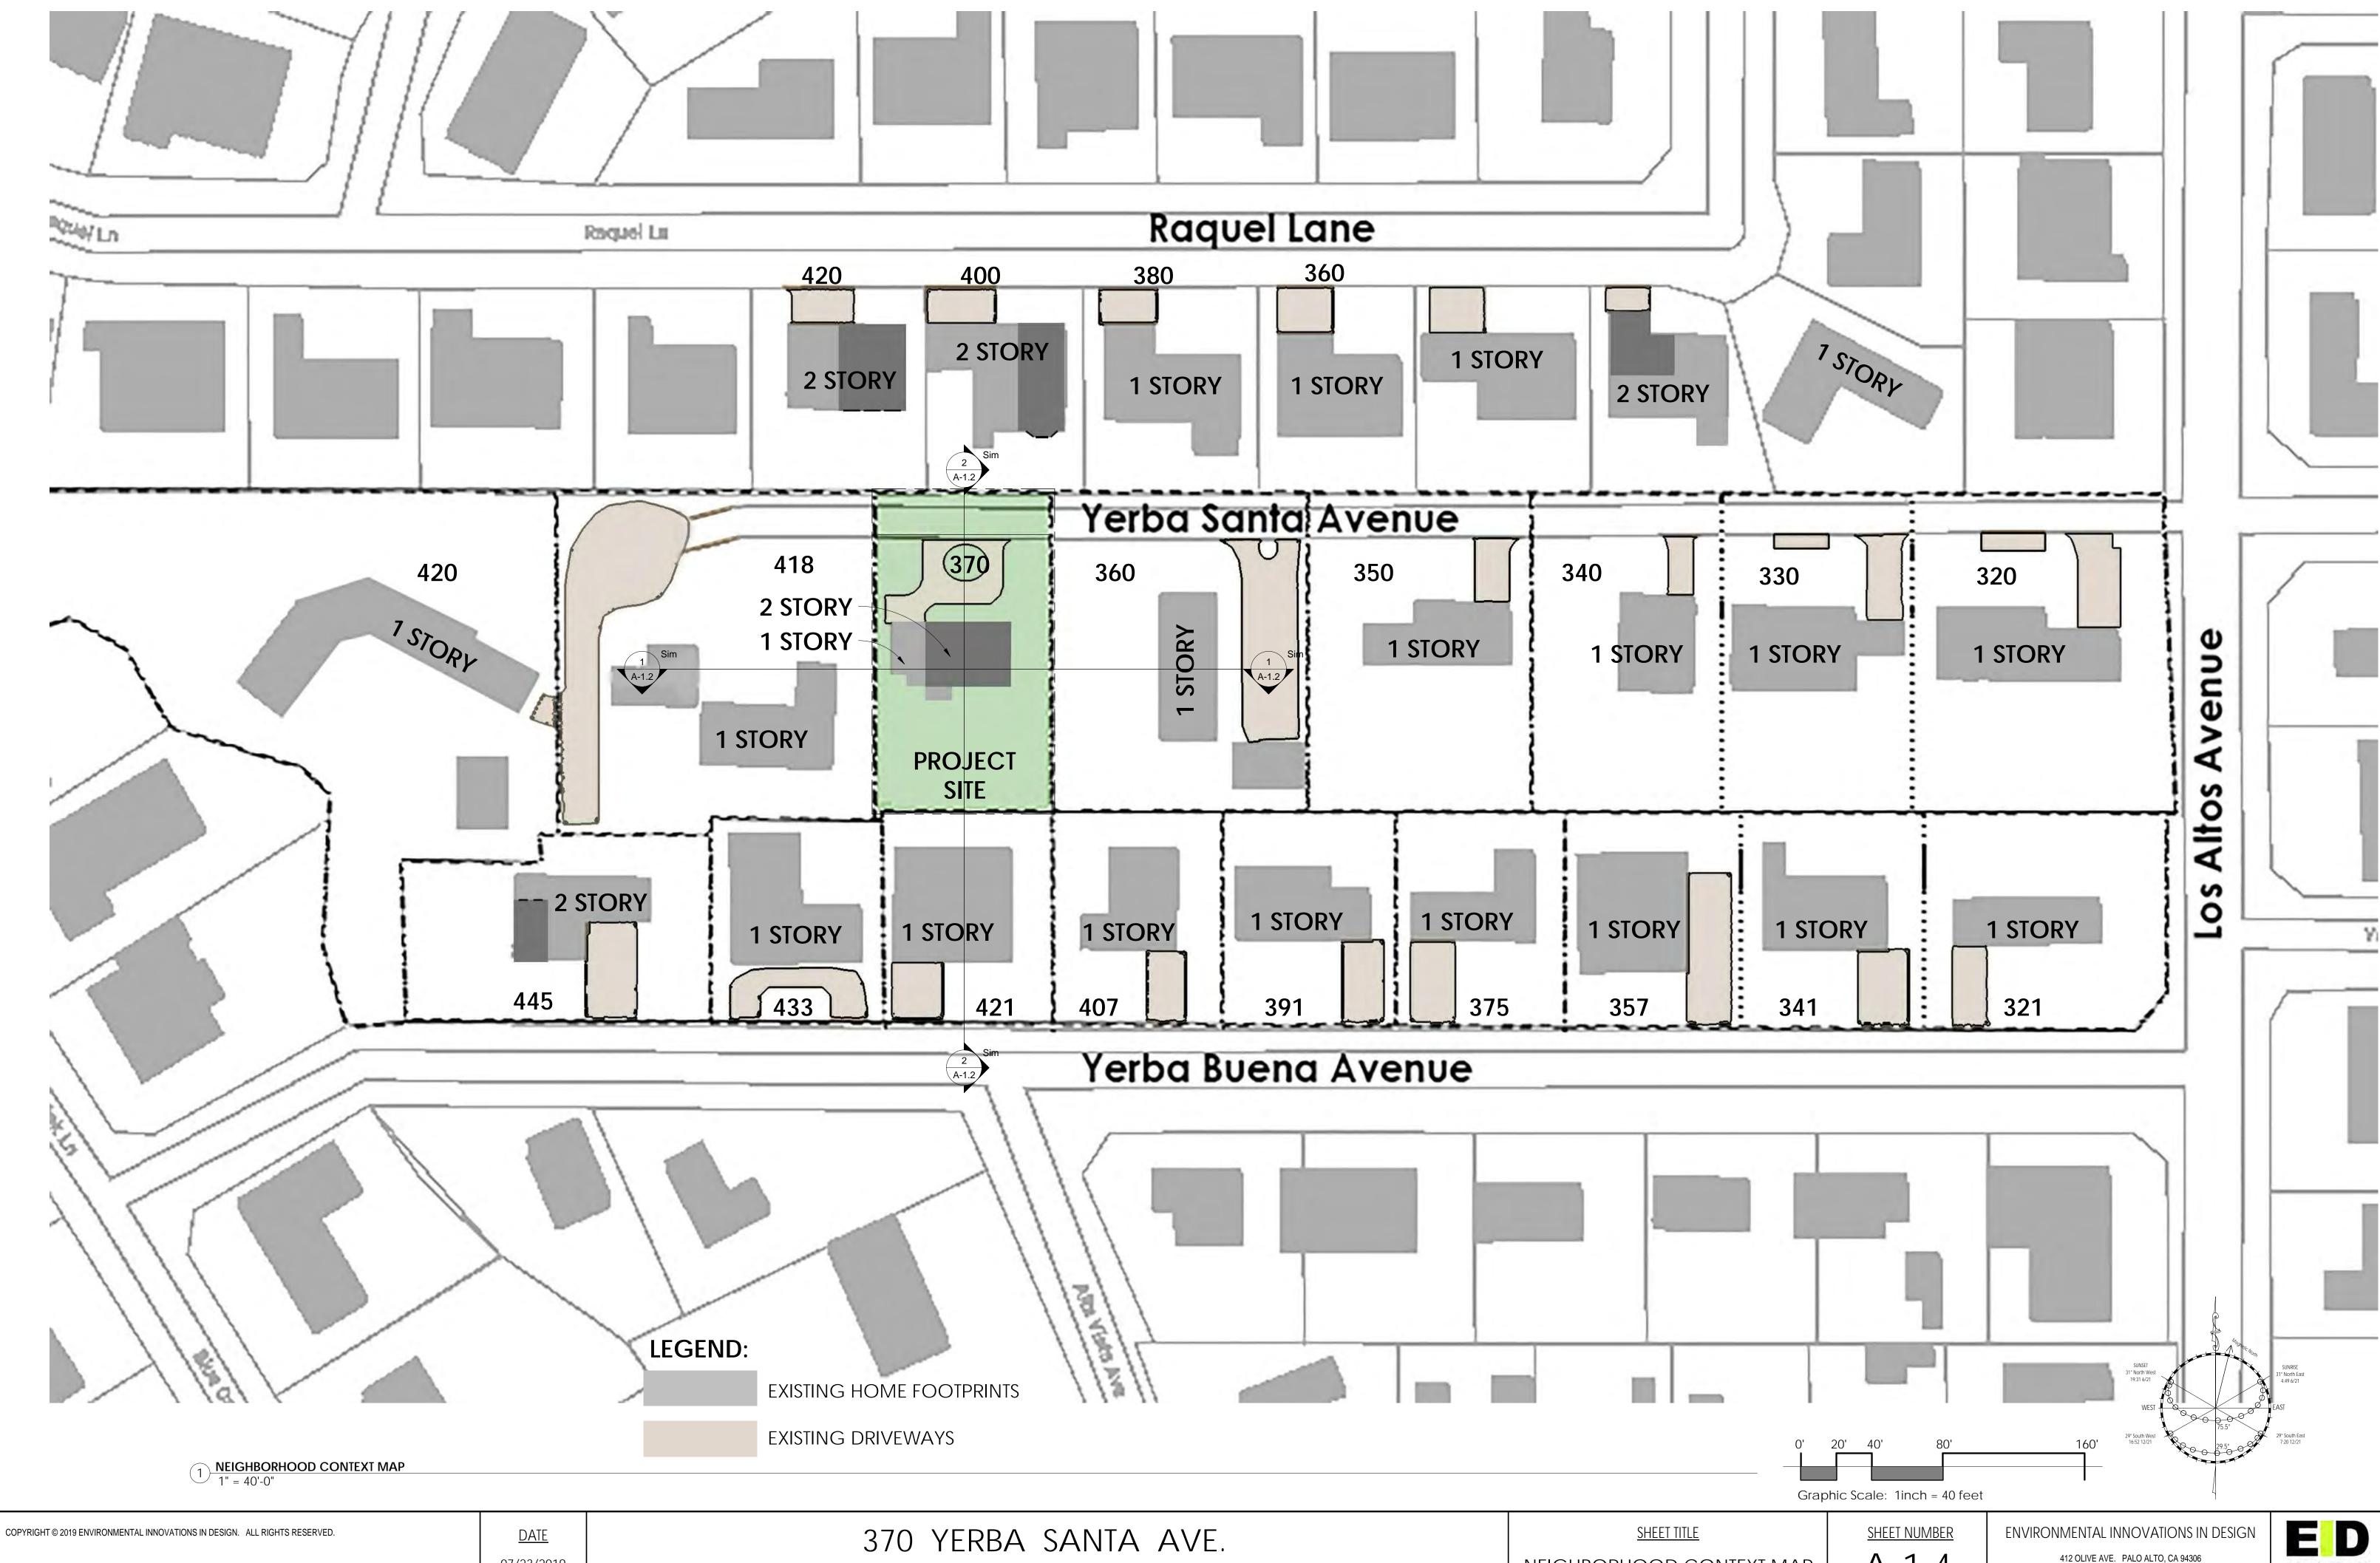



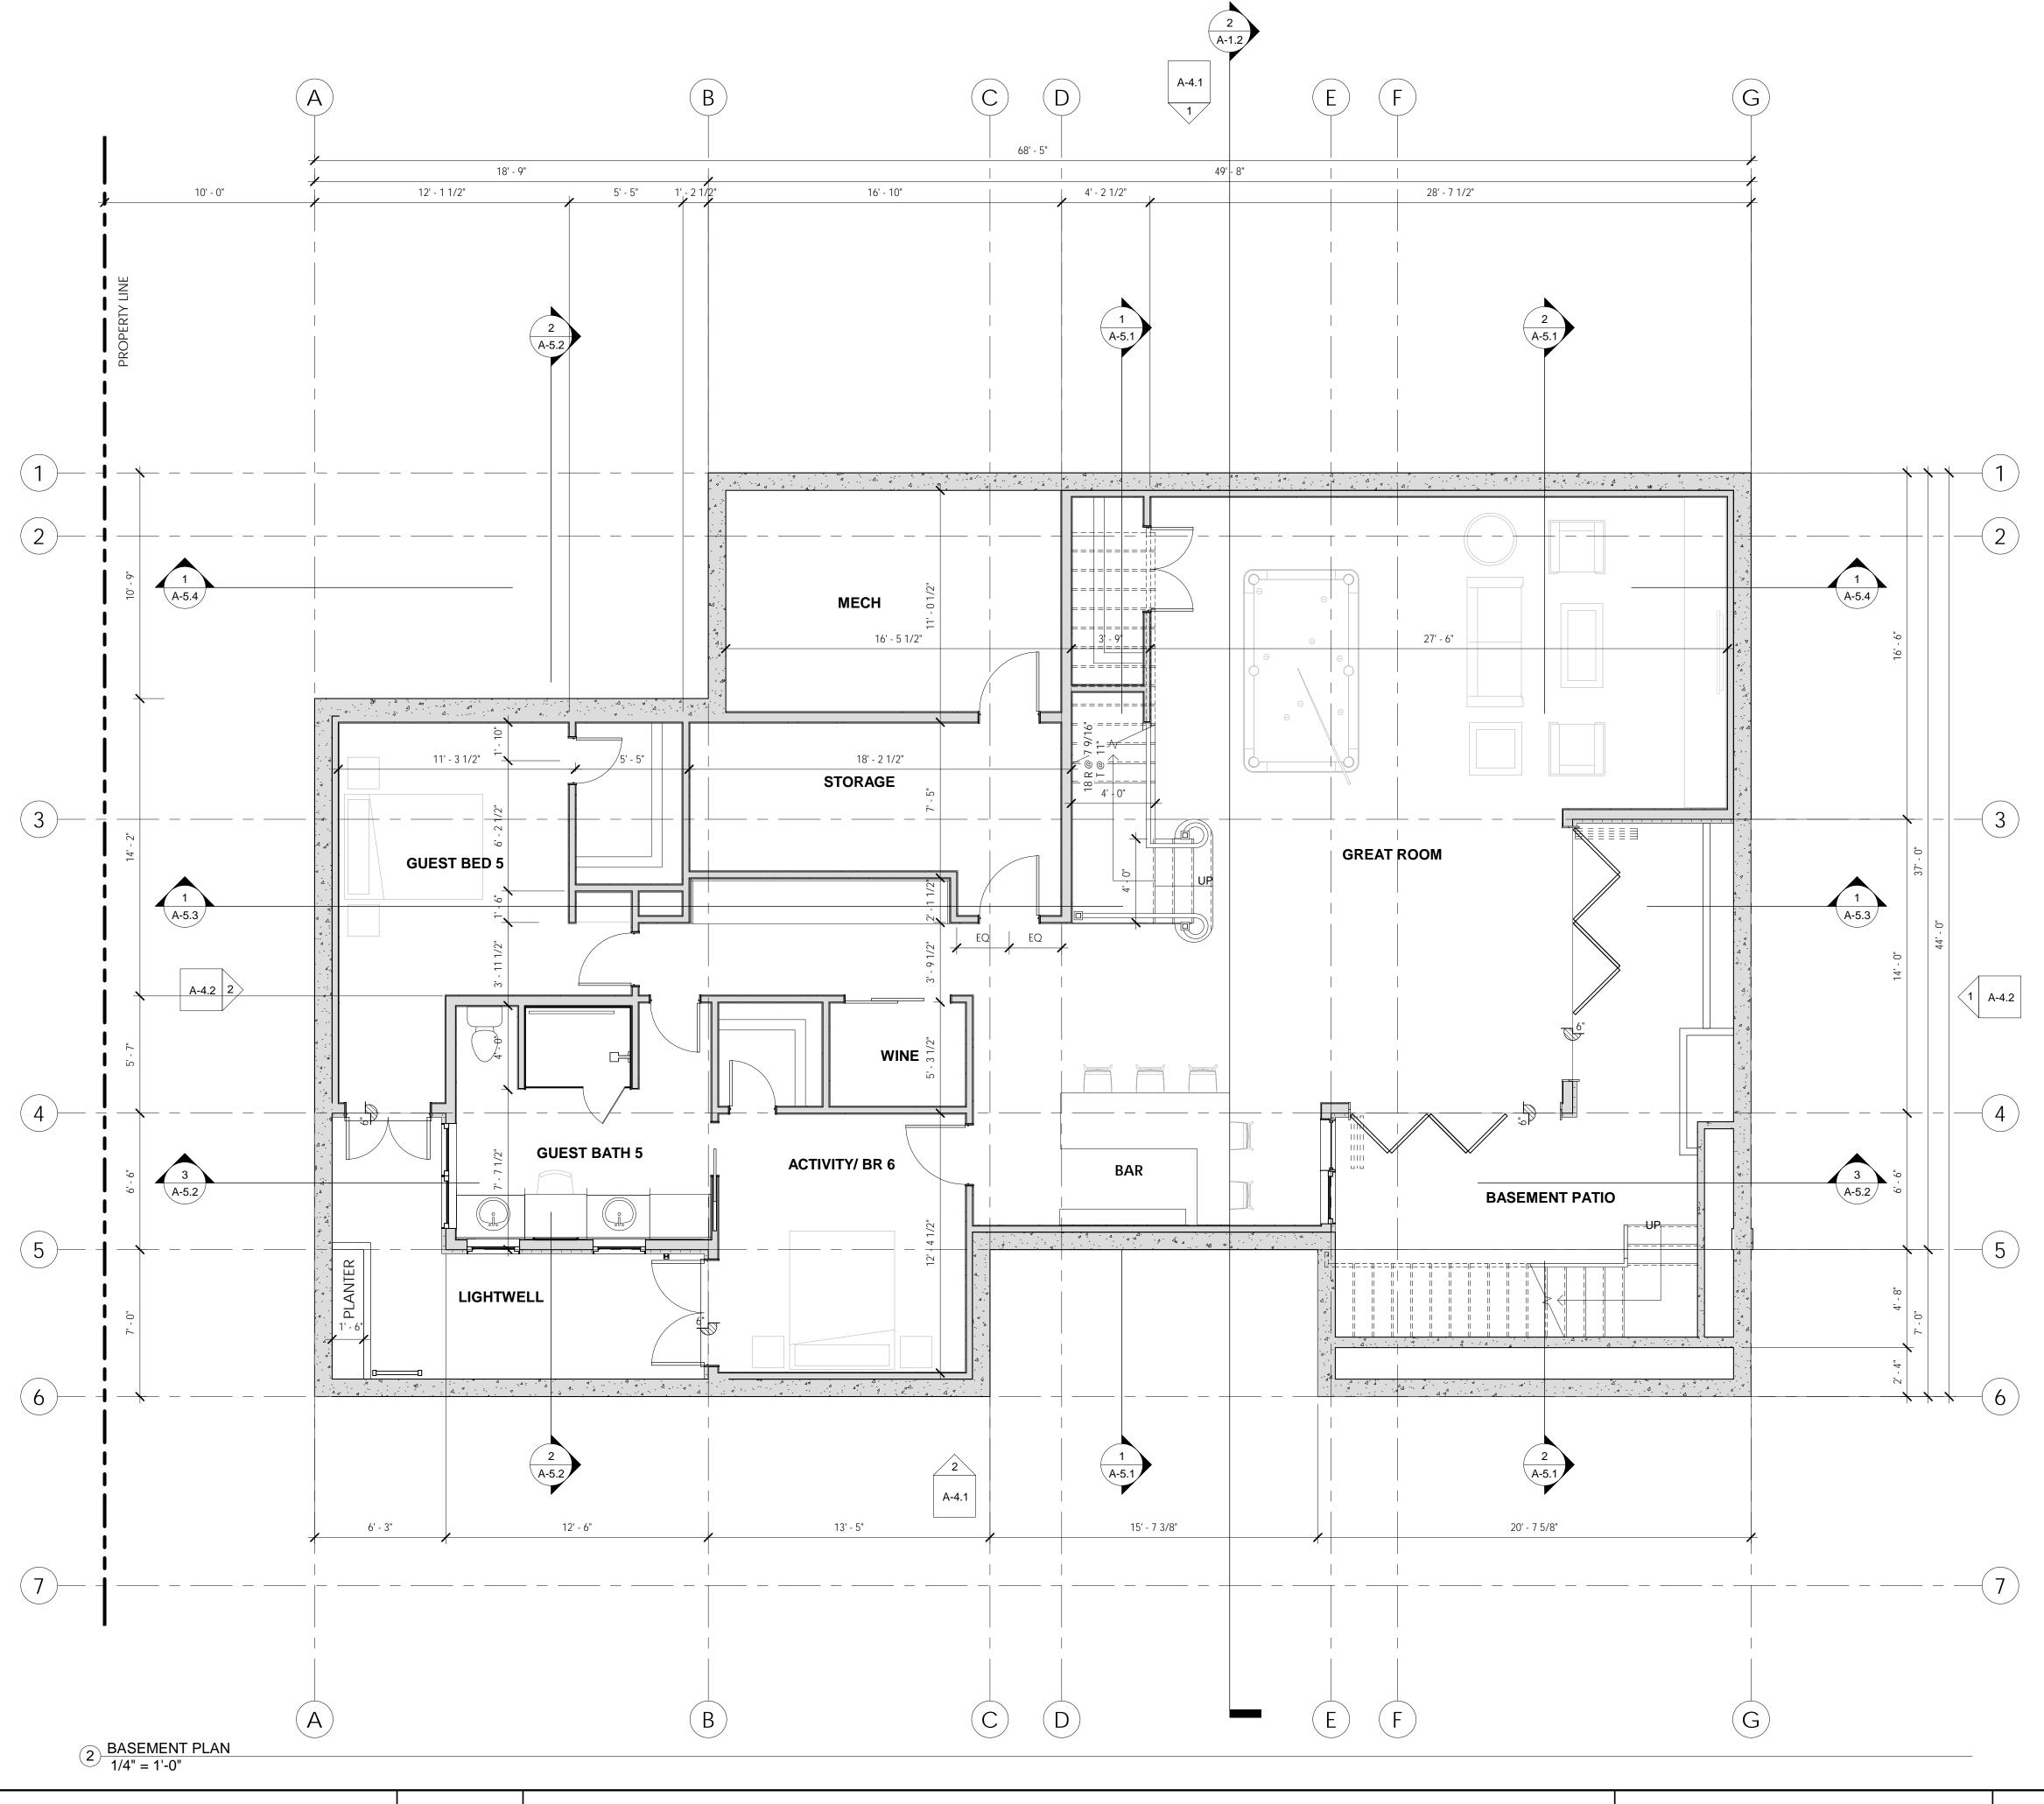



<u>DATE</u> 07/23/2019 370 YERBA SANTA AVE.


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SHEET TITLE

BASEMENT PLAN

SHEET NUMBER
A-3.0

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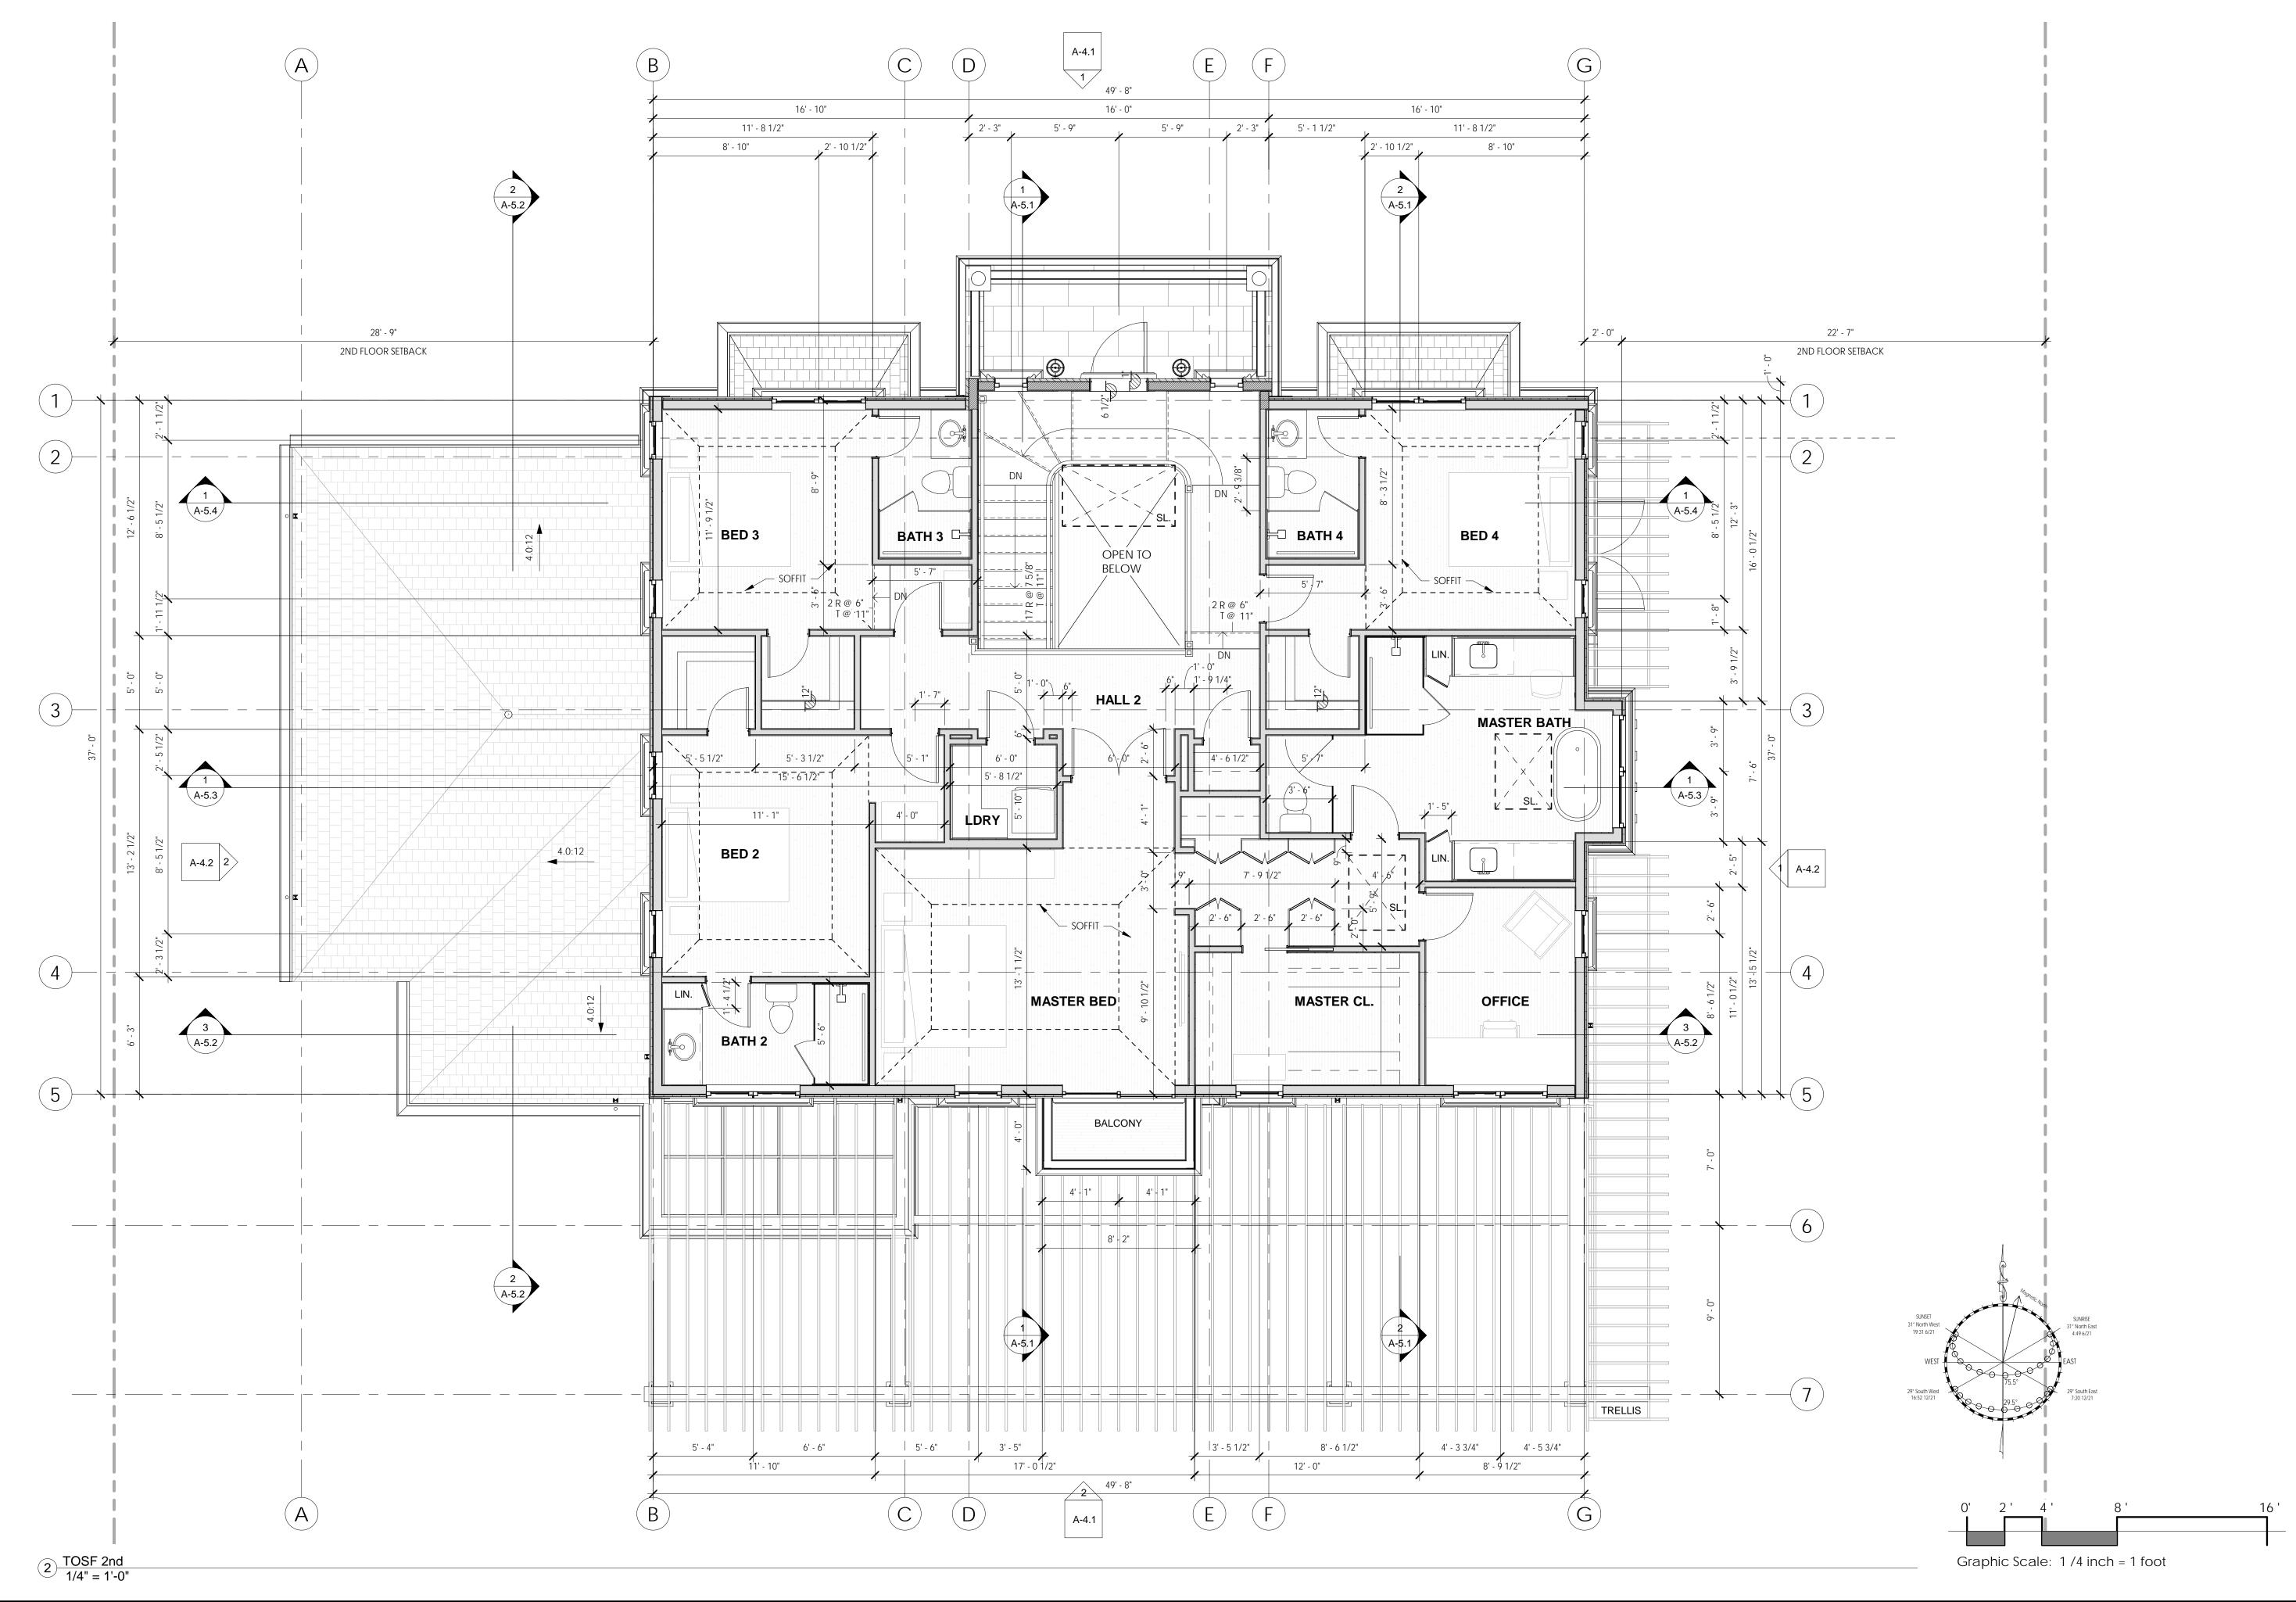


<u>Date</u> 07/23/2019 LOS ALTOS, CALIFORNIA 94022

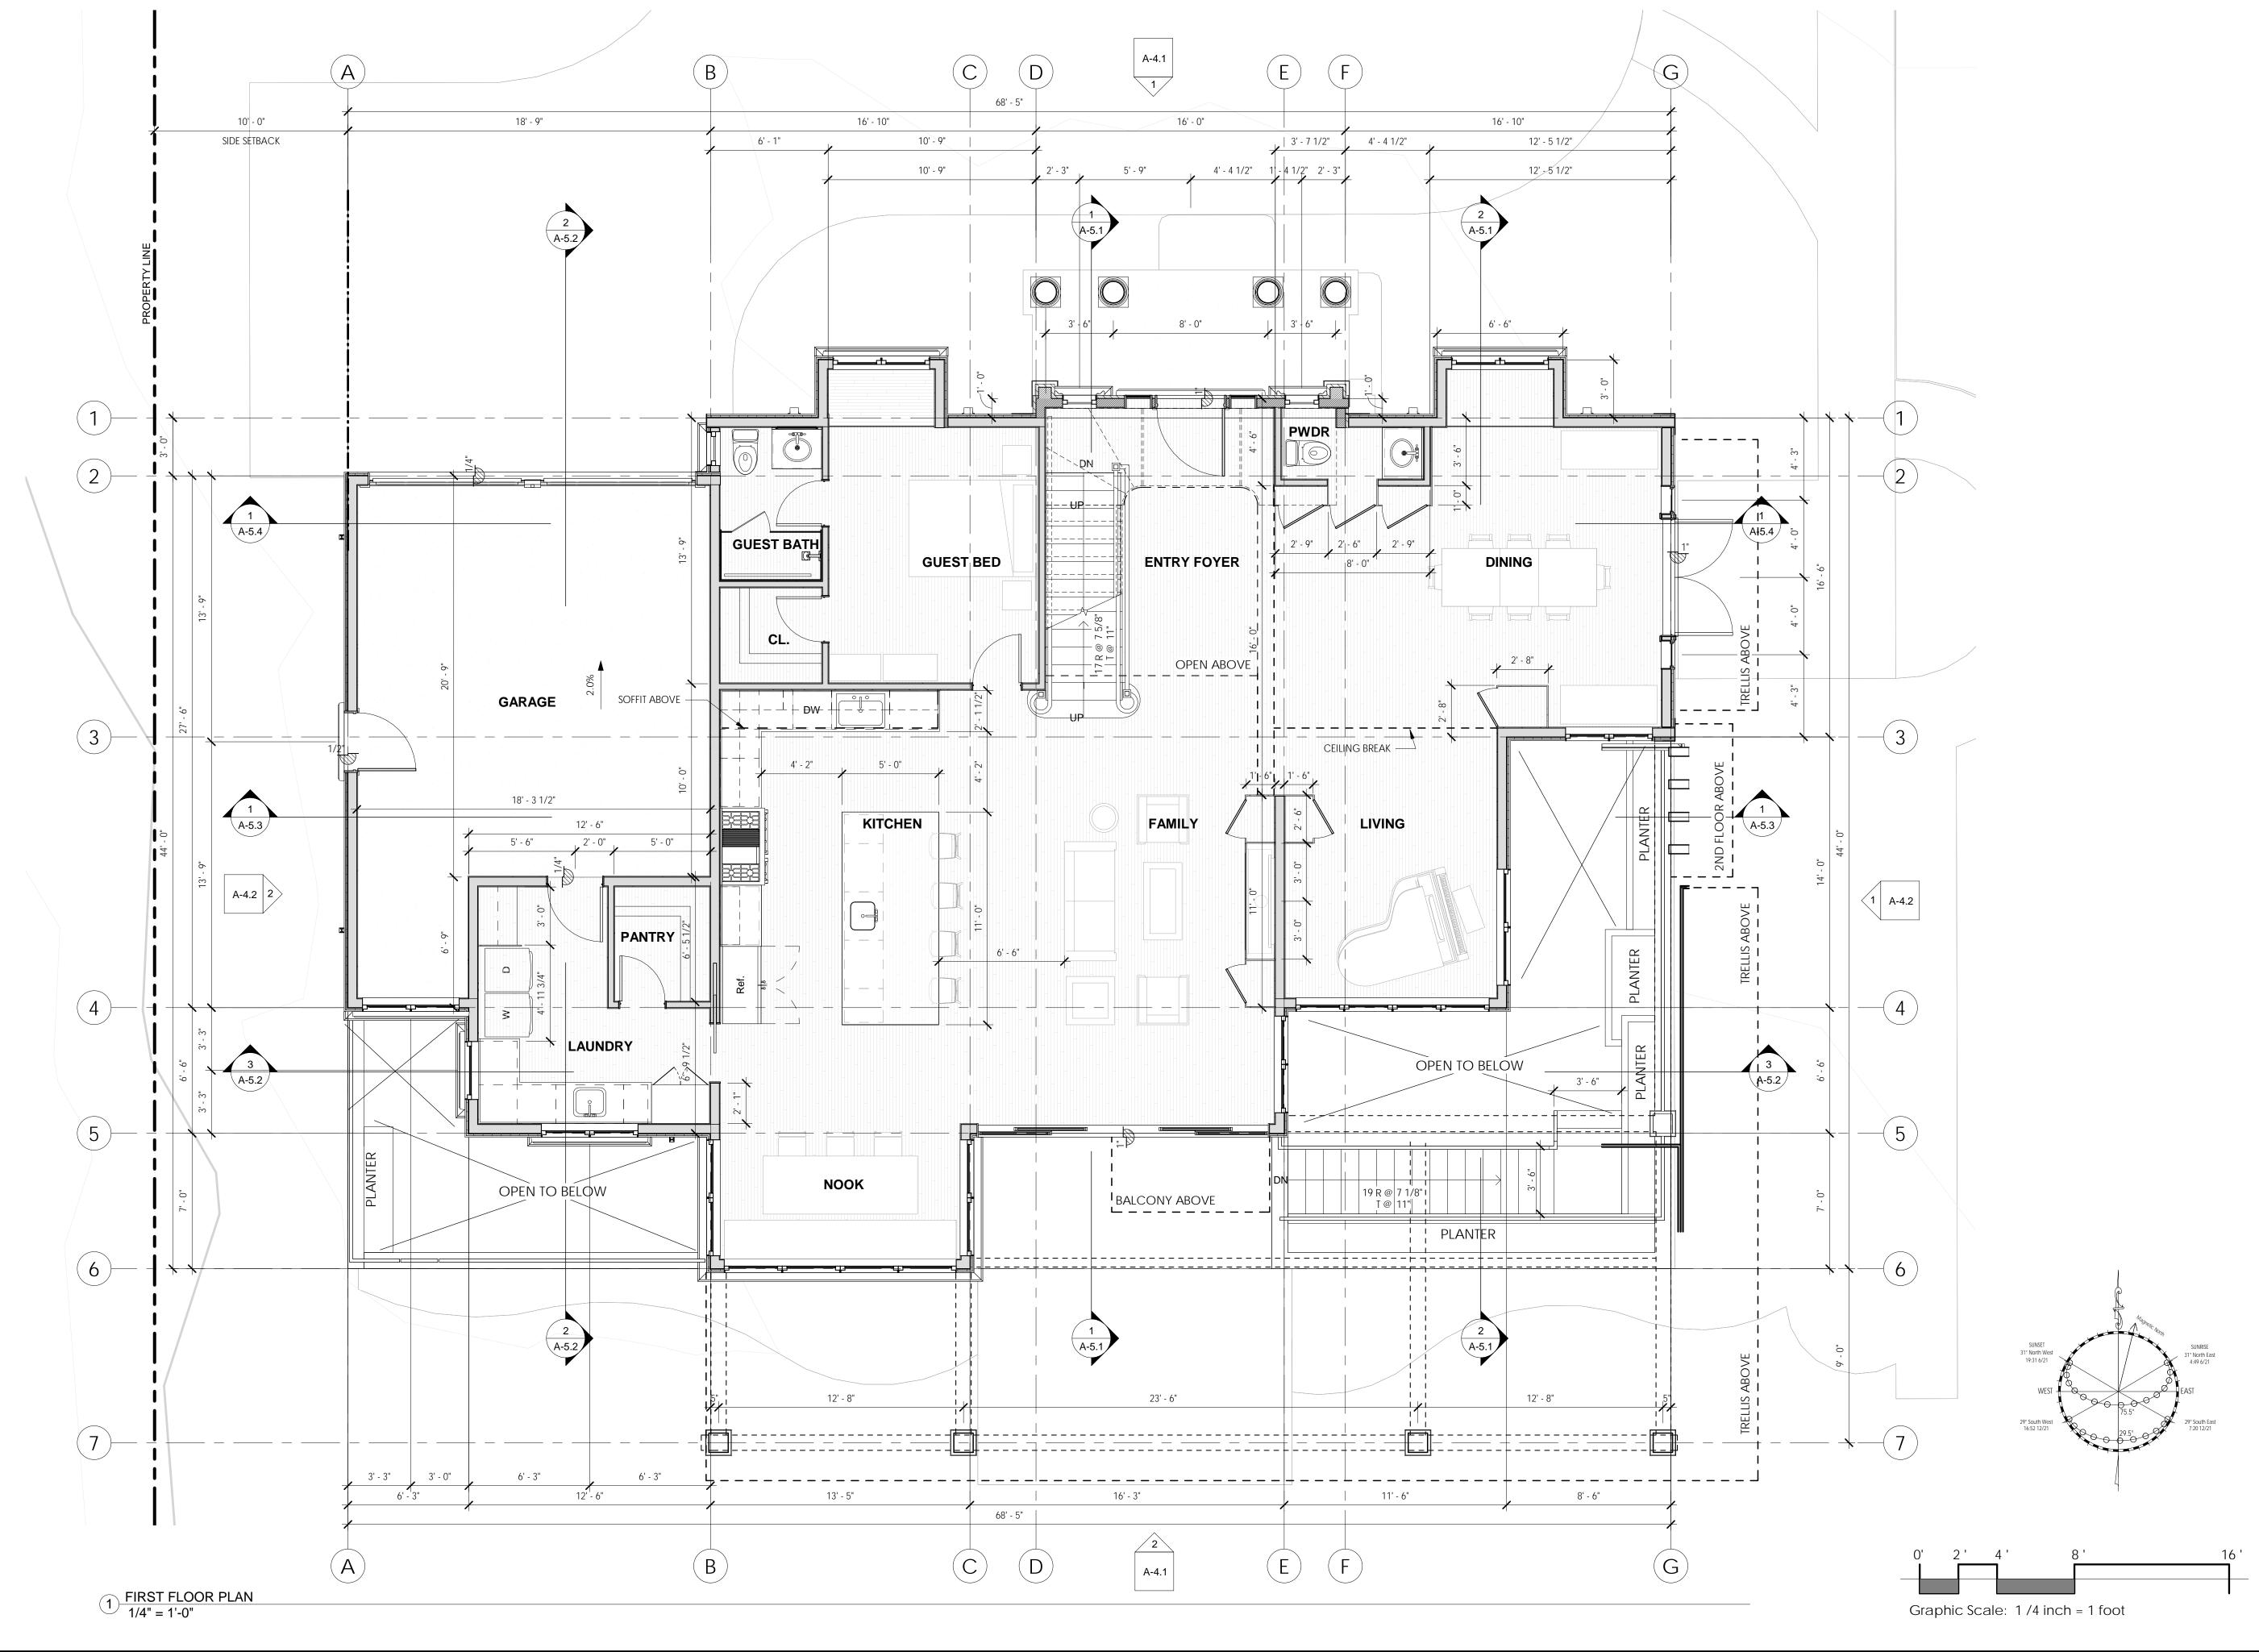SHEET TITLE FIRST FLOOR PLAN


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ENVIRONMENTAL INNOVATIONS IN DESIGN 412 OLIVE AVE. PALO ALTO, CA 94306




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412 OLIVE AVE. PALO ALTO, CA 94306
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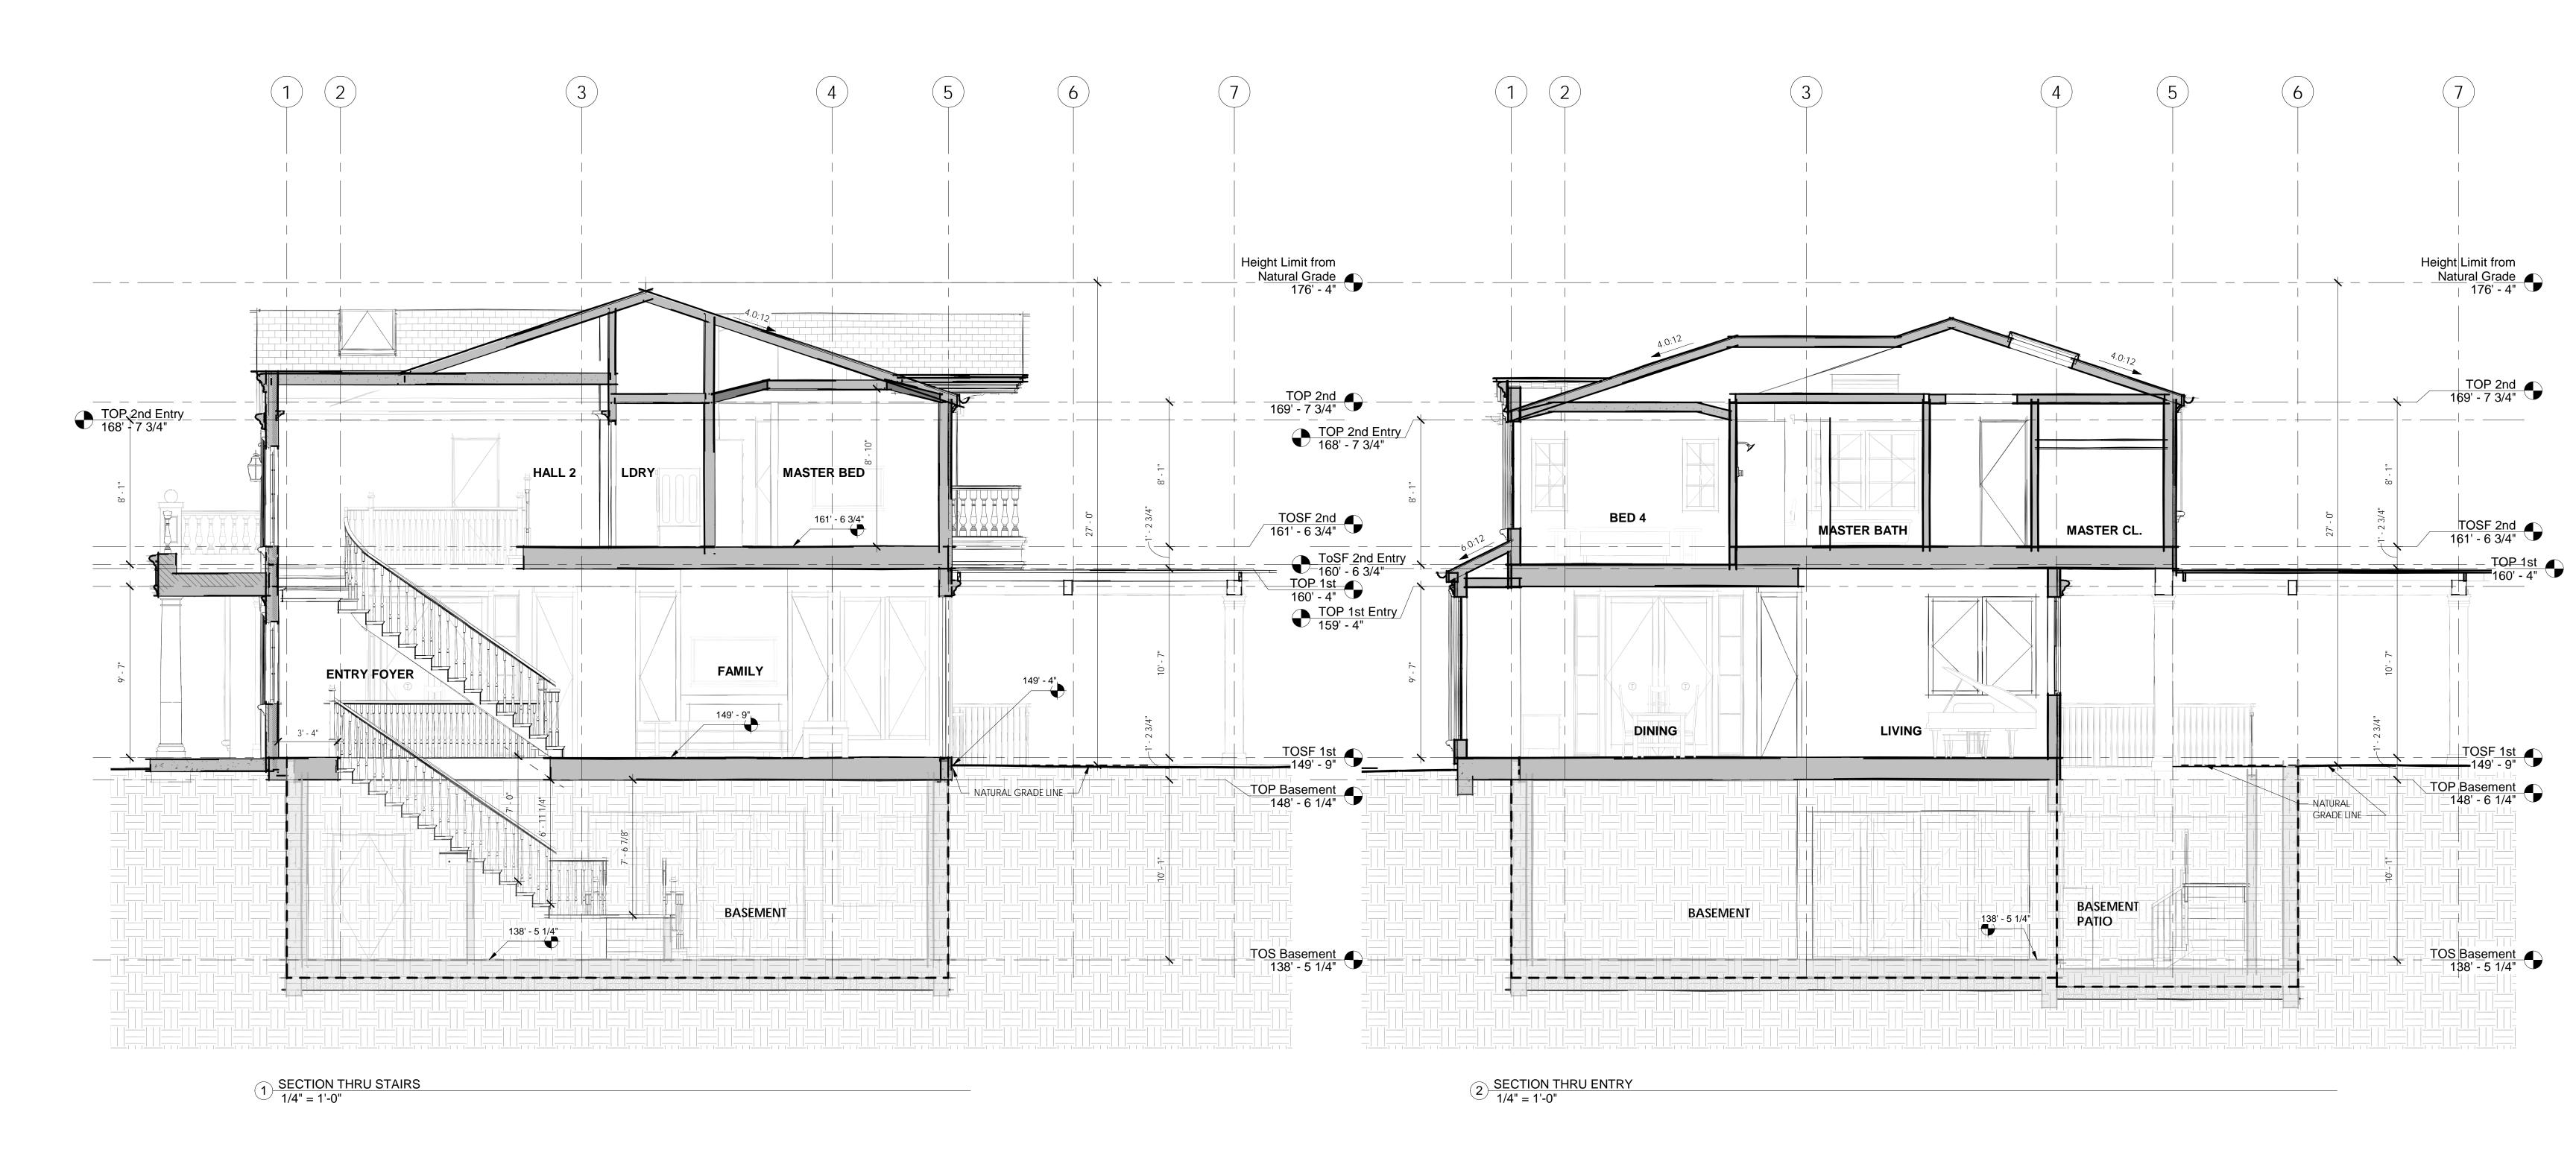


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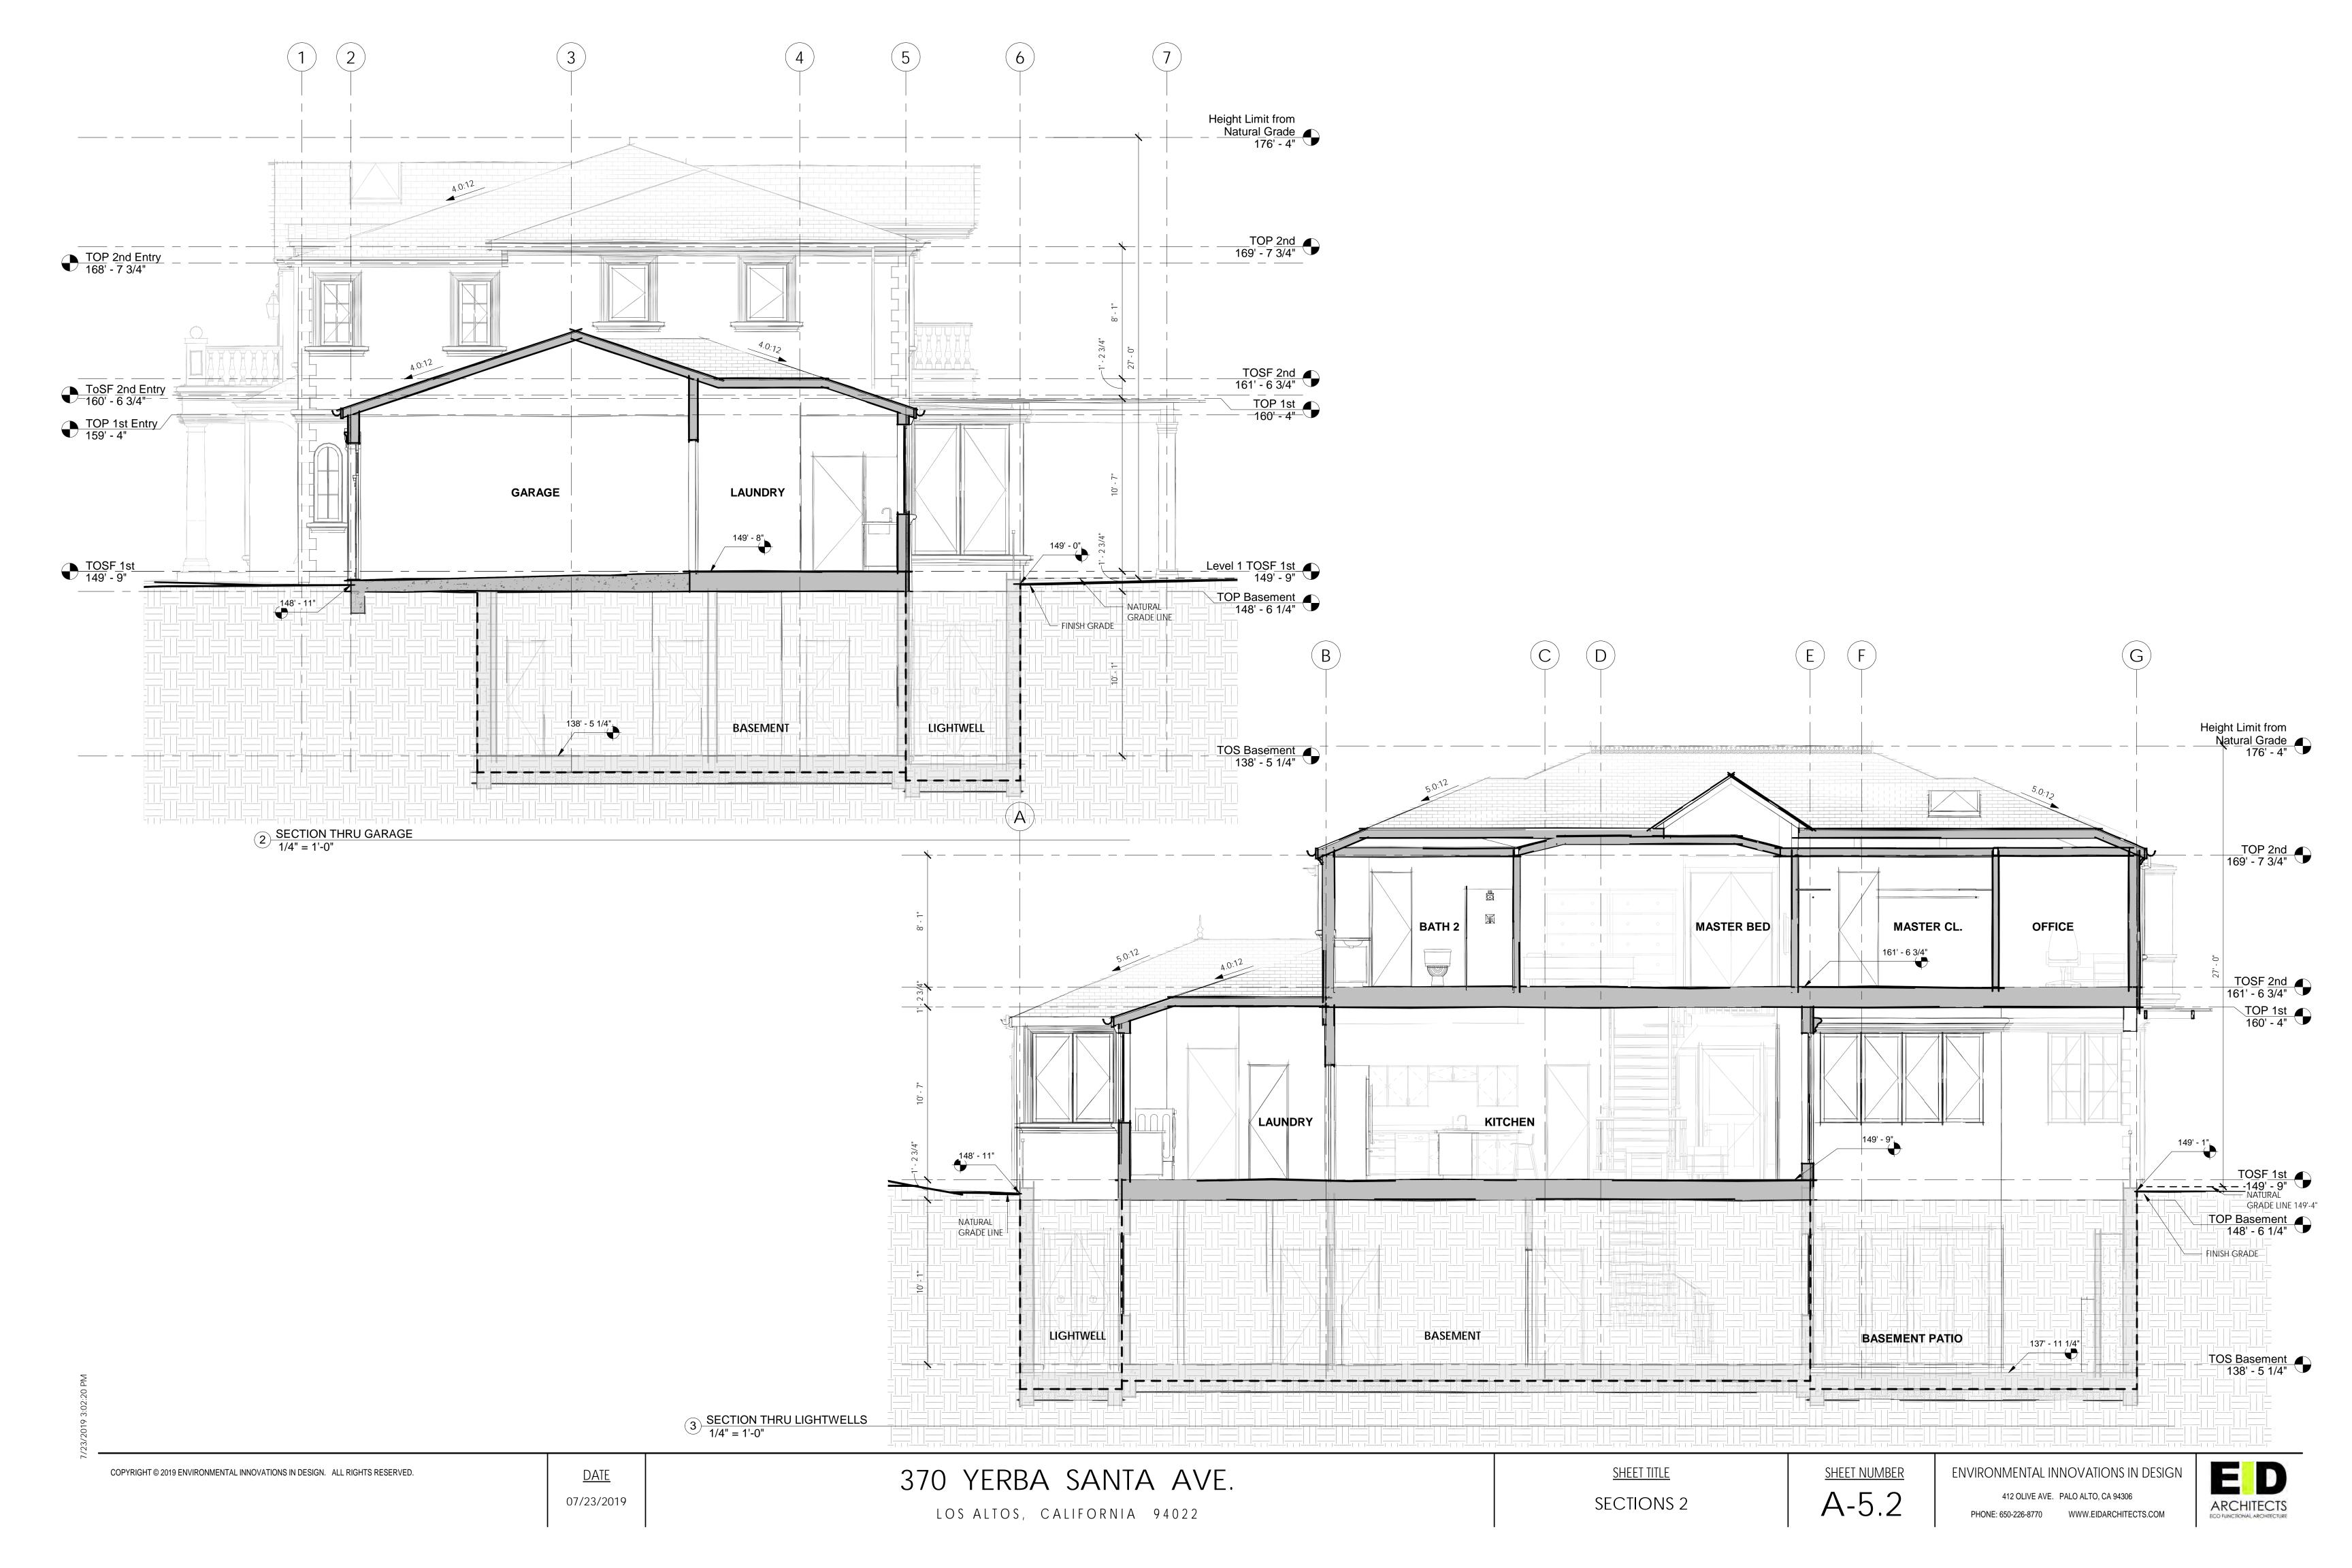





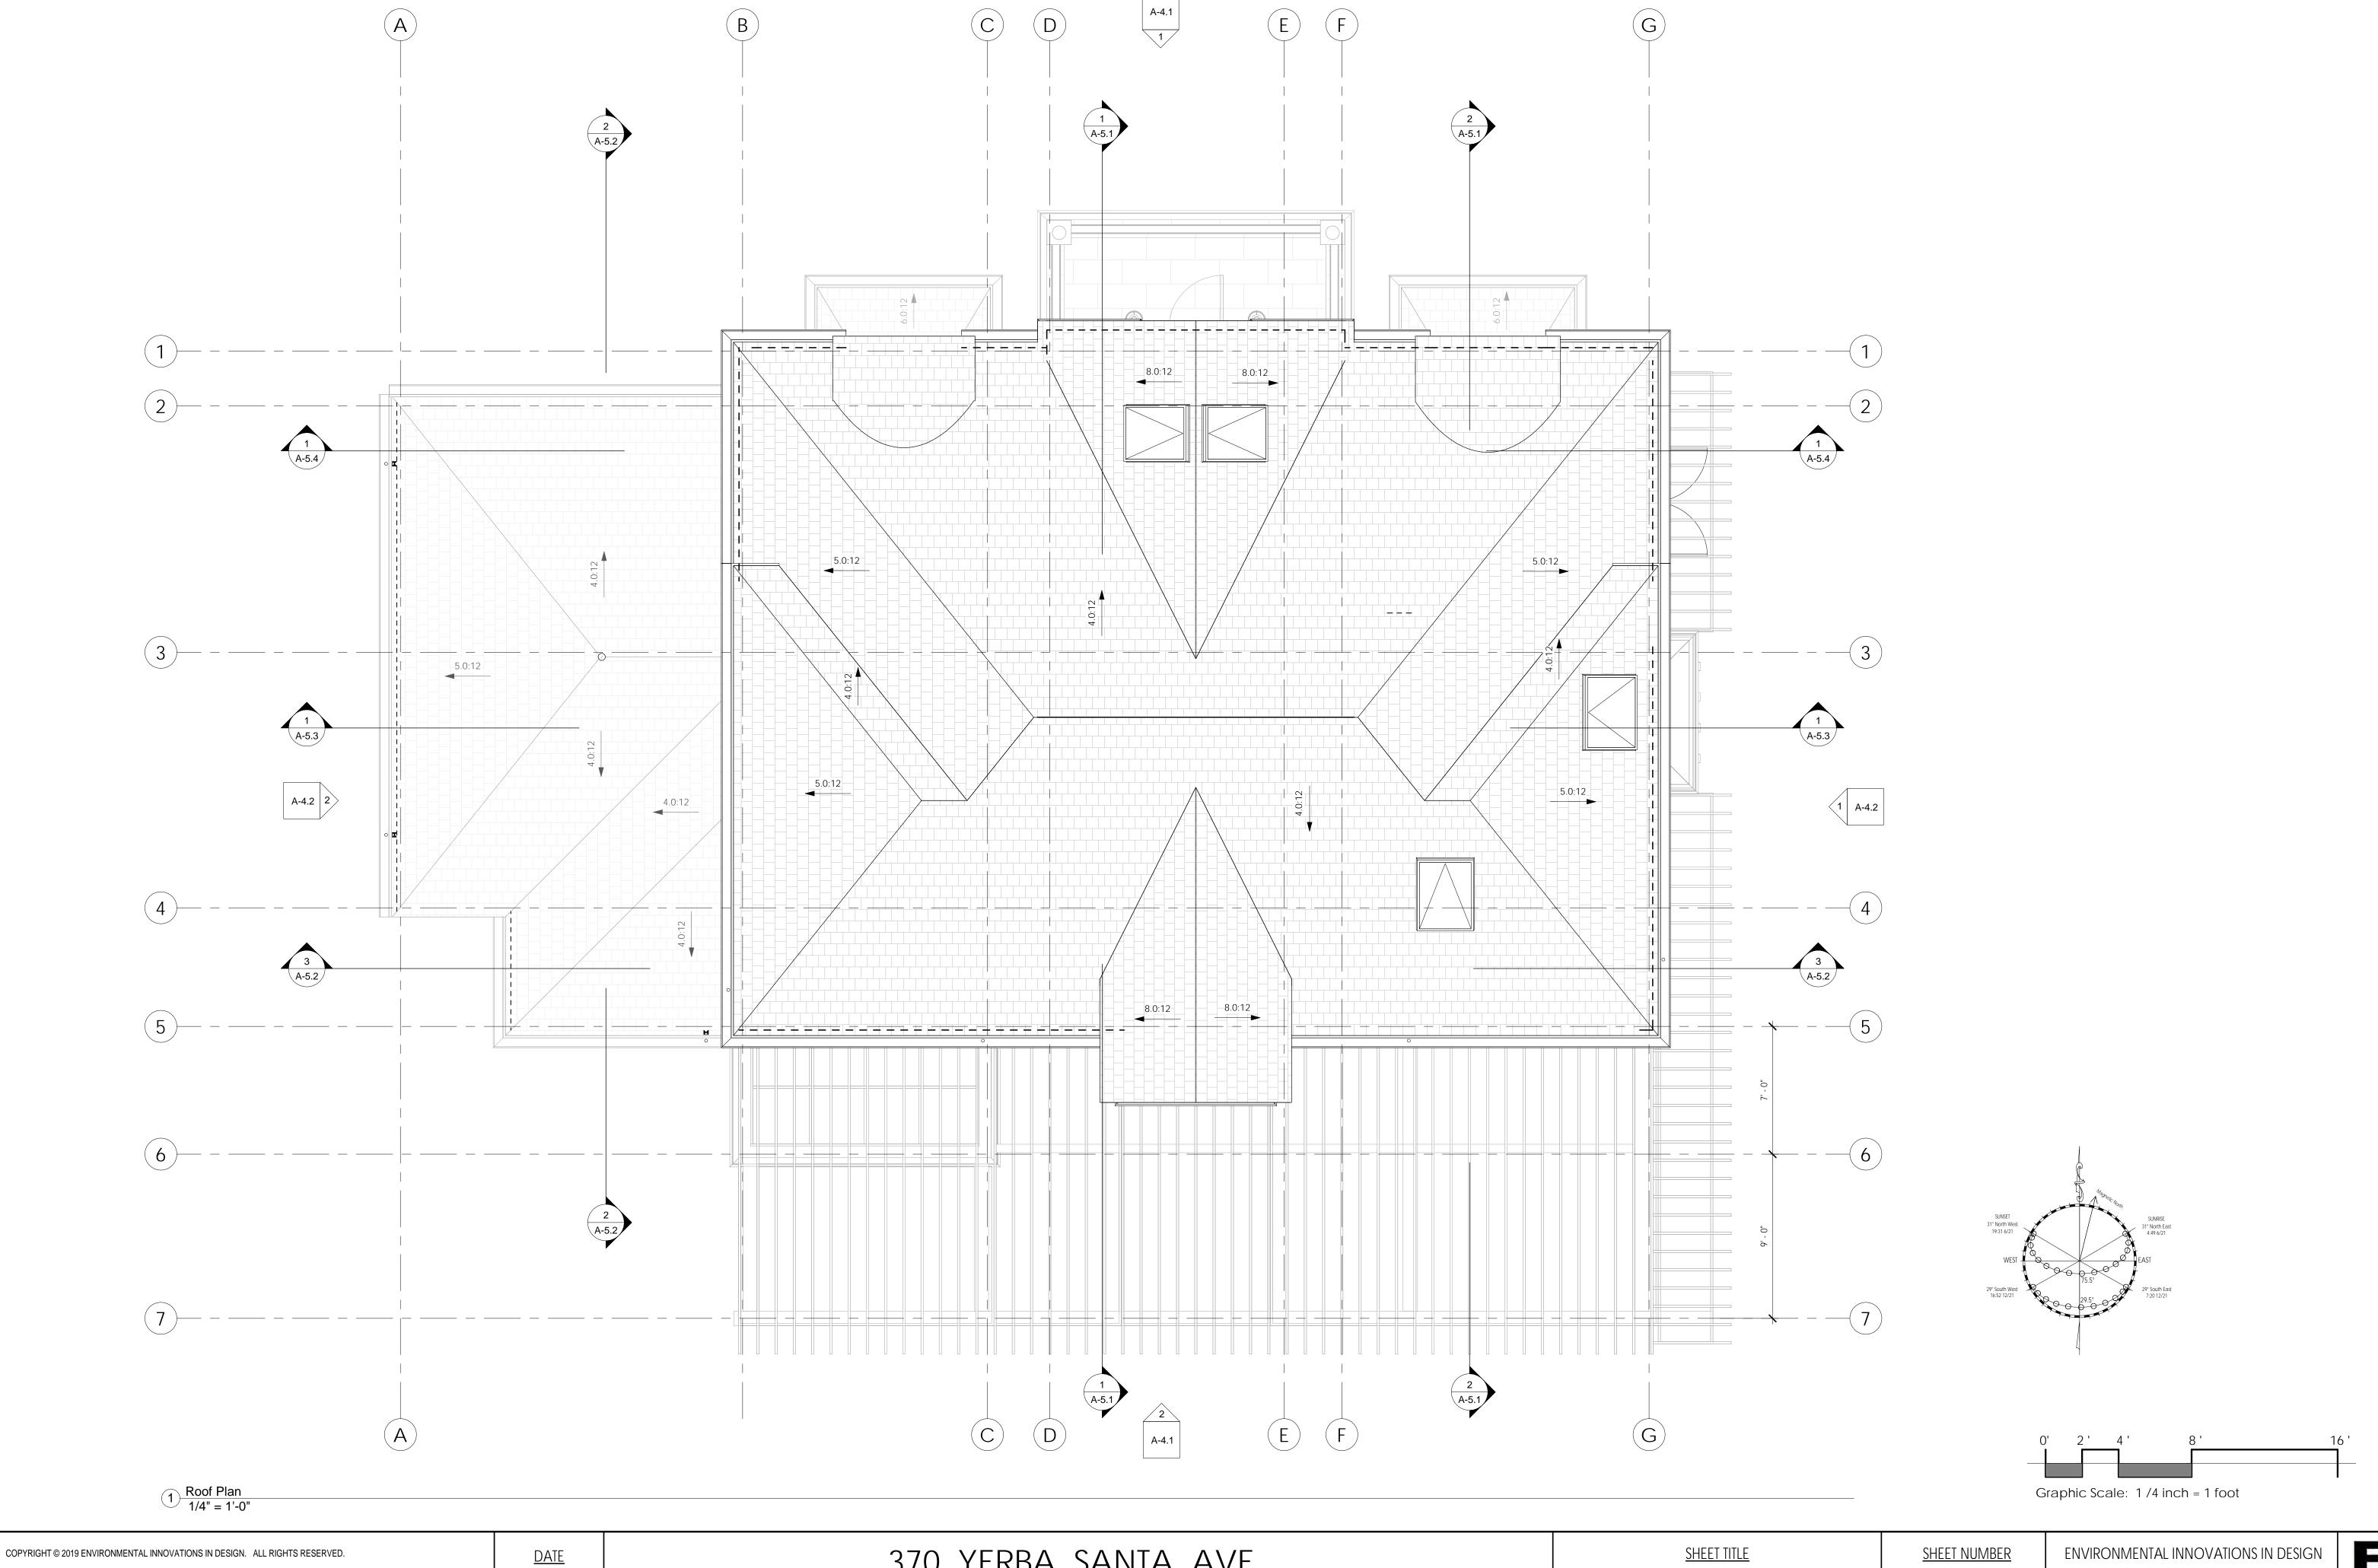

SHEET TITLE

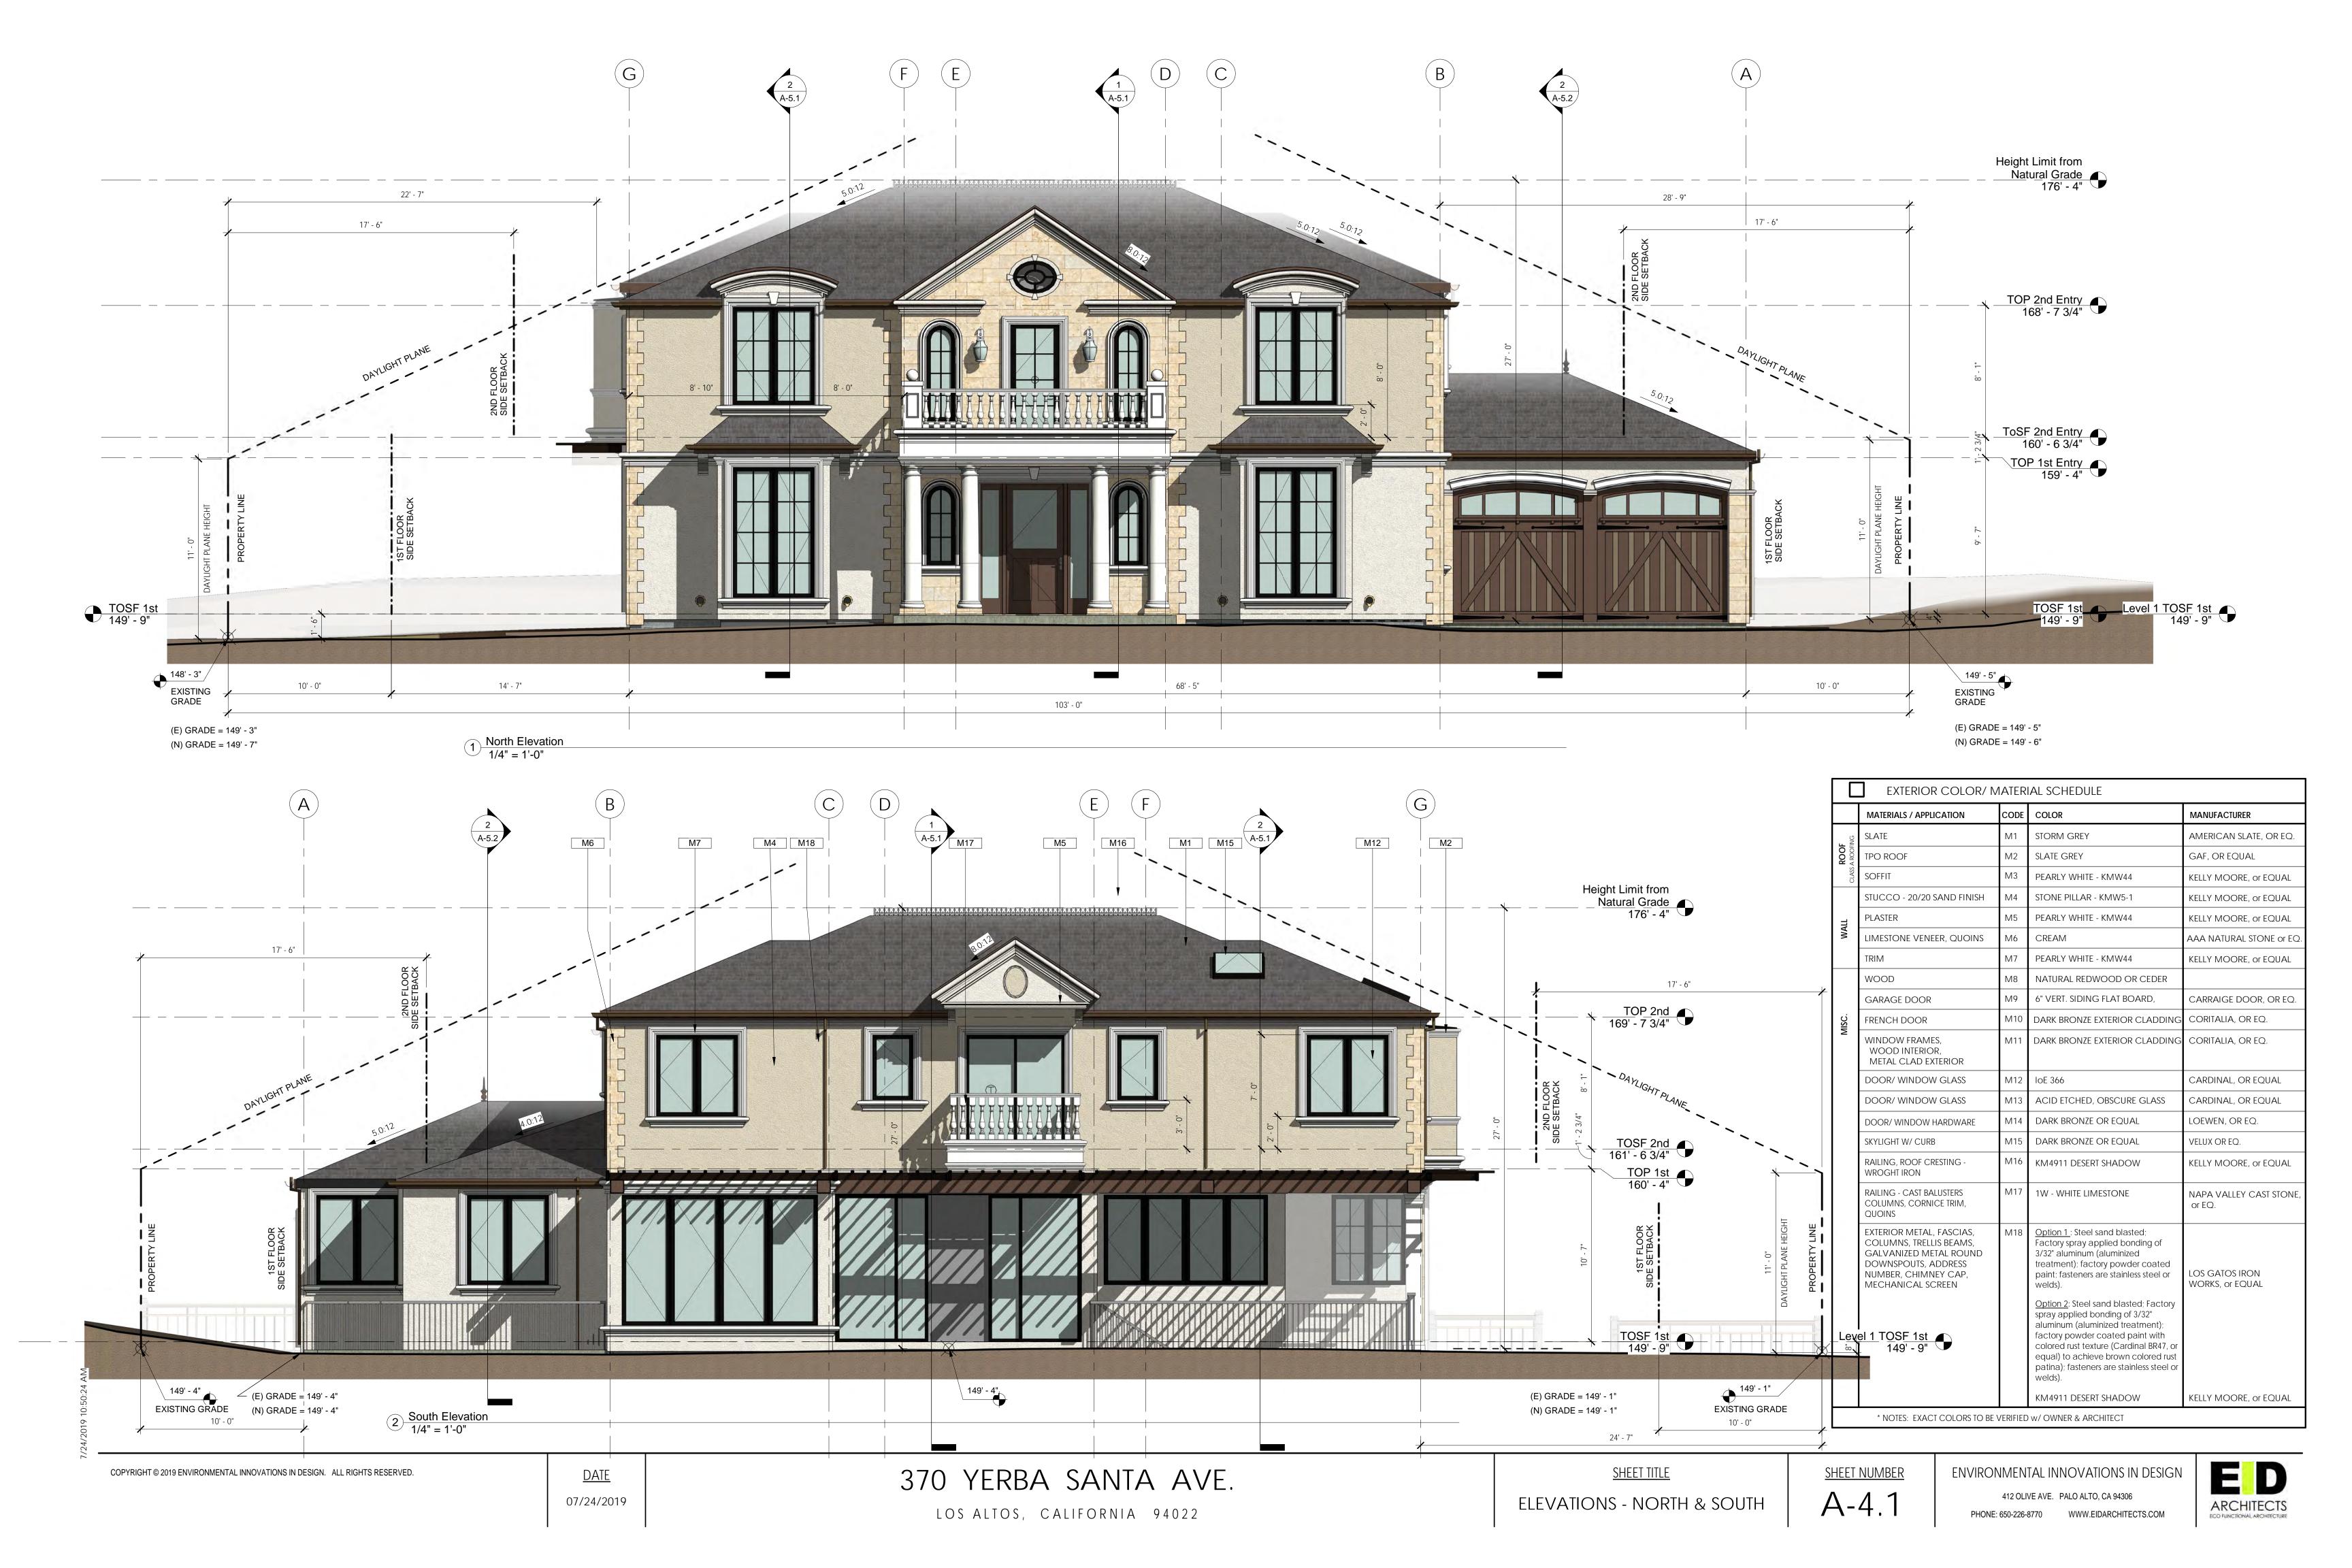SECTIONS 1



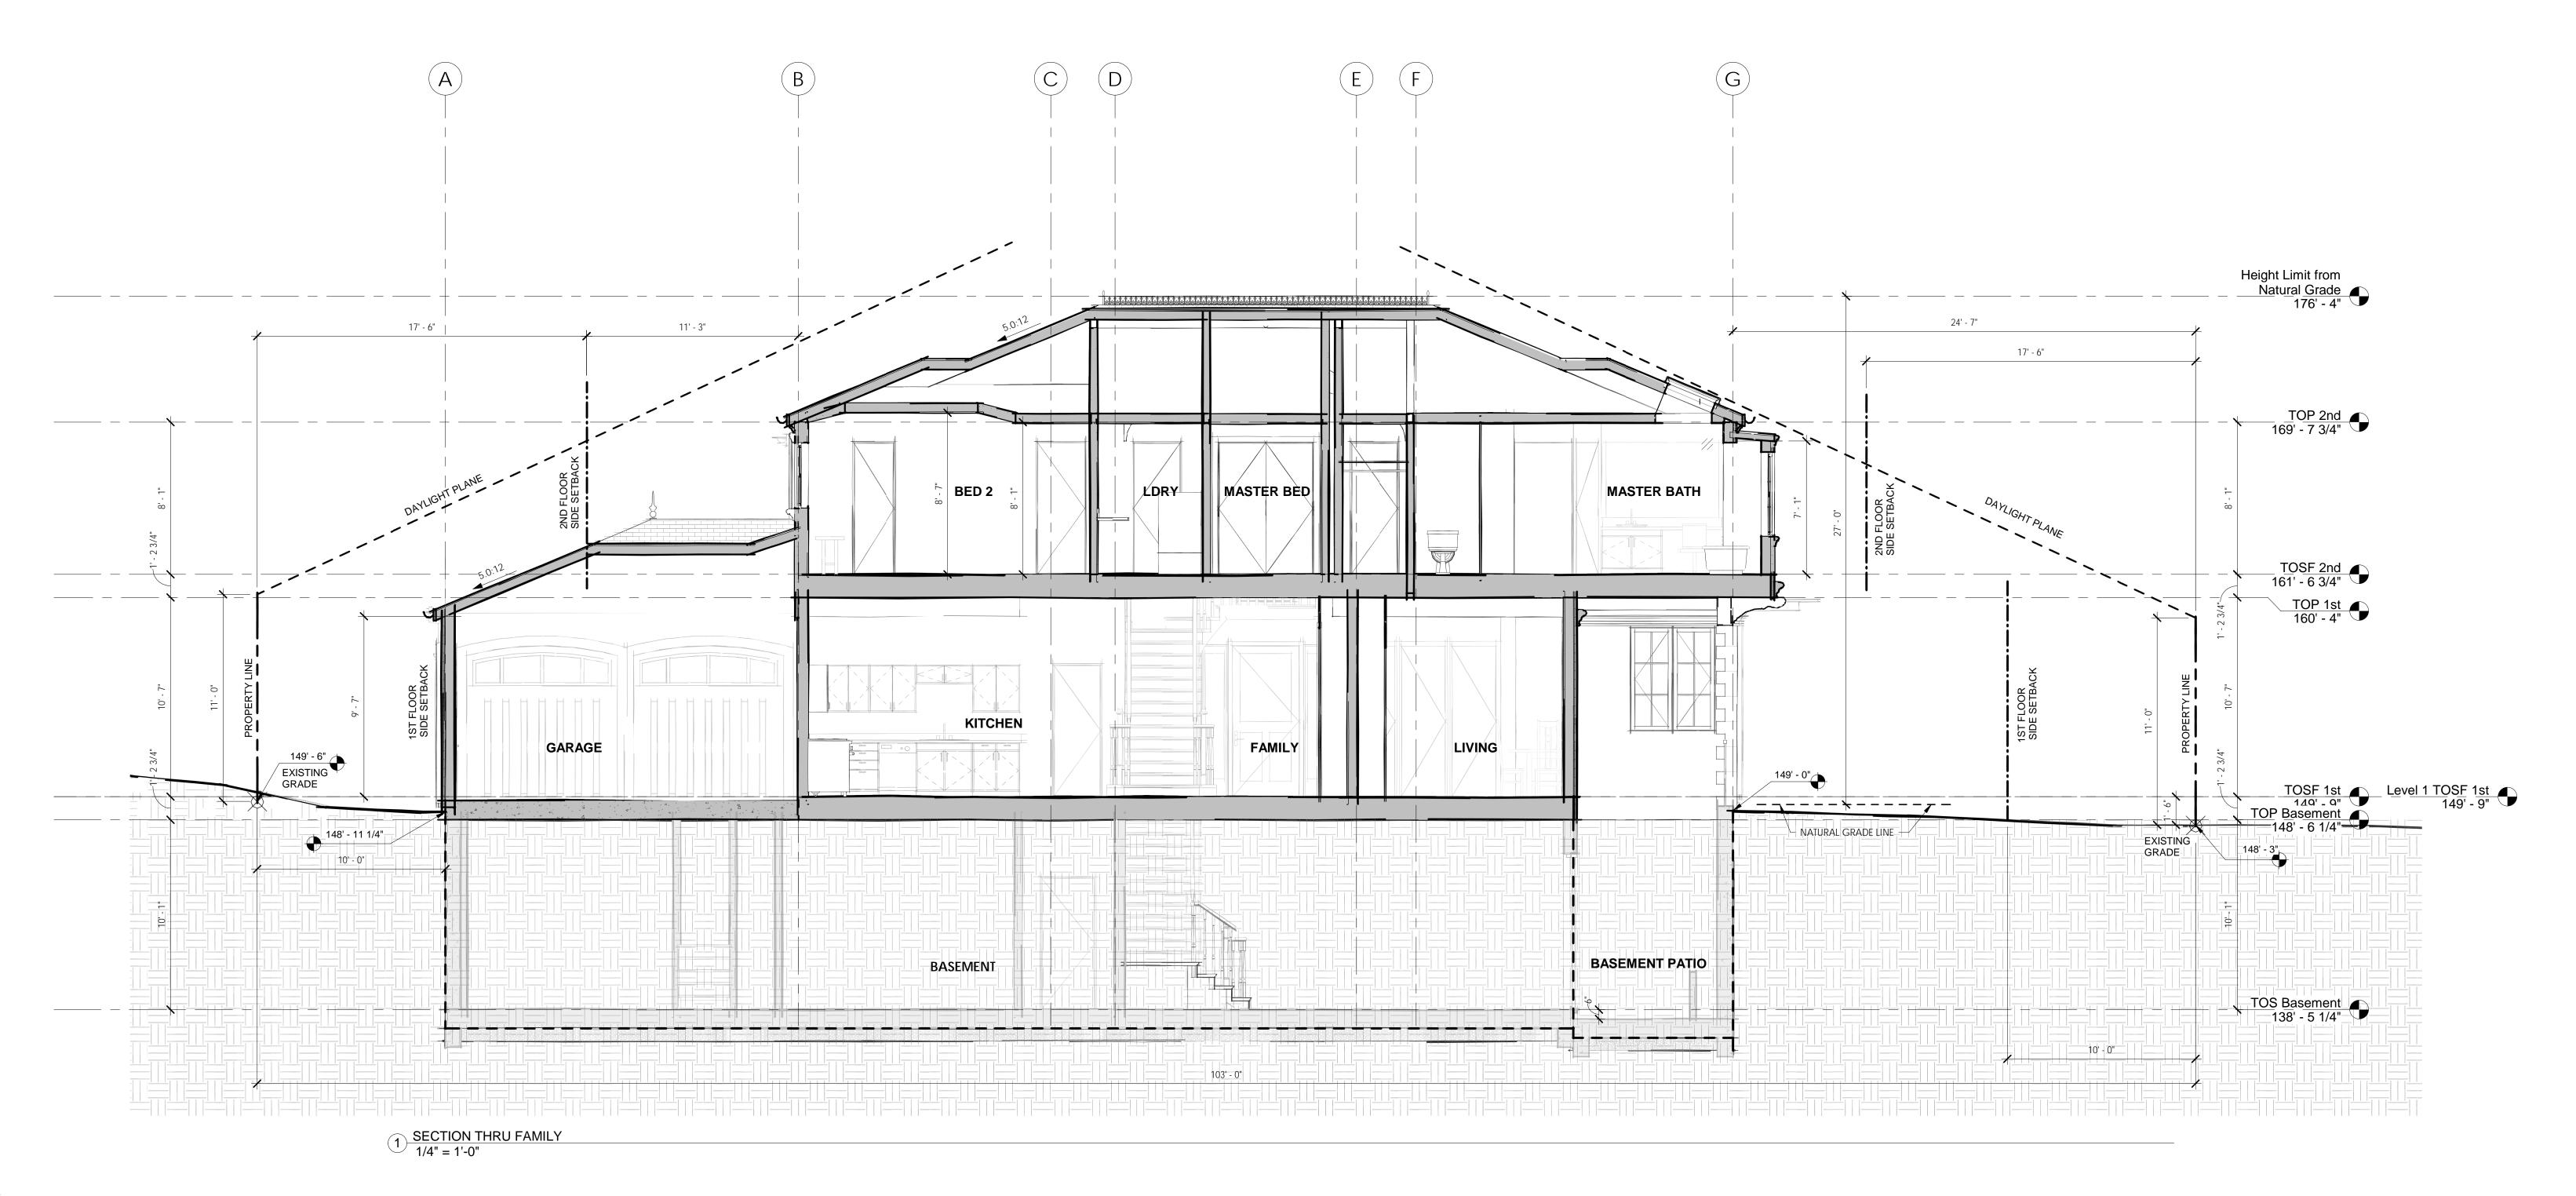


SHEET TITLE

SECTIONS 3

<u>Date</u>

07/23/2019

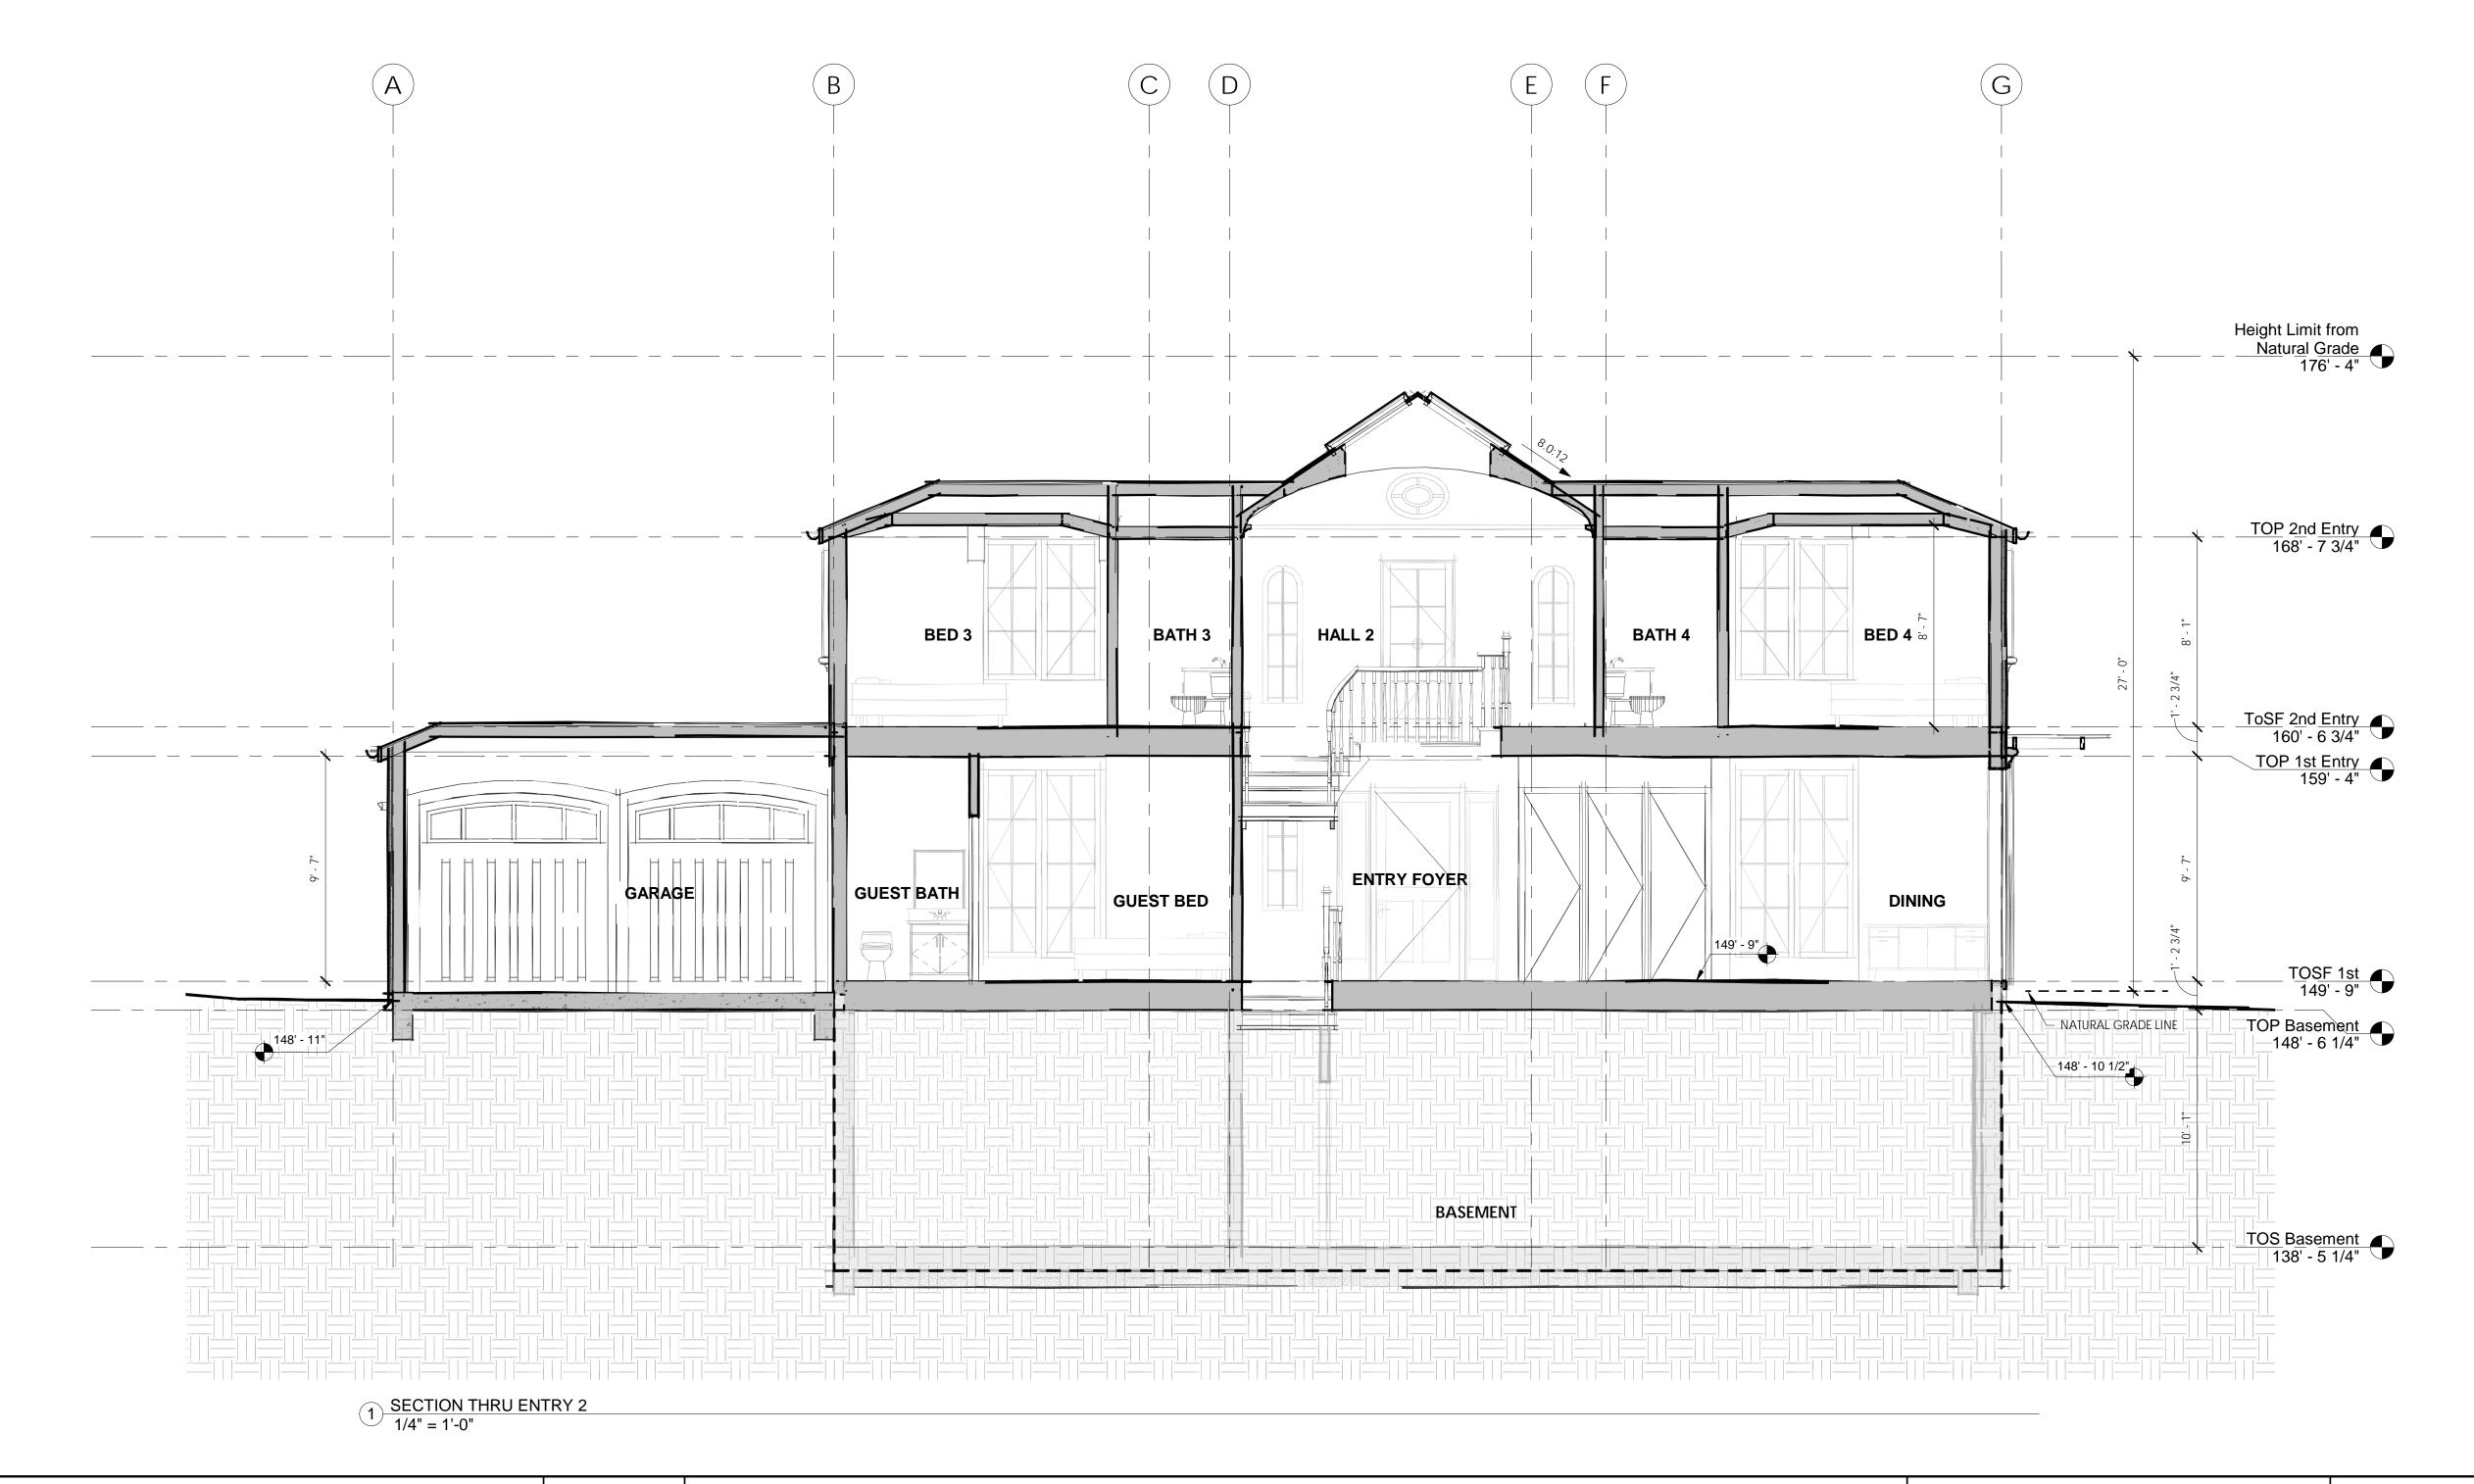





18. CAST STONE FOR TRIM



17. SLATE ROOF WITH SKYLIGHTS




16. BACKYARD TRELLIS AND PATIO, ROUND COLUMNS AT FRONT BALCONY



15. SECTIONAL GARAGE DOORS TO LOOK LIKE HINGED DOORS



14. BREAKFAST NOOK

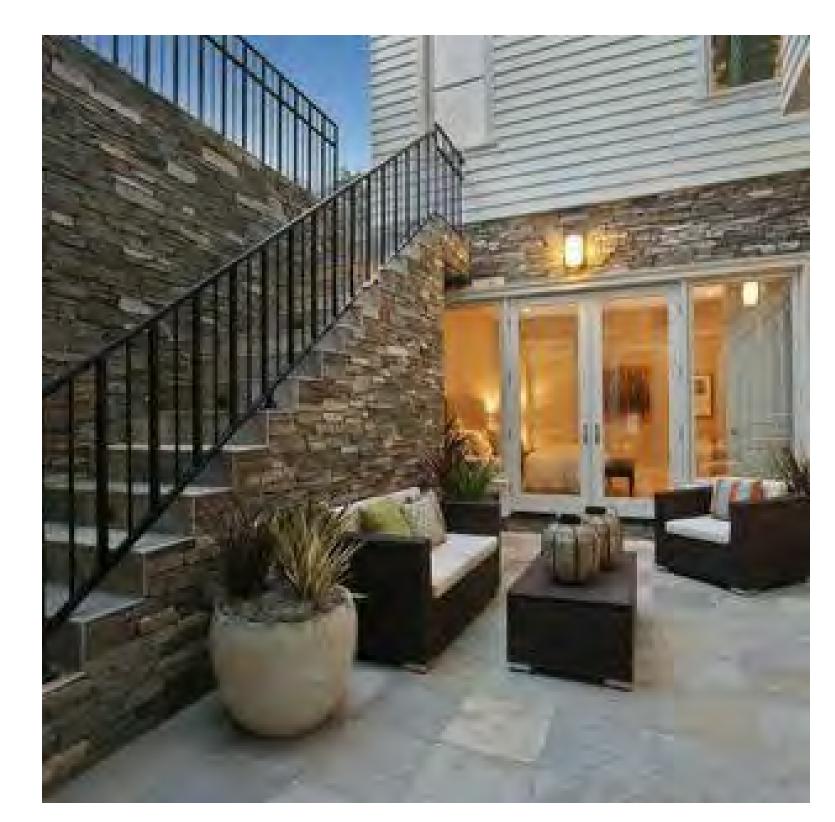

13. BASEMENT PATIO WITH IRON RAILINGS




12. PANEL-FOLD EXTERIOR DOORS



11. OVAL WINDOW



10. WALL SCONCE

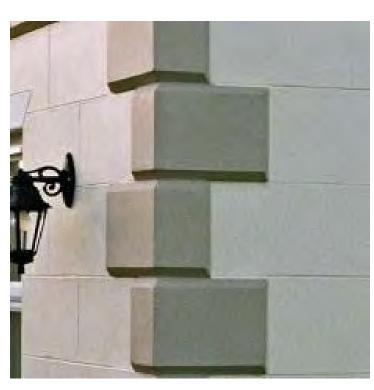

9. QUOINING ON CORNERS



8. ENTRY DOOR, W/ SIDELIGHTS



7. SIDE WING W/ HIPPED ROOF, ARCHED WINDOWS BREAK ROOF EAVES, HORIZONTAL TRIM BAND, DOWNSPOUTS WITH COLLECTORS



6. RAIN COLLECTOR




5. BRASS DRAIN OUTLET



4. SQUARE COLUMNS AT REAR TRELLIS



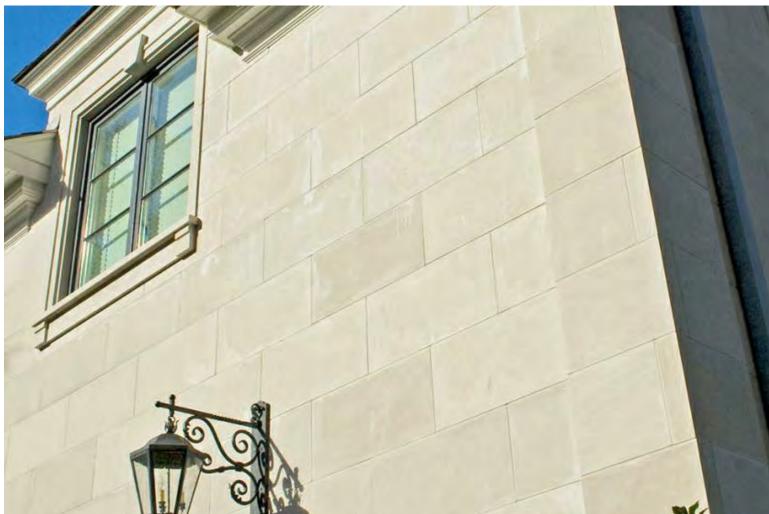


2. NATURAL LIMESTONE VENEER PANEL SIDING



1. WINDOWS WITH TRIM





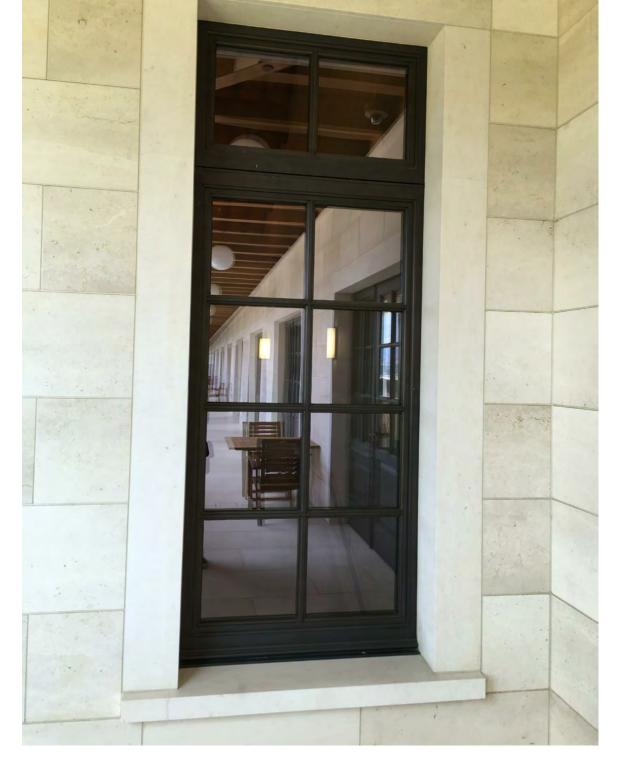

DARK DIVIDED WINDOW



WINDOW BY COORITALIA, WOOD INTERIOR &

METAL CLAD EXTERIOR

INTERIOR VIEW OF FRENCH DOOR

EXTERIOR FRENCH DOOR



IN SWING CASEMENT

TYP. STUCCO WALL
SYSTEM. SEE ELEVATIONS —— Cast stone head, red leaf stone or Eq. — CASEMENT WINDOW, ANDERSON OR EQUAL -Casement Window, Anderson or Equal Cast stone sill, red leaf stone or equal — TYP. STUCCO WALL
SYSTEM. SEE ELEVATIONS ———





TOP VIEW OF CASEMENT

COMING TOGETHER



WINDOW BY COORITALIA, WOOD INTERIOR & METAL CLAD EXTERIOR

EXTERIOR SIDE

DOUBLE CASEMENT WINDOWS

LOS ALTOS, CALIFORNIA 94022

SECTION DETAILS

INTERIOR SIDE

SHOWING HARDWARE

VICINITY MAP

ABBREVIATIONS

AGGREGATE BASE ASPHALT CONCRETE AREA DRAIN ATD ATRIUM DRAIN BACK FLOW PREVENTION DEVICE BOTTOM OF WALL ELEVATION CATCH BASIN CENTER LINE CS CRAWL SPACE ELEVATION CIP CAST IRON PIPE CONC CONCRETE DD DDCV DOUBLE DETECTOR CHECK VALVE DG DIP DUCTILE IRON PIPE DS **ROOF DOWN SPOUT** DWY ELECTRICAL **ELECTRICAL METER** FINISHED FLOOR ELEVATION FLOW LINE ELEVATION FORCE MAIN LINE FINISHED SURFACE ELEVATION FINISHED PAVEMENT ELEVATION FW FIRE WATER LINE GB GRADE BREAK GM GAS METER GR GRATE ELEVATION GATE VALVE HIGH POINT HEATED WATER LINE PIPE INVERT ELEVATION JOINT TRENCH JOINT POLE LANDSCAPE DRAIN LINEAR FEET LOW POINT POST INDICATOR VALVE PIVPOC POINT OF CONNECTION RIM RIM ELEVATION SLOPE SAP SEE ARCHITECTURAL PLANS SBD STORM SUB DRAIN SBDCO STORM SUB DRAIN CLEANOUT SD STORM DRAIN SDCO STORM DRAIN CLEANOUT SGR SEE GEOTECHNICAL REPORT SICB SIDE INLET CATCH BASIN SLP SEE LANDSCAPE PLANS SPP SEE PLUMBING PLANS SS SANITARY SEWER SSCO SANITARY SEWER CLEANOUT SSP SEE STRUCTURAL PLANS TW TOP OF WALL ELEVATION TYP TYPICAL VD PIPE VERTICAL DROP DOMESTIC WATER LINE

EARTHWORK QUANTITIES


WATER METER

	<u>n i nwonr</u>	<u>QUANTITIES</u>	
CUT		1,150 C.Y.	
FILL		300 C.Y.	
TOTA	L TO BE MOVED	1,450 C.Y.	
BALA	NCE	850 C.Y. CUT (OFF-HAU	L)
EART	HWORK QUANTITII	ES SHOWN ABOVE ARE	

EARTHWORK QUANTITIES SHOWN ABOVE ARE FOR PLANNING PURPOSES ONLY. CONTRACTOR SHALL CALCULATE THEIR OWN EARTHWORK QUANTITIES, AND USE THEIR CALCULATIONS FOR BIDDING AND COST ESTIMATING PURPOSES.

NEW RESIDENCE 370 YERBA SANTA AVENUE

LOS ALTOS, CA 94022

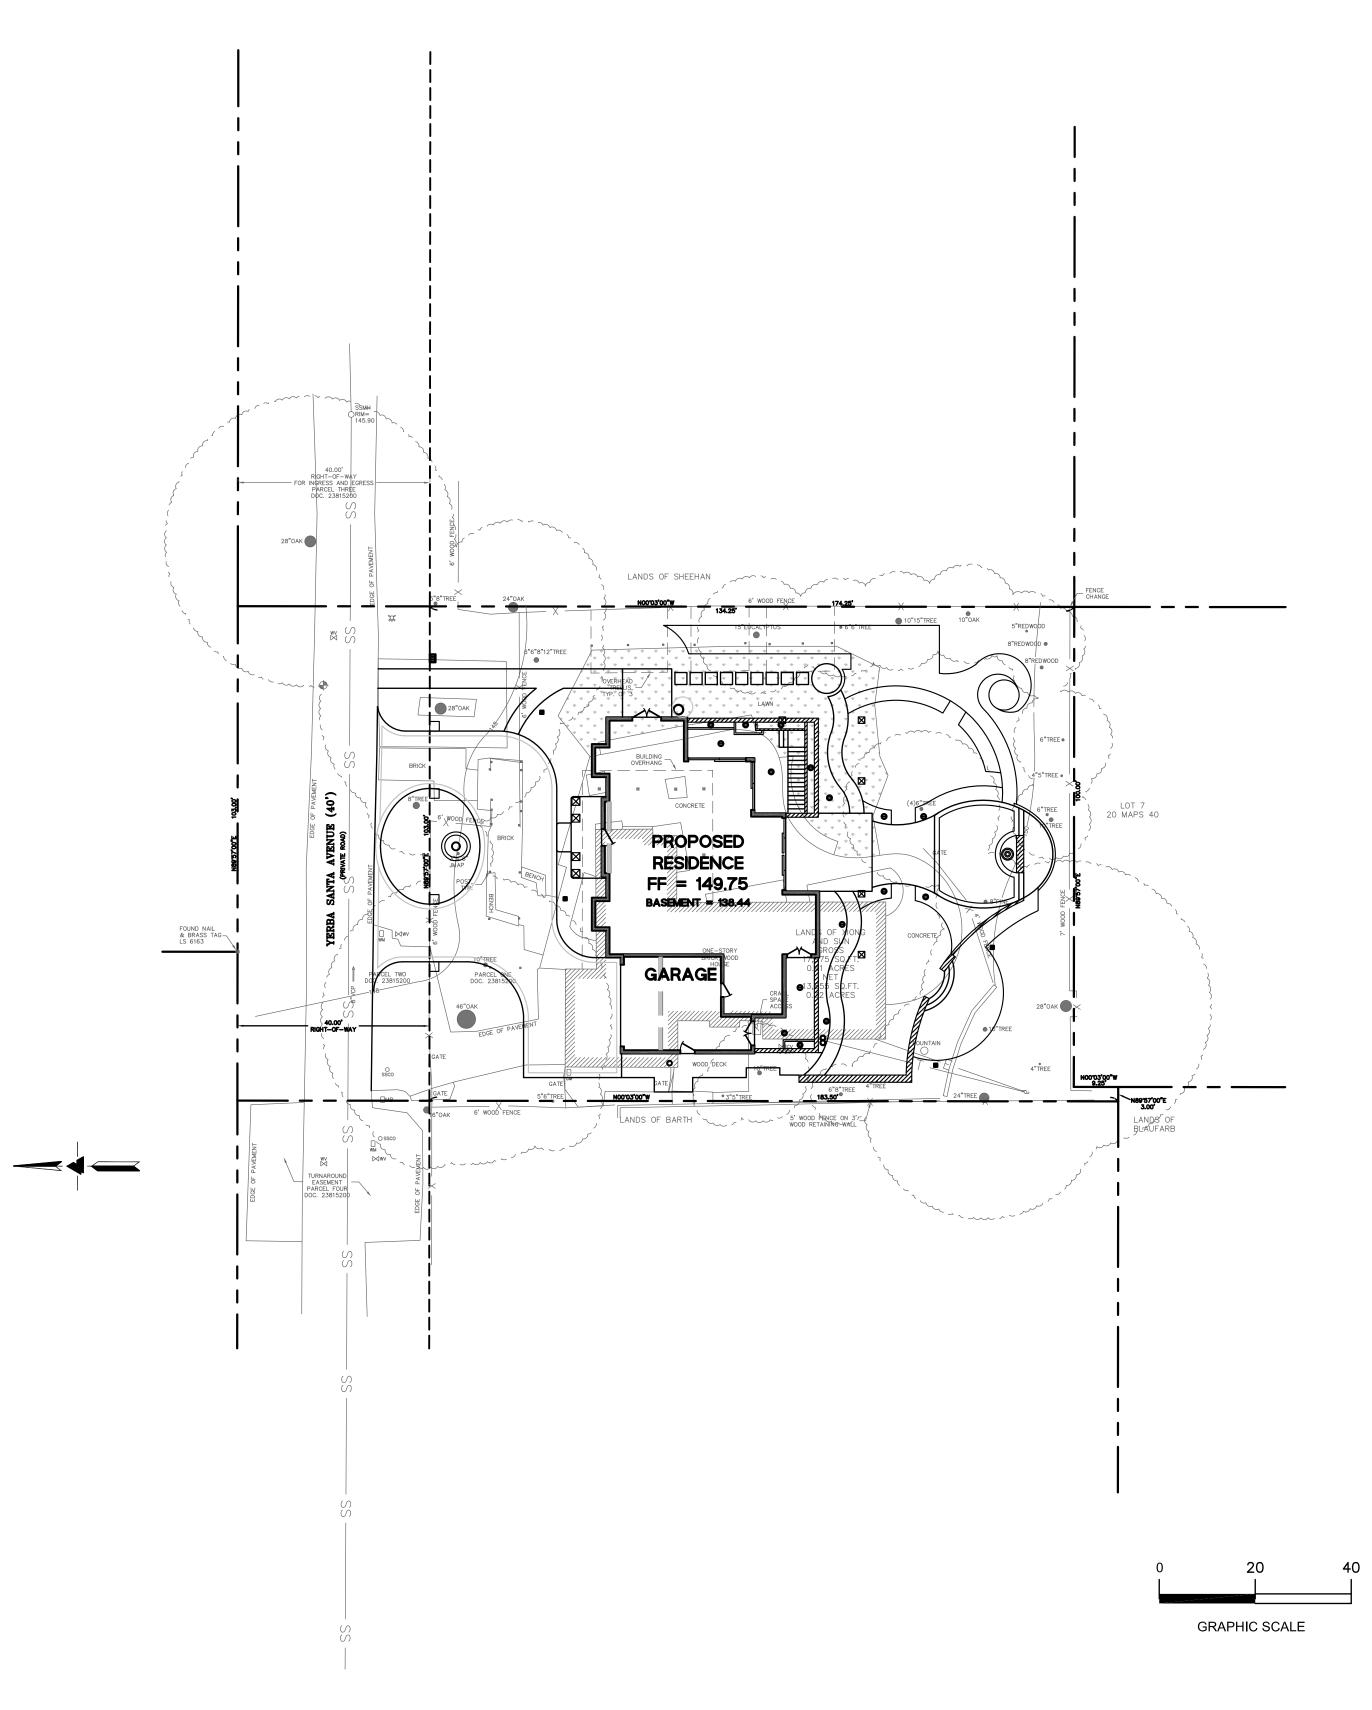



LOCATION MAP

EXISTING	PROPOSED	<u>LEGEND</u> .
SS	— <u>SS</u> >—	SANITARY SEWER
SD	——SD——	STORM DRAIN
		STORM SUB-DRAIN (PERFORATED PIPE)
		TRANSITION FROM PERF. PIPE TO SOLID P
— FM	— FM>—	FORCE MAIN
FW	————FW——	FIRE WATER LINE
W		DOMESTIC WATER SERVICE
IRR	— IRR	IRRIGATION SERVICE
——————————————————————————————————————	— GAS —	NATURAL GAS
——Е——	——Е——	ELECTRIC
JT	JT	JOINT TRENCH
×		FENCE
0	0	CLEAN OUT
	@	DOUBLE DETECTOR CHECK VALVE
	•	POST INDICATOR VALVE
\otimes	8	VALVE
	\boxtimes	METER BOX
•————	- ⇔	STREET LIGHT
	•	AREA DRAIN
		CATCH BASIN
	8	FIRE HYDRANT
\Diamond	೮	FIRE DEPARTMENT CONNECTION
	***	BENCHMARK
	6	MANHOLE
0	ے	SIGN
•	•	DOWNSPOUT
\Rightarrow	\Rightarrow	SPLASH BLOCK
		CONTOURS
		PROPERTY LINE
		SETBACK
	<u> </u>	GRASS SWALE
	· · · · · · · · · · · · · · · · · · ·	RETAINING WALL/ BUILDING STEMWALL
	\times	(E) TREE TO BE REMOVED


SHEET INDEX

SHEET NO.	DESCRIPTION
C-0	TITLE SHEET
C-2	GRADING PLAN
C-3	UTILITY PLAN





DATE:

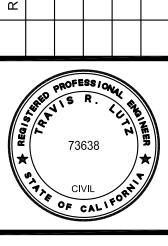

ESIDENCE ERBA SANTA AVENUE LTOS CA 94022

TTLE NEW RE 05/15/2019

Scale:


AS SHOWN


Design:

AJP
Check:
TRL
Orawing Number:

C-0

PEC Job No.
PEC 18-138

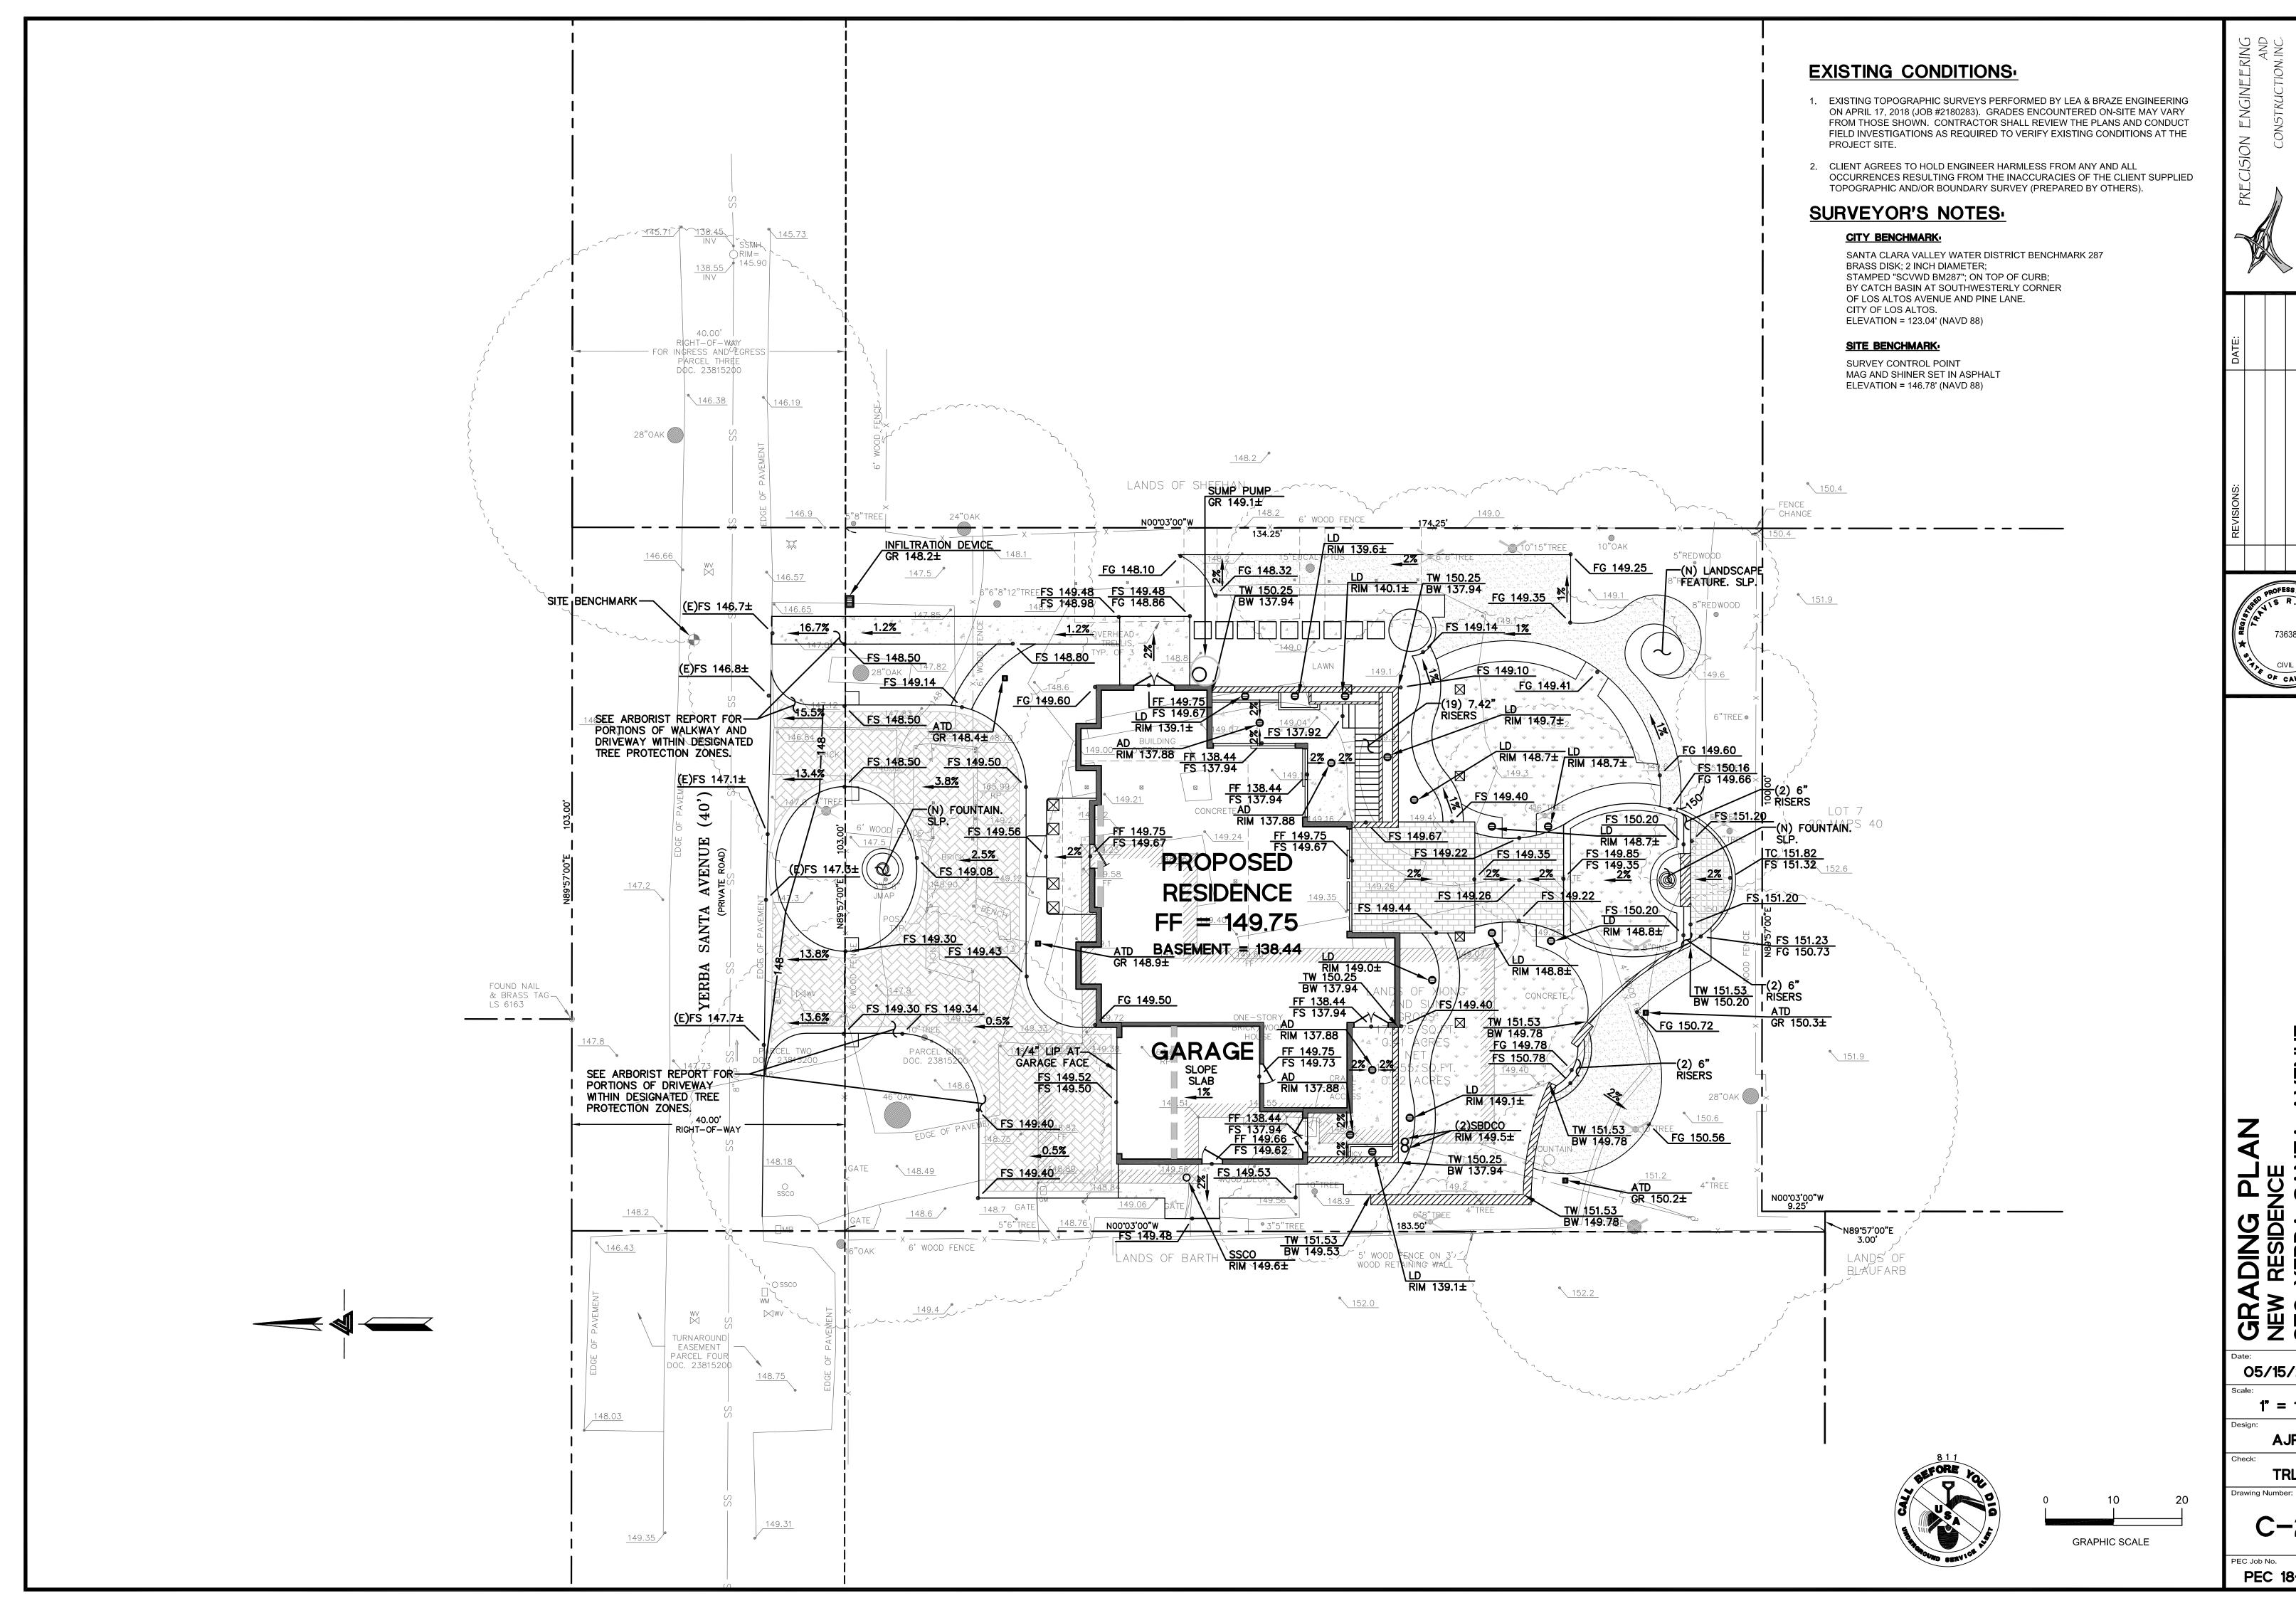

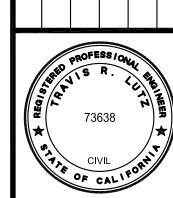

GRADING
NEW RESIDEN
370 YERBA
LOS ALTOS,


05/15/2019 1" = 10'


AJP

TRL

C-2

PEC 18-138

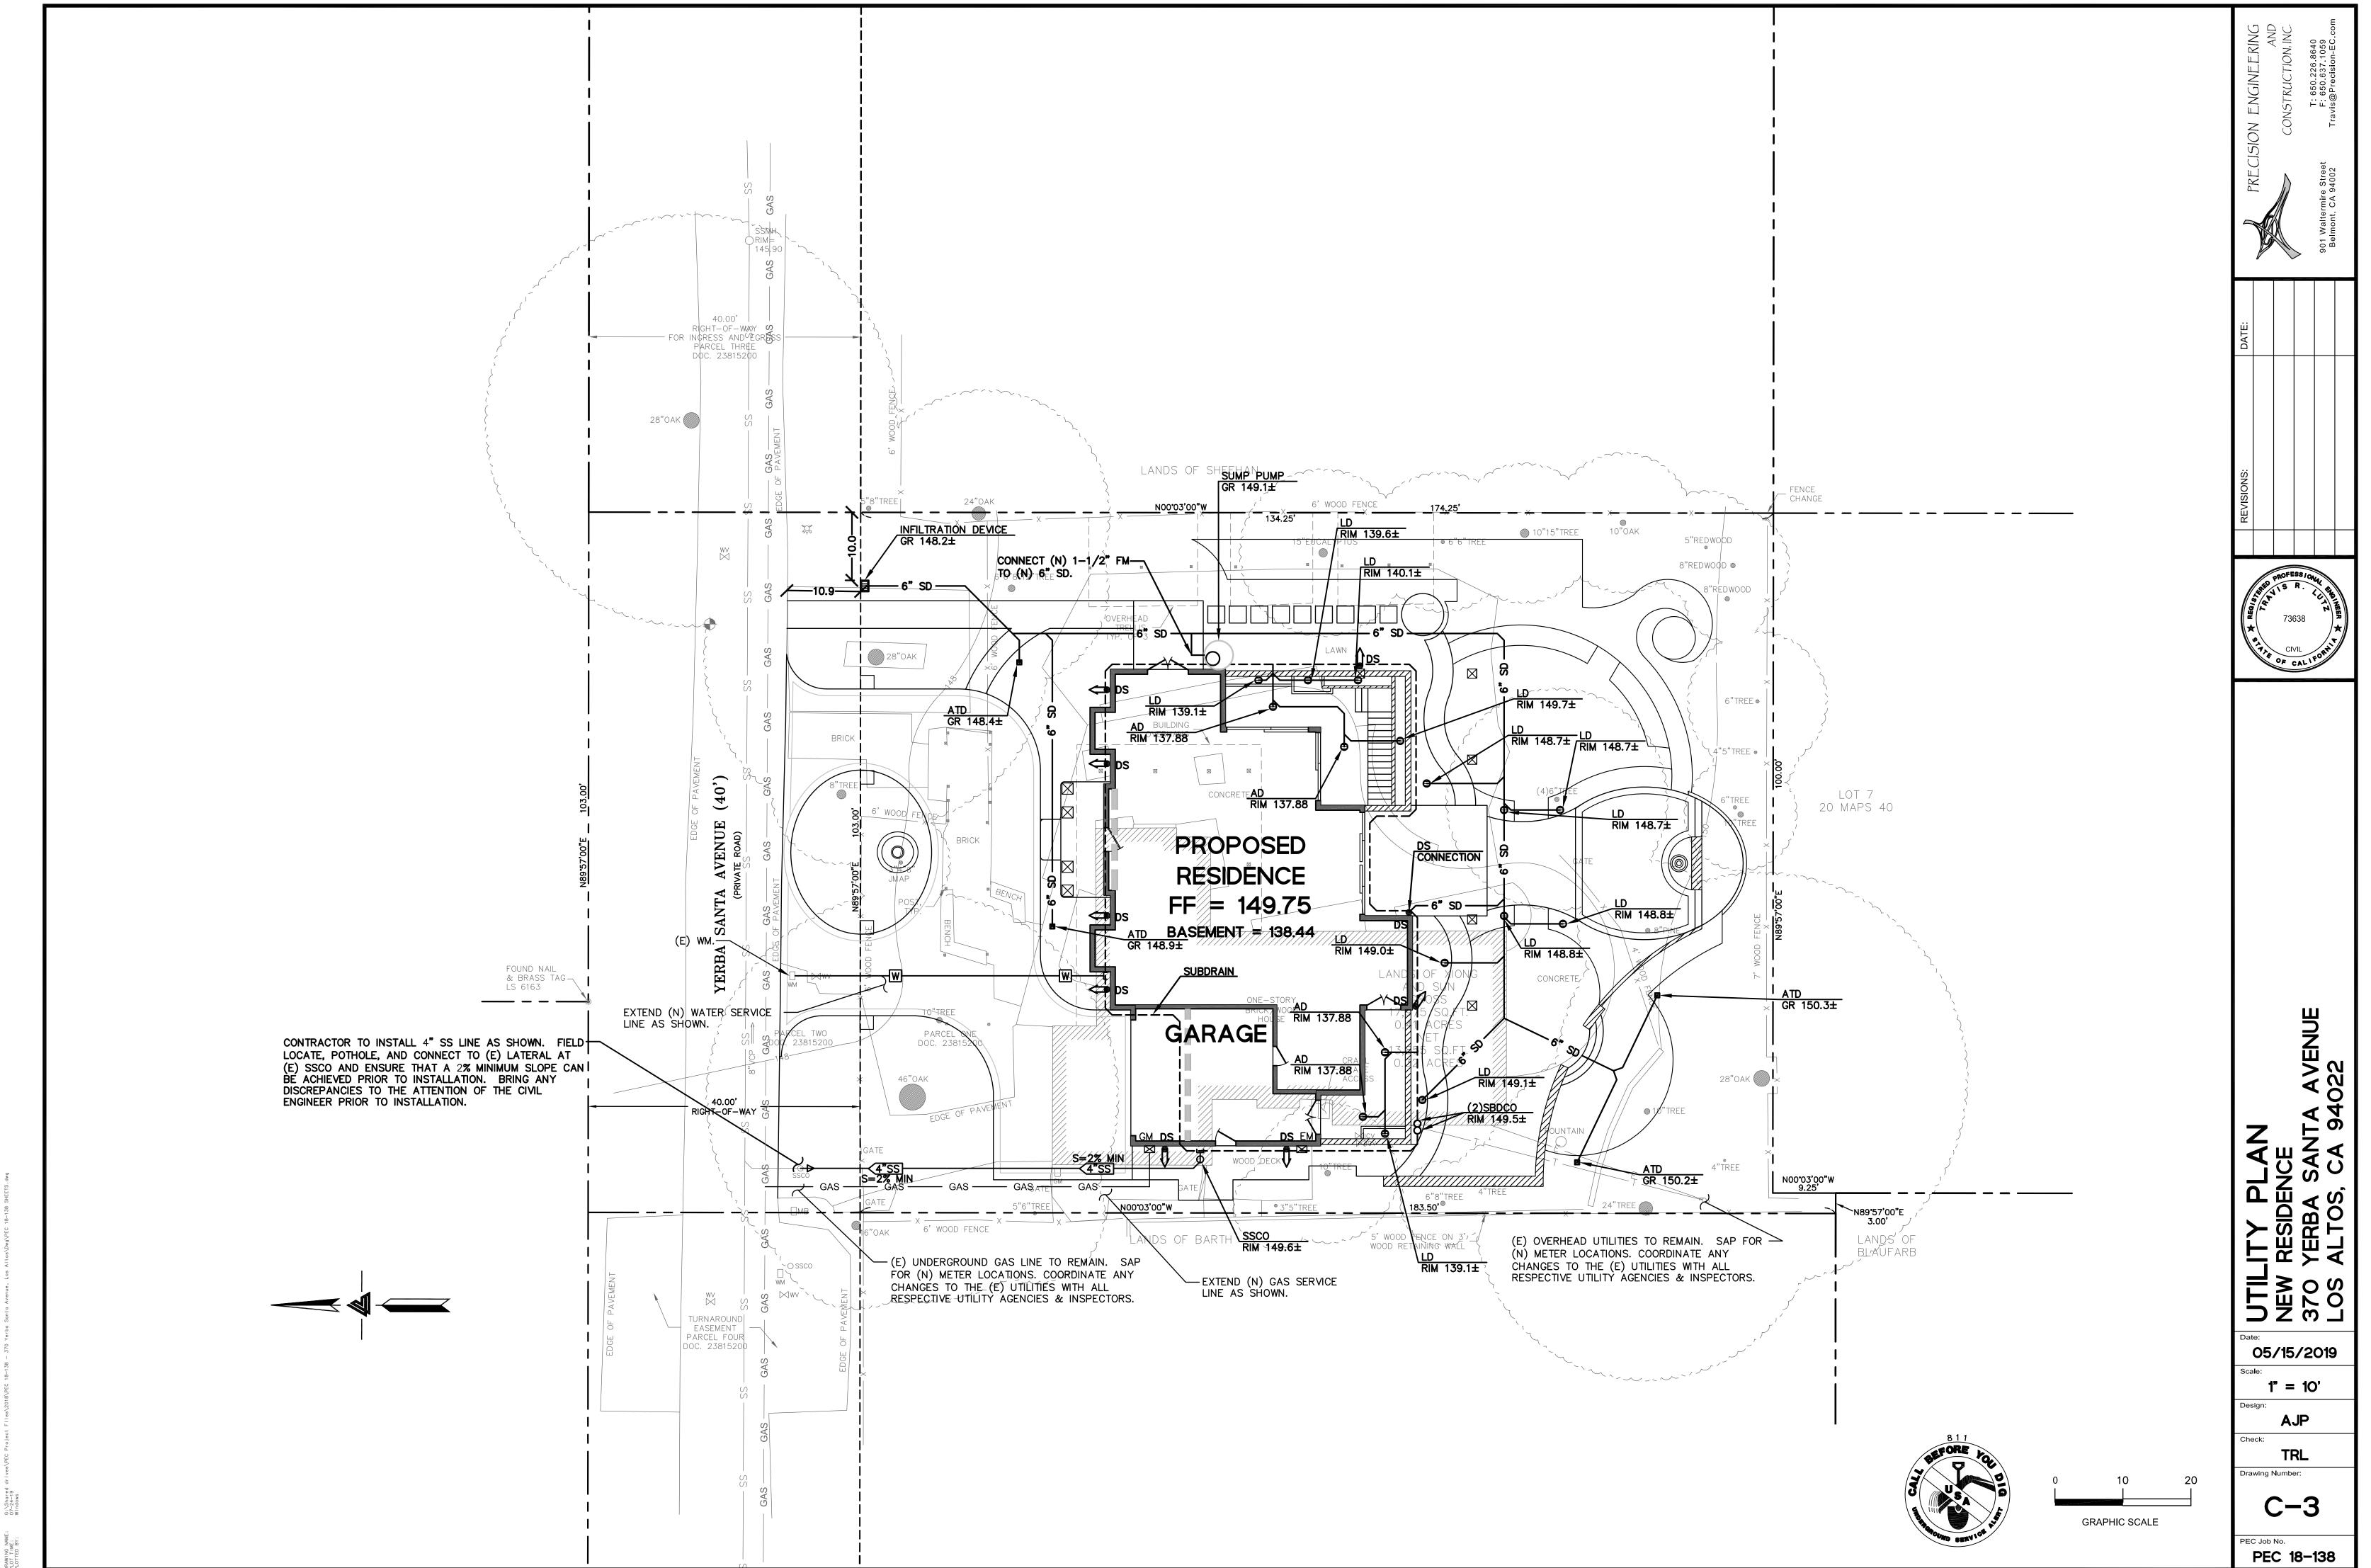

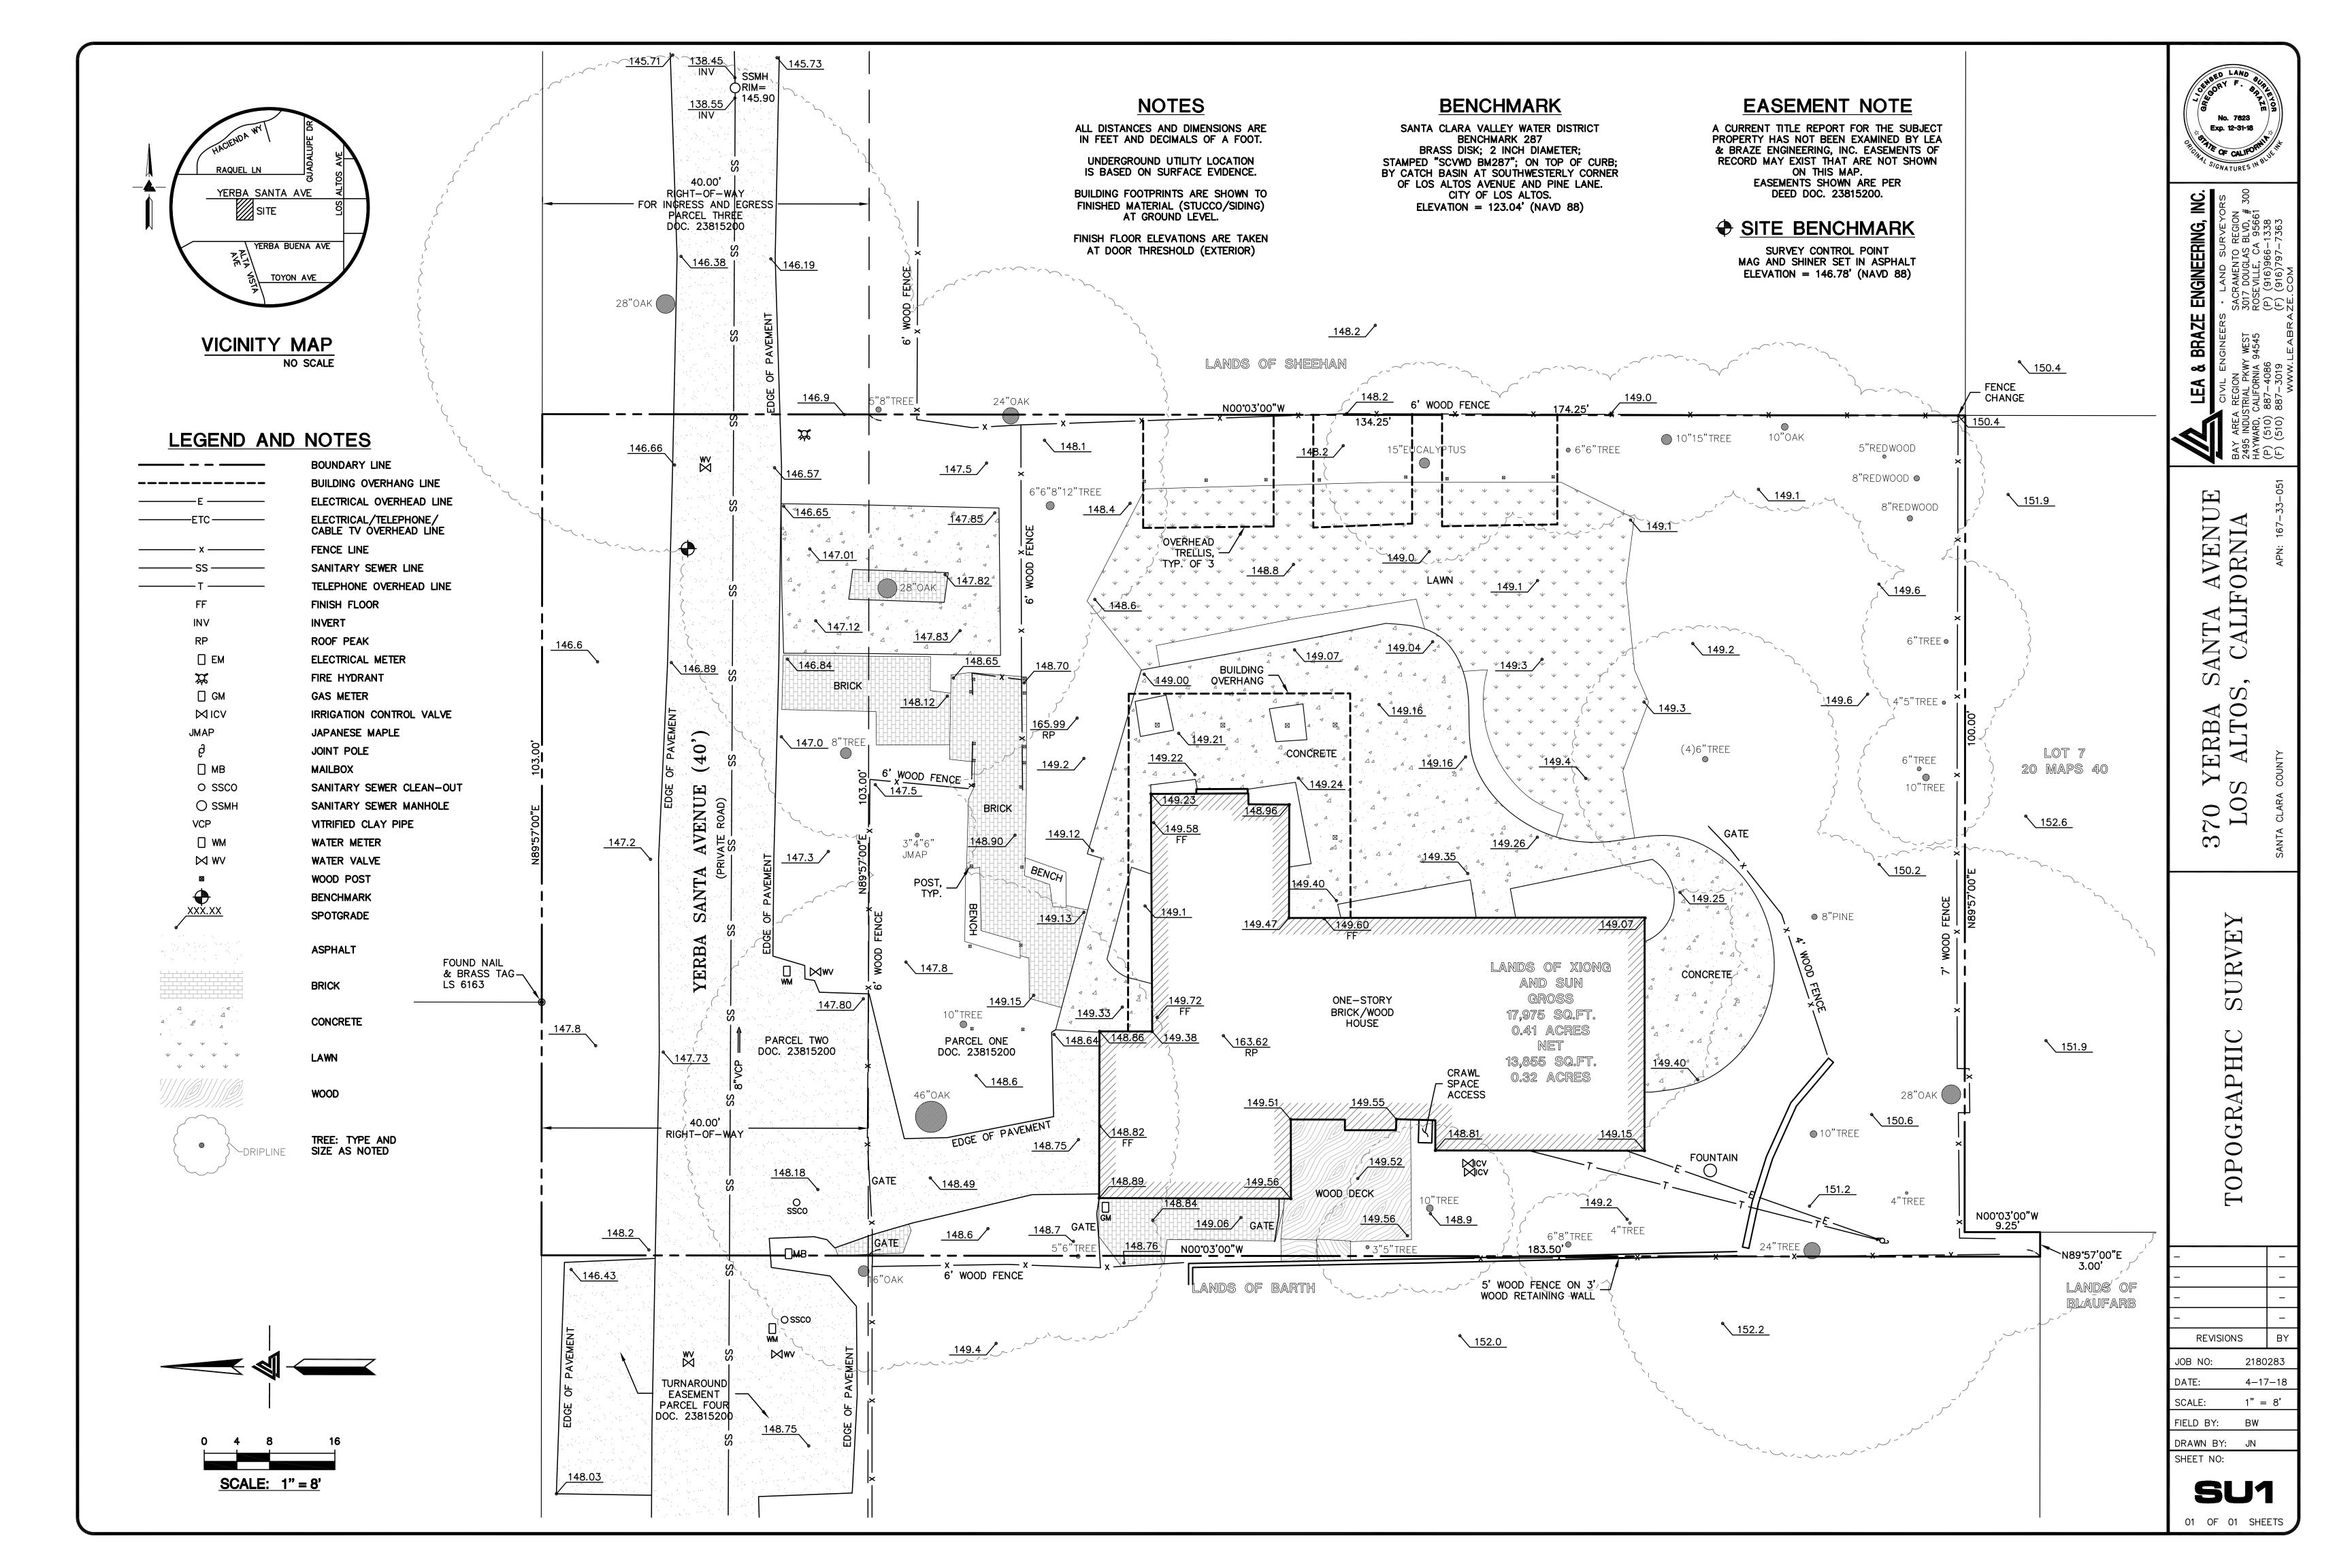







COVERED TERRACE





VIEW OF FOCUS POINT

HANGING SWING





FORMAL LAWN COUT-FOCUS POINT

ROMANTIC PLANTING





TERRACE-SEATWALLS

WALKWAY

TRAVERTINE PAVING

PROPOSED TREE

EXISTING TREE

21 PLUM TO BE REMOVED


MULCH

SCREEN PLANTING

CLEAN-FORMAL PLANTING

SWING GATE



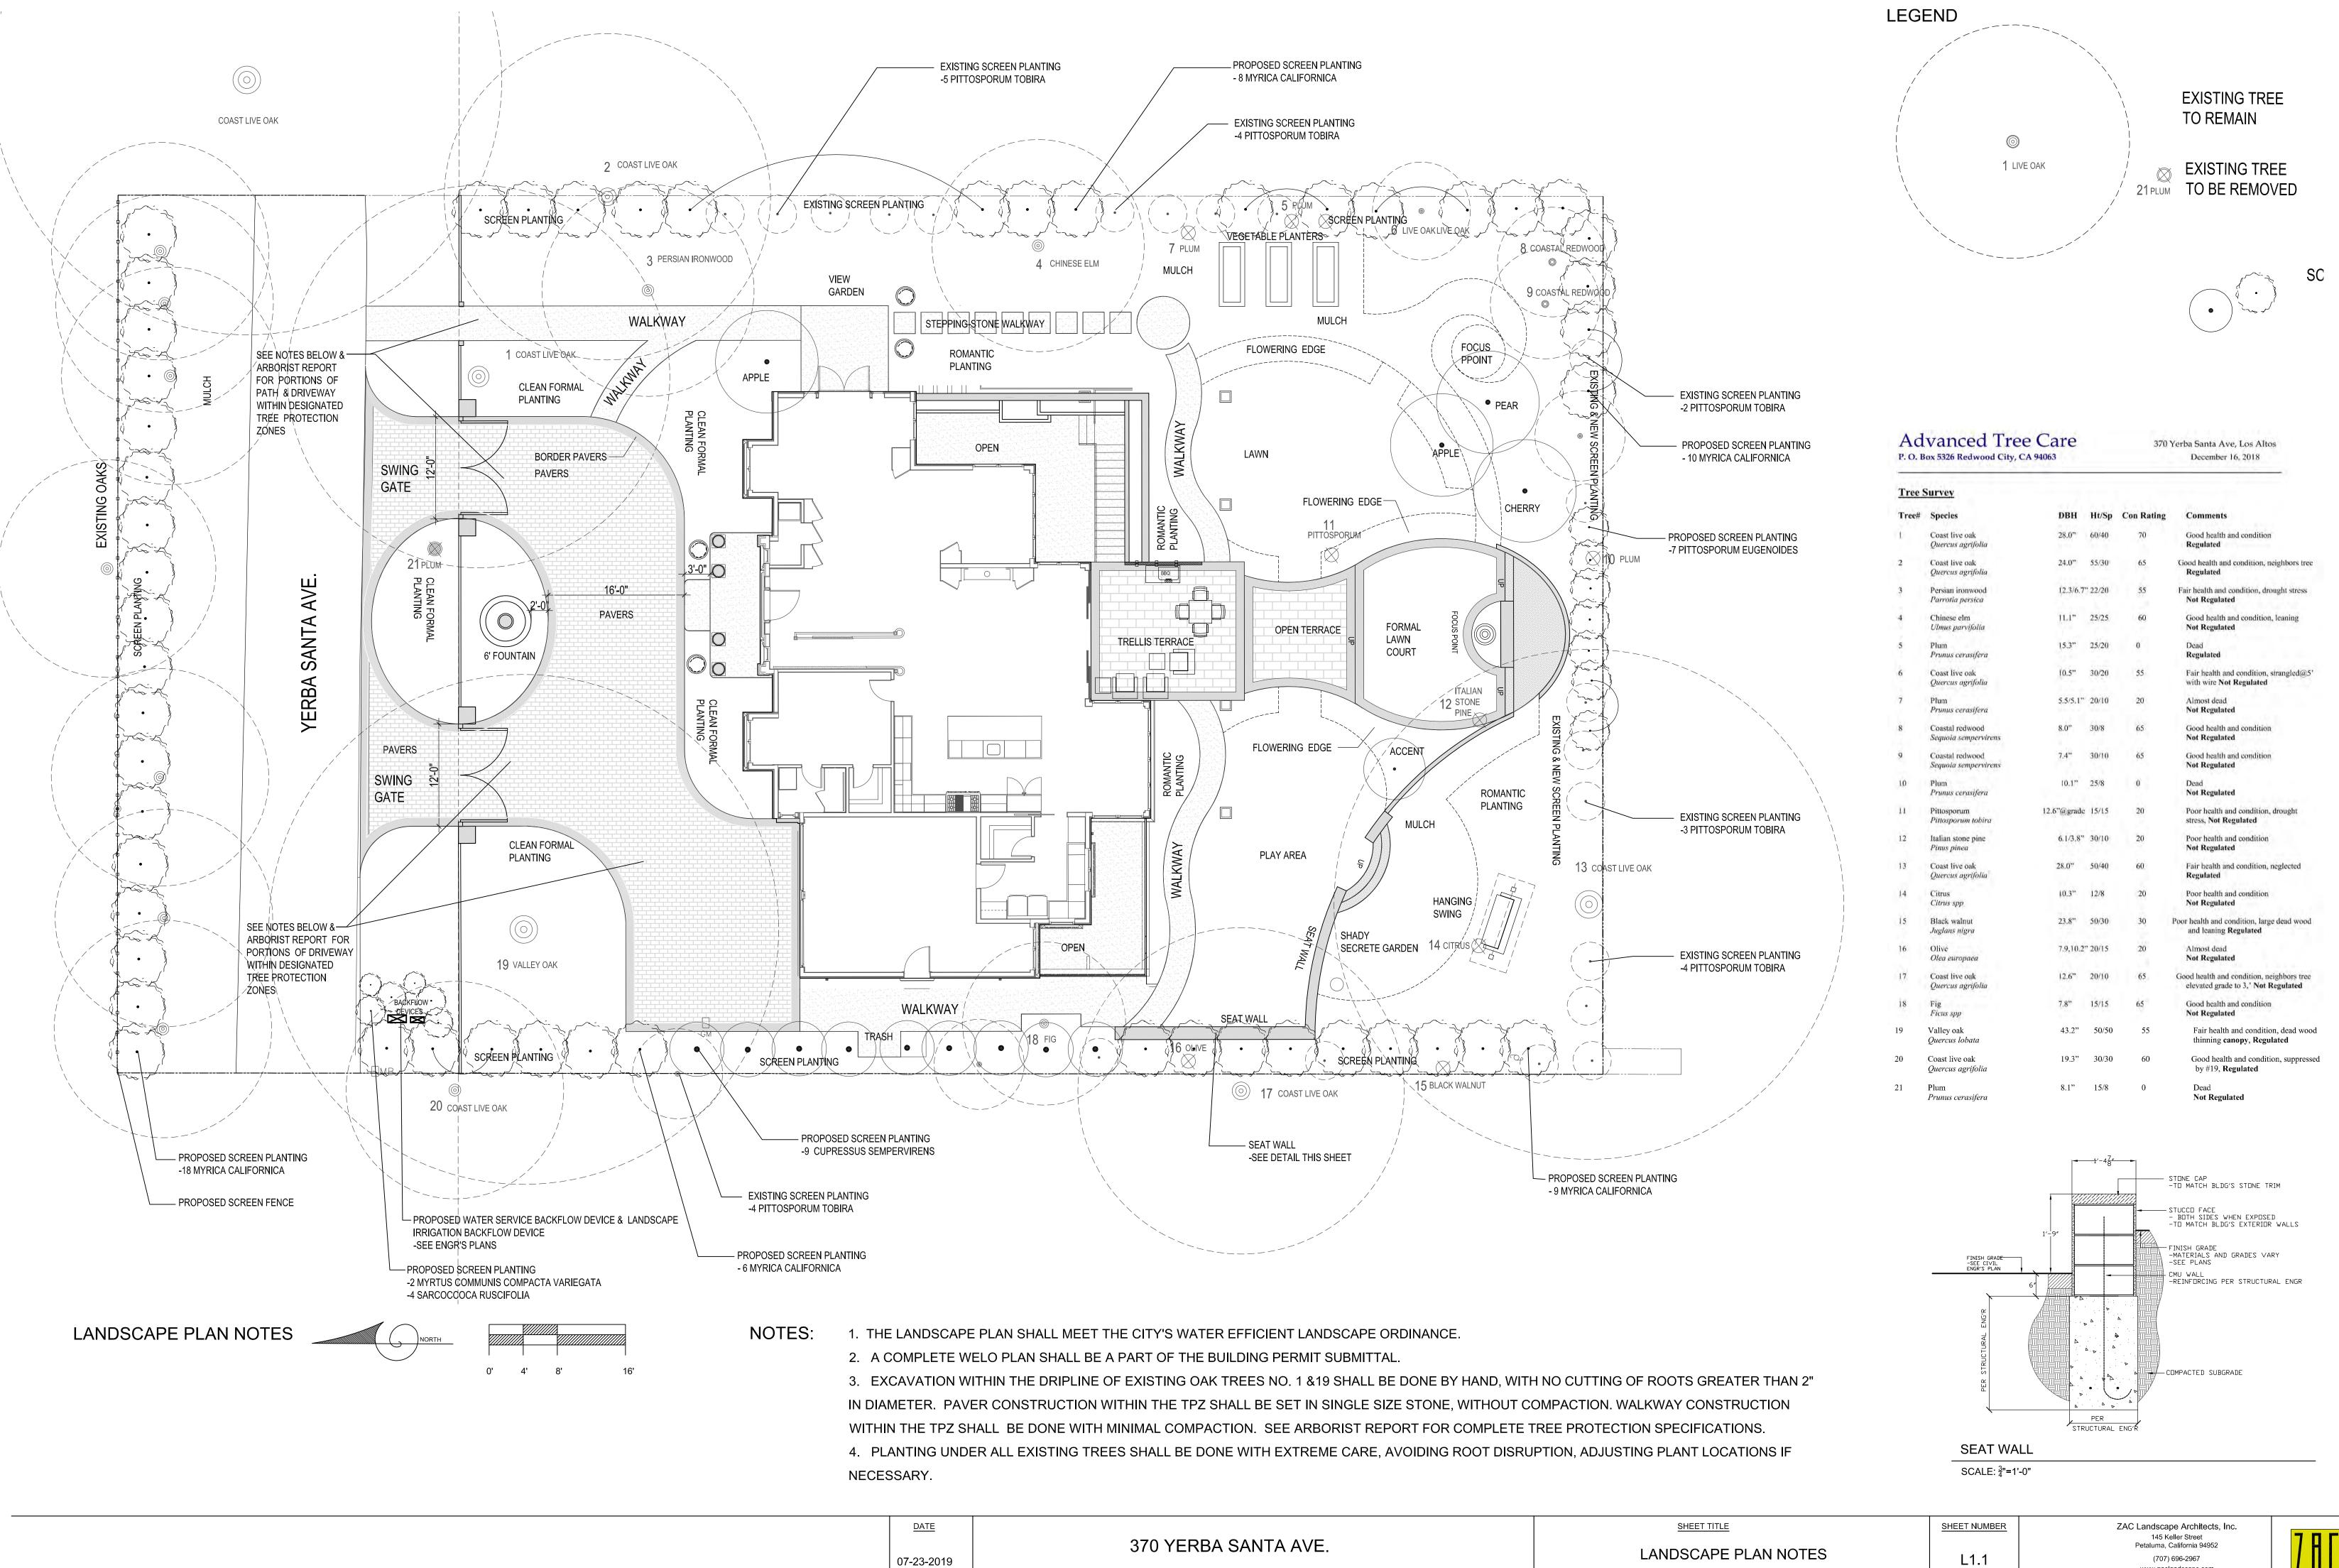






MYRTUS COMMUNIS COMPACTA

SCREEN SHRUBS AT UTILITY DEVICES





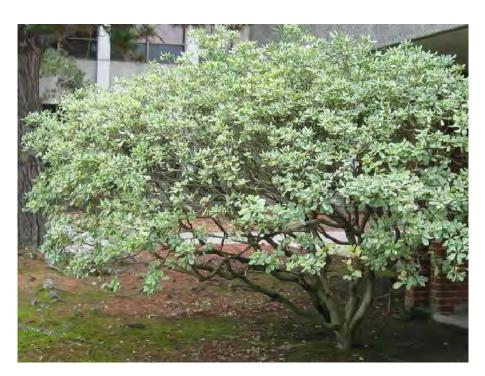


EXISTING PITTOSPORUM TOBIRA

PROPOSED SCREEN TREE and SHRUB S AT at WEST PROPERTY LINE





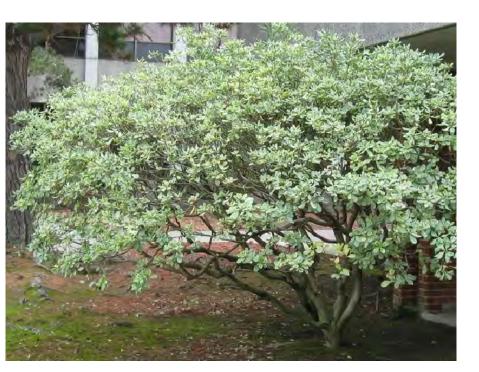


MYRICA CALIFORNICA

PITTOSPORUM EUGENOIDES EXISTING PITTOSPORUM TOBIRA

PROPOSED SCREEN SHRUBS AT at SOUTH and EAST PROPERTY LINES



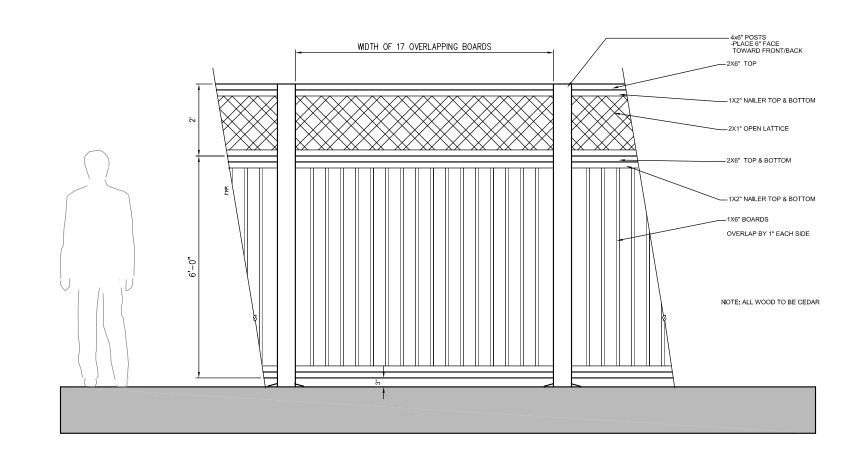

MYRICA CALIFORNICA

PROPOSED SCREEN SHRUBS and FENCE at NORTH PROPERTY LINE

PLANT LIST

SCREEN SHRUBS

QTY	CODE	BOTANICAL NAME	COMMON NAME	SIZE	D	E N	Dr	w	GENERAL DESCRIPTION
	TREE-SHRUB & VINE LEGEND								
9	CUP SEM	CUPRESSUS SEMPERVIRENS	ITALIAN CYPRESS	36" BOX	D		Dr		EV 60H 5-10W COLUMNAR DARK GREEN FOILAGE
51	MYR CAL	MYRICA CALIFORNICA	PACIFIC WAX MYRTLE	15 GAL	D	N	Dr	w	EV 10-30H10-15W FRG PUR FRT BRD
2	MYR COM CV	MYRTUS COMMUNIS COMPACTA VARIEGATA	COMPACT VARIEAGATED MYRTLE	5 GAL	D		Dr	w	EV 2-3H2-3W WHT FRT
7	PIT EUG	PITTOSPORUM EUGENOIDES	PITTOSPORUM	15 GAL			Dr		EV 20-40H 15W LARGE SCREEN YEL-GRN LVS CAN BE LOOSE OR FORMAL HEDGE
 EXISTING	PIT TOB	PITTOSPORUM TOBIRA	MOCK MORANGE OR TOBIRA	15 GAL			Dr		EV 20 (UP TO 30)H6-15W DENSE ROUNDED SHINY DRK GRN FRAG GOOD HEDGE
4	SAR RUS	SARCOCCOCA RUSCIFOLIA		5 GAL	D		Dr		EV 4-6H3-7W SHADE

OTHER PLANTING

TREE	BOTANICAL NAME	COMMON NAME	SIZE	10	E		Dr	Π,	V GENERAL DESCRIPTION
LEGEND				1	L		Н	4	
ACE PAL	ACER PALMATUM	BUTTERFLY JAPANESE MAPLE	24" BOX	D			Ш		DEC 10H 8W MULTI TRUNK CUT LEAF VARIEG FALL CLR
FTA	FRUIT TREE SEMIDWARF-APPLE	FUGI & GOLDEN DELICIOUS APPLE	15 GAL		L		Ц		
FT C	FRUIT TREE-CHERRY	CHERRY	15 GAL						
FTLM	FRUIT TREE-SEMIDWARF-LEMON-MYER	MEYER LEMON	15 GAL		E		П		
FTLIM	FRUIT TREE-SEMIDWARF-LIME-MEXICAN THORNLESS	MEXICAN THORNLESS LIME	15 GAL		E		П		
FT PR	FRUIT TREE SEMIDWARF-PEAR	SD PEAR	15 GAL				П		
LAG NAT	LAGERSTROEMIA NATCHEZ	WHITE CRAPE MYRTLE	24" BOX	T	T	Г	Dr	T	DEC 25H12W WHT ORG-RED FALL
				T			П		
CODE	BOTANICAL NAME	COMMON NAME	SIZE	D	E	N	Dr	,	V GENERAL DESCRIPTION
SHRUB & VINE LEGEND				Ť	T	T	П	T	
BUX MIC G	BUXUS MICROPHYLLA JAPONICA GREEN BEAUTY	JAPANESE BOXWOOD	1 GAL	D	r		Ħ		EV 2-6H 2W
HYD PAN L	HYDRANGEA PANICULATA LIMELIGHT	HYDRANGEA LIMELIGHT	5 GAL				Н	E	DEC 6-10H10W WHT TO CHARTREUSSE CONE SHAPED FADES PNK VIGOROUS LATE PRUNE TO SHAPE PRT SHADE BUT
MYR COM CV	MYRTUS COMMUNIS COMPACTA VARIEGATA	COMPACT VARIEAGATED MYRTLE	5 GAL	D	H		Dr		V EV 2-3H2-3W WHT FRT
PIT TOB C	PITTOSPORUM TOBIRA CREAM DE MINT	TOBIRA MINT DWARF	5 GAL	+	\vdash		Dr		EV 2H2W VARIAGATED MINT WITH CREAMMY WHT FRAG
RHA CAL	RHAMNUS CALIFORNICA	COFFEEBERRY	5 GAL	+	┝	N		_	V EV 5-8H 8-10W SUN-SHD RED BLU FRT BUT BRD
				D	├	N	Н	+	
RHO OCC	RHODODENDRON OCCIDENTALE	NATIVE RHODODENDRON	5 GAL	1		l ^N	H		3H 4W YEL FLWR GRACEFUL SHAPE BUT BRD
ROS ICE	ROSA ICEBERG	ICEBERG	5 GAL	+	H		Н		WHITE EVERGBLOOM
WES FRT M	WESTRINGIA FRUTICOSA MORNING LIGHT	VARIGATED COAST ROSEMARY	5 GAL	D	٦ ا	L	Dr ≥⊇		EV 3H3W LAV, GREY FOIL
					EDIE	₩§	NATIV DROU	- 1	
CODE	BOTANICAL NAME	COMMON NAME	SIZE	D	С	N	Dr		V GENERAL DESCRIPTION
PERENNIAL LEGEND				1	L	L	Ц	4	
AGA BLU	AGASTACHE BLUE FROTUNE		4" POT	D			Dr		2H3W DEEP BLU BUT HUM BRD
ANE HYB H	ANENOME HYBRIDA (JAPONICA) HONORINE JOBERT	JAPANESE ANENOME	4" POT	D	L		Ц		3H2W WHT CUT
AQU FLA Q	AQUILEGIA FLABELLATA ALBA	FAN COLUMBINE	4" POT	D					1H 1W WH PT SHD GRY LVS HUM BRD
AQU OYL	AQUILEGIA H. ORIGAMI YELLOW	COLUMBINE	4" POT	D			Dr		ANN 1.5H SFT YEL CUT PT SHD BUT HUM BRD
CAM BLU	CAMPANULA BLUE WATERFALL	CAMPANULA BLUE CLIPS	4" POT						6"H SPREADING LITE BLU
ECH RIT V	ECHINOPS RITRO VEITCH S BLUE	GLOBE THISTLE	4" POT	D			Dr		2-4H 2W DK BLU
PEN CEN	PENTSTEMON CENTRANTHIFOLIUS	SCARLET BUGLER	4" POT	D		N	Dr	١	V EV 2-3H 2W RED GRAY LVS HBRD BEE
PEN FIR	PENSTEMON FIREBIRD	BEARD TONGUE	4" POT	D			D R		EV 2H1.5W RE ATTRACTS BUT & HUM
PEN HET	PENSTEMON HETEROPHYLUS	FOOTHILL PENSTEMON	4" POT	D	T	N	D R	1	W EV 1H2-3W BLUE FADE TO PUR PIN BUT(L) HBRD BEE
PEN HET	PENSTEMON HETEROPHYLUS ELECTRIC BLUE	FOOTHILL PENSTEMON	4" POT	D		N	In I	ľ	V EV 1H2-3W BLUE FADE TO PUR PIN BUT(L) HBRD BEE
PEN HET B	PENSTEMON HETEROPHYLLUS BLUE SSPRINGS	BLUE BEDDER PENSTEMON	4" POT	D		N	Dr		EV GRN BUDS TO VIVID BL PT SHD
PEN HOL	PENSTEMON 'HOLLY'S WHITE'	BEARD TONGUE	4" POT	D			Dr		EV 2H1.5W WHT W/ PIN BLUSH ATTRACTS BUT HUM
POL MUN	POLYSTICHUM MUNITUM	CALIF. SWORD FERN	4" POT			N	\Box		EV 2-4H 4W SHADE
				EER	DIBL	- €	DROU	1	
GROUNDCOV ER LEGEND				T	Ī				
	CAMPANULA CARPATIC BLUE CLIPS	BELLFLOWER	4"	D	H	H	$\dagger \dagger$	\top	8"-18"H BLU PT SHD
CAMP CAR W	CAMPANULA CARPATIC WHITEE CLIPS	BELLFLOWER	4"	D					8"-18"H WHT PT SHD
CER TOM	CERASTIUM TOMENTOSUM	SNOW IN SUMMER	4"	+	H	H	\forall	+	EV 6-8"H 2-3 W WHT GREY LVS
DYM MAR	DYMONDIA MARGARETAE	DYMONDIA	1 GAL		H	H	+		EV 2-3"H 20"W YEL BETWEEN STEP STONES
DYM MAR S	DYMONDIA MARGARETAE SILVER CARPET	DYMONDIA SILVER CARPET	1 GAL	+			H		EV 2-3"H 12"W YEL BETWEEN STEP STONES VERY DENSE
GAL ODO	GALIUM ODORATUM	SWET WOODRUFF	4"	D	\vdash		H	+	EV 6-12"H 12"W WHT
				1			$\ \ $	\dashv	
GLE HED V	GLECHOMA HEDERA VARIEGATA	GROUND IVY	4"	+	\vdash	\vdash	H	\dashv	EV 4"H 24 W BLU VARI LVS GOOD TRAILER
LIR GIG	LIRIOPE GIGANTEA	GIANT LILY TURF	1 GAL	D	\vdash		$\ \ $	\dashv	12"H WHT &PUR GOOD AROUND ROOTY PLANTS
PAC TER	PACHYSANDRA TERMINALLIS		4"	D	\vdash	L	\prod	\sqcup	EV 8-12"H SPREADING WHT FLWR SHADE
PAC TER V	PACHYSANDRA TERMINALLIS SILVER EDGE "VARIEGATA		4"	D			$\parallel \parallel$		EV 6-8"H SPREADING WHT FLWR SHADE
							. 1	. 1	



SHEET NUMBER