





RESIDENCE


NEW SINGLE FAMILY RESIDEN

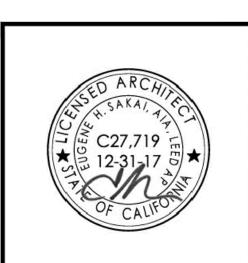

PROJECT NO.			17-008
REVISION	DATE	DESCRIPTION	DRAWN BY
	09.30.2017	09.30.2017 PLANNING PERMIT SUBMITTAL	<u>≥</u>
	12.04.2017	12.04.2017 PLANNING PERMIT RESUBMITTAL IV	<b>≥</b>

**COVER SHEET** 

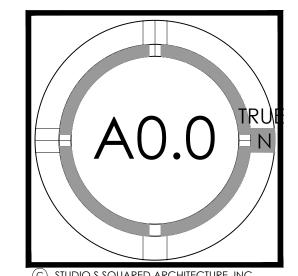

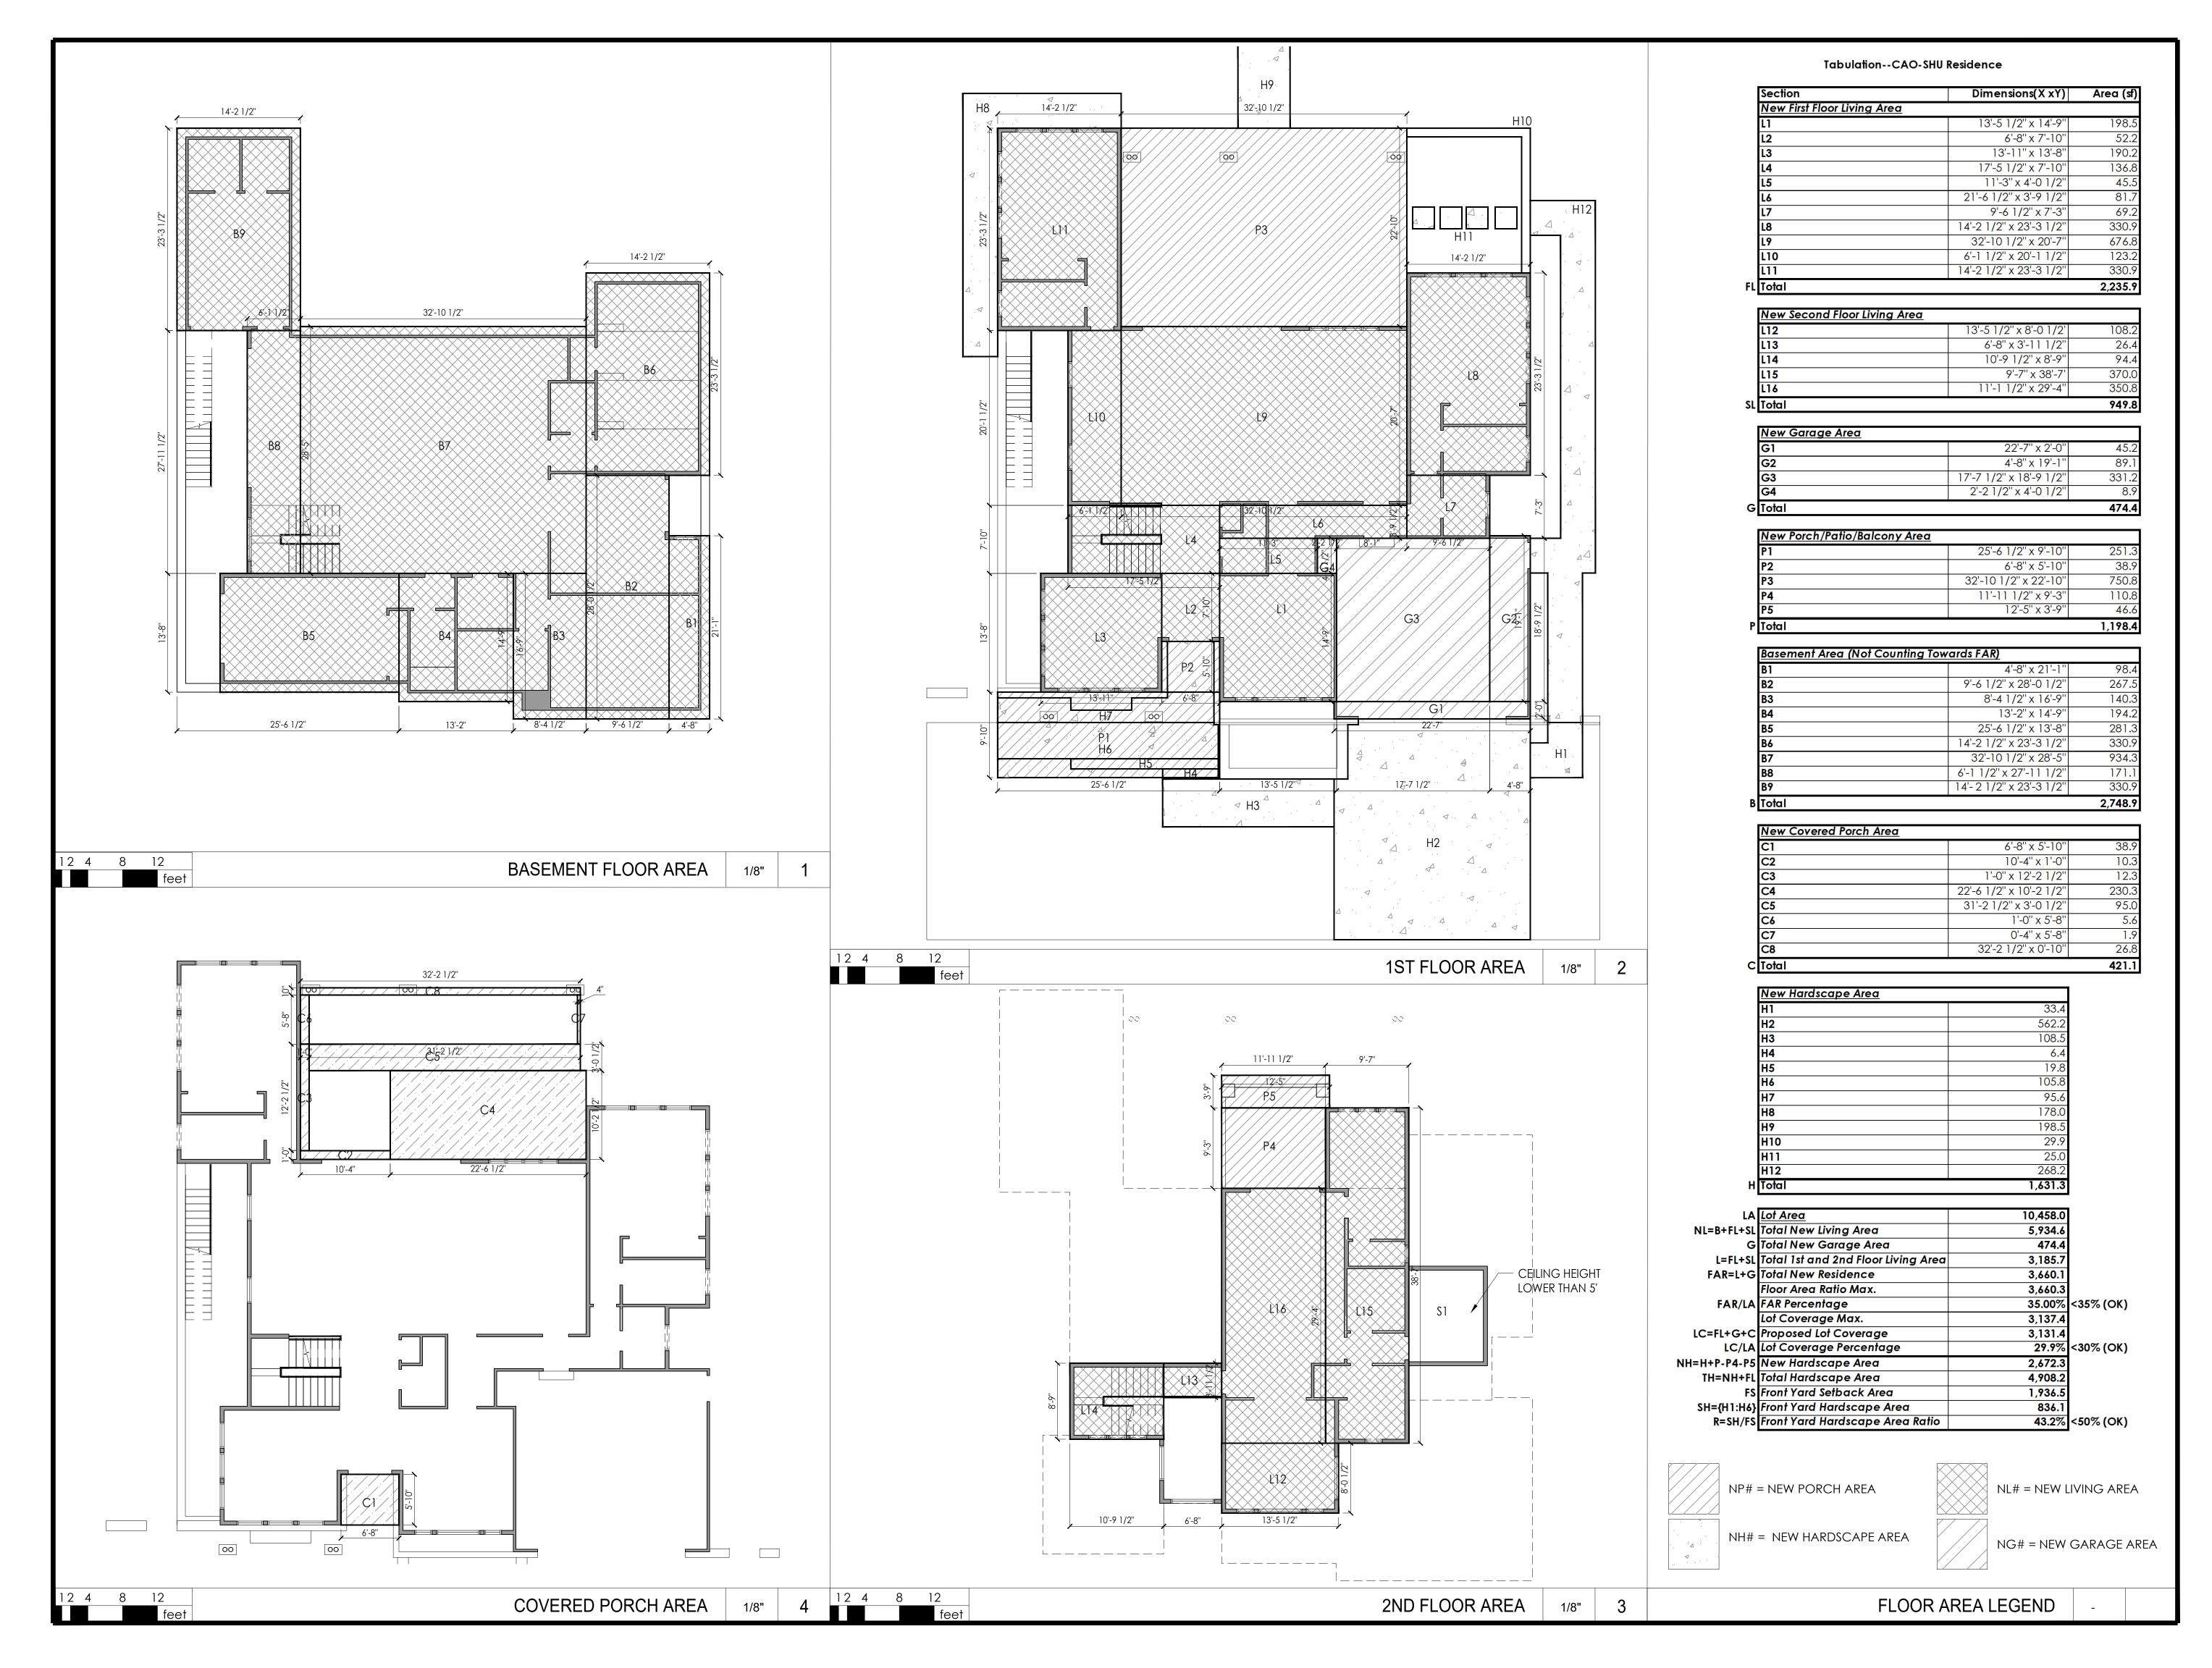



1000 S Winchester Blvd San Jose, CA 95128 P: (408) 998 - 0983


F: (408) 404 - 0144

SIDENCE

CAO RESIDENCE

NEW SINGLE FAMILY RESIDENCE


390 HOLLY AVENUE, LOS ALT

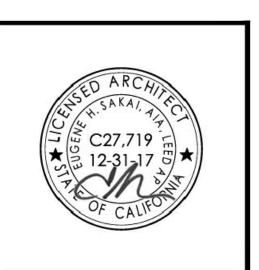


PROJECT NO.			17-008
REVISION	DATE	DESCRIPTION	DRAWN BY
	09.30.2017	09.30.2017 PLANNING PERMIT SUBMITTAL	>
	12.04.2017	12.04.2017 PLANNING PERMIT RESUBMITTAL IV	<u>&gt;</u>

FLOOR AREA

CALCULATIONS

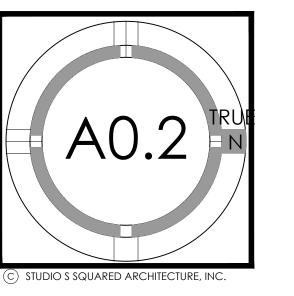

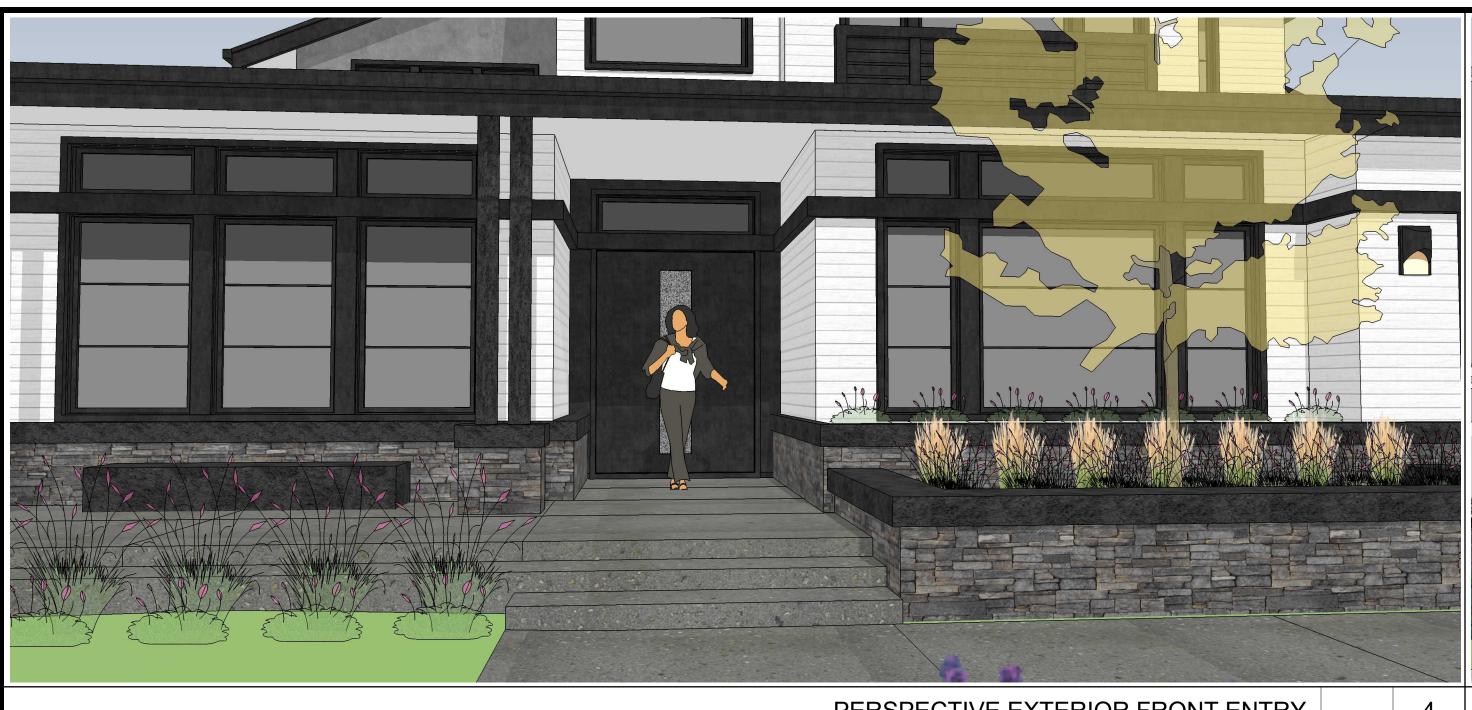



PERSPECTIVE EXTERIOR FRONT ENTRY

PERSPECTIVE EXTERIOR FRONT RIGHT

PERSPECTIVE EXTERIOR RIGHT SIDE

PERSPECTIVE EXTERIOR FRONT LEFT

PERSPECTIVE EXTERIOR FRONT HIGH




PERSPECTIVE EXTERIOR LEFT SIDE






1000 S. Winchester Blvd

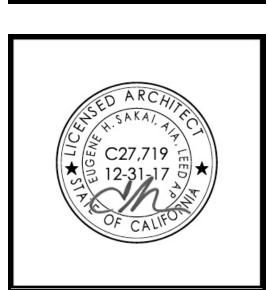

PROJECT NO.			17-008
REVISION	DATE	DESCRIPTION	DRAWN BY
	09.30.2017	PLANNING PERMIT SUBMITTAL	≥
	12.04.2017	PLANNING PERMIT RESUBMITTAL	2

**EXTERIOR** PERSPECTIVES

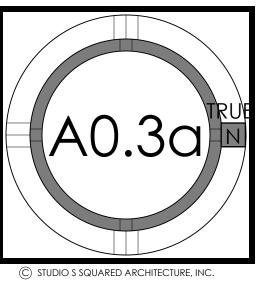










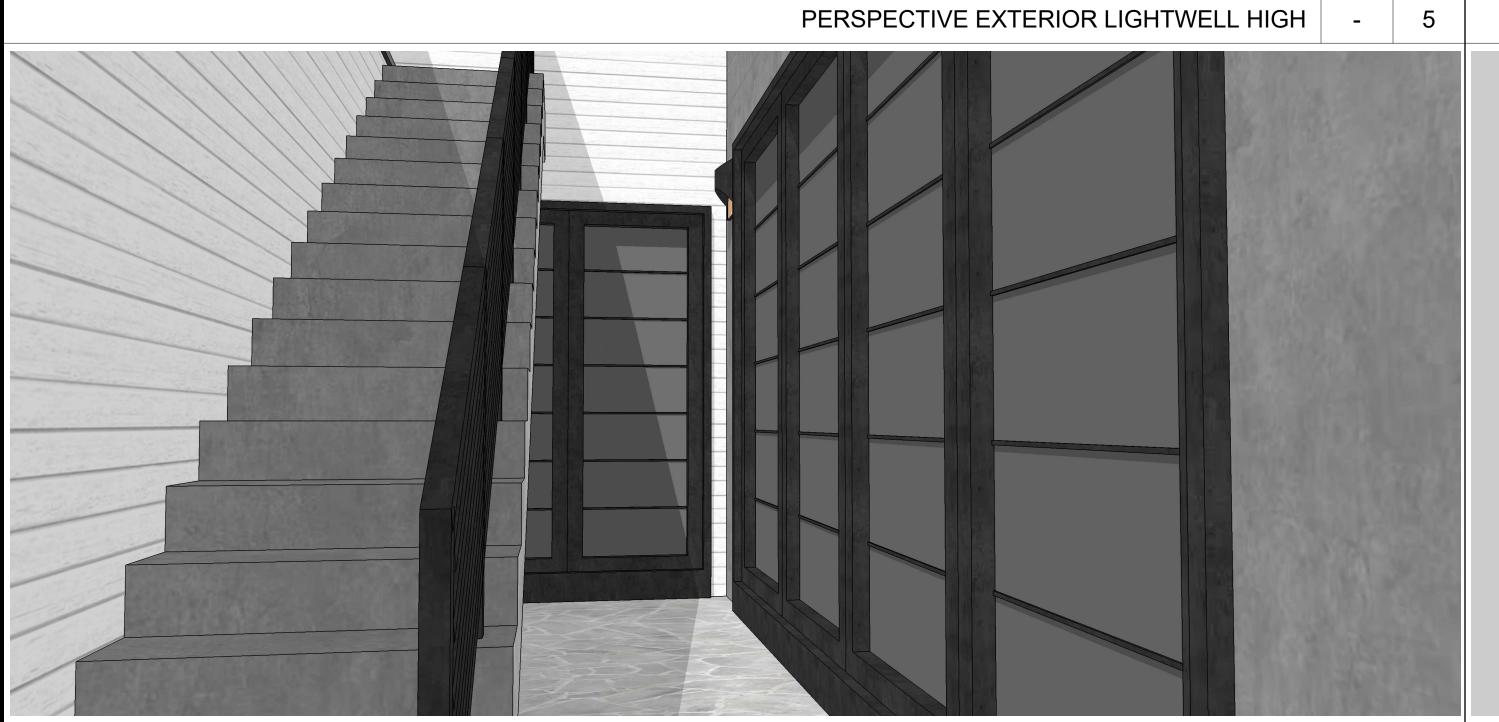

PERSPECTIVE EXTERIOR LIGHTWELL - CLOSE




PERSPECTIVE EXTERIOR REAR HIGH




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PROJECT NO.			17-008
REVISION	DATE	DESCRIPTION	DRAWN BY
	09.30.2017	PLANNING PERMIT SUBMITTAL	≥
	12.04.2017	PLANNING PERMIT RESUBMITTAL	>

## EXTERIOR PERSPECTIVES




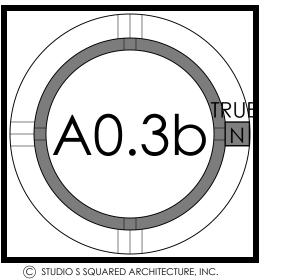

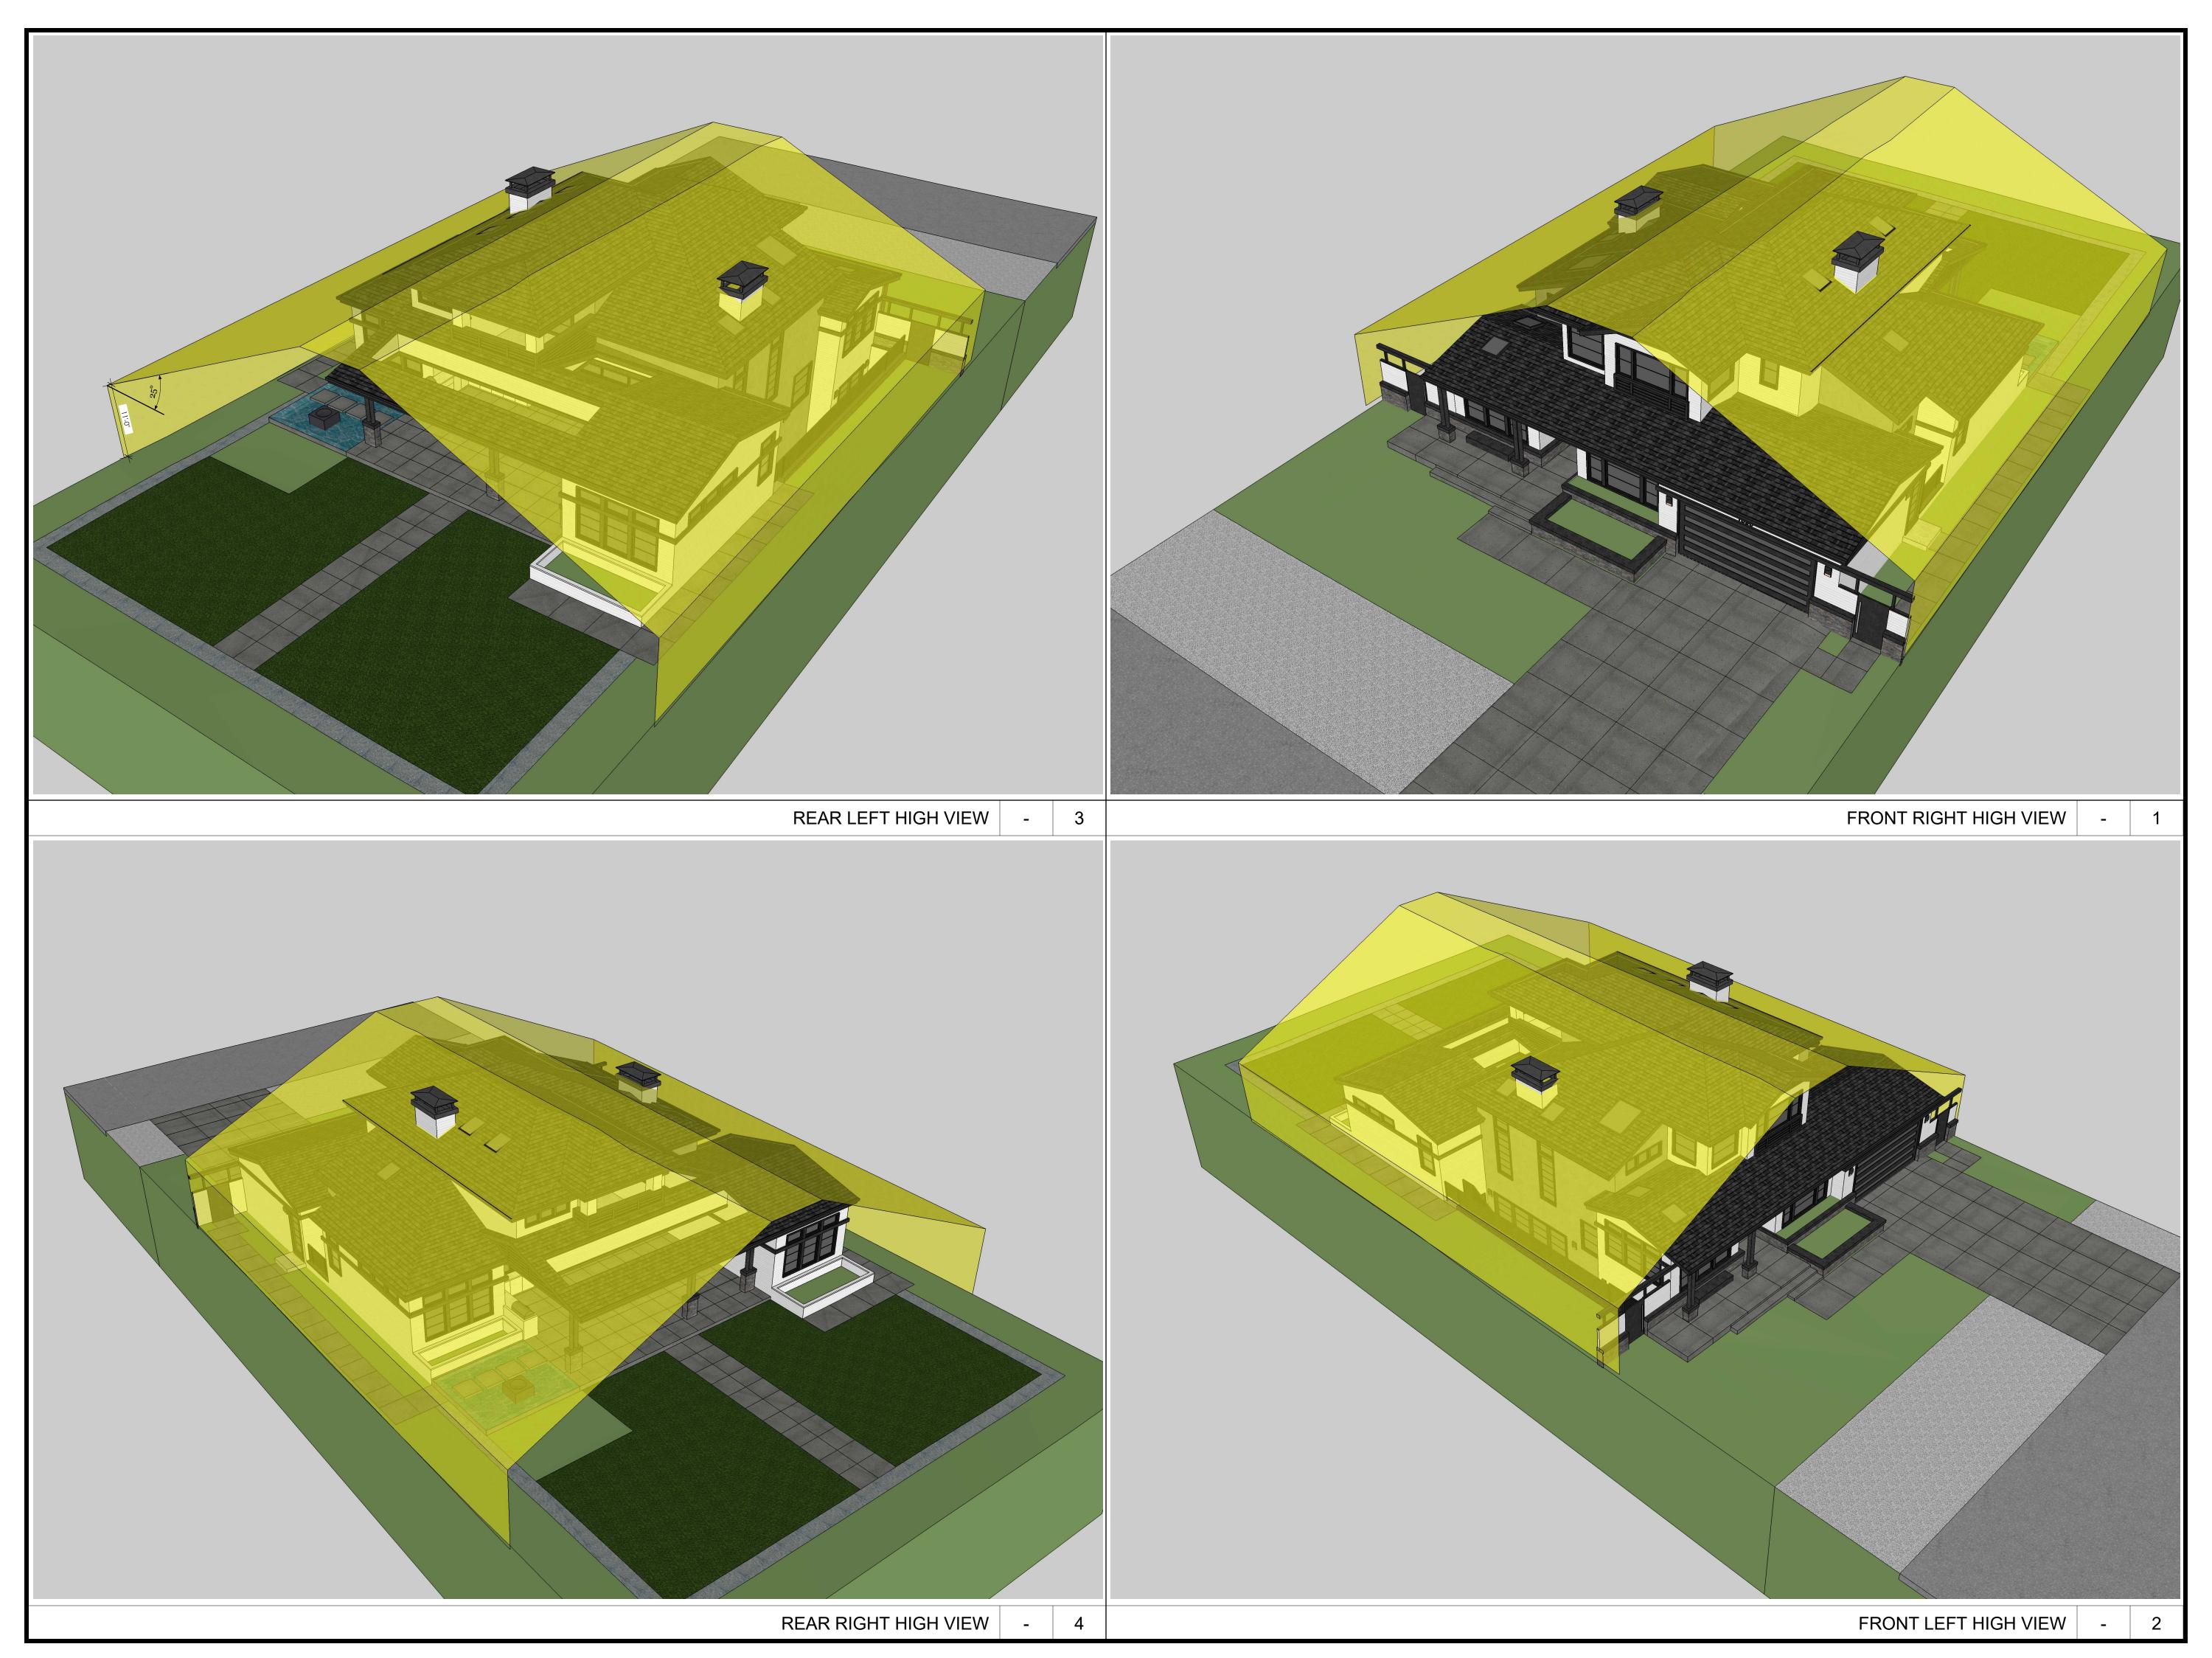


1000 S. Winchester Blvd F : (408) 404 - 0144


CAO RESIDENCE

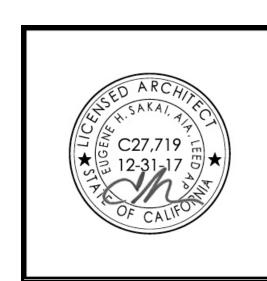


PROJECT NO.			17-008
REVISION	DATE	DESCRIPTION	DRAWN BY
	09.30.2017	PLANNING PERMIT SUBMITTAL	≥
	12.04.2017	PLANNING PERMIT RESUBMITTAL	≥

# DAYLIGHT PLANE

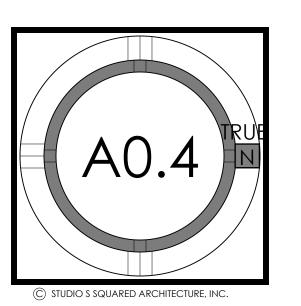

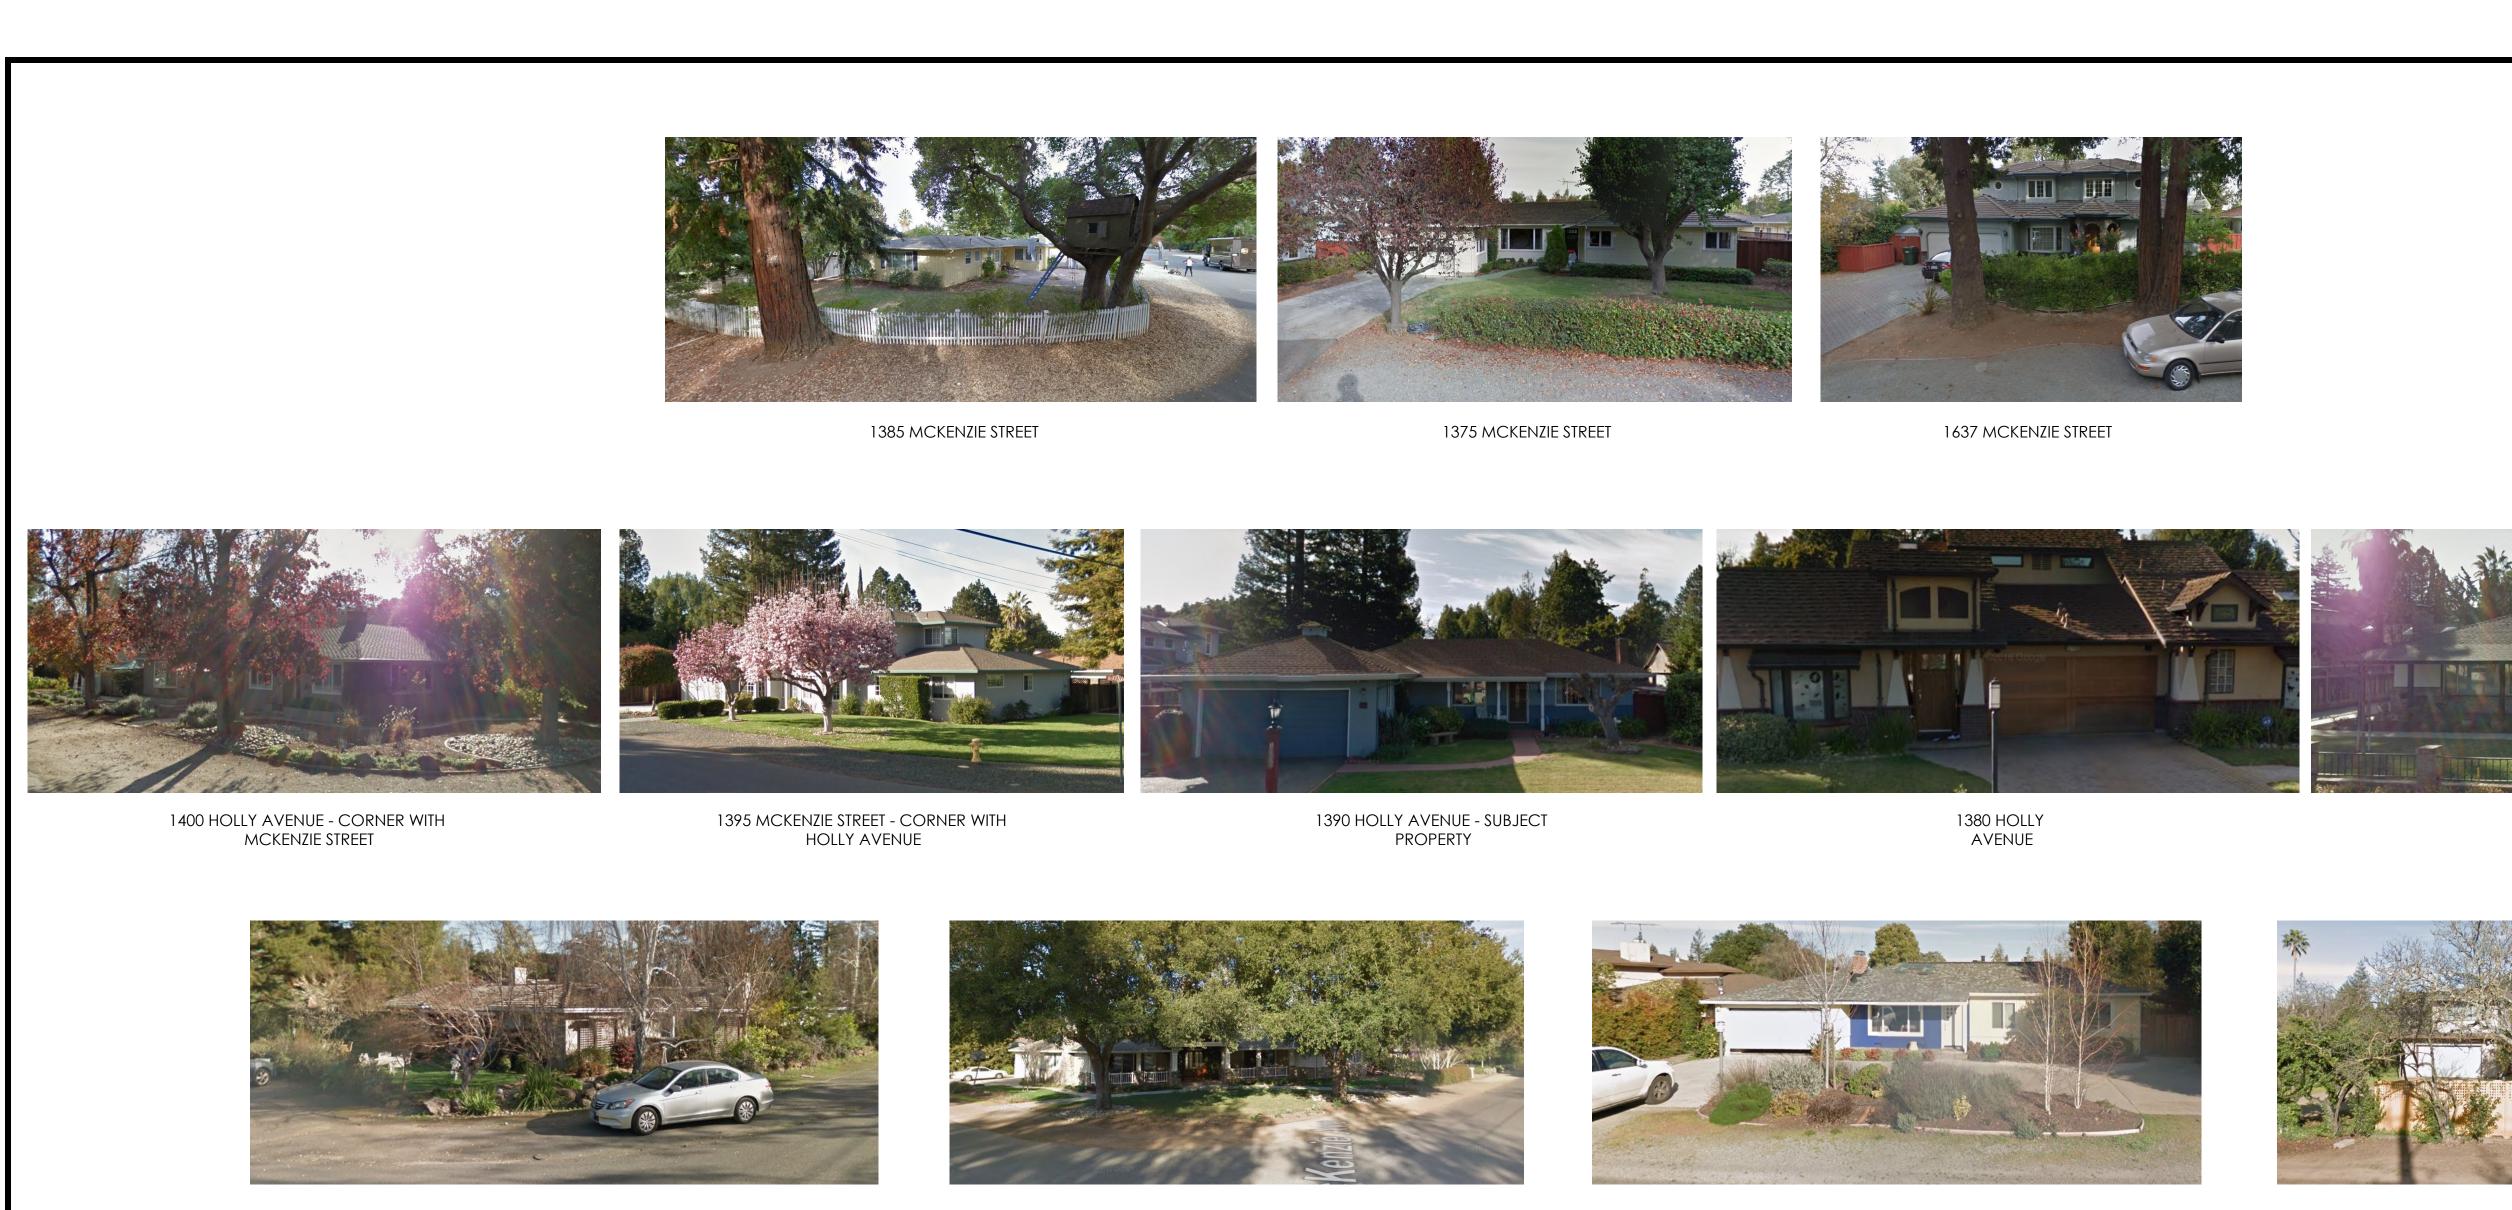

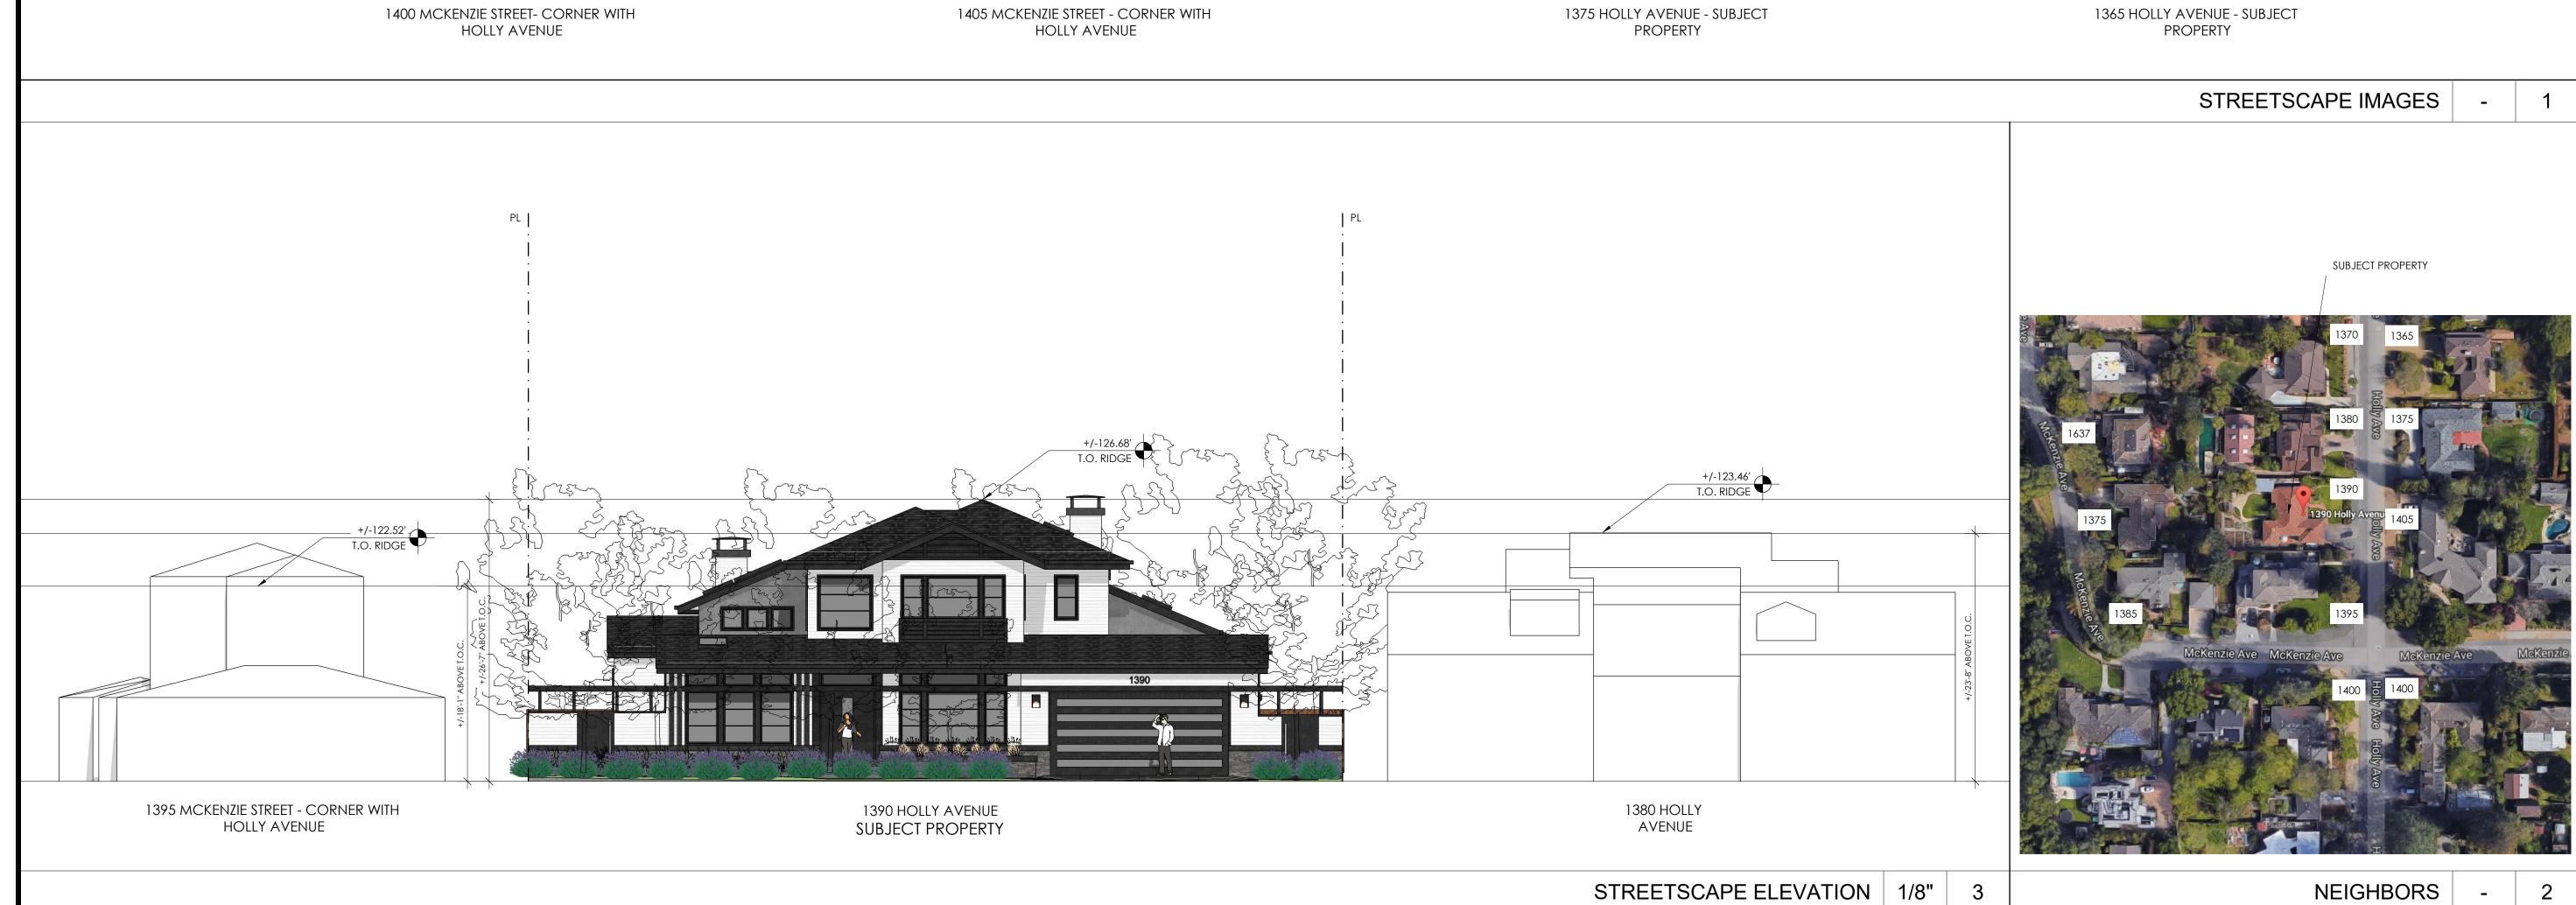





DENCE


NEW SINGLE FAMILY RESIDEN

1370 HOLLY AVENUE

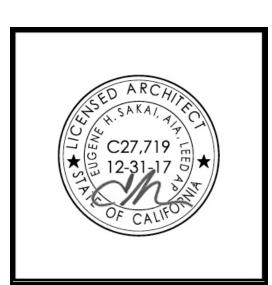


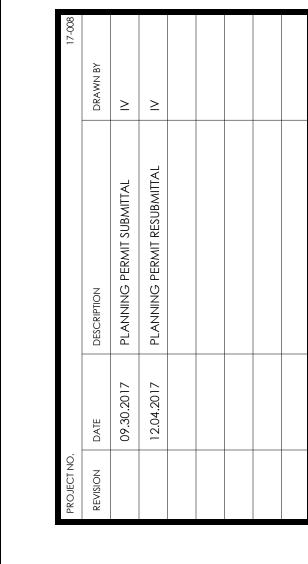

STREETSCAPE

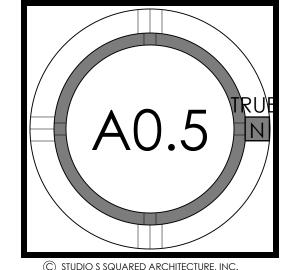


© STUDIO S SQUARED ARCHITECTURE, INC

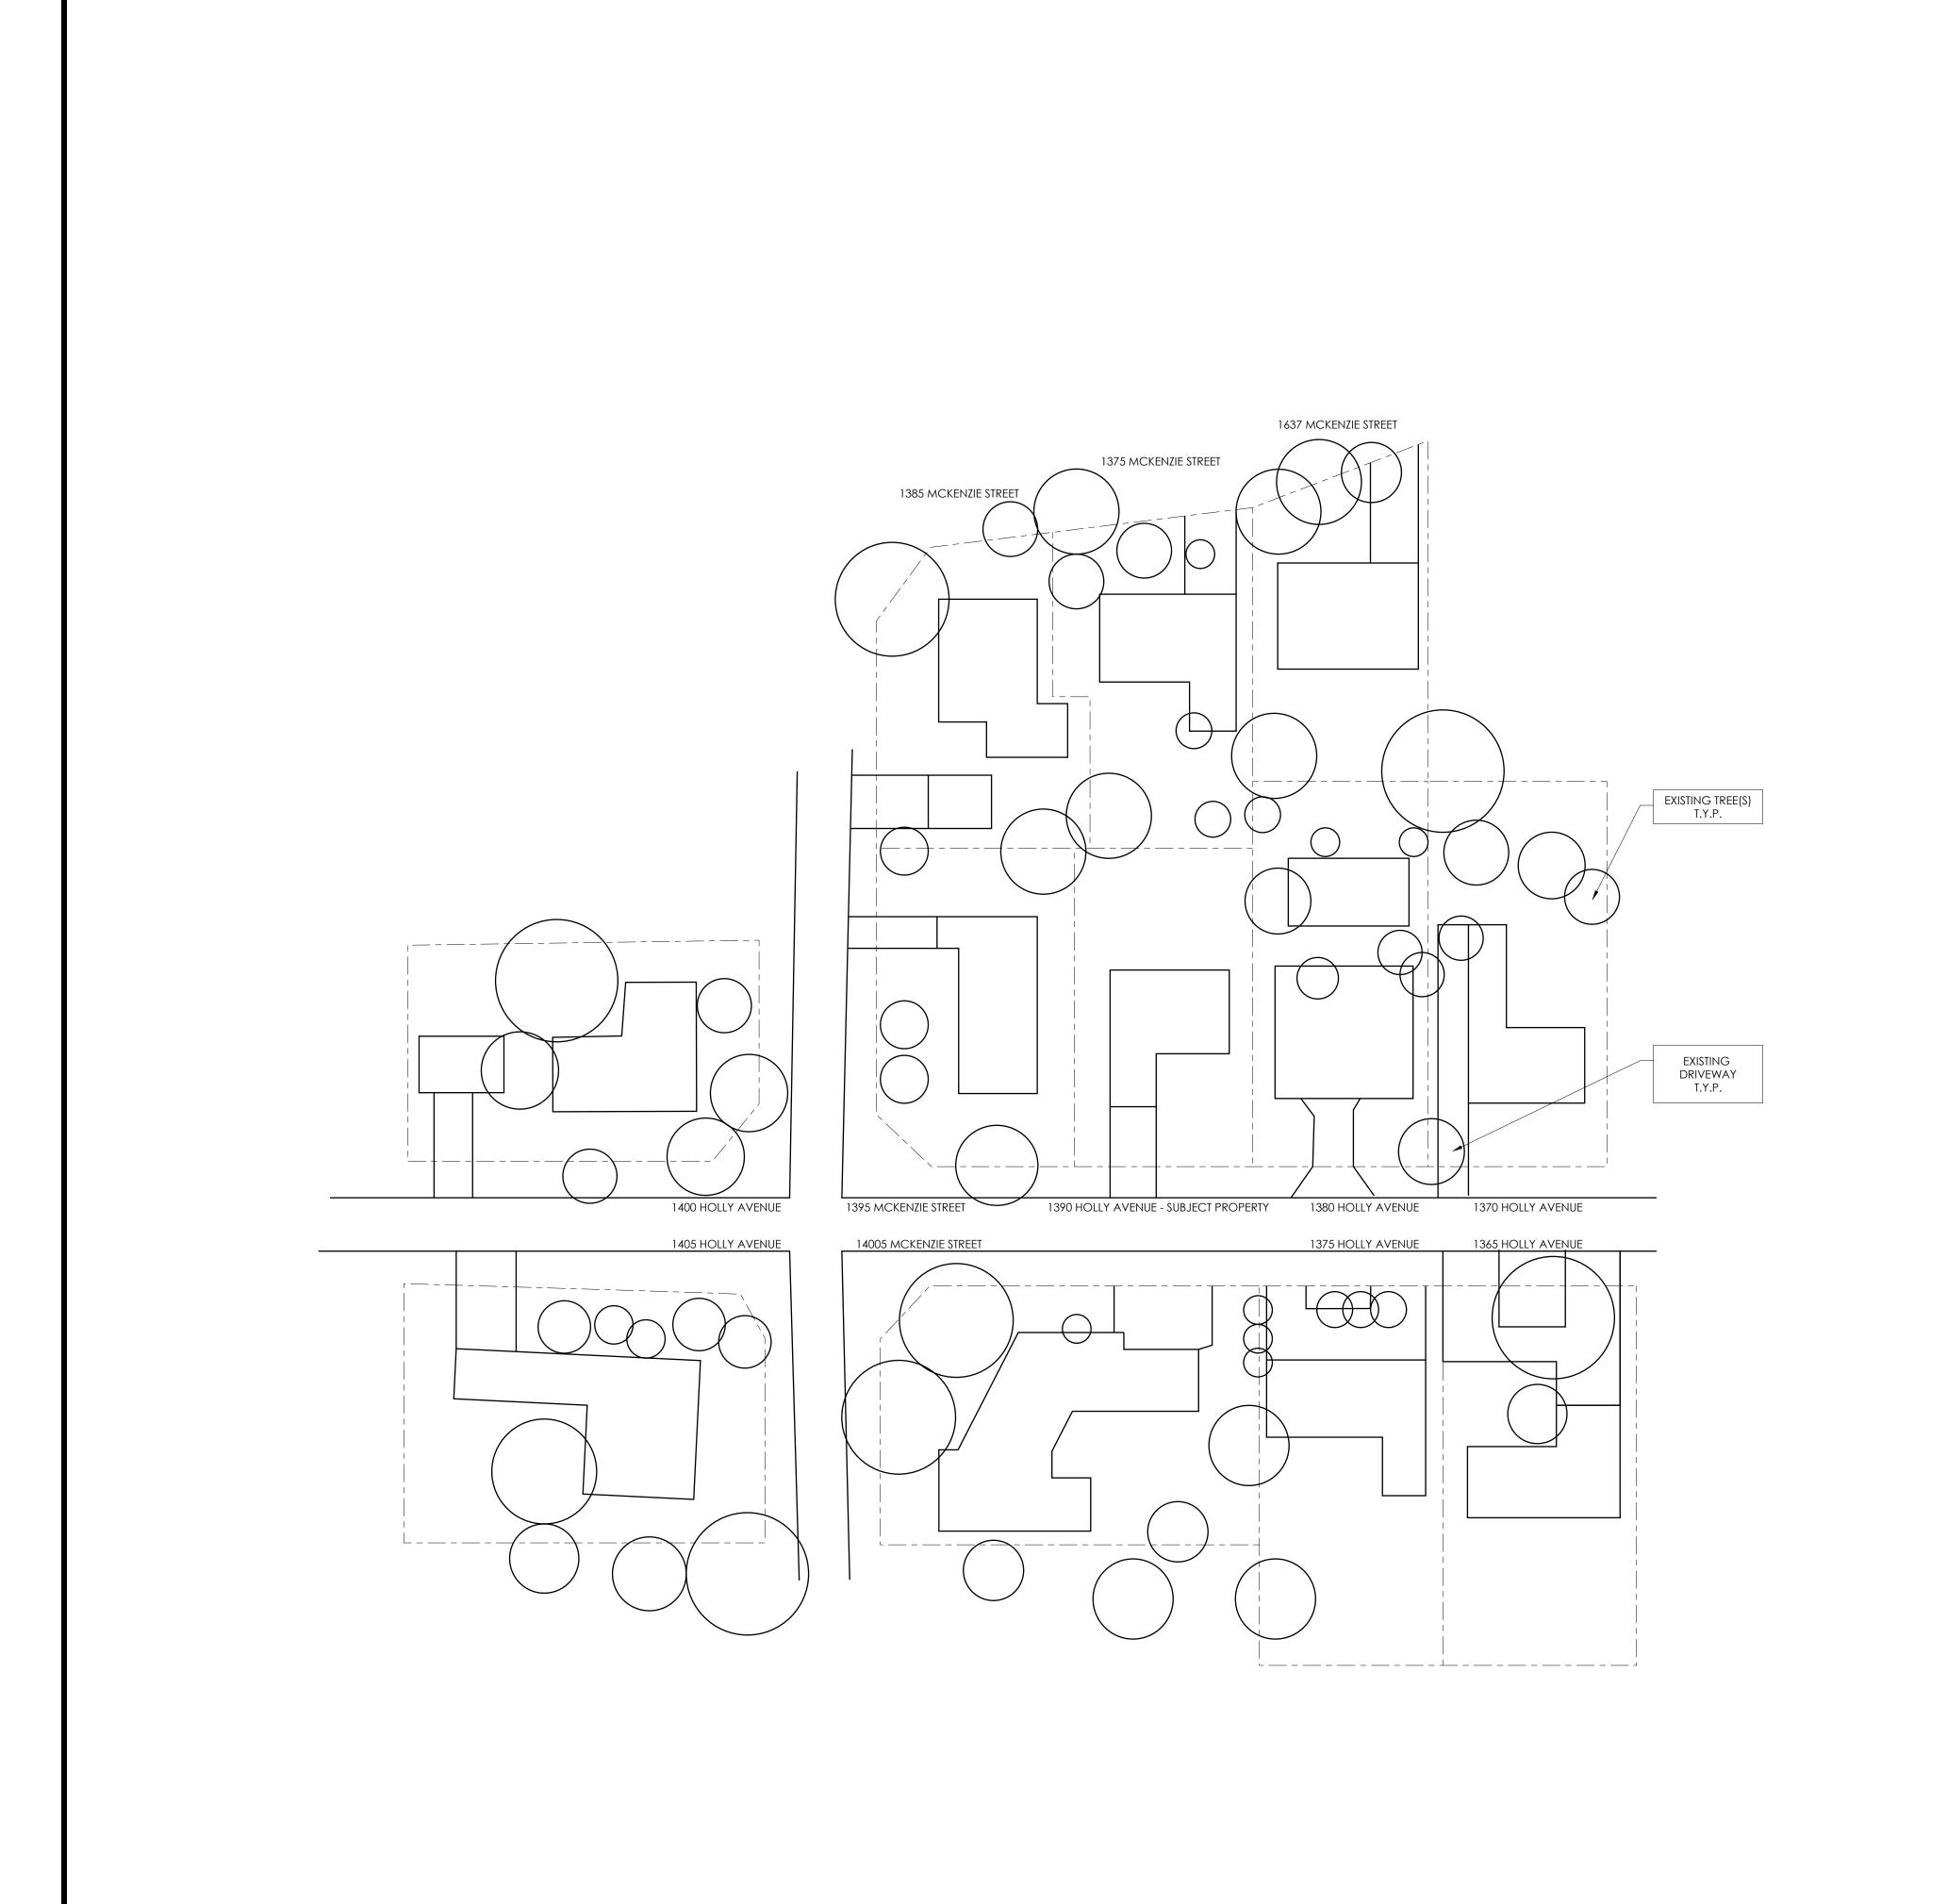




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RESIDENCE

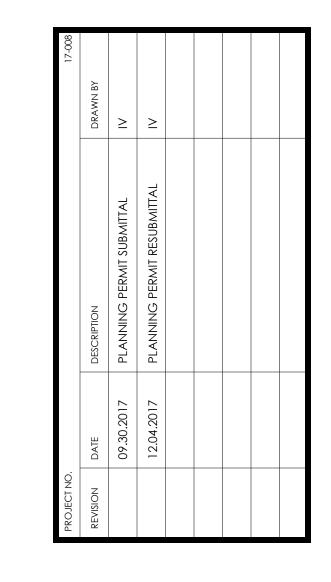

### NEIGHBORHOOD CONTEXT

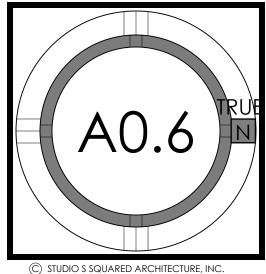

NOTE: OUTLINES OF THE NEIGHBORHOOD STRUCTURES, DRIVEWAYS AND TREES ARE DRAWN USING GOOGLE MAPS VIEWS

NEIGHBORHOOD PRIVACY DIAGRAM | 1/32" | 2

LEGEND -

## City of Palo Alto

## Tree Protection - It's Part of the Plan!

Make sure your crews and subs do the job right!

Fenced enclosures around trees are essential to protect them by keeping the foliage canopy and branching structure clear from contact by equipment, materials and activities, preserving roots and soil conditions in an intact and non-compacted state, and identifying the Tree Protection Zone (TPZ) in which no soil disturbance is permitted and activities are restricted, unless otherwise approved. An approved tree protection report must be added to this sheet when project activity occurs within the TPZ of a regulated tree. For detailed information on Palo Alto's regulated trees and protection during development, review the City Tree Technical Manual (TTM) found at www.cityofpaloalto.org/trees/.


TREE DISCLOSURE STATEMENT CITY OF PALO ALTO Palo Alto, CA 94301 Palo Alto Municipal Code, Chapter 8.10.040, requires disclosure and protection of certain trees located on private and public property, and that they be shown on approved site plans. A completed disclosure statement must accompany all building permit applications that include exterior work, all demolition or grading permit applications, or other development activity. PROPERTY ADDRESS: 1390 HOLLY AVENUE, LOS ALTOS, CA Are there Regulated trees on or adjacent to the property? YES NO (If no, proceed to Section 4) [Sections 1- 4 MUST be completed by the applicant. Please circle and/or check where applicable.] 1. Where are the trees? Check those that apply. (Plans must be submitted showing over 4" diameter trees) On adjacent property overhanging the project site In the City planter strip or right-of-way easement within 30' of property line (Street Trees)\* \*Street trees require special protection by a fenced enclosure, per the attached instructions. Prior to receiving any permit, you must provide an authorized Street Tree Protection Verification form by calling Public Works Operations at 493-5953 for inspection of required type I, II or III 2. Are there any Protected or Designated Trees? (YES Check where applicable) NO Protected Tree (s) □ On or overhanging the property 3. Is there activity or grading within the dripline? (radius 10 times the trunk diameter) of these trees? If Yes, a Tree Preservation Report must be prepared by an ISA certified arborist and submitted for staff review (see TTM, Section 6.25). Attach this report to Sheet T-1,:Tree Protection, its Part of the Plan!", per Site Plan Requirements. 4. Are the Site Plan Requirements\*\* completed? YES NO \*\*Protection of Regulated trees during development require the following: (1) Plans must show the measured trunk diameter and canopy dripline; (2) Plans must denote, as a bold dashed line, a fenced enclosure area out to the dripline, per Sheet T-1 and Detail #605 http://www.cityofpaloalto.org/trees/forms.htm (See also TTM<sup>2</sup>, Section 2.15 for area to be fenced) I, the undersigned, agree to the conditions of this disclosure. I understand that knowingly or negligently providing false or misleading information in response to this disclosure requirement constitutes a violation of the Palo Alto Municipal Code Section 8.10.040, which can lead to criminal and/or civil legal action. (Prop. Owner or Agent) FOR STAFF USE: Sections 5-6 must be completed by staff for the issuance of any development permit (demolition, grading or building permit). 5. Protected Trees. The specified tree fencing is in place. A written statement is attached verifying that (N/A if there are no protected trees, check here □) 6. Street Trees. A signed Public Works Street Tree Protection Verification form is attached. (N/A if there are no street trees, check here  $\square$ ).


Regulated Trees - a) Street trees - trees on public property; b) Protected trees - Coast Live Oaks or Valley Oaks which are 11.5" in diameter or larger, Coast

http://www.cityofpaloalto.org/planning-community/tree\_technical-manual.html

Redwoods which are 18" in diameter or larger, when measured 54" above natural grade; and Heritage trees are trees designated by City Council; and c)

Designated Trees - commercial or non-residential property trees, which are part of an approved landscape plan. Palo Alto Tree Technical Manual (TTM) contains instructions for all requirements on this form, available at

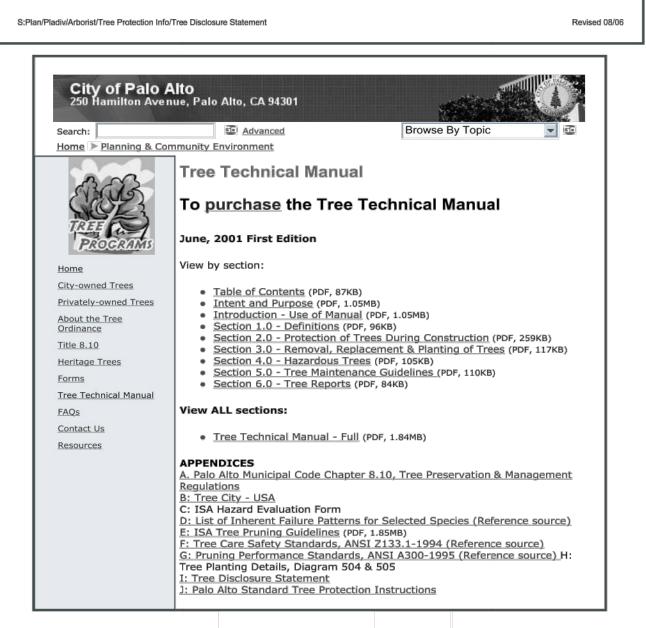

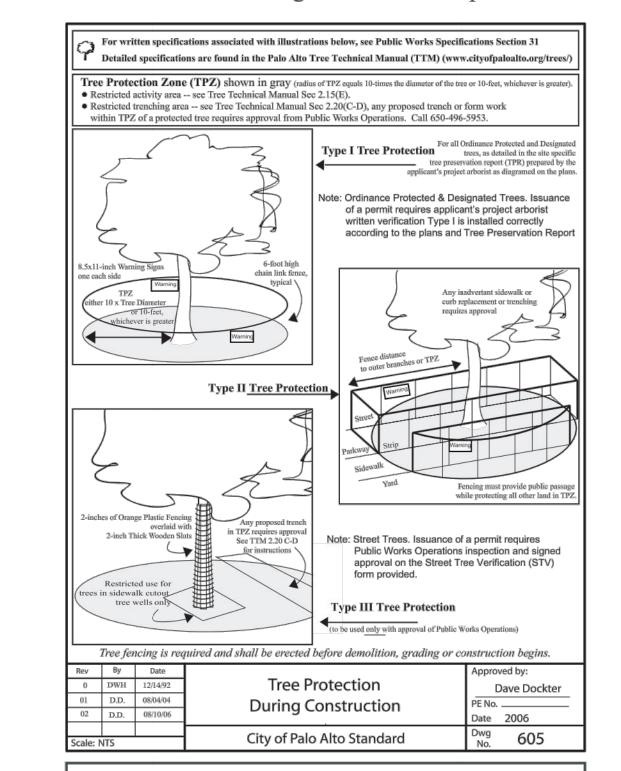

500	THE	APPENDIX
	*	PALO ALTO STREET TREE PROTECTION INSTRUCTIONSSECTION 31
31-1	General	1
	a.	Tree protection has three primary functions, 1) to keep the foliage canopy and branching structure cle from contact by equipment, materials and activities; 2) to preserve roots and soil conditions in an intact an non-compacted state and 3) to identify the Tree Protection Zone (TPZ) in which no soil disturbance permitted and activities are restricted, unless otherwise approved.
	b.	The Tree Protection Zone (TPZ) is a restricted area around the base of the tree with a radius of ten-tim the diameter of the tree's trunk or ten feet; whichever is greater, enclosed by fencing.
1-2	Referen	nce Documents
	a.	Detail 605 – Illustration of situations described below.
	b.	Tree Technical Manual (TTM) Forms (http://www.cityofpaloalto.org/trees/)  1. Trenching Restriction Zones (TTM, Section 2.20(C))
		2. Arborist Reporting Protocol (ITM, Section 6.30)
		3. Site Plan Requirements (TTM, Section 6.35)
		4. Tree Disclosure Statement (TTM, Appendix J)
	c.	Street Tree Verification (STV) Form (http://www.cityofpaloalto.org/trees/forms)
1-3	Execution	ión .
	a.	Type I Tree Protection: The fence shall enclose the entire TPZ of the tree(s) to be protected throughout the life of the construction project. In some parking areas, if fencing is located on paving or concrete that will n be demolished, then the posts may be supported by an appropriate grade level concrete base, if approved by Public Works Operations.
	b.	Type II Tree Protection: For trees situated within a planting strip, only the planting strip and yard side of the TPZ shall be enclosed with the required chain link protective fencing in order to keep the sidewalk and street open for public use.
	e.	Type III Tree Protection: To be used only with approval of Public Works Operations. Trees situated in a tree well or sidewalk planter pit, shall be wrapped with 2-inches of orange plastic fencing from the ground the first branch and overlaid with 2-inch thick wooden slats bound securely (slats shall not be allowed to diginto the bark). During installation of the plastic fencing, caution shall be used to avoid damaging any branches. Major limbs may also require plastic fencing as directed by the City Arborist.
	d.	Size, type and area to be fenced. All trees to be preserved shall be protected with six (6') foot high chain link fences. Fences are to be mounted on two-inch diameter galvanized iron posts, driven into the ground to a depth of at least 2-feet at no more than 10-foot spacing. Fencing shall extend to the outer branching, unless specifically approved on the STV Form.
	e.	*Warning' signs. A warning sign shall be weather proof and prominently displayed on each fence at 20-for intervals. The sign shall be minimum 8.5-inches x 11-inches and clearly state in half inch tall letters: "WARNING - Tree Protection Zone - This fence shall not be removed and is subject to a fine according to PAMC Section 8.10.110."
	f.	<b>Duration.</b> Tree fencing shall be erected before demolition; grading or construction begins and remain in place until final inspection of the project, except for work specifically allowed in the TPZ. Work or soil disturbance in the TPZ requires approval by the project arborist or City Arborist (in the case of work around Street Trees). Excavations within the public right of way require a Street Work Permit from Public Works.
	g.	During construction
		<ol> <li>All neighbors' trees that overhang the project site shall be protected from impact of any kind.</li> <li>The applicant shall be responsible for the repair or replacement plus penalty of any publicly owned tree that are damaged during the course of construction, pursuant to Section 8.04.070 of the Palo Alto Municipal Code.</li> </ol>
		<ul> <li>3. The following tree preservation measures apply to all trees to be retained:</li> <li>a. No storage of material, topsoil, vehicles or equipment shall be permitted within the TPZ.</li> <li>b. The ground under and around the tree canopy area shall not be altered.</li> </ul>
		<ul> <li>Trees to be retained shall be irrigated, aerated and maintained as necessary to ensure survival.</li> <li>END OF SECTION</li> </ul>
lity of l	Palo Alto	2004 Standard Drawings and Specifications
		fication of Protection, PWE, Section 31 Revised 08/06

able 2-2	Palo Alto Tree Technical Manual
	CONTRACTOR & ARBORIST INSPECTION SCHEDULE
Refere	nce: the Palo Alto Tree Technical Manual is available at www.cityofpaloalto.org/environment/
100 miles	ITEMS APPLY TO THIS PROJECT:
signed Monthl inspect designa	tion of Protective Tree Fencing. For Public Trees, the Street Tree Verification Form shall be by the City Arborist. For Protected Trees, the project site arborist shall provide an initial by Tree Activity Report form with a photograph verifying that he has conducted a field ion of the trees and that the correct type of protective fencing is in place around the sted tree protection zone (TPZ) prior to issuance of a demolition, grading, or building permit. IM, Verification of Tree Protection, Section 1.39).
conduc grading	nstruction Meeting. Prior to commencement of construction, the applicant or contractor shall tapre-construction meeting to discuss tree protection with the job site superintendent, goperators, project site arborist, City Arborist, and, if a city maintained irrigation system is ed, the Parks Manager (Contact 650-496-6962).
perform TPZ to require	tion of Rough Grading or Trenching. Contractor shall ensure the project site arborist as an inspection during the course of rough grading or trenching adjacent to or within the ensure trees will not be injured by compaction, cut or fill, drainage and trenching, and if d, inspect aeration systems, tree wells, drains and special paving. The contractor shall provide ject arborist at least 24 hours advance notice of such activity.
monthl immed Techni landsca	ly Tree Activity Report Inspections. The project site arborist shall perform a minimum y activity inspection to monitor and advise on conditions, tree health and retention or, iately if there are any revisions to the approved plans or protection measures. The Tree cal Manual Monthly Tree Activity Report format shall be used and sent to the Planning Dept. spe review staff no later than 14 days after issuance of building permit date. Fax to (650) 329-See TTM, Monthly Tree Activity Inspection Report, Addendum 11 & section 1.17).
require	activity within the Tree Protection Zone. Work in the TPZ area (see also #7 below) is the direct onsite supervision of the project arborist (see TTM, Trenching, Excavation & ment, Section 2.20 °C).
final oc on site Quality constru verifica	cape Architect Inspection. For discretionary development projects, prior to temporary or ccupancy the applicant or contractor shall arrange for the Landscape Architect to perform an inspection of all plant stock, quality of the materials and planting (see TTM, Planting v, Section 5.20.1 A) and that the irrigation is functioning consistent with the approved action plans. The Planning Dept. landscape review staff shall be in receipt of written ation of Landscape Architect approval prior to scheduling the final inspection, unless ise approved.
List O	ther (please describe as called out in the site Tree Preservation Report, Sheet T-1, T-2, etc.)
*	
*	

Pul PO 650	ee Department blic Works Operations Dox 10250 Palo Alto, CA 0/496-5953 FAX: 650/85 eprotection@CityofPaloA	A 94303 2-9289		rification of Tree Protection	
				form along with signed Tree ect and notify applicant.	
APPLICATION DAT	E:				
ADDRESS/LOCATI TREES TO BE PRO					
APPLICANT'S NAM	1E:				
APPLICANT'S ADD	RESS:			:	
APPLICANT'S TEL & FAX NUMBERS:	EPHONE				
This section to be file	led out by City Tree St	aff			
1. The Street Tree address(es) are	adequately		YES 🗌	NO* □	
used is:	ype of protection		* If NO, g	o to #2 below	
Inspected by:				<del></del>	
Date of Inspectio	n:			:	
The Street Tree address are <u>NO</u> protected. The formodifications are Indicate how the modifications we to the applicant.	Tadequately collowing e required: e required ere communicated				
Subsequent Inspect	ion			:	
Street trees at above to be adequately pro	e address were found otected:	* If	YES   NO, indicate in "Notes"	NO* ☐ below the disposition of case.	
Inpsected by:					
Date of Inspection:					
Notes: List City stre site, condition and ty installed. Also note taken. Use back of	pe of tree protection if pictures were				
Return approved si S:PWD/OPS/Tree/DS/St.Tree	heet to Applicant for eProtect	demolition o	r building permit is		5/170

		m Data Here		RCA/IS	A Certified Arborist #WE
_	M	onthly Tree	Activity Repo	rt- Construction	on Site
	nspection ate:	Site address:	Contractor- Main Site Contact	#1: Job site superinte Company: Email:	
1123	nspection	Palo Alto, CA	Information	Job site Office: Cell: Mail:	
			Also present:	:	
D	istribution:	City of Palo Alto     Others	Attn: Dave Dockter	Dave.dockter@cityofp: 650-329-2440	aloalto.org
51		ested minimum inform		istomize as necessary. To be project completion. Use ad	
<ol> <li>4.</li> <li>5.</li> </ol>	b. Inspect C. Determine Tree P b. Trench Action Item a. Tree P b. Root z c. Schede Photographs	t to verify that tree prinine if field adjustment wations (general site-protection Fences (TP, sing has/will occur is (list site-wide, by the protection Fence (TPF tone buffer material (value sewer trench, four situations) (use often)  on Map (mandatory 8)	wide and list by individe F) are  The enumber and date to be needs adjusting (tree wood chips) can be insudation dig with	in place evisions may be needed dual tree number) be satisfied) and Date Du # x, x, x) talled next	e
7.	Past visits (	list carry-over items s	atisfied/still outstandir	g)	
P	espectfully so roject site arb onsultant cor c:	porist	lude email, cell#, and i	nailing)	
		CPA Mon			

### ---WARNING---**Tree Protection Zone**

This fencing shall not be removed without City Arborist approval (650-496-5953)

Removal without permission is subject to a \$500 fine per day\*

\*Palo Alto Municipal Code Section 8.10.110 City of Palo Alto Tree Protection Instructions are located at http://www.city.palo-alto.ca.us/trees/technical-manual.html

SPECIAL INSPECTIONS	PLANNING DEPARTMENT
TREE PROTECTION IN	SPECTIONS MANDATORY
PAMC 8.10 PROTECTED TREES. CONTRACTOR SHAL REQUIRED TREE INSPECTION AND SITE MONITORIN REPORTS TO THE PLANNING DEPARTMENT LANDSC BUILDING PERMIT ISSUANCE.	
BUILDING PERMIT DATE:	
DATE OF 1ST TREE ACTIVITY REPORT:	
CITY STAFF:	
VERIFY THAT ALL TREE PROTECTION MEASURES AF ACTIVITY, SCHEDULED OR UNSCHEDULED, WITHIN	/ITY REPORT SHALL CONFORM TO SHEET T-1 FORMAT RE IMPLIMENTED AND WILL INCLUDE ALL CONTRACTOR A TREE PROTECTION ROOT ZONE. NON-COMPLIANCE REFERENCE: PALO ALTO TREE TECHNICAL MANUAL

Apply Tree Protection Report on sheet(s) T-2


Use addtional "T" sheets as needed



1000 S Winchester Blvd San Jose, CA 95128 P: (408) 998 - 0983


F: (408) 404 - 0144

RESIDENCE SLE FAMILY RESIDENCE

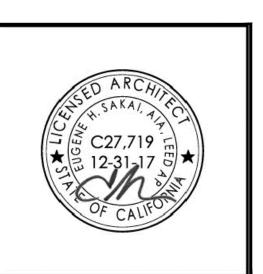

PROJECT NO.			17-00
REVISION	DATE	DESCRIPTION	DRAWN B
	09.30.2017	09.30.2017 PLANNING PERMIT SUBMITTAL	<u>&gt;</u>
	12.04.2017	12.04.2017 PLANNING PERMIT RESUBMITTAL IV	<u>&gt;</u>

TREE **PROTECTION** PLAN

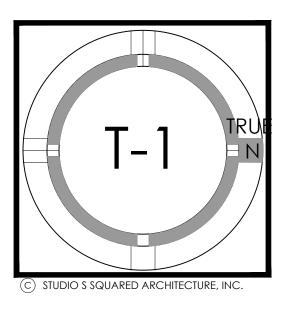

Special Tree Protection Instruction Sheet City of Palo Alto



All other tree-related reports shall be added to the space provided on this sheet (adding as needed) Include this sheet(s) on Project Sheet Index or Legend Page. 1-1 A copy of T-1 can be downloaded at

roject

http://www.cityofpaloalto.org/civica/filebank/blobdload.asp?BlobID=6460

## City of Palo Alto Tree Protection - It's Part of the Plan!

Make sure your crews and subs do the job right!

Fenced enclosures around trees are essential to protect them by keeping the foliage canopy and branching structure clear from contact by equipment, materials and activities, preserving roots and soil conditions in an intact and non-compacted state, and identifying the Tree Protection Zone (TPZ) in which no soil disturbance is permitted and activities are restricted, unless otherwise approved. An approved tree protection report must be added to this sheet when project activity occurs within the TPZ of a regulated tree. For detailed information on Palo Alto's regulated trees and protection during development, review the City Tree Technical Manual (TTM) found at www.cityofpaloalto.org/trees/.

Kielty Arborist Services LLC Certified Arborist WE#0476A P.O. Box 6187 San Mateo, CA 94403 650-515-9783

October 10, 2017

San Jose, CA 95128

Studio S. Squared Architecture, Inc. Attn: Cao Shu 1000 S. Winchester Blvd.

Site: 1390 Holly Avenue, Los Altos, CA

As requested on Monday, October 9, 2017, I visited the above site to inspect and comment on the trees. New home construction is proposed for this site and your concern as to the future health and safety of the trees on site has prompted this visit.

All inspections were made from the ground; the trees were not climbed for this inspection. The trees in question were located on a to scale map provided by you. The trees were then measured for diameter at 54 inches above ground level (DBH or diameter at breast height). The trees were given a condition rating for form and vitality. The trees condition ratings are based on 50 percent vitality and 50 percent form, using the following scale.

> 1 - 29 Very Poor 30 - 49 Poor 50 - 69 Fair 70 - 89 Good

90 - 100 Excellent

The height of the trees was measured using a Nikon Forestry 550 Hypsometer. The spread was paced off. Comments and recommendations for future maintenance are provided.

1390 Holly/10/10/17

**DBH CON HT/SP Comments Tree# Species** 11.6 40 5/20 Poor vigor, fair form, in decline, brown rot. Apricot (Prunus armeniaca)

8est 50 20/20 Fair vigor, poor form, shared tree. Ivy on

18.9 45 30/35 Good vigor, poor form, pollarded, decay on Fruitless mulberry 40est 75 70/35 Good vigor, good form, 15 feet from

38est 70 70/35 Good vigor, good for, 5 feet from property line corner. (Seguoia sempervirens)

26.1 65 30/40 Good vigor, fair form, heavily topped in Black walnut (Juglans californica) 12.7 50 25/35 Good vigor, poor-fair form, growing (Persea americana)

24.1 40 20/25 Fair vigor, poor form, heavily topped and Black walnut (Juglans californica)

The trees on and off the site are a mix of native walnuts and non-native trees. Several of the trees on the site have been poorly maintained and should be removed. Walnut #8 and fruitless mulberry #3 have been heavily topped and are decayed.

Walnut #6 and avocado #7 are in the rear corner of the property and can be retained. Redwoods #4 and #5 are near the southern corner of the property and should not be affected. Apricot #1 is in poor condition and should be removed. The following tree protection plan should be followed

#### for any retained trees. **Tree Protection Plan:**

Tree protection zones should be established and maintained throughout the entire length of the project. Fencing for the protection zones should be 6-foot-tall metal chain link type supported by 2-inch diameter metal poles pounded into the ground to a depth of no less than 2 feet. The support poles should be spaced no more than 10 feet apart on center. The location for the protection fencing should be placed at 10X the trees diameter where possible.

1390 Holly/10/10/17

Where not possible tree protection should be placed as close as possible to the proposed work while still allowing room for construction to safely continue. Signs should be placed on fencing signifying "Tree Protection Zone - Keep Out". No materials or equipment should be stored or cleaned inside the tree protection zones. Areas outside the fencing but still beneath the dripline of protected trees, where foot traffic is expected to be heavy, should be mulched with 4 to 6 inches of chipper chips. The following tree protection distances should be followed throughout the entire length of the project:

Root Cutting Any roots to be cut should be monitored and documented. Large roots or large masses of roots to be cut should be inspected by the site arborist. The site arborist may recommend irrigation at that time. Cut all roots clean with a saw or loppers. Roots to be left exposed for a period of time

Trenching and Excavation

Trenching for irrigation, electrical, drainage or any other reason, should be hand dug when beneath the dripline of desired trees. Hand digging and careful placement of pipes below or beside protected roots will dramatically reduce root loss, thus reducing trauma to desired trees. Trenches should be back filled as soon as possible using native materials and compacted to near original levels. Trenches to be left open with exposed roots shall be covered with burlap and kept moist. Plywood laid over the trench will help to protect roots below. The site arborist will be on site during any excavation within the driplines of protected trees.

should be covered with layers of burlap and kept moist by spraying the burlap multiple times a

Normal irrigation should be maintained throughout the entire length of the project. Irrigation should consist of surface flooding, with enough water to wet the entire root zone. If the root zone is traumatized this type of irrigation should be carried out two times per month during the


The information included in this report is believed to be true and based on sound arboricultural principles and practices.

Apply Tree Protection Report on sheet(s) T-2

Use addtional "T" sheets as needed

Kevin R. Kielty

David P. Beckham Certified Arborist WE#0476A Certified Arborist WE#10724A

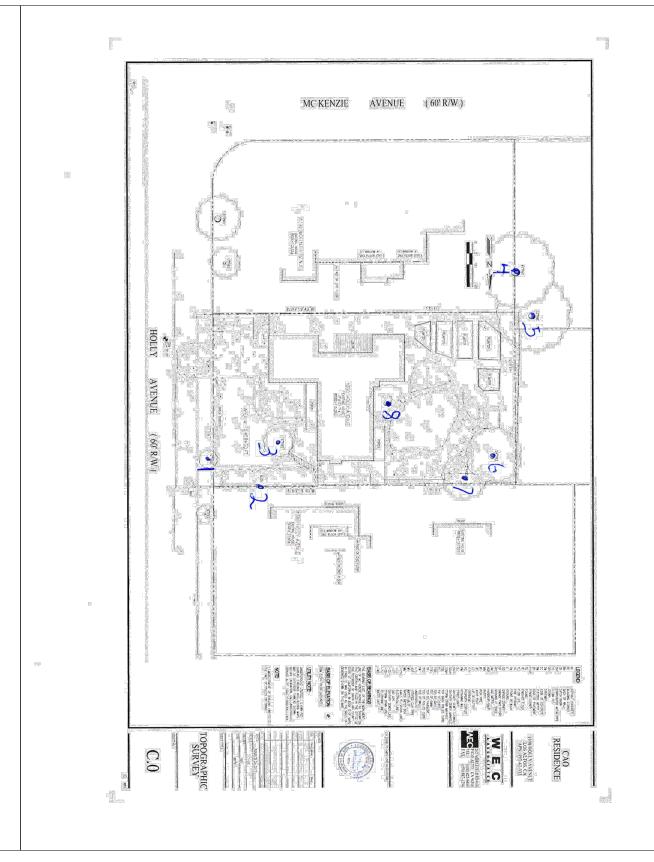



All other tree-related reports shall be added to the space provided on this sheet (adding as needed) Include this sheet(s) on Project Sheet Index or Legend Page. A copy of T-1 can be downloaded at http://www.cityofpaloalto.org/civica/filebank/blobdload.asp?BlobID=6460


Special Tree Protection Instruction Sheet City of Palo Alto




ARCHITECTURE


1000 S Winchester Blvd San Jose, CA 95128 P: (408) 998 - 0983 F: (408) 404 - 0144


CAO RESIDENCE
JEW SINGLE FAMILY RESIDENCE AVENUE, LOS

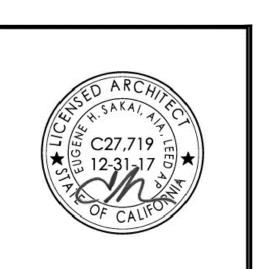

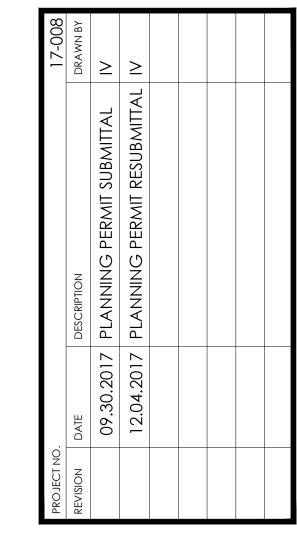

TREE PROTECTION PLAN

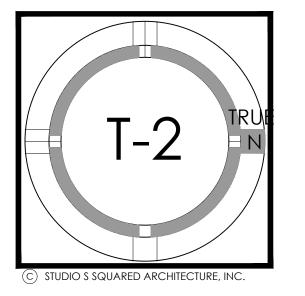


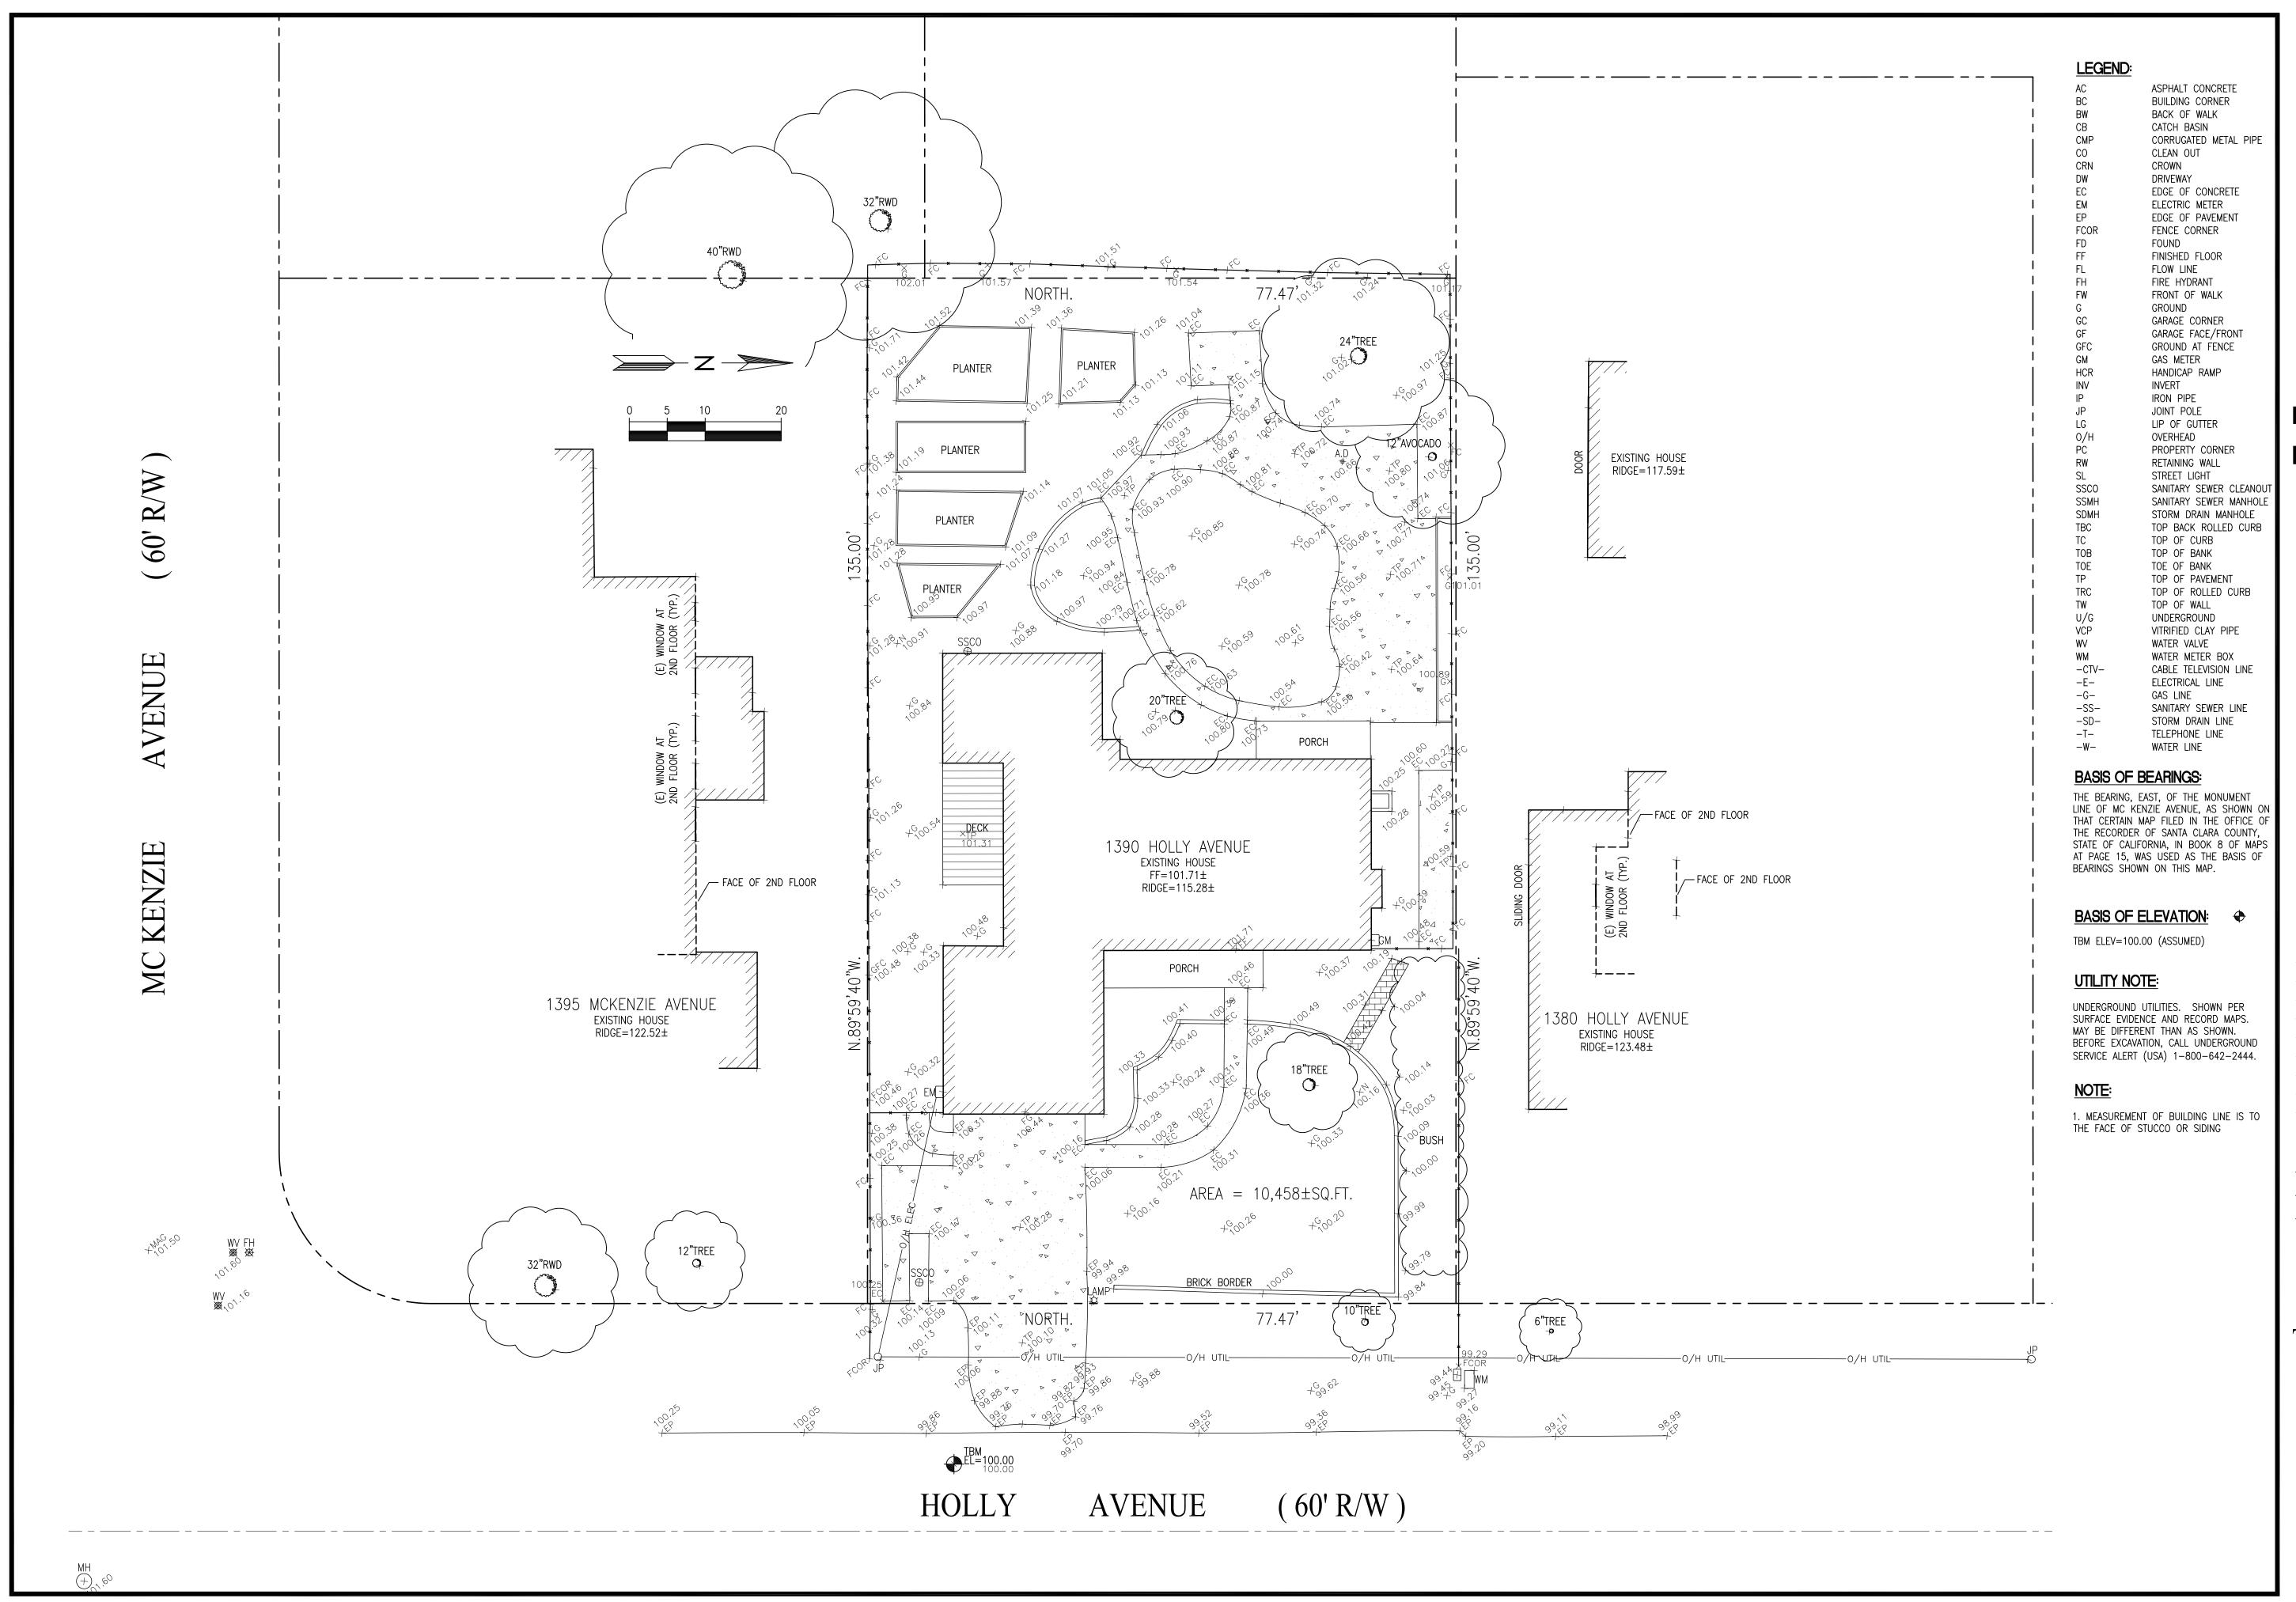

CAO RESIDENCE

1390 HOLLY AVENUE LOS ALTOS, CA APN: 193-42-033

WEC & ASSOCIATES

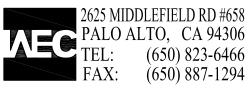

LICENSE STAMPS AND SIGNATURE




No.	Description	Date
DAT	E: MARCH 26, 2017	
SCA.	LE: 1"=10'	
DRA	WN:	
JOB:	10078	

TOPOGRAPHIC SURVEY

SHEET NO.

C.(

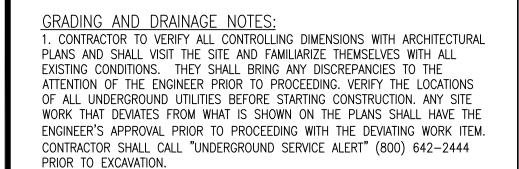

2. THE SITE SHALL BE FINE GRADED TO PROVIDE A MINIMUM OF 5% SLOPE AWAY FROM THE BUILDING PERIMETER AND ADJACENT PROPERTY LINES. EXISTING DRAINAGE COMING FROM ADJACENT PROPERTIES SHALL BE MAINTAINED. IN NO CASE SHALL THE FINAL GRADING INCREASE SHEET FLOW ONTO ADJACENT PROPERTIES.

3. THE HOUSE AND GARAGE MUST HAVE DOWN SPOUTS THAT ARE DIRECTED TO SPLASH BLOCKS (2 FEET LONG) THAT DEFLECT THE WATER AWAY FROM BUILDING FOUNDATION BY SURFACE DRAINAGE. ALL DOWNSPOUT AND GUTTER SHALL BE GALV. SHEET METAL.

4. CONTRACTOR SHALL OBTAIN A STREET WORK PERMIT FROM PUBLIC WORKS ENGINEERING FOR ANY PROPOSED CONSTRUCTION WHICH WILL IMPACT THE USE OF THE SIDEWALK, STREET AND ALLEY OR ON THE PROPERTY IN WHICH THE CITY HOLDS AN INTEREST.

5. ANY CONSTRUCTION WITHIN THE CITY RIGHT-OF WAY MUST HAVE AN APPROVED PERMIT FOR CONSTRUCTION IN THE PUBLIC STREET PRIOR TO COMMENCEMENT OF THIS WORK. THE PERFORMANCE OF THIS WORK IS NOT AUTHORIZED BY THE BUILDING PERMIT ISSUANCE BUT SHOWN ON THE BUILDING PERMIT FOR INFORMATION ONLY.

6. IF GROUNDWATER OR RUNOFF WATER IS ENCOUNTERED AND REQUIRES REMOVAL FROM THE EXCAVATION AREA, ALL EXCAVATION AND/OR BUILDING ACTIVITIES MUST IMMEDIATELY STOP. THE PLAN FOR THE DEWATERING OF THE EXCAVATION MUST BE DESIGNED AND SUBMITTED FOR APPROVAL TO THE PUBLIC WORKS-ENGINEERING DIVISION. ONCE APPROVAL OF THE PLAN DESIGN HAS BEEN RECEIVED, IMPLEMENTATION OF THE PLAN IS REQUIRED PRIOR TO THE COMMENCEMENT OF THE EXCAVATION AND/OR BUILDING ACTIVITIES.

### EROSION CONTROL AND BEST MANAGEMENT PRACTICE:

1. CONTRACTOR SHALL ASSUME THE CONCEPTS ON THE EROSION CONTROL PLAN/NOTES, IF PROVIDED, ARE MINIMUM REQUIREMENTS, THE FULL EXTENTS OF WHICH ARE TO BE DETERMINED BY CONTRACTOR. CONTRACTOR IS RESPONSIBLE FOR THE EXACT DESIGN AND EXTENT OF CONTRACTOR'S INTENDED USE AND MANAGEMENT OF THE CONSTRUCTION SITE.

2. ALL EROSION CONTROL FACILITIES SHALL BE INSPECTED BY THE CONTRACTOR AND REPAIRED AS REQUIRED AT THE CONCLUSION OF EACH WORKING DAY DURING THE RAINY SEASON. REPAIRS TO DAMAGED FACILITIES SHALL BE MADE IMMEDIATELY UPON DISCOVERY.

3. THE CONTRACTOR SHALL REMOVE ANY ACCUMULATION OF SILT OR DEBRIS FROM THE EROSION CONTROL SEDIMENT BASINS FOLLOWING EACH STORM AND SHALL CLEAR THE OUTLET PIPES OF ANY BLOCKAGE.

4. STOCKPILED MATERIAL SHALL BE COVERED WITH VISQUEEN OR TARPAULIN UNTIL THE MATERIAL IS REMOVED FROM THE SITE. ANY REMAINING BARE SOIL THAT EXISTS AFTER THE STOCKPILE HAS BEEN REMOVED SHALL BE COVERED UNTIL A NATURAL GROUND COVER IS ESTABLISHED OR IT MAY BE SEEDED OR PLANTED TO PROVIDE GROUND COVER PRIOR TO THE FALL RAINY SEASON.

5. PROTECT ADJACENT PROPERTIES AND UNDISTURBED AREAS FROM CONSTRUCTION IMPACTS USING VEGETATIVE BUFFER STRIPS. SEDIMENT BARRIERS OR FILTER. DIKES. MULCHING OR OTHER MEASURES AS APPROPRIATE.

6. CONTRACTOR SHALL MAINTAIN ADJACENT STREETS IN A NEAT, CLEAN, DUST FREE AND SANITARY CONDITION AT ALL TIMES. CONTRACTOR SHALL BE RESPONSIBLE FOR ANY CLEAN UP ON ADJACENT STREETS AFFECTED BY THEIR CONSTRUCTION. NO STOCKPILING OF BUILDING MATERIALS WITHIN THE PUBLIC RIGHT-OF WAY IS

7. PROTECT DOWN SLOPE DRAINAGE COURSES, STREAMS AND STORM DRAINS WITH ROCK FILLED SAND BAGS, TEMPORARY DRAINAGE SWALES, SILT FENCES, EARTH BERMS. STORM DRAIN INLET FILTERS AND/OR STRAW BALES USED ONLY IN CONJUNCTION WITH PROPERLY INSTALLED SILT FENCES. PROVIDE ROCKED DRIVEWAY FOR SITE ACCESS DURING CONSTRUCTION.

#### **UTILITY NOTES:**

1. CONTRACTOR SHALL PREPARE AN ACCURATE COMPOSITE UTILITY PLAN THAT TAKES INTO ACCOUNT THE ACTUAL LOCATION OF EXISTING UTILITIES. CONTRACTOR SHALL VERIFY (POTHOLE IF NECESSARY) SIZE, MATERIAL, LOCATION AND DEPTH OF ALL GRAVITY SYSTEMS THAT ARE TO BE CONNECTED TO OR CROSSED PRIOR TO THE TRENCHING OR INSTALLATION. ALL WORK FOR GRAVITY SYSTEMS SHALL BEGIN AT THE 1. DOWNSTREAM CONNECTION POINT. ALL DIRECTION CHANGES SHALL BE MADE WITH A WYE CONNECTION. ELBOWS AND TEE SHOULD BE AVOIDED.

2. CLEANOUTS, CATCH BASINS AND AREA DRAINS ARE TO BE ACCURATELY LOCATED BY THEIR RELATIONSHIP TO THE BUILDING, FLATWORK, ROOF DRAINS, AND/OR CURB LAYOUT, NOT BY THE LENGTH OF PIPE SPECIFIED IN THE DRAWINGS.

3. A MINIMUM OF SIX (6) INCHES VERTICAL CLEARANCE SHALL BE PROVIDED BETWEEN CROSSING UTILITY PIPES, EXCEPT THAT THE MINIMUM VERTICAL CLEARANCE BETWEEN WATER AND SANITARY SEWER PIPELINES SHALL BE 12 INCHES AND ALL NEW WATER PIPES SHALL BE TYPICALLY INSTALLED TO CROSS ABOVE/OVER EXISTING SANITARY SEWER PIPELINES.

4. A MINIMUM HORIZONTAL SEPARATION BETWEEN NEW PIPELINES AND ANY EXISTING UTILITIES SHALL BE FIVE (5) FEET, EXCEPT THAT THE MINIMUM HORIZONTAL SEPARATION FOR WATER AND SANITARY SEWER PIPELINES SHALL BE 10 FEET MINIMUM, UNLESS OTHERWISE NOTED. A MINIMUM HORIZONTAL SEPARATION BETWEEN NEW PIPELINES AND JOINT TRENCH SHALL BE 5 FEET.

#### GEOTECHNICAL INVESTIGATION REPORT

A GEOTECHNICAL INVESTIGATION REPORT HAS BEEN PREPARED BY JOEL BALDWIN, EARTH INVESTIGATIONS CONSULTANTS, P.O. BOX 795, PACIFICA, CA, 650-557-0262 (DATE: APRIL 29, 2014, JOB NO 2513.02.00)

### **EATHWORK QUANTITIES:**

CUT(OUTSIDE BLDG FOOTPRINT) 350 C.Y. CUT(INSIDE BLDG FOOTPRINT) 1450 C.Y. 355 C.Y. BALANCE 1445 C.Y.

EARTHWORK QUANTITIES SHOWN ARE FOR PLANNING PURPOSES ONLY. CONTRACTOR SHALL PERFORM THEIR OWN EARTHWORK QUANTITY CALCULATION AND USE THEIR CALCULATION FOR BIDDING AND COST ESTIMATING PURPOSES.

#### CUT AND FILL EST.

#### ----SS----- SANITARY SEWER ——SL—— STREET LIGHT ----IRR----- IRRIGATION — X — FENCE ——TV—— TV/CABLE TV ——FS—— FIRE SERVICE — JT — JOINT TRENCH — W — DOMESTIC WATER SERVICE — O/H — OVERHEAD WIRES — T — TELEPHONE × 16.07 (E) SPOT ELEVATION —— G —— NATURAL GAS (N) SPOT ELEVATION ——FM—— FORCE MAIN ——SPLASH BLOCK, MIN. 2 FEET LONG DEFLECT THE WATER AWAY FROM BOTH BLDG.

-DOWNSPOUT

FINISHED GROUND ELEV.

FLOW LINE ELEVATION

FORCE MAIN LINE

FW FIRE WATER LINE

FINISHED PAVEMENT

FINISH SURFACE ELEV

#### LEGEND

AB AC	AGGREGATE BASE ASPHALT CONCRETE	GB	GRADE BREAK
		GM	GAS METER
AD	AREA DRAIN	GR	GRATE ELEVATION
BW	BOTTOM OF WALL	HP	HIGH POINT
CB	CATCH BASIN	INV	INVERT ELEVATION
CIP	CAST IRON PIPE	JT	JOINT TRENCH
CL	CENTER LINE	JP	JOINT POLE
CONC	CONCRETE	LD	LANDSCAPE DRAIN
CS	CRAWL SPACE ELEV.	LF	LINEAR FEET
DD	DECK DRAIN	(N)	NEW
DIP	DUCT IRON PIPE	РКС	PARKING
DS	DOWNSPOUT		POINT OF CONNECTION
DWY	DRIVEWAY	RET	RETAINING WALL
(E)	EXISTING CRADING	RIM	RIM ELEVATION
	EXISTING GRADING	S	SLOPE
EM	ELECTRICAL METER	SD	STORM DRAIN LINE
EP	EDGE OF PAVEMENT		STORM DRAIN CLEANOUT
FC	FACE OF CURB ELEV.		STORM DRAIN FORCED MAIN
FD	FRENCH DRAIN	SS	SANITARY SEWER
FF	FINISH FLOOR ELEVATION		SANITARY SEWER CLEANOUT
FG	FINISHED GROUND FLEV		

### **ABBREVIATION**

TYP TYPICAL

TW TOP OF WALL ELEVATION

W DOMESTIC WATER LINE

WM WATER METER

1 FLOW REDUCTION BOX, RIM=100.3

INV=97.8 SEE DETAIL 3/C.2 2 SUMP PUMP, SEE DETAIL 9/C.2, GR=89.40 PUMP ON=88.40 PUMP OFF=86.40, SEE 6/C.2

3 STABILIZE DISCHARGE AREA W/ DRAIN ROCK (2'X4') FOR EROSION CONTROL 4 MAINTAIN STABILIZED CONSTRUCTION

ENTRANCE AREA. SEE DETAIL 2/C.2 5 MAINTAIN FIBER ROLL AROUND ENTIRE PROPERTY LINES FOR EROSION CONTROL. SEE DETAIL 1/C.2

6 DURING CONSTRUCTION ALLOW SEDIMENT-LADEN RUNOFF TO FORM PONDING AND ALLOW SEDIMENTS TO

SETTLE OUT PRIOR TO DISCHARGE 7 INFILTRATION DEVICE, 6'X8', 3' DEEP, SEE 7/C.1

8 PROVIDE AND MAINTAIN VEGETATION COVERAGE AROUND THE THE EXTEND OF THE DISTURBED AREA DURING CONSTRUCTION UNTIL PHASED GRADING ACTIVITIES


9 PERF. DRAIN PIPE AROUND BASEMENT WALL. SEE STRUCTURAL PLAN FOR DRAIN PIPE PLACEMENT. CONNECT TO LIGHTWALL SUMP PUMP

PROPERTY LINE -----PERF PVC SD LINE — — — — — SOLID PVC SD LINE -----GRADE BREAK \_\_\_\_\_

NOTE: CONTRACTOR TO DETERMINE TOP OF BASEMENT RETAINING WALL (MIN 8" ABOVE PROPOSED OUTSIDE GRADE.) SEE STRUCTURAL PLAN FOR BASEMENT WALL DETAILS. COORDINATE WITH WATER PROOFING CONSULTANT

FEATURE	RIM	INV
AD1	100.9	99.7
AD2	100.9	99.6
AD3	100.9	99.5
AD4	100.9	99.4
AD5	100.9	99.3
AD6	100.5	99.2
POP-UP1	100.3	98.8
AD7	100.9	99.7
AD8	100.9	99.6
AD9	100.9	99.5
AD10	100.7	99.4
AD11	100.6	99.3
AD12	100.3	99.2
AD13	100.3	99.1
POP-UP2	100.0	98.5
AD14	89.47	NOTE1
AD15	89.47	NOTE1


NOTE1: INV TO BE DETERMINED IN THE FIELD BASED ON WATER PROOFING CONTRACTOR RECOMMENDATION

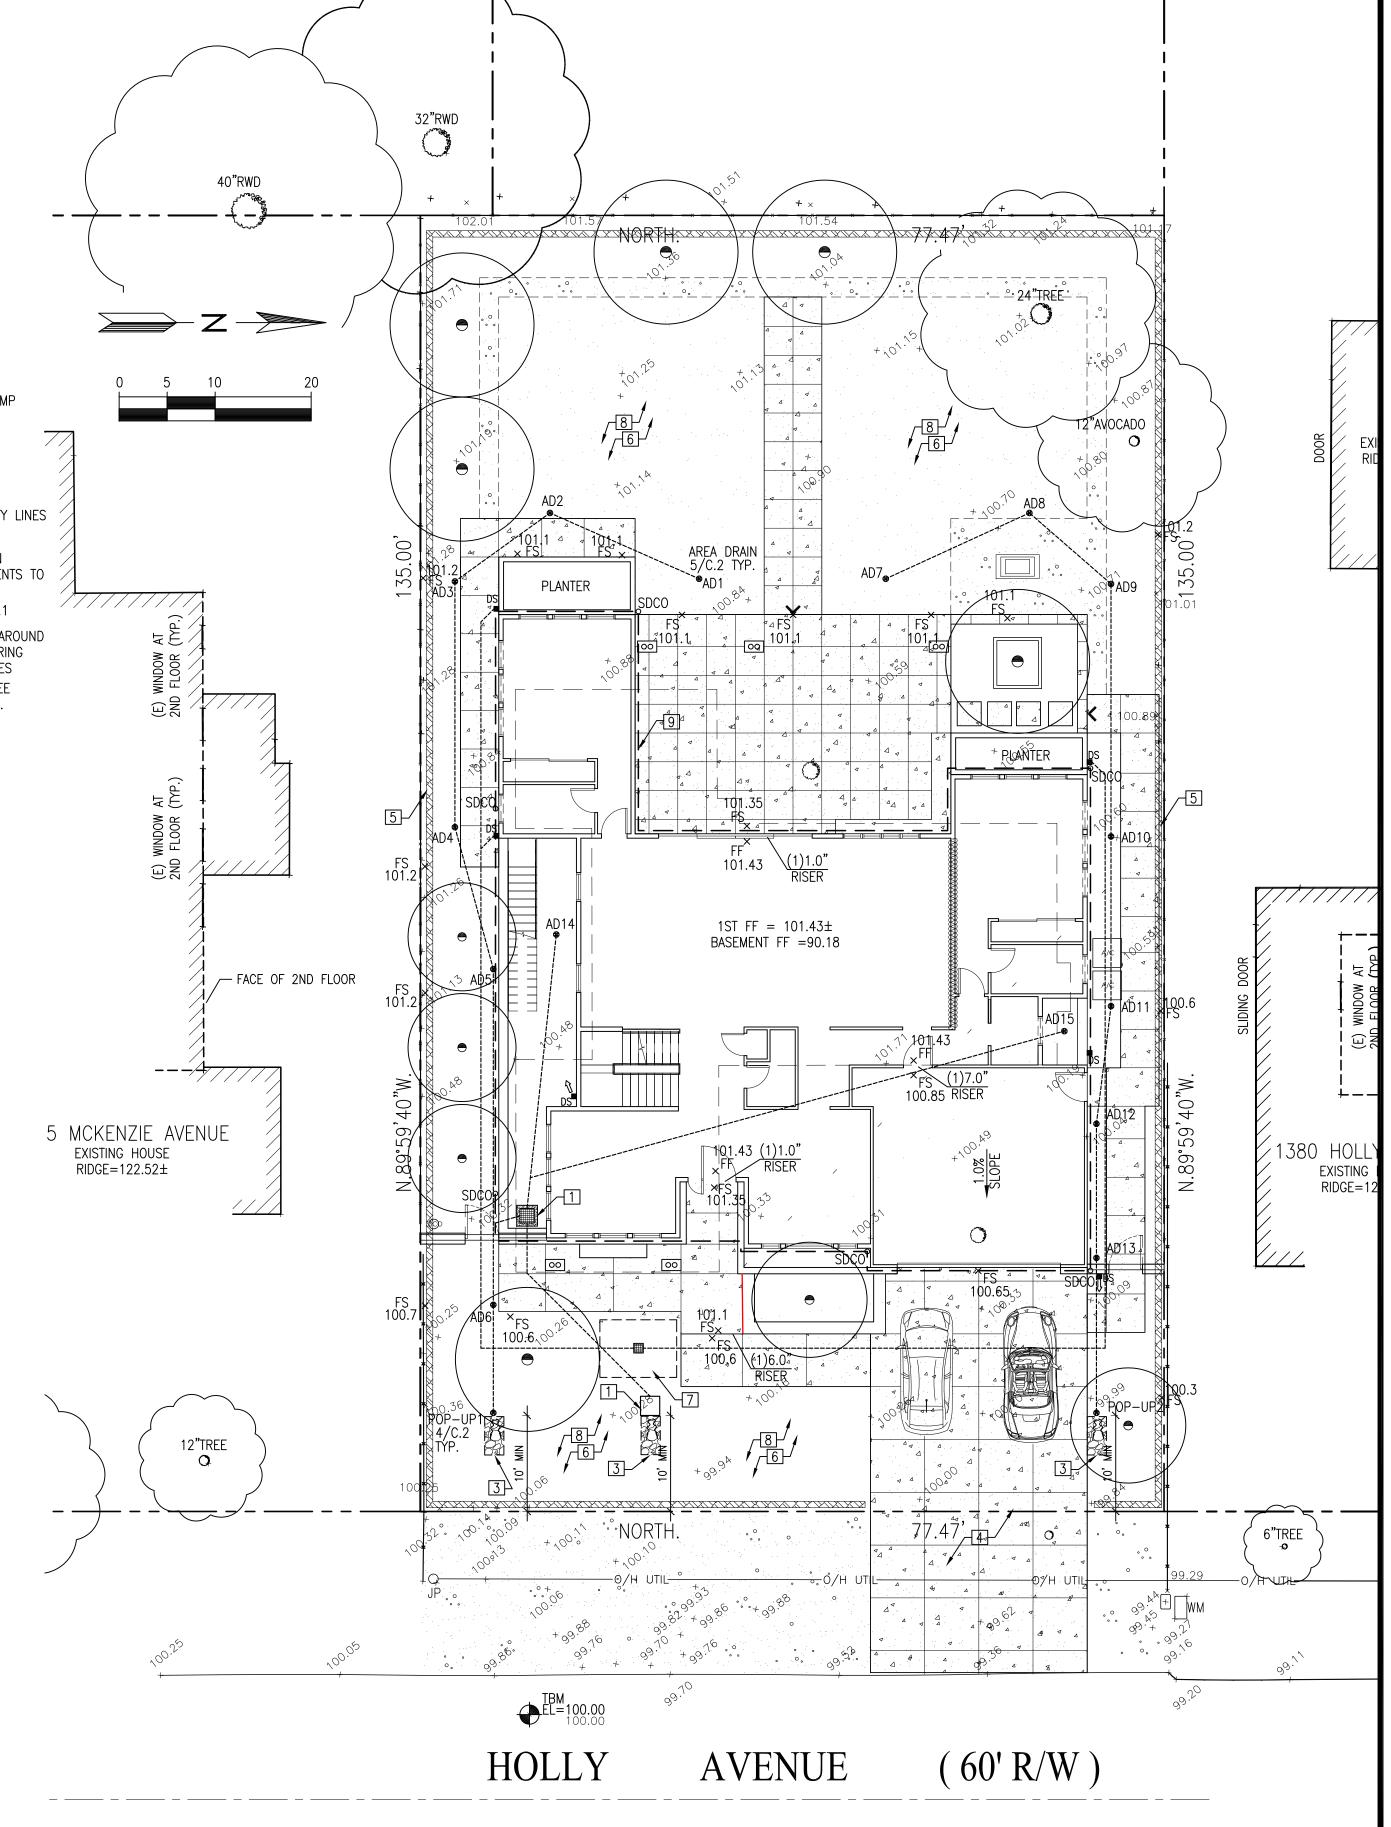

CAO

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## & ASSOCIATES

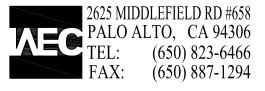

LICENSE STAMPS AND SIGNATURE




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DAT	E: SEPT 12, 2017	
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DRA		
JOB:	10078	

SHEET TITLE:

GRADING AND DRAINAGE & **EROSION** CONTROL PLAN

SHEET NO.

GRADING AND DRAINAGE PLAN & EROSION CONTROL PLAN SCALE: 1"=10" **GENERAL NOTES** 

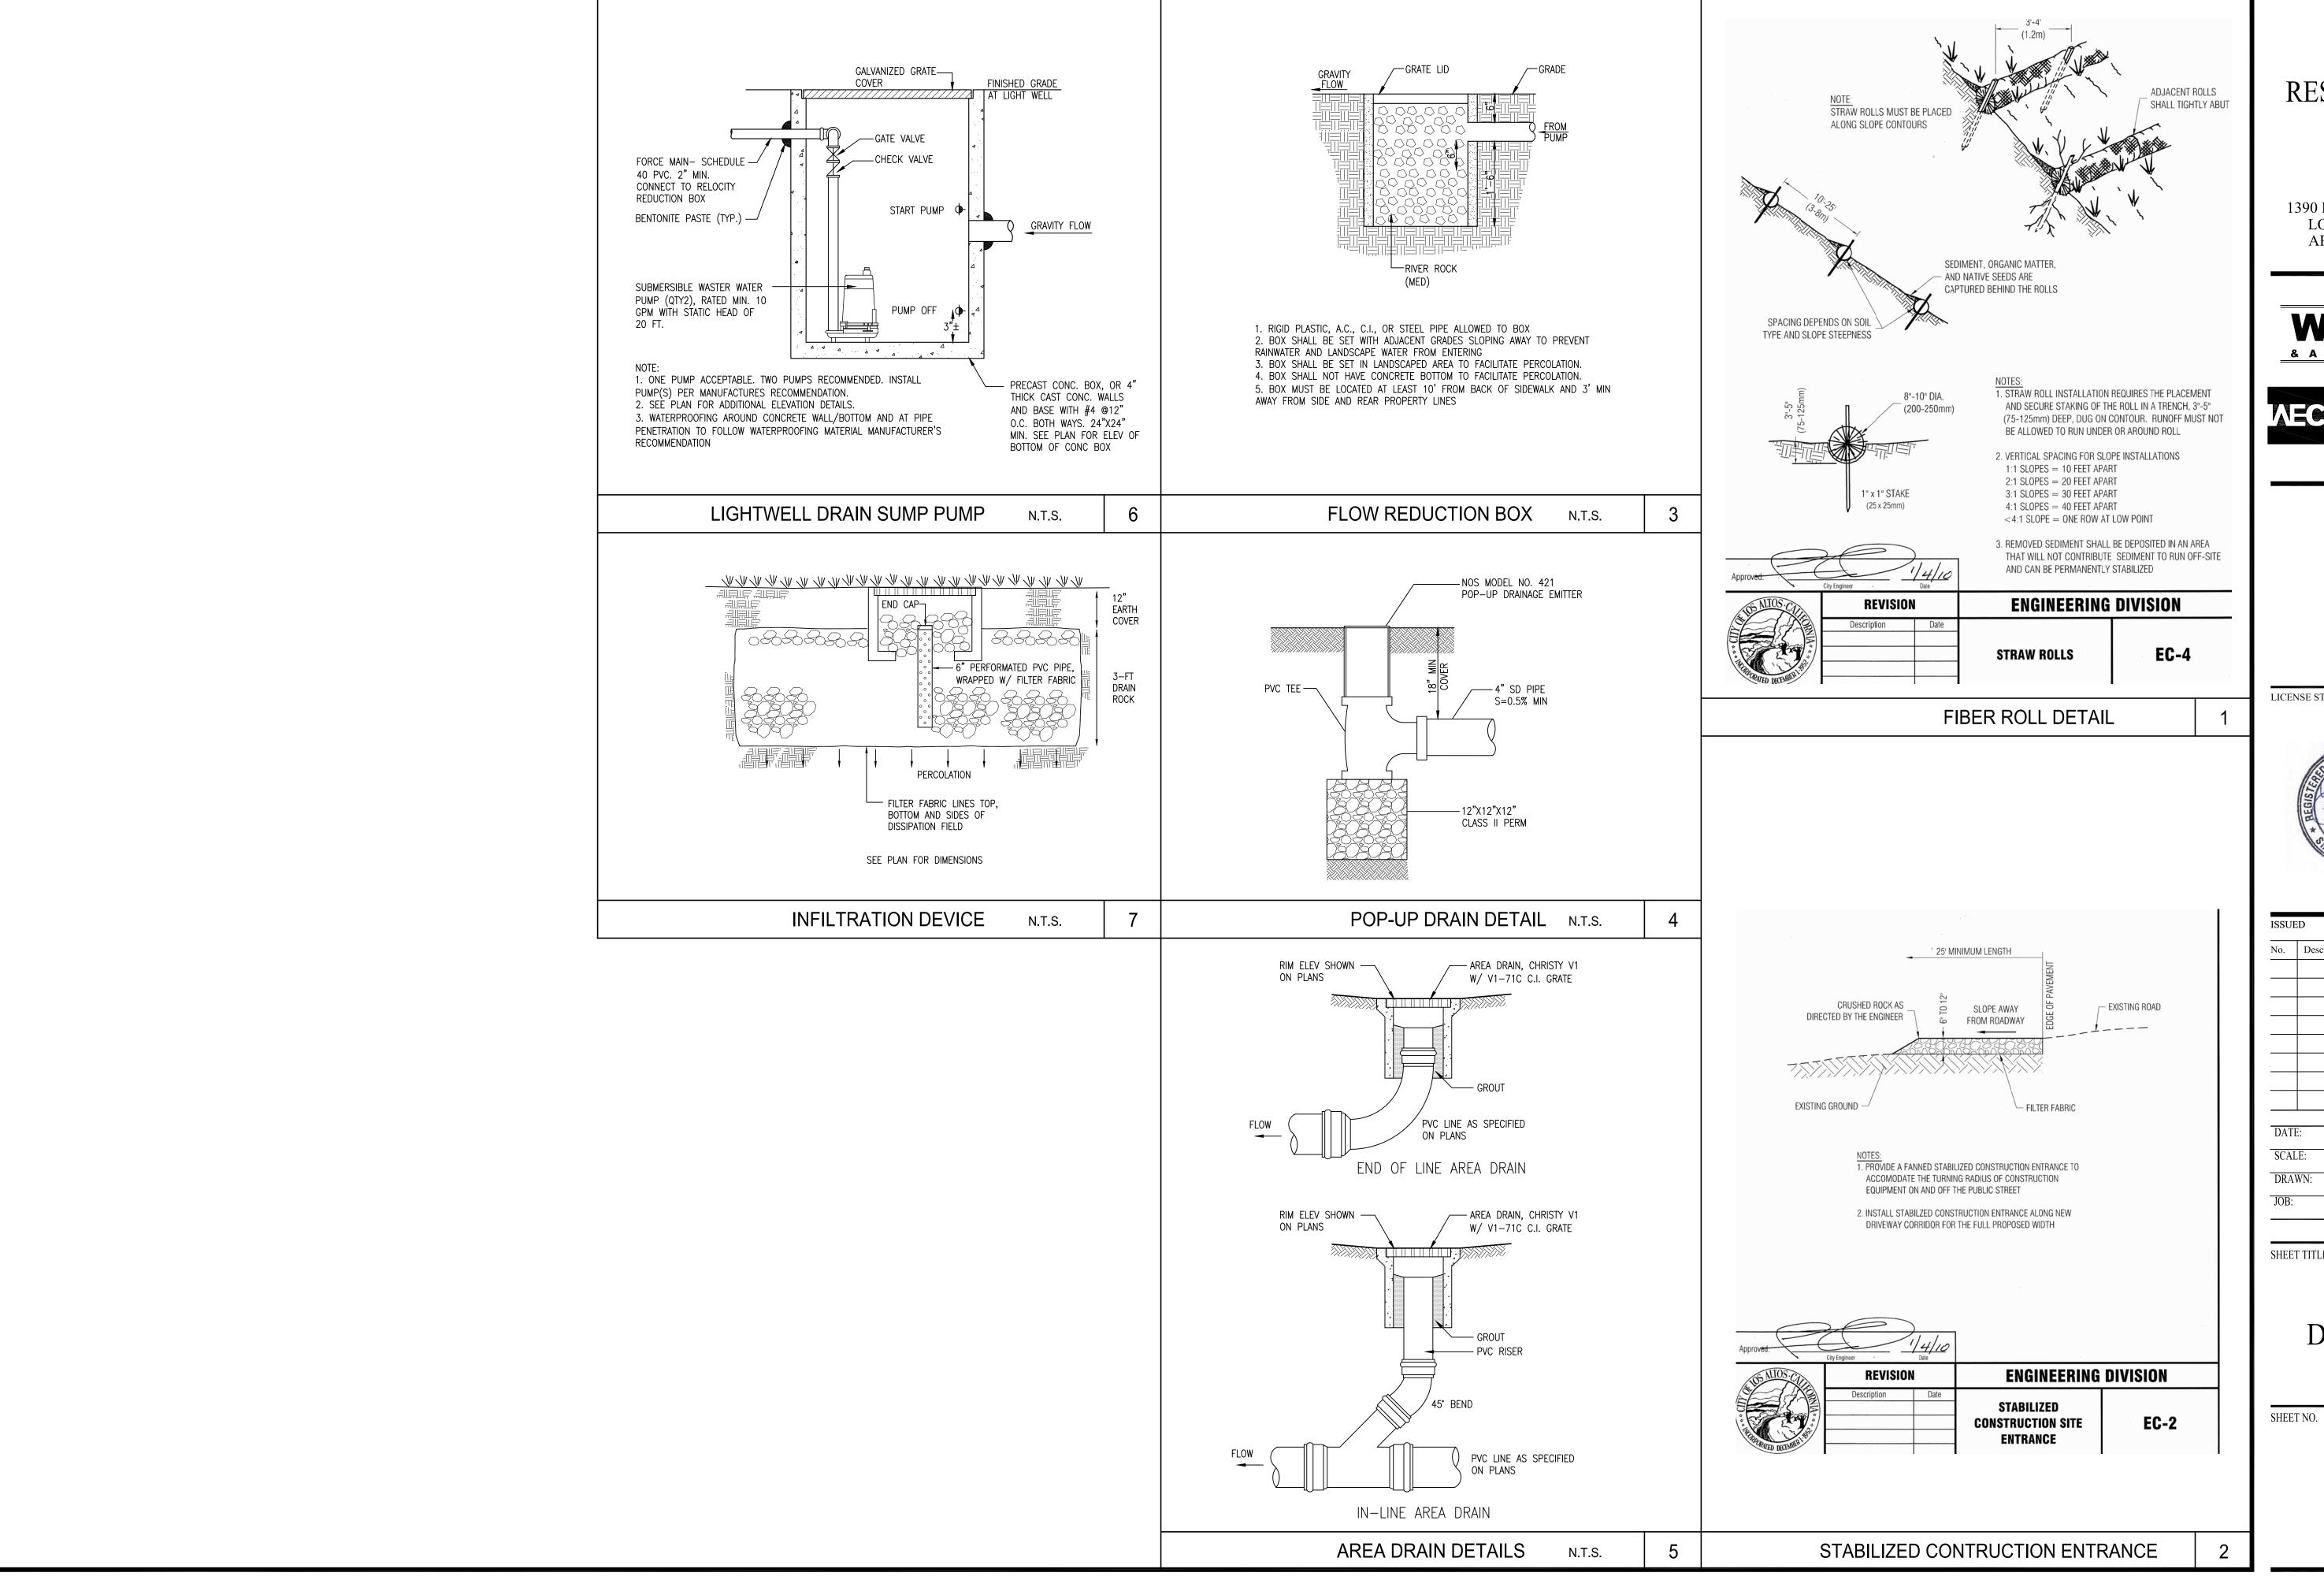

CAO

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& ASSOCIATES




LICENSE STAMPS AND SIGNATURE



No.	Description	Dat
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JOB:	10078	
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**DETAILS** 




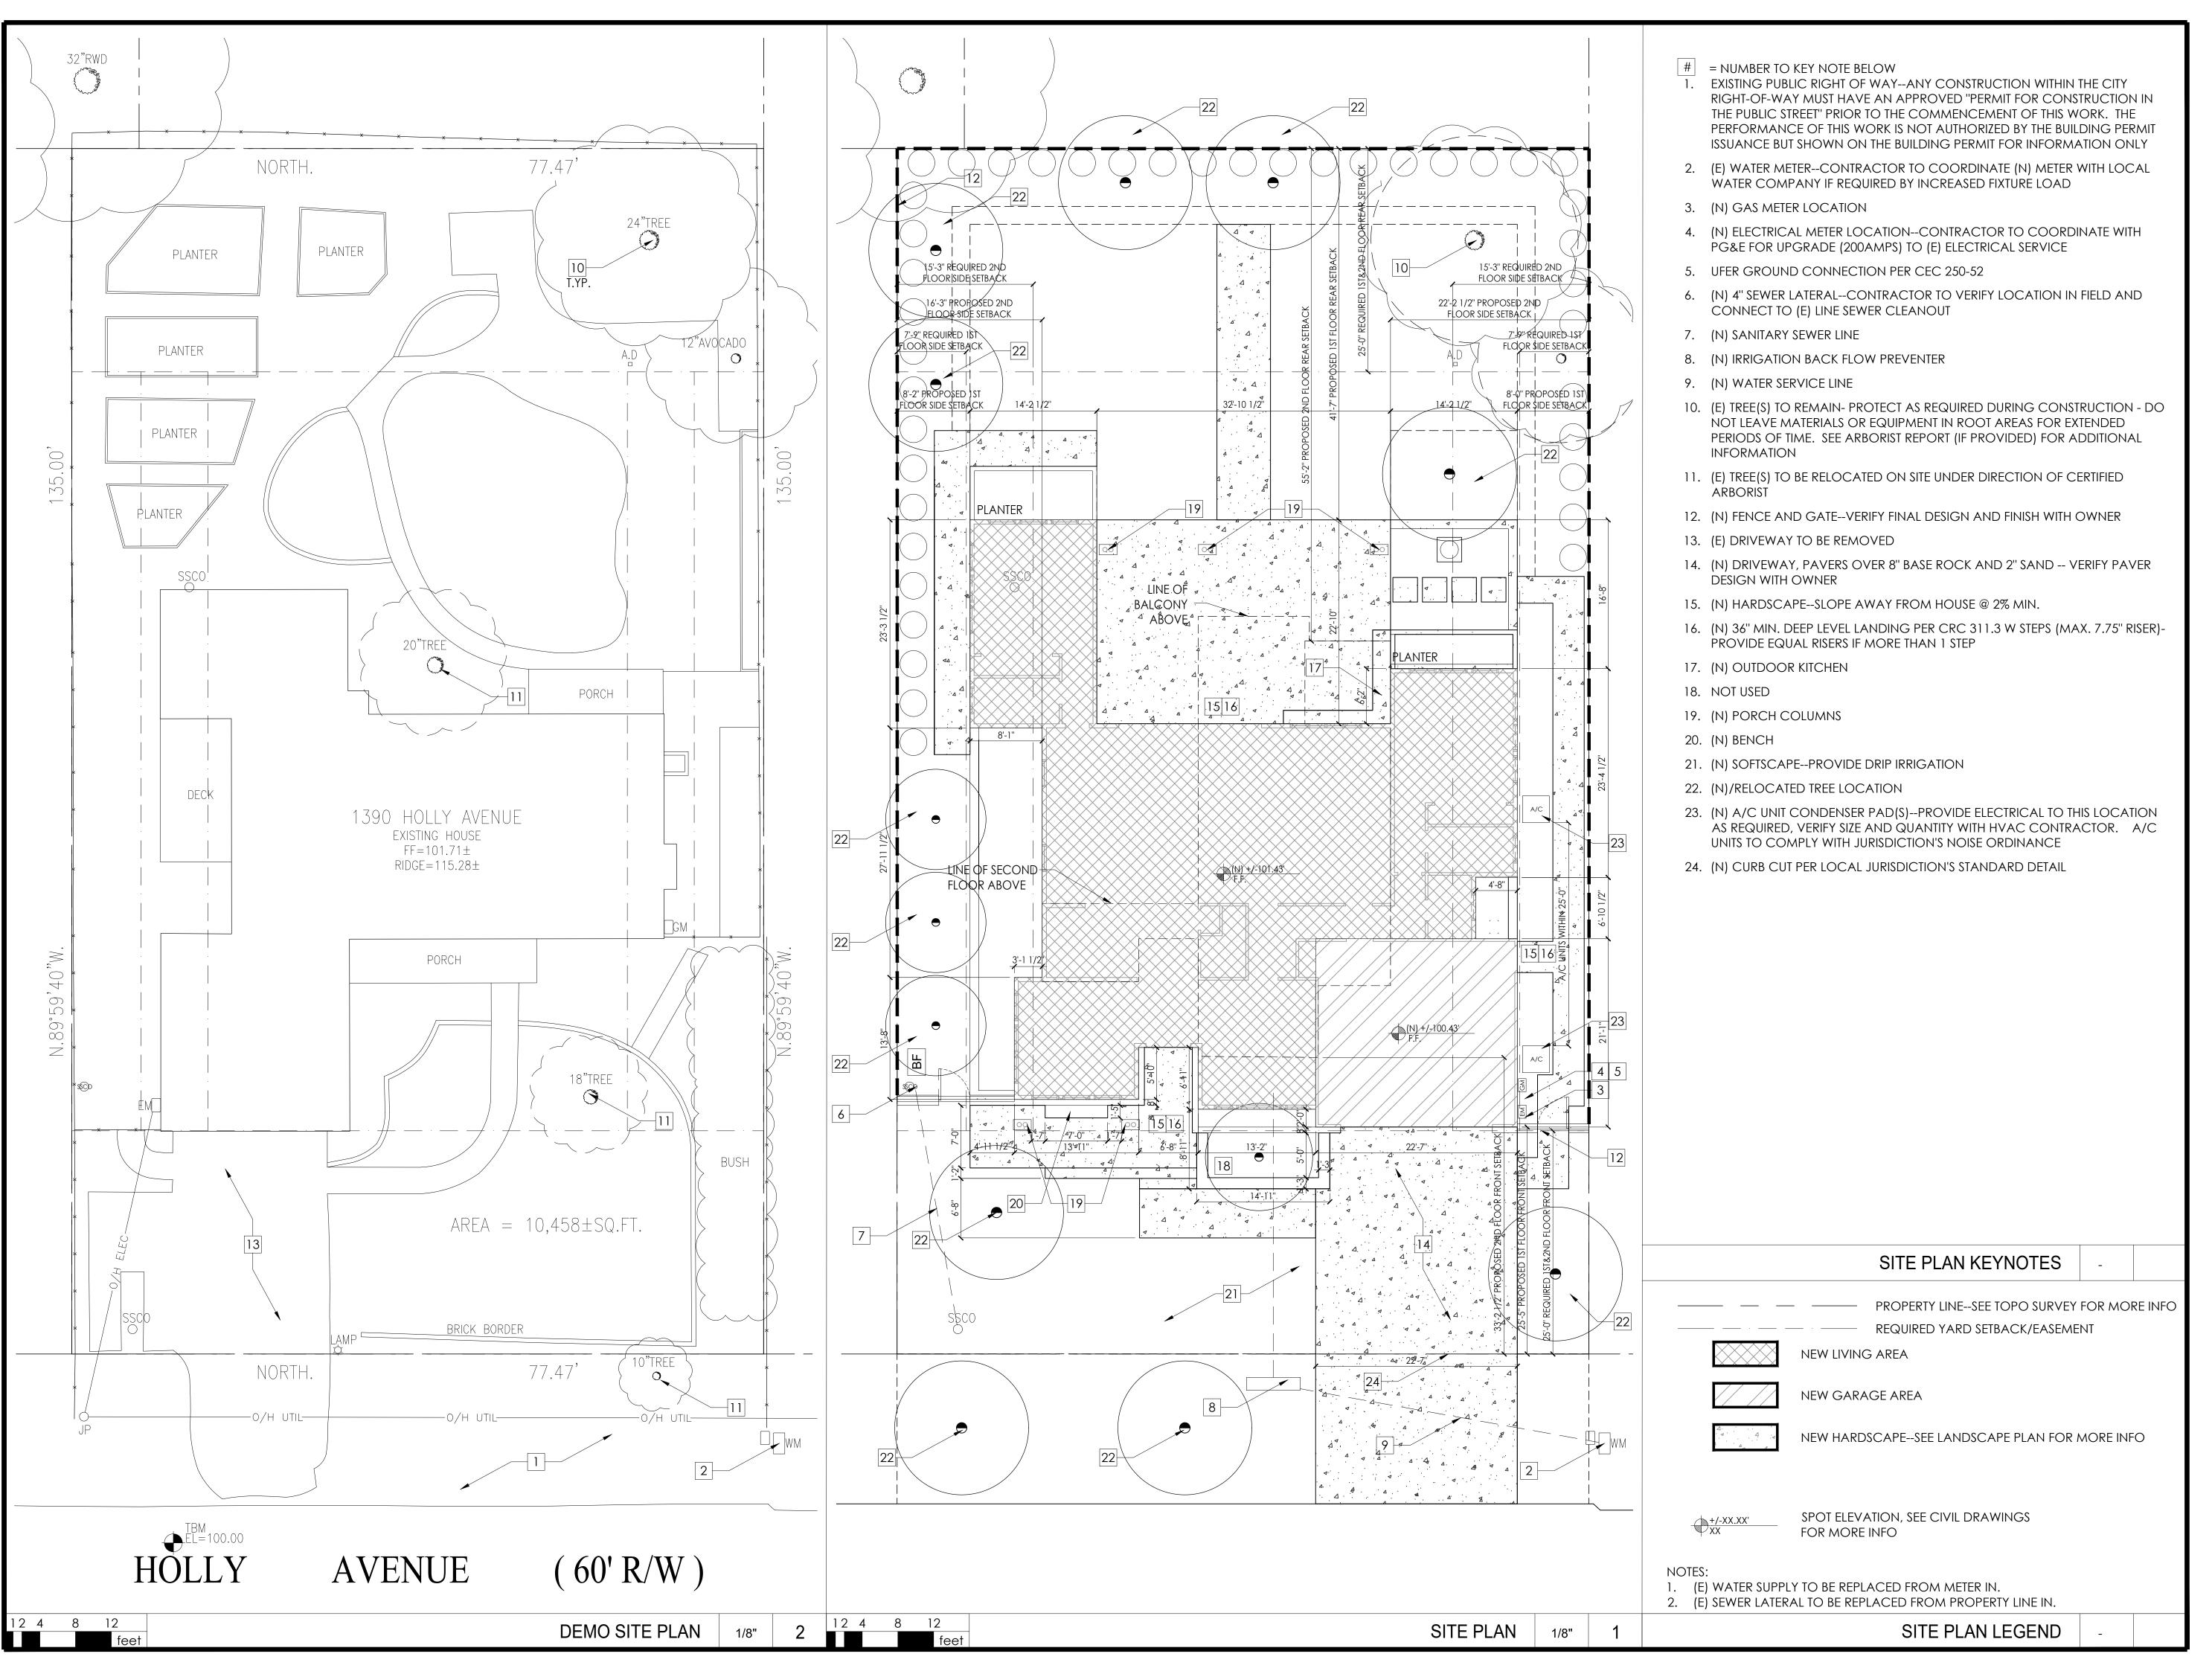

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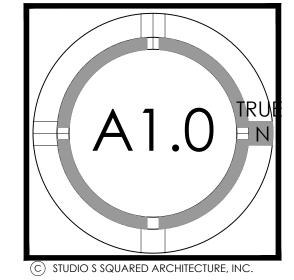
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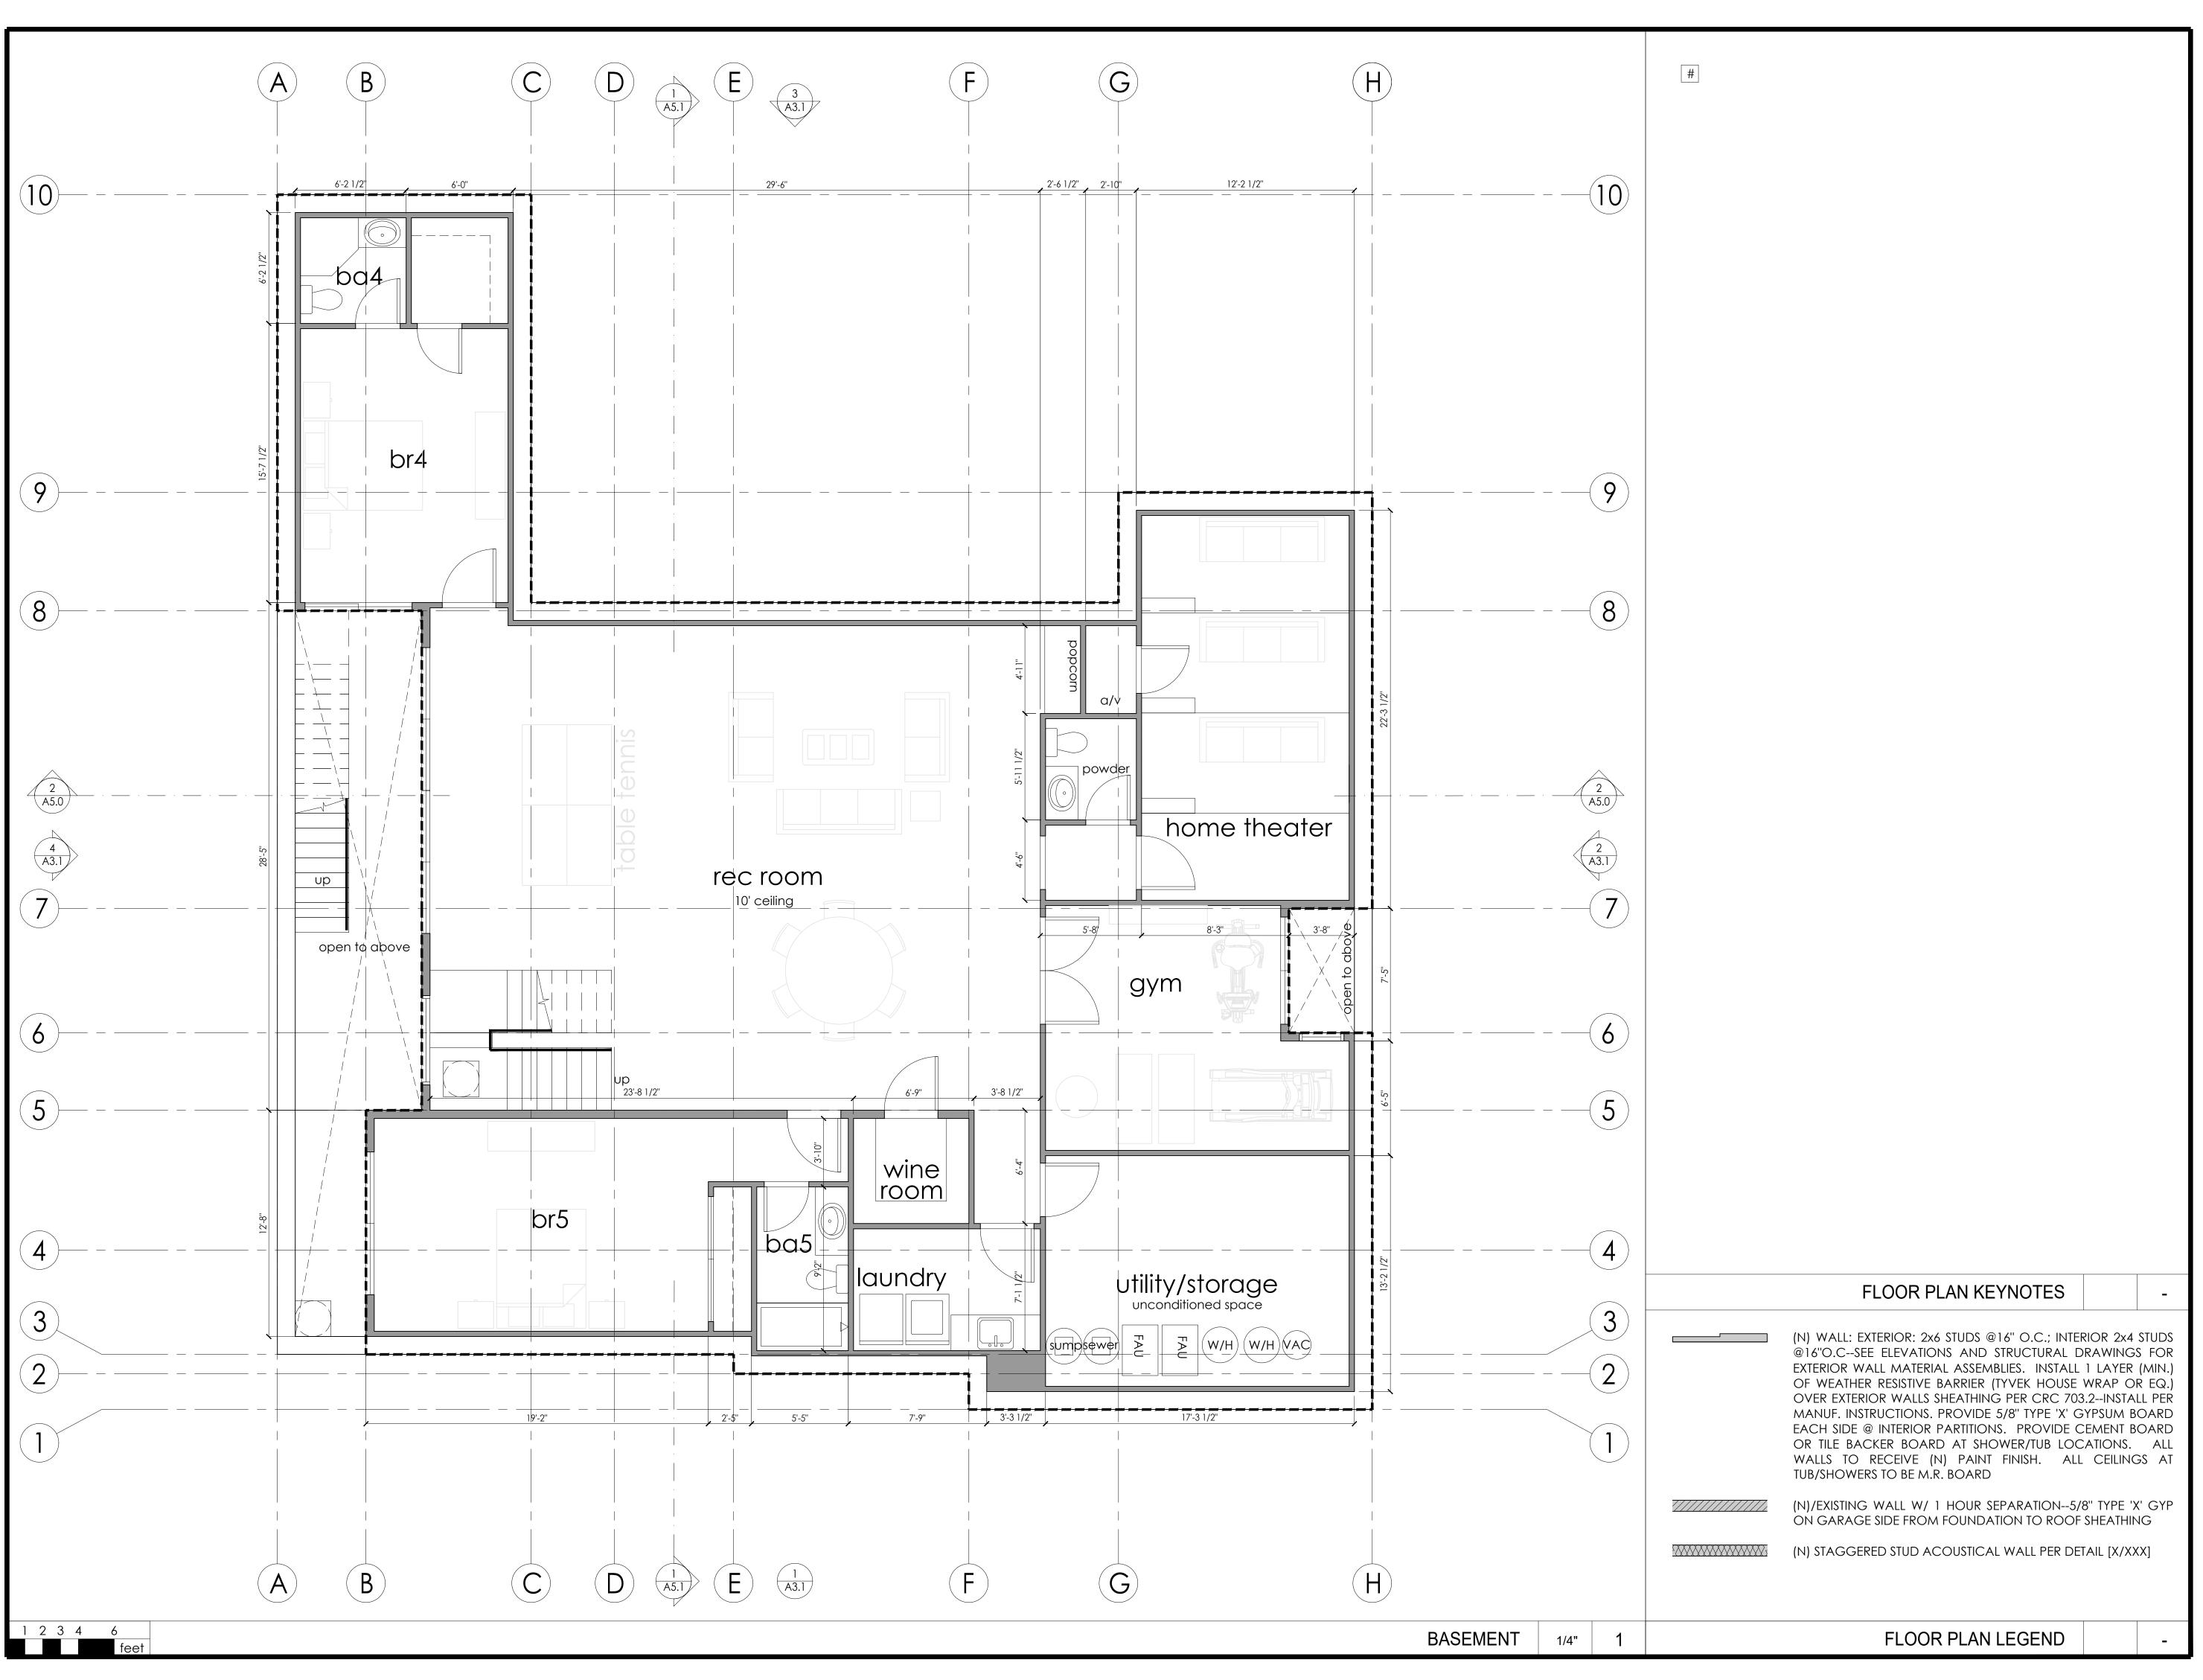
CAO RESIDENCE
NEW SINGLE FAMILY RESIDENCE
OLLY AVENUE, LOS ALTO



PROJECT NO.			17-008
REVISION	DATE	DESCRIPTION	DRAWN BY
	09.30.2017	09.30.2017 PLANNING PERMIT SUBMITTAL	>
	12.04.2017	12.04.2017 PLANNING PERMIT RESUBMITTAL IV	<u>&gt;</u>

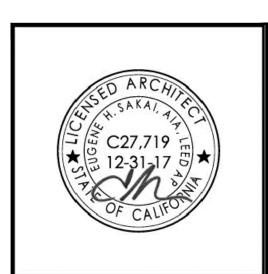SITE PLAN & DEMO SITE PLAN








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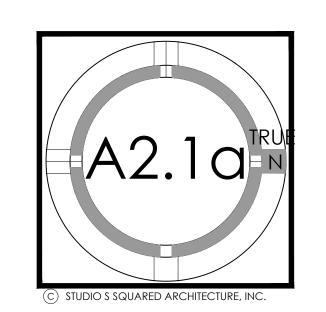
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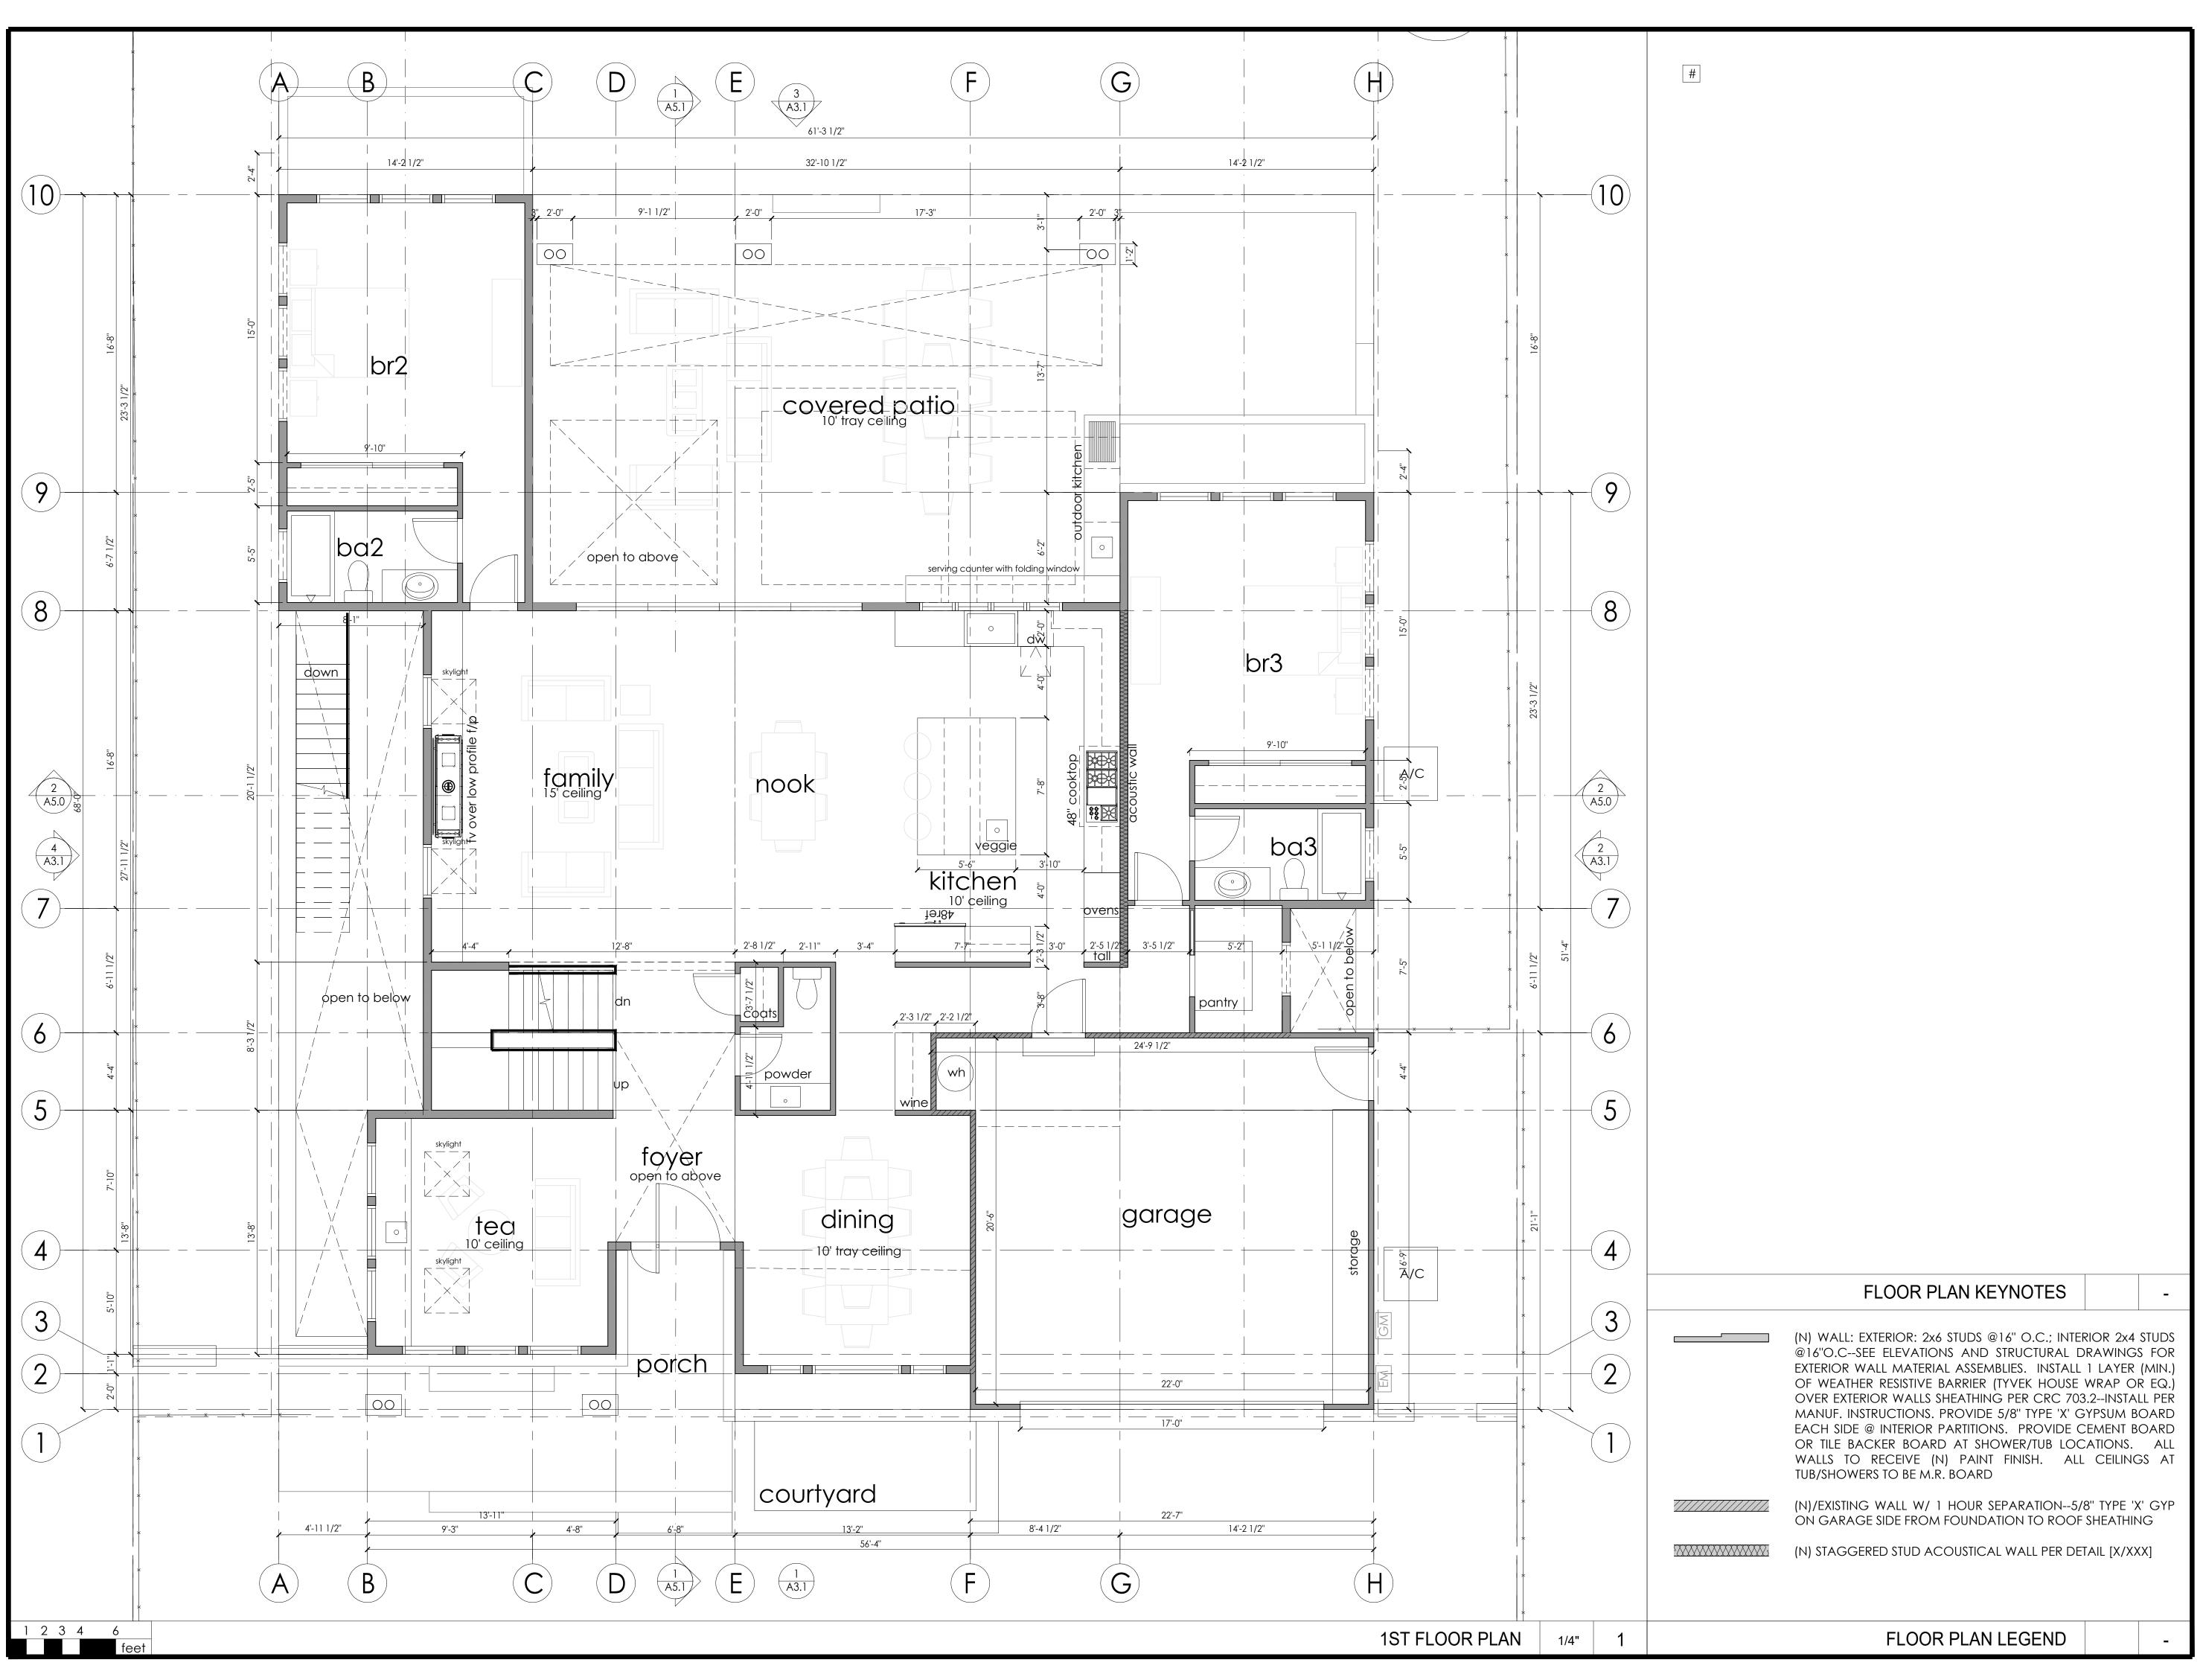
HOLLY AVENUE, LOS ALTOS, CA



PROJECT NO.	.0		17-008
REVISION	DATE	DESCRIPTION	DRAWN BY
	09.30.2017	09.30.2017 PLANNING PERMIT SUBMITTAL	<u>&gt;</u>
	12.04.2017	12.04.2017 PLANNING PERMIT RESUBMITTAL IV	<u>&gt;</u>

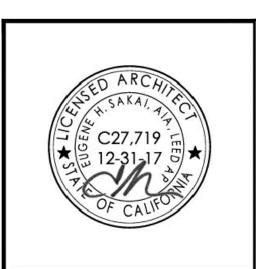BASEMENT







CAO RESIDENCE

NEW SINGLE FAMILY RESIDENCE


OLLY AVENUE, LOS ALTOS, CA




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	09.30.2017	09.30.2017 PLANNING PERMIT SUBMITTAL	<u>&gt;</u>
	12.04.2017	12.04.2017 PLANNING PERMIT RESUBMITTAL IV	<u>&gt;</u>

1ST


FLOOR PLAN

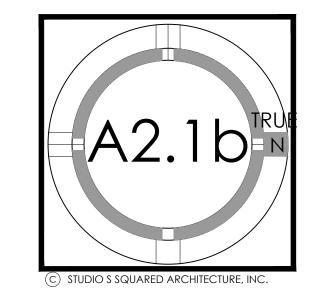

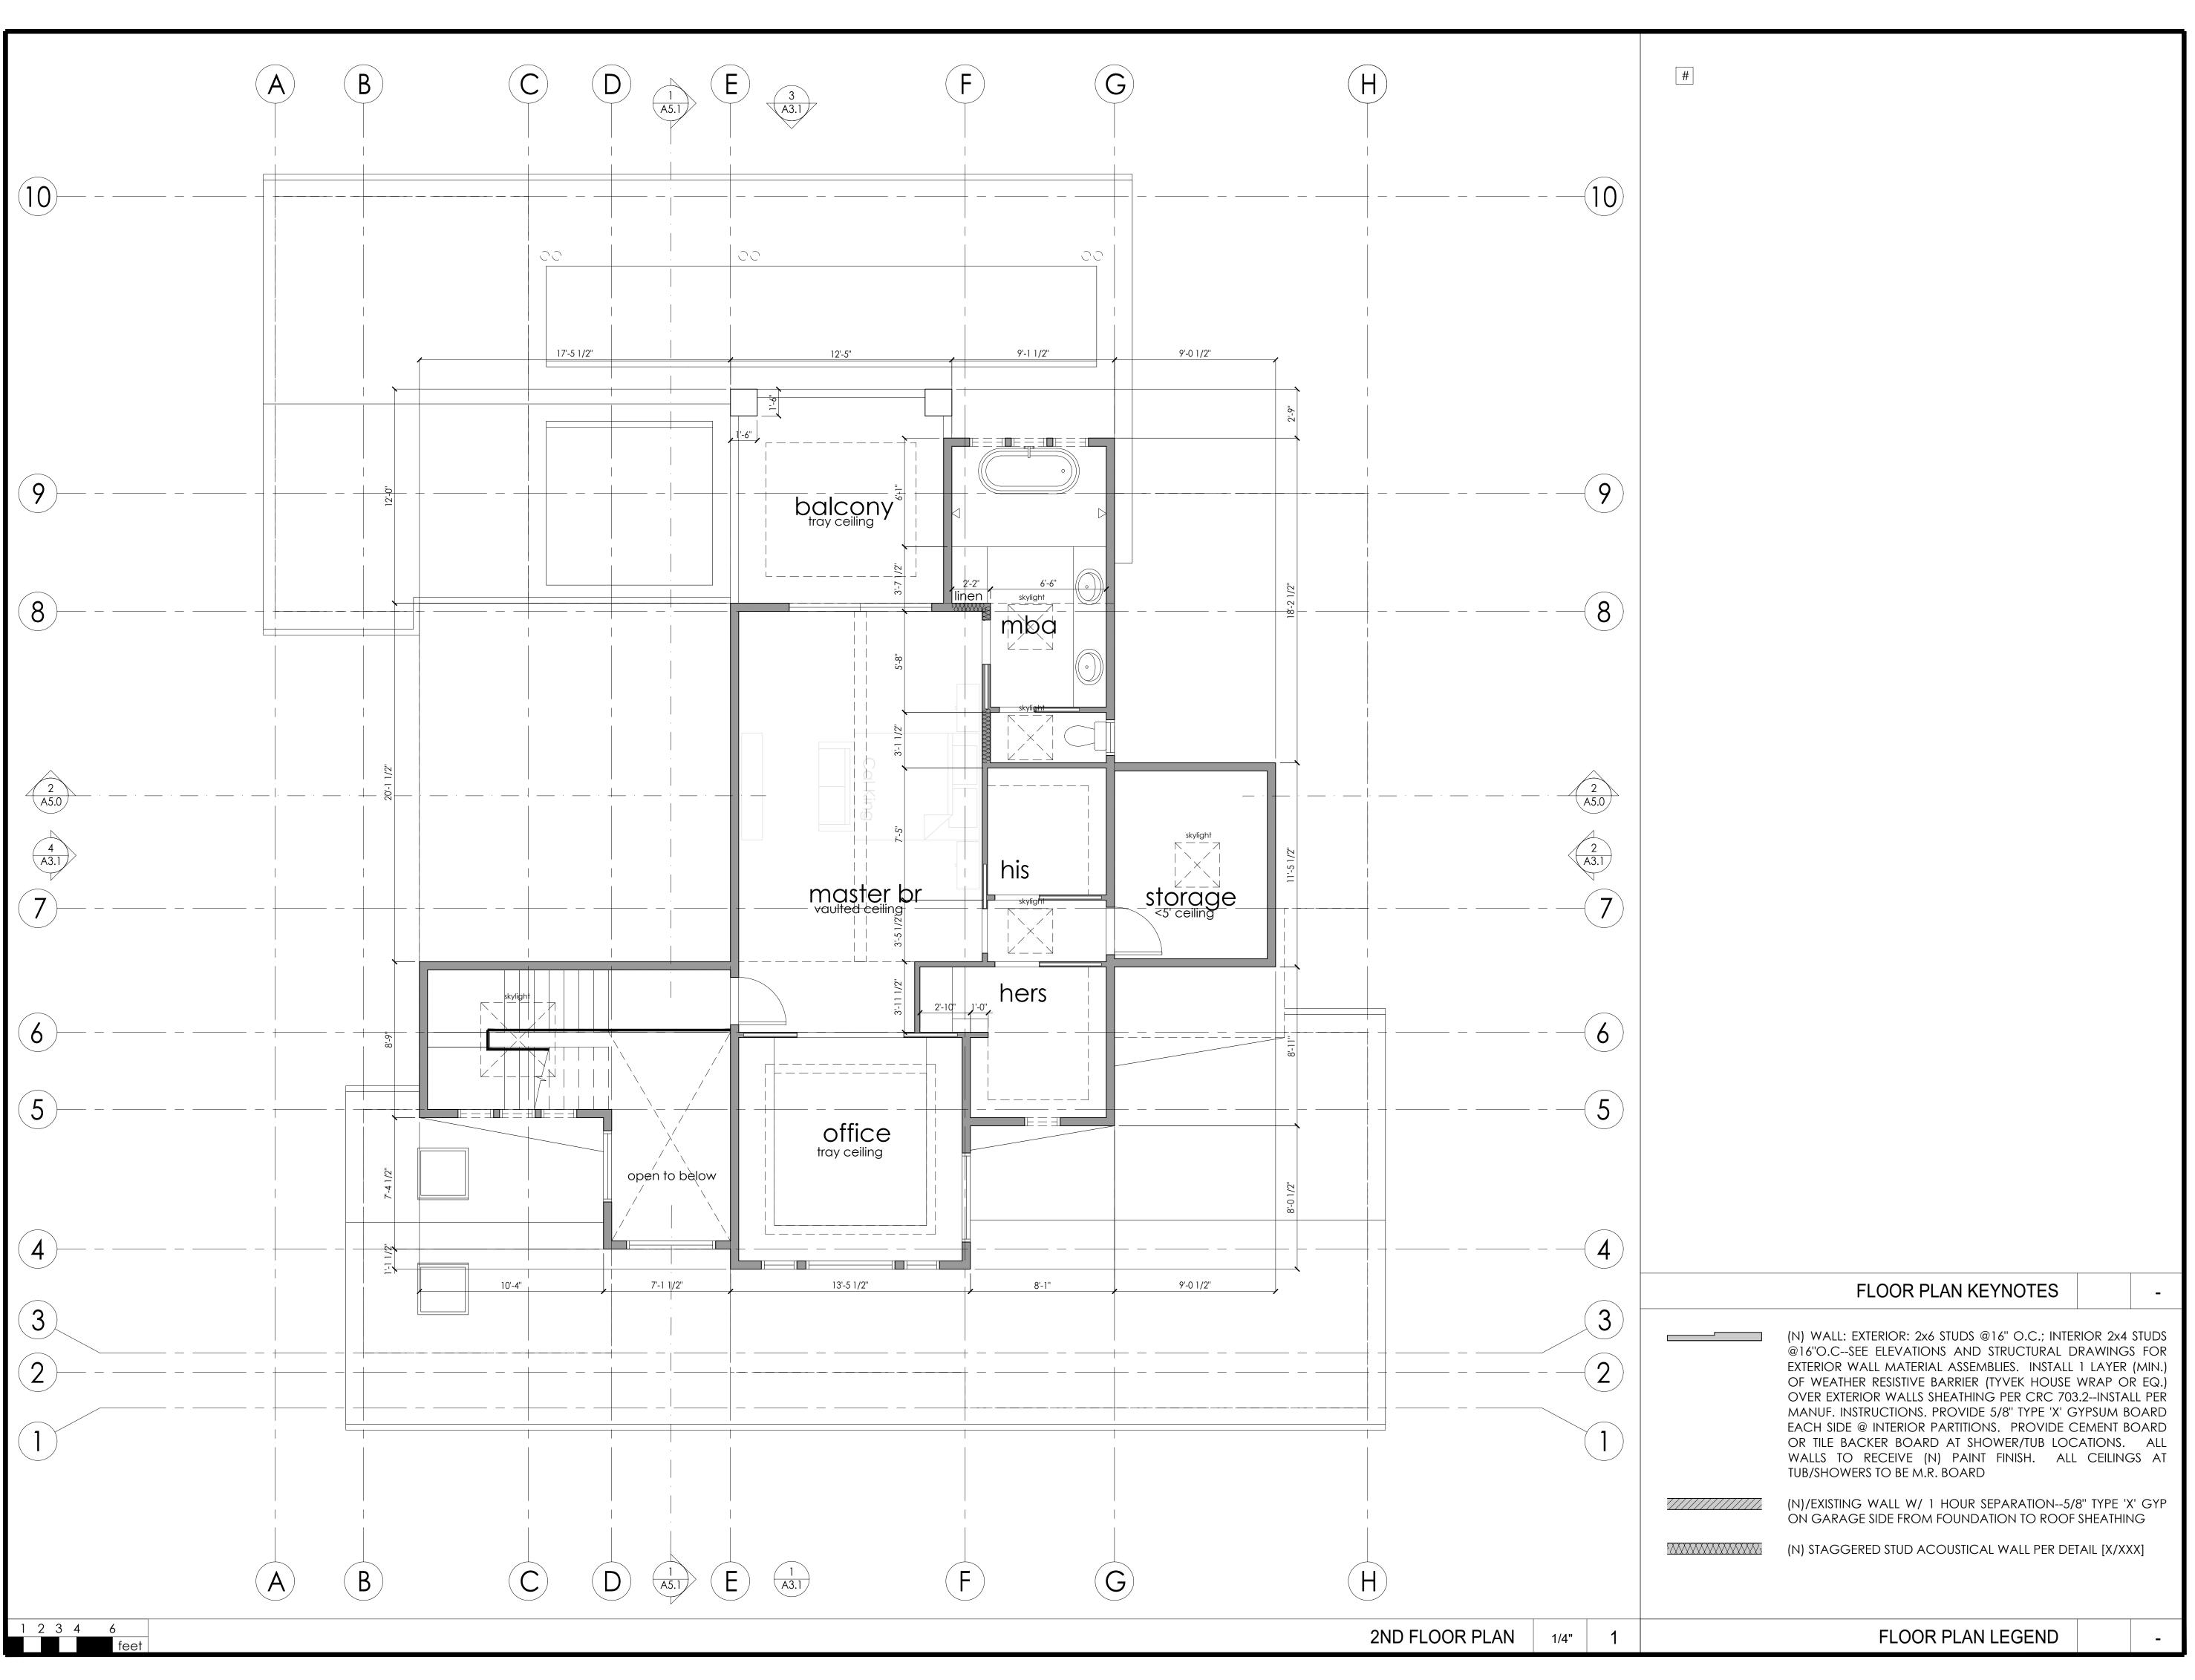




CAO RESIDENCE
NEW SINGLE FAMILY RESIDENCE
OLLY AVENUE, LOS ALTOS, CA

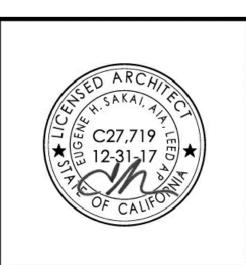


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	12.04.2017	12.04.2017 PLANNING PERMIT RESUBMITTAL IV	<u>&gt;</u>

2ND

FLOOR PLAN

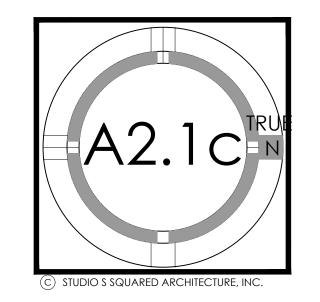

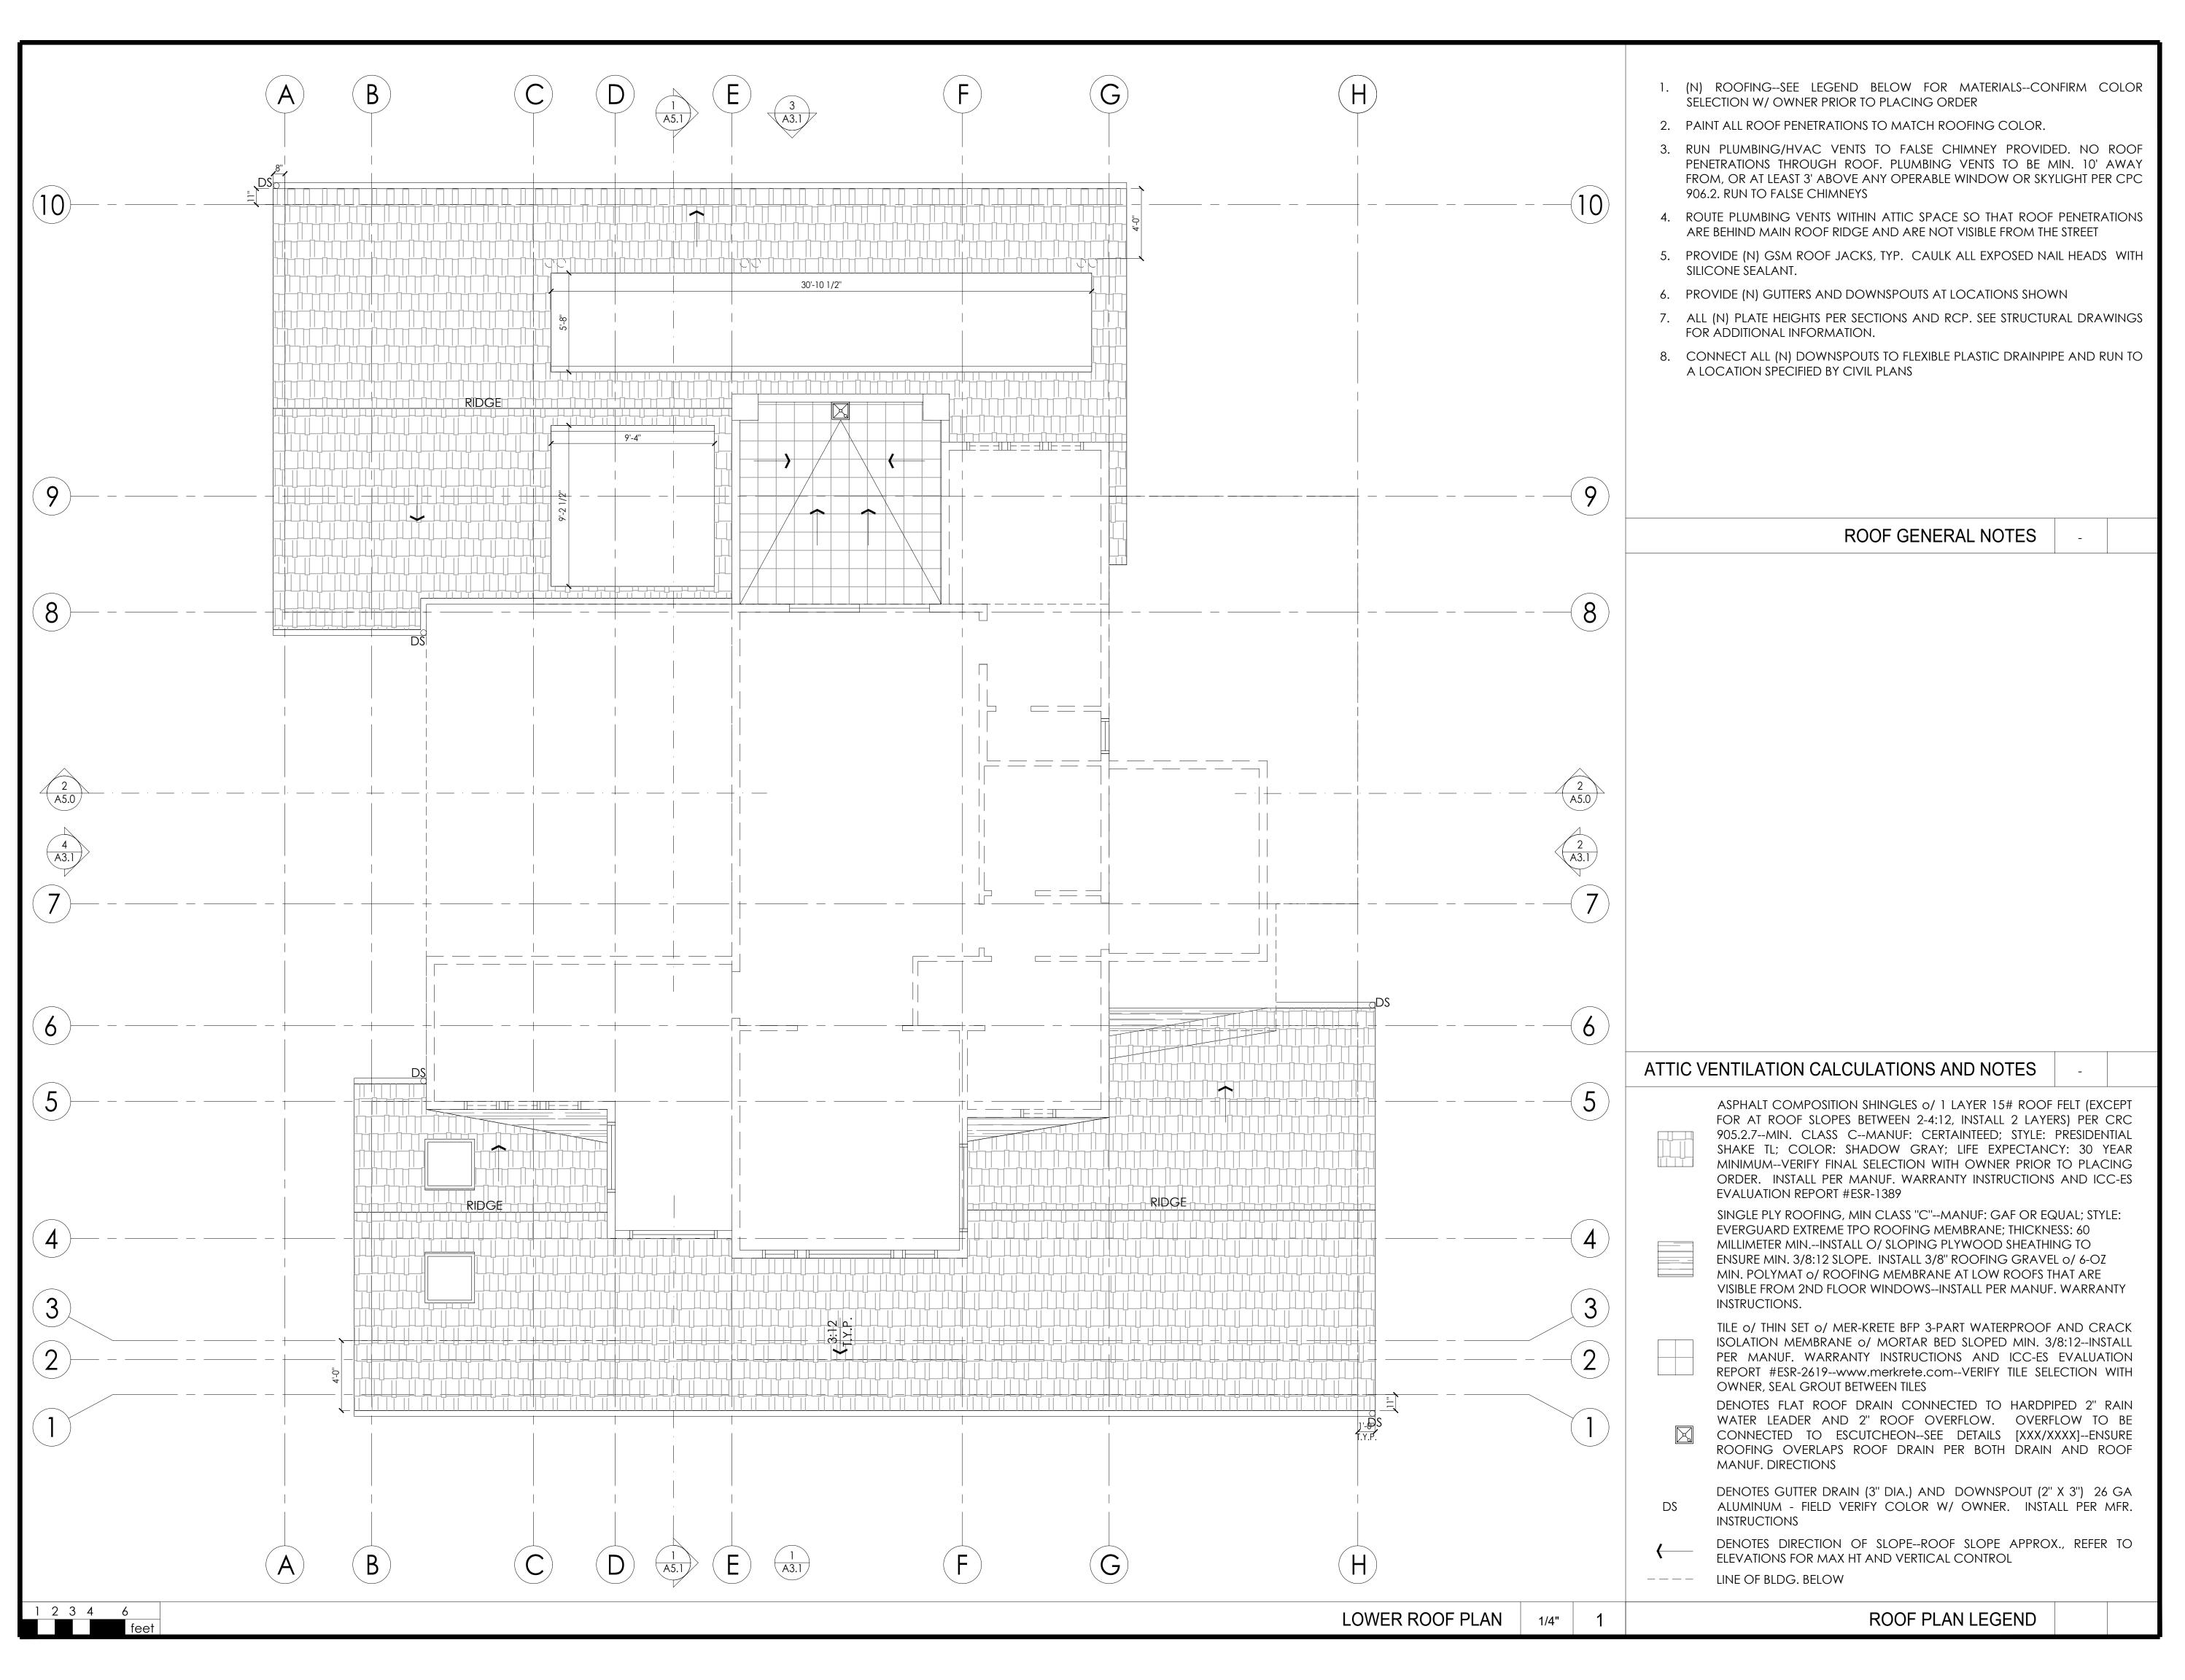




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F: (408) 404 - 0144


RESIDENCE LOS


AVENUE,

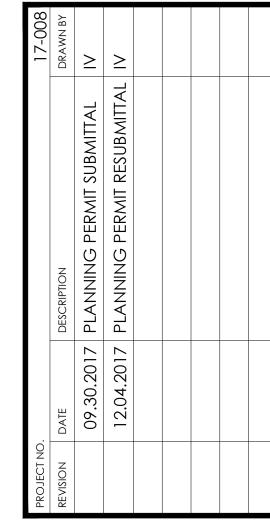

LOWER

**ROOF PLAN** 

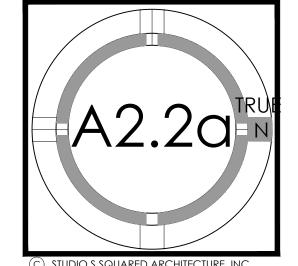

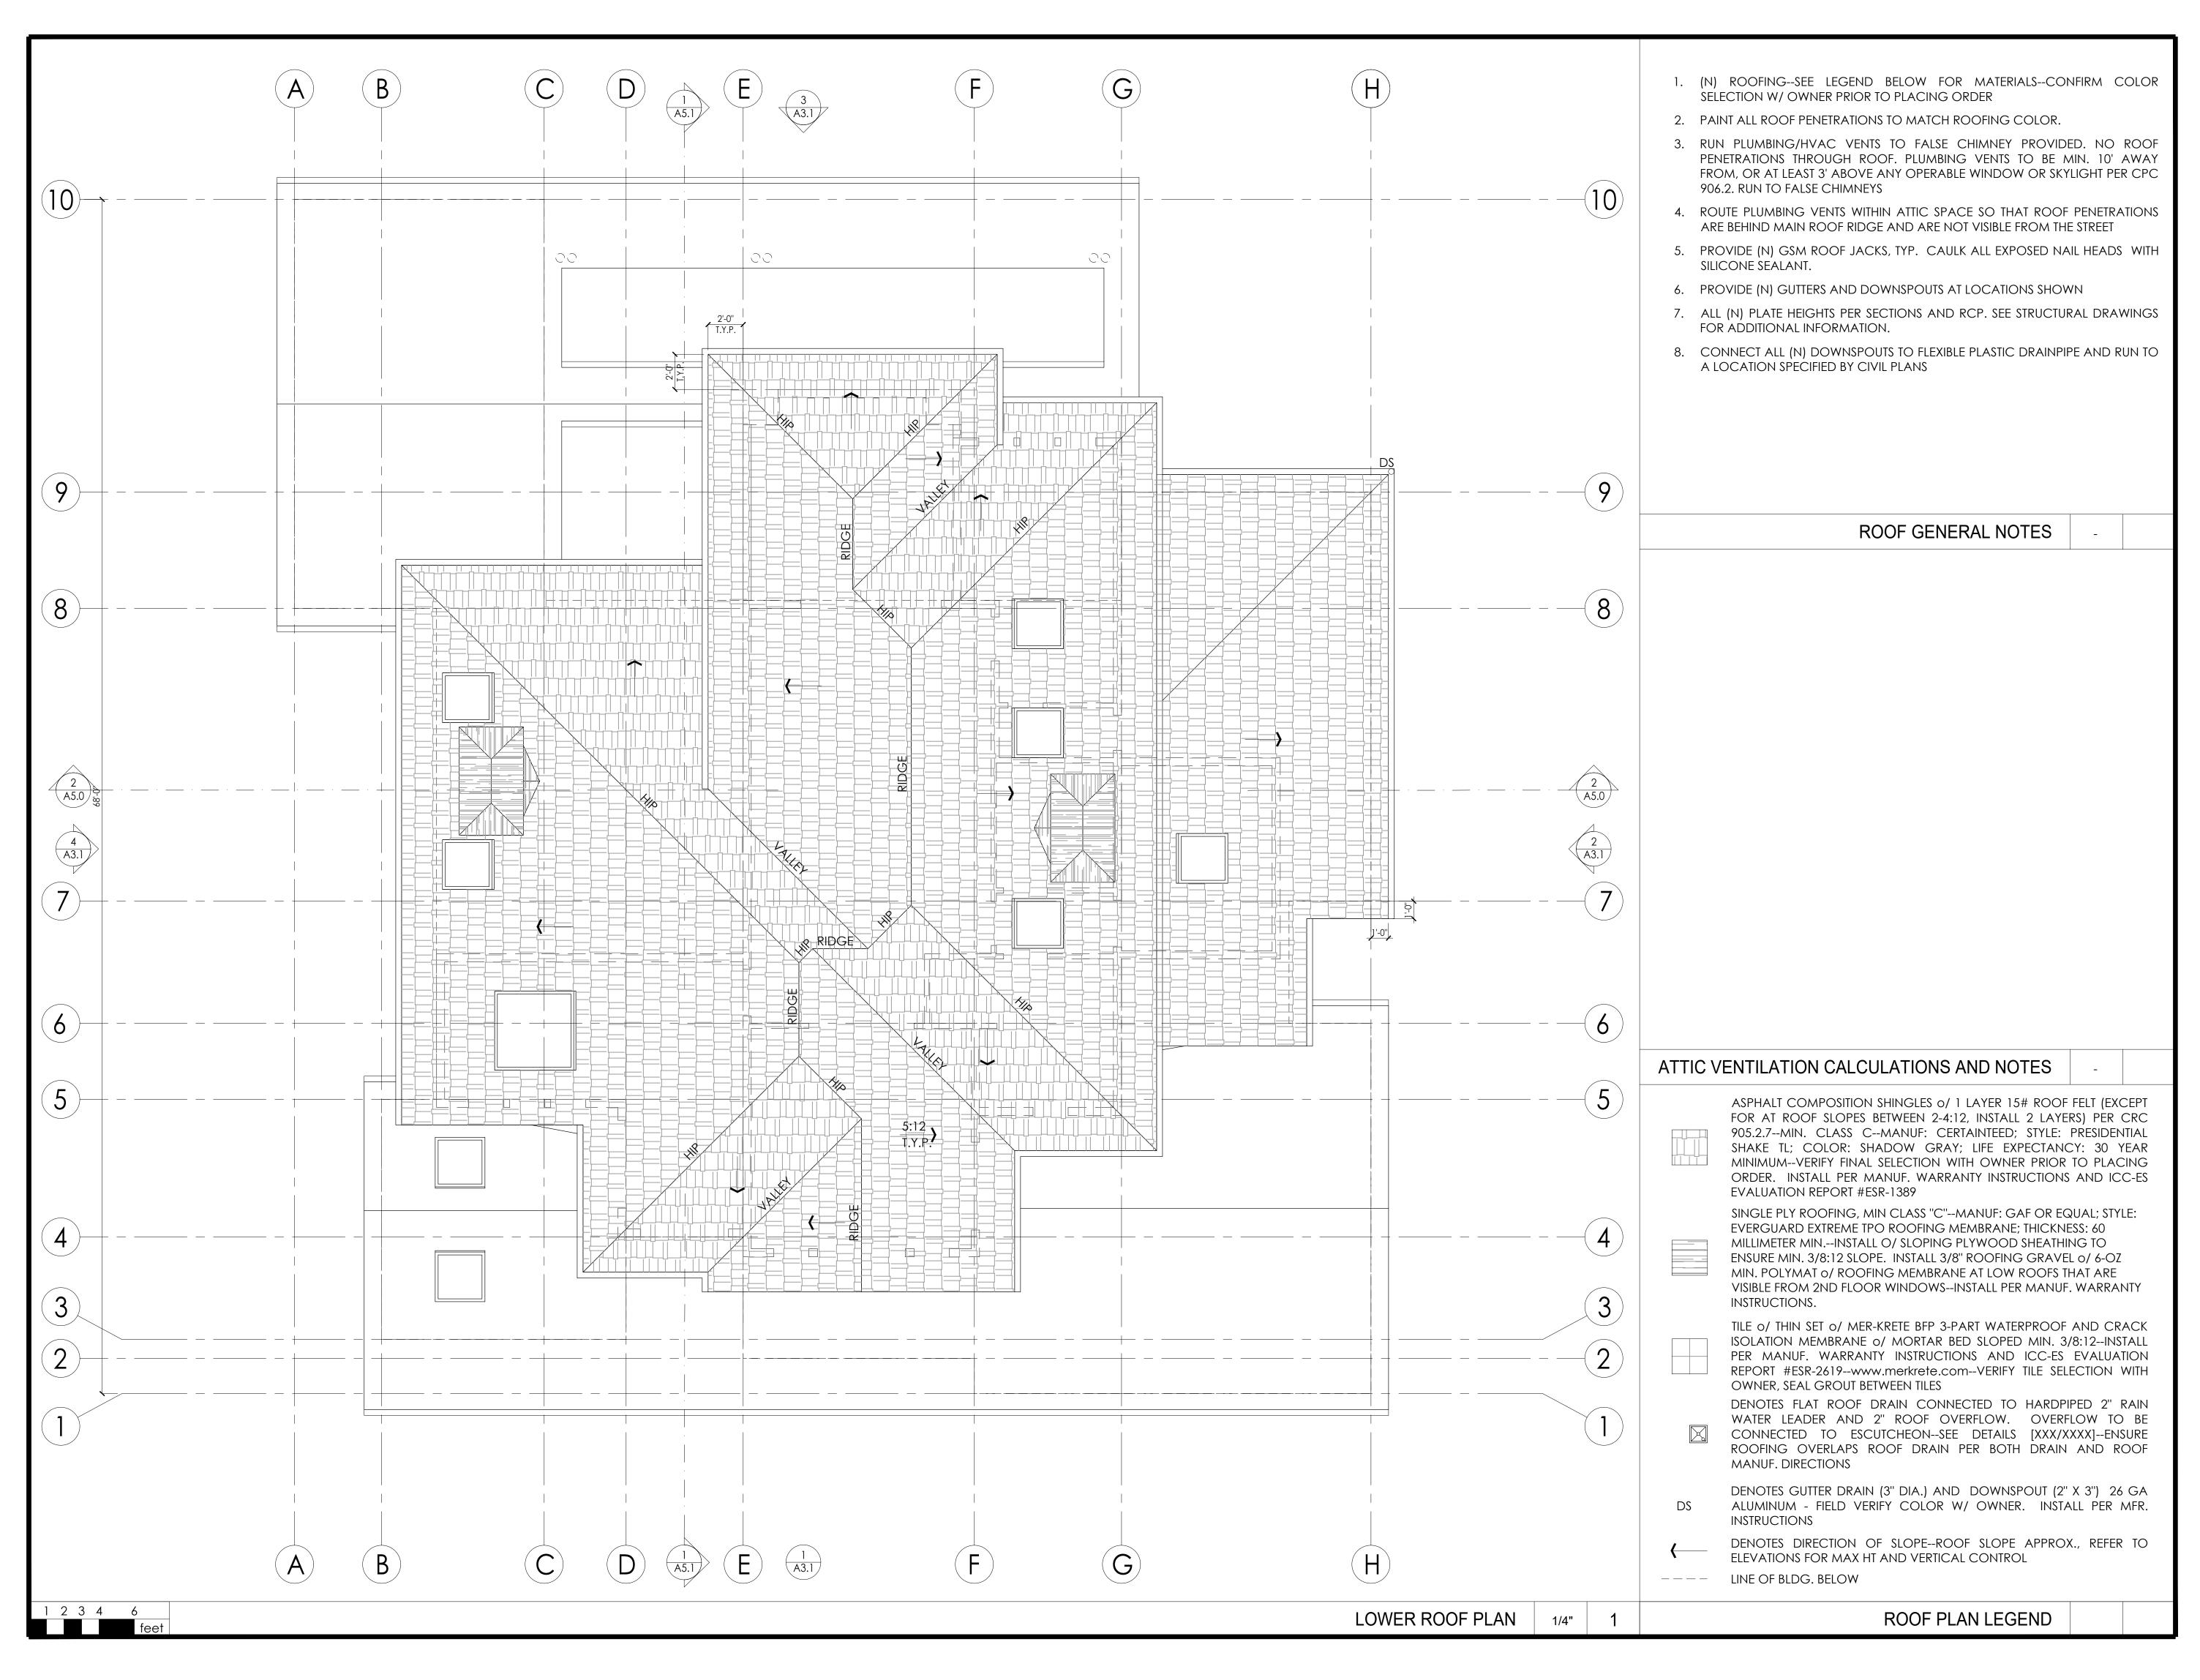




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CAO RESIDENCE

NEW SINGLE FAMILY RESIDENCE


HOLLY AVENUE, LOS ALTOS, CA




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	12.04.2017	12.04.2017 PLANNING PERMIT RESUBMITTAL IV	<u>&gt;</u>

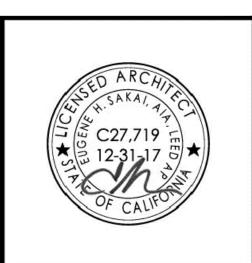UPPER

ROOF PLAN

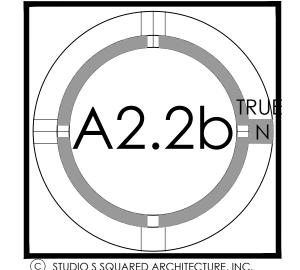

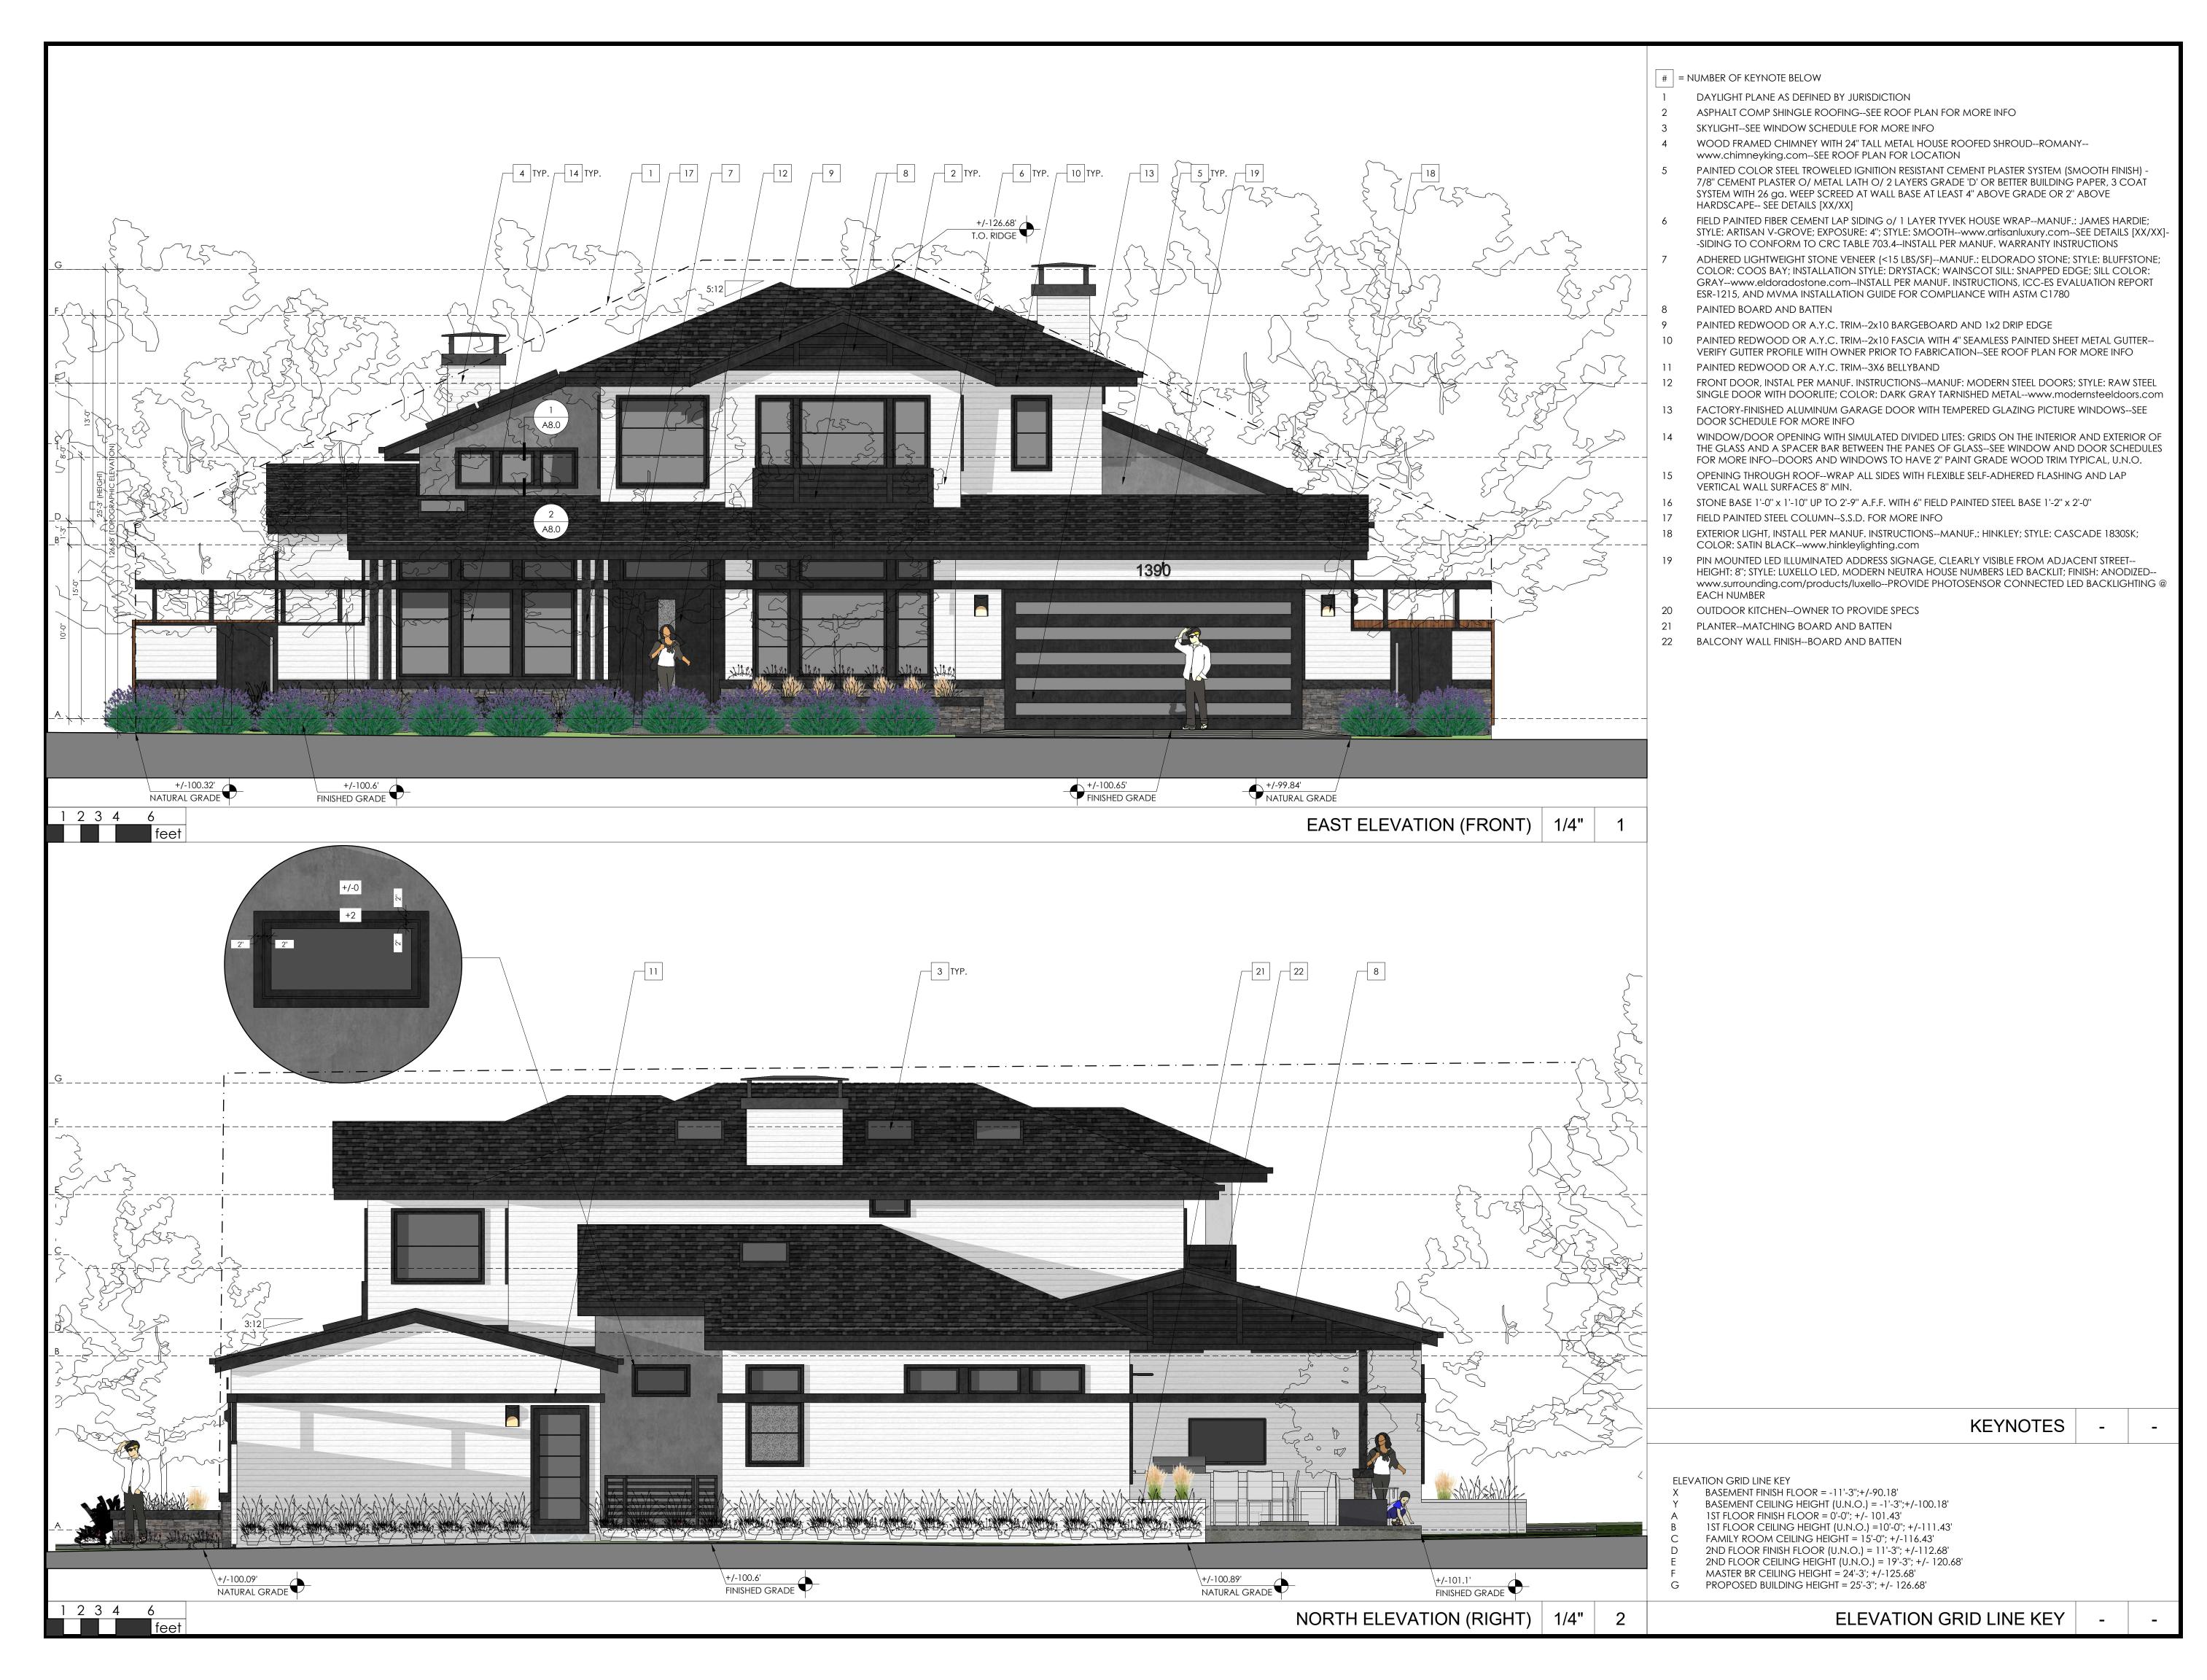



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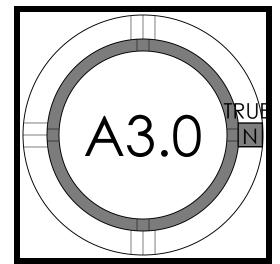
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NEW SINGLE FAMILY RESIDENCE




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REVISION	DATE	DESCRIPTION	DRAWN BY
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	12.04.2017	PLANNING PERMIT RESUBMITTAL	>

EXTERIOR ELEVATIONS





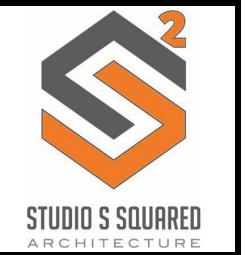

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S ALTOS, CA


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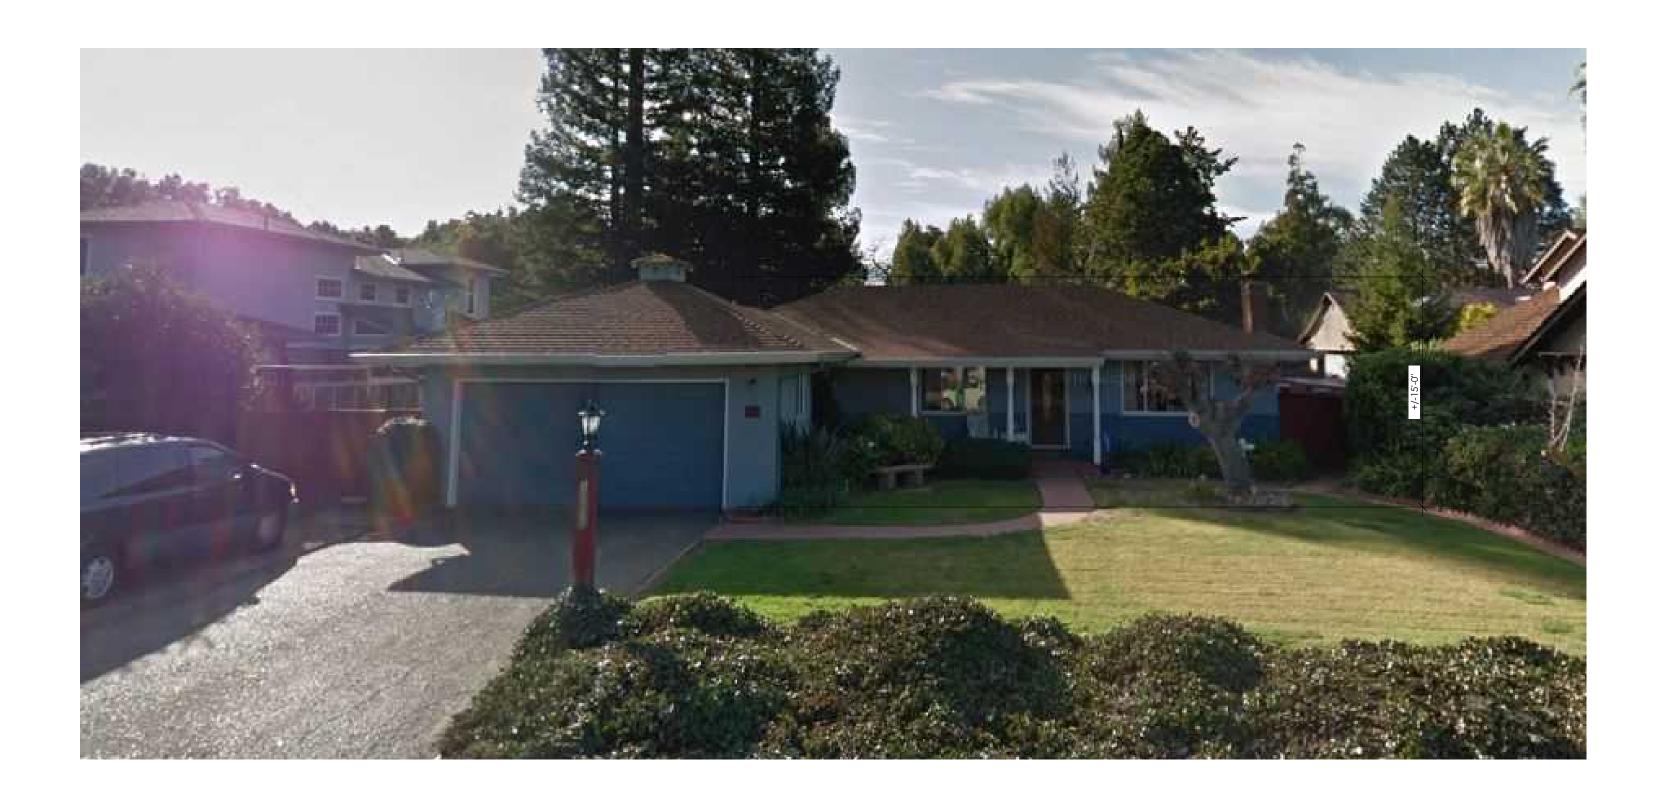
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REVISION	DATE	DESCRIPTION	DRAWN BY
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	12.04.2017	PLANNING PERMIT RESUBMITTAL	>

EXTERIOR ELEVATIONS







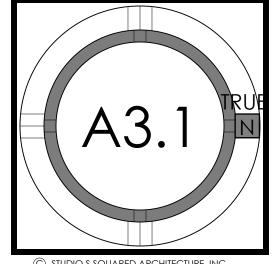


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EXISTING SIDE ELEVATIONS -

2

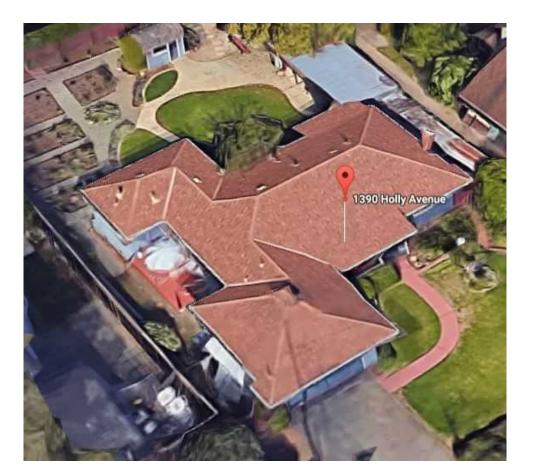KEYNOTES

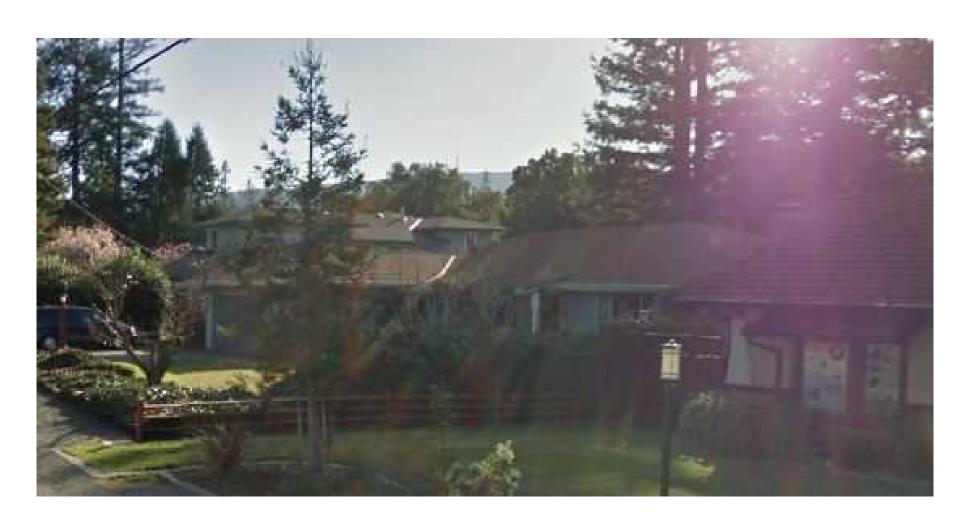
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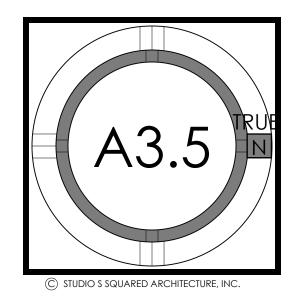
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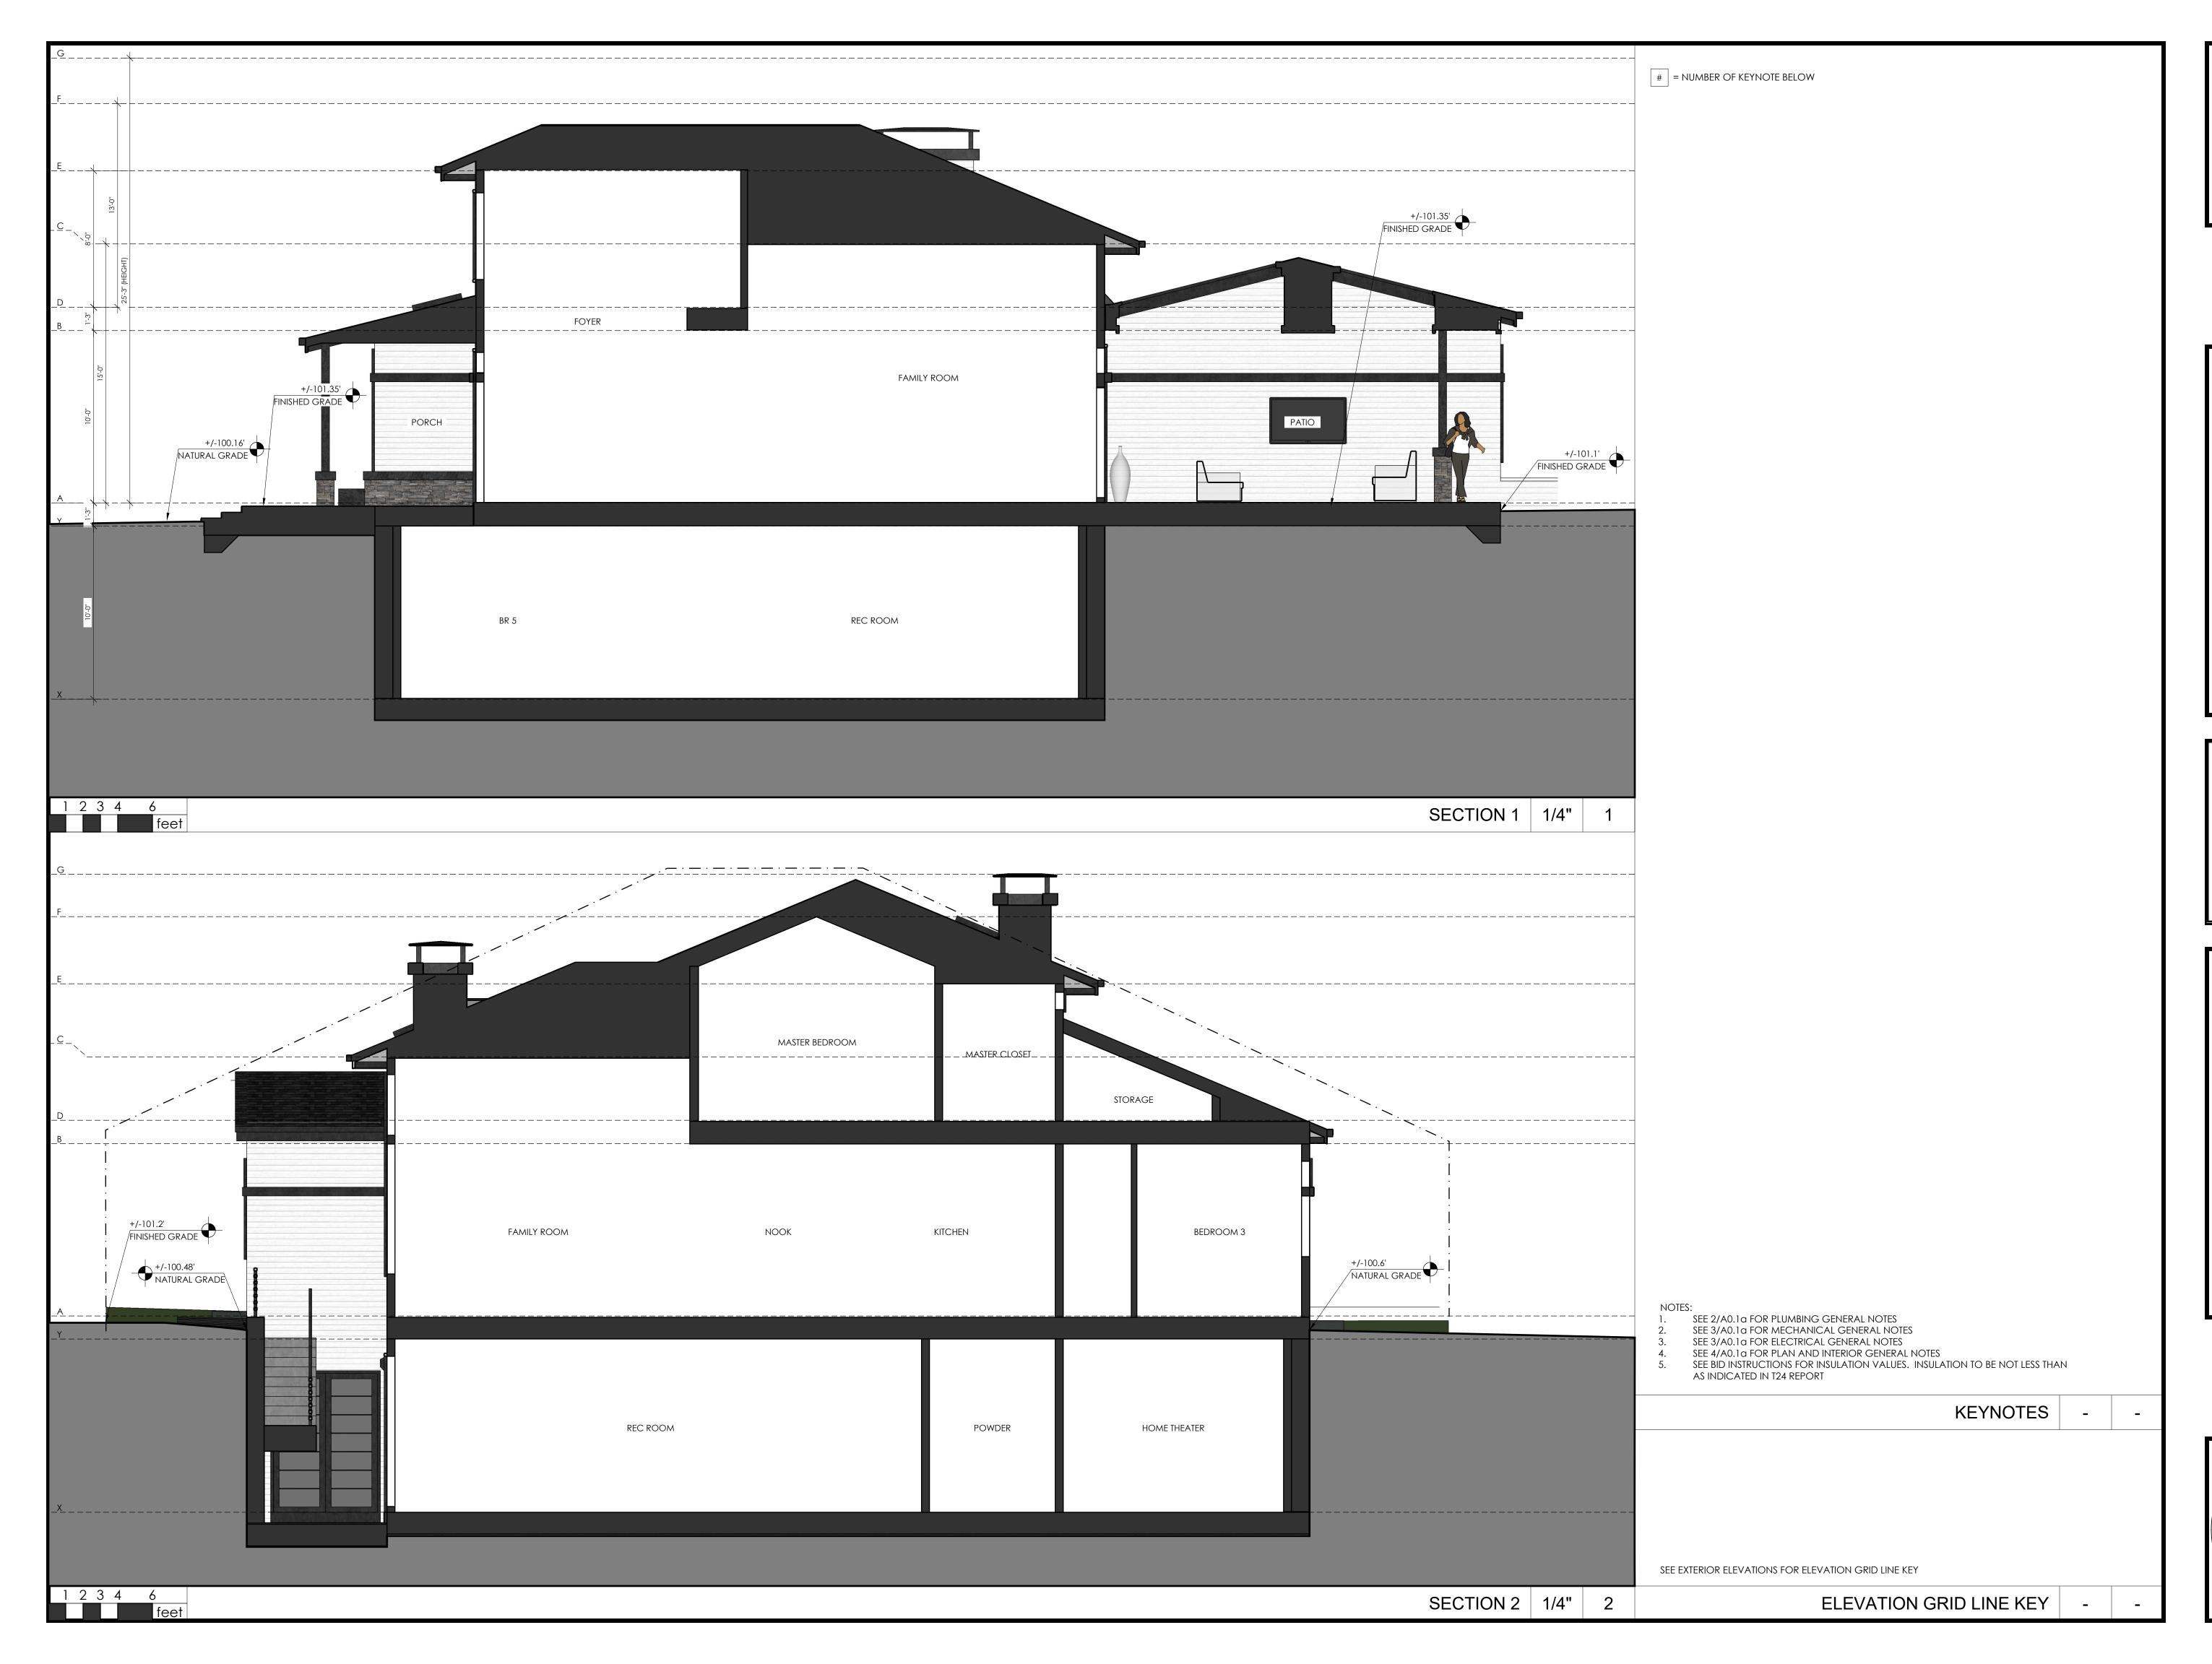
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PROJECT NO.			17-008
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	09.30.2017	PLANNING PERMIT SUBMITTAL	>
	12.04.2017	PLANNING PERMIT RESUBMITTAL	<u>&gt;</u>

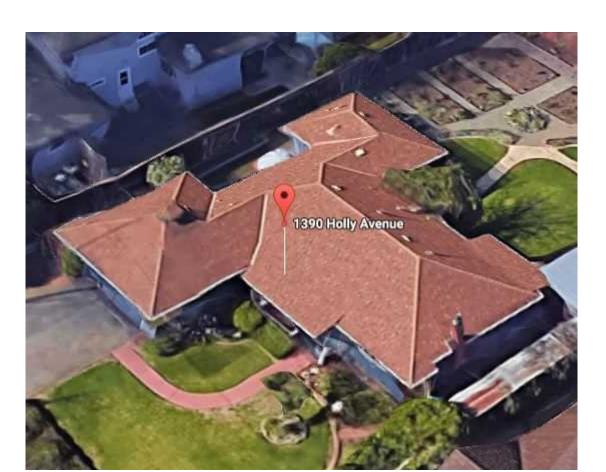EXISTING ELEVATIONS





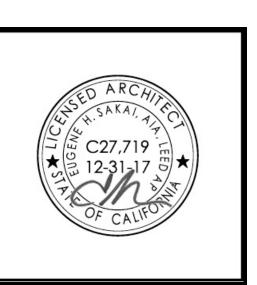

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RESIDENCE


SLE FAMILY RESIDENCE


ANEVUE, LOS ALTOS, CA

1390 HOLLY ANEVUE, LOS



SECTIONS

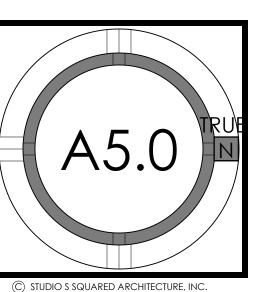

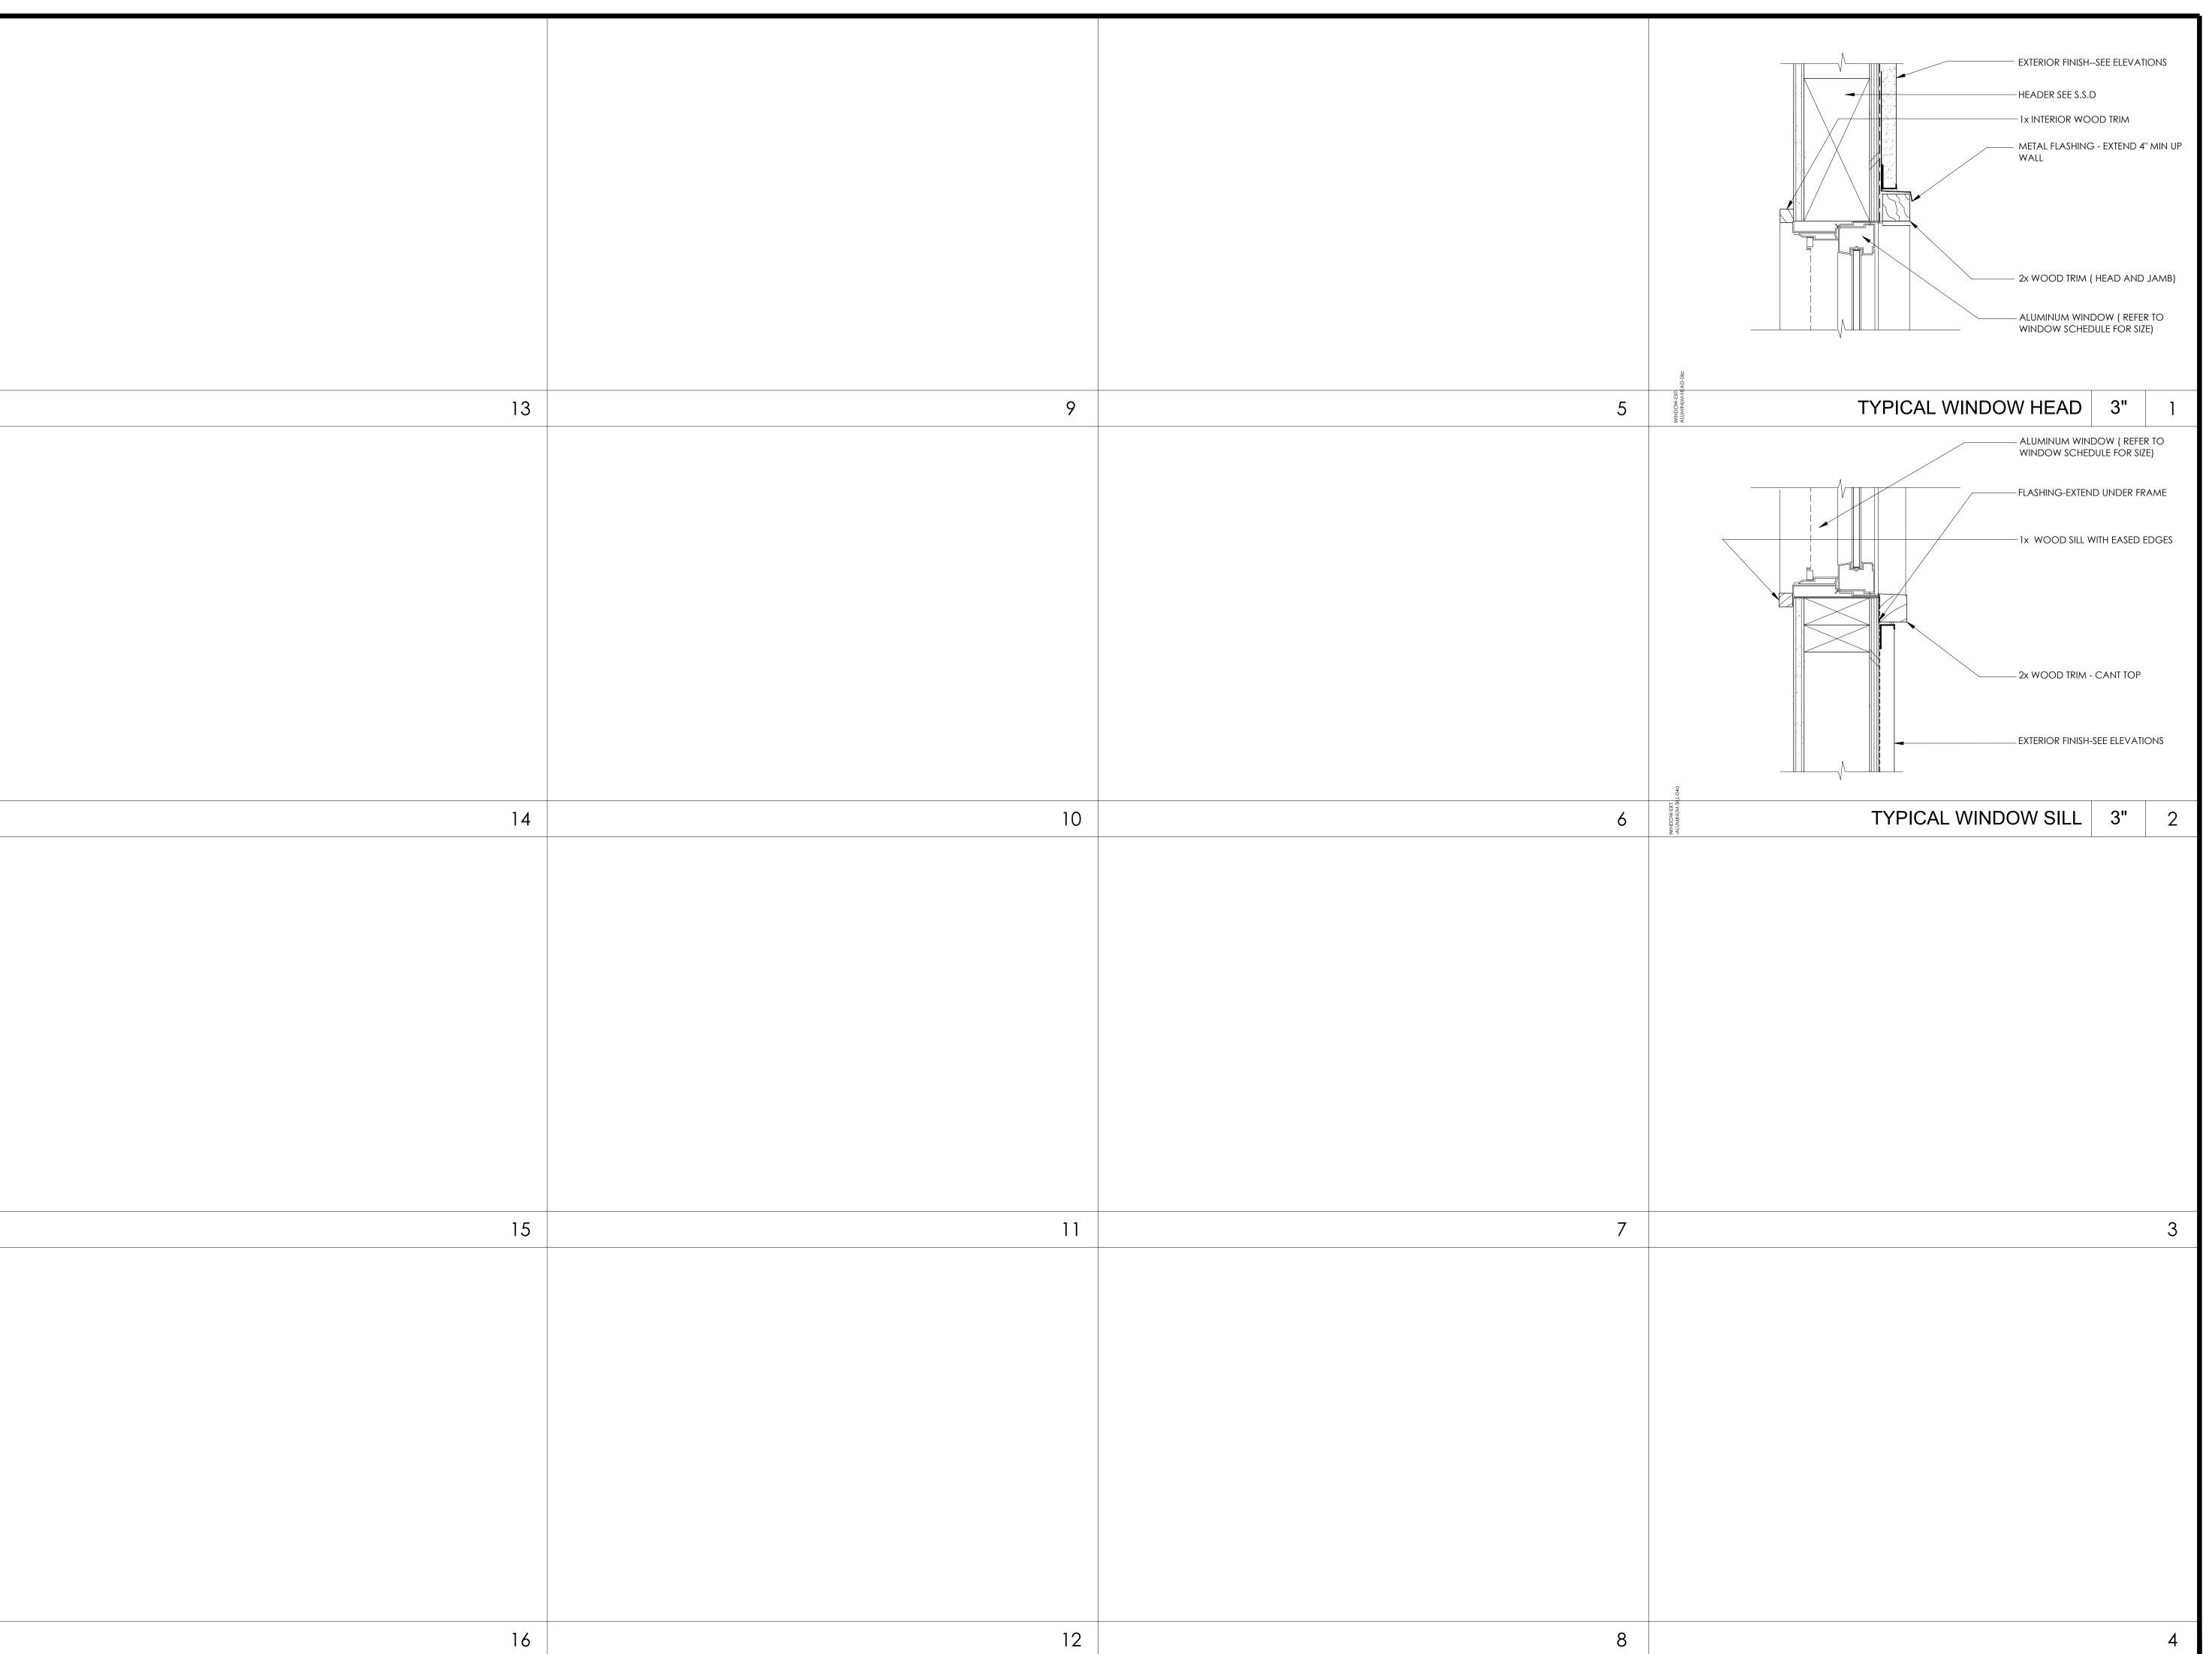



CAO RESIDENCE

NEW SINGLE FAMILY RESIDENCE


1390 HOLLY AVENUE, LOS ALTOS, CA

CAO SHU



PROJECT NO.	.0		17-008
REVISION	DATE	DESCRIPTION	DRAWN BY
	09.30.2017	09.30.2017 PLANNING PERMIT SUBMITTAL	2
	12.04.2017	12.04.2017 PLANNING PERMIT RESUBMITTAL IV	<u>&gt;</u>

DETAILS

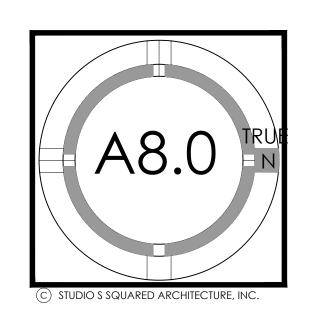

## CAO RESIDENCE 1390 HOLLY AVE. LOS ALTOS, CA LANDSCAPE CONCEPT

#### LOT COVERAGE CALCULATIONS:

 NET LOT AREA - $10,458 \, \mathrm{SF}$ • HARDSCAPE COVERAGE: ARCHITECTURE -3034 SF• HARDSCAPE COVERAGE: LANDSCAPE -2444 SF TOTAL SOFTSCAPE  $4980~\mathrm{SF}$ 

• FRONT YARD AREA -1937 SF• FRONT YARD HARDSCAPE -862 SF (44.5%)

#### PRELIMINARY PLANT LIST:

BOTANICAL NAME

WHITE REDBUD

CERCIS CANADENSIS 'ALBA' GINKGO BILOBA LAURUS NOBILIS 'SARATOGA' MAGNOLIA 'LITTLE GEM'

PRUNUS SERRULATA 'KWANZAN'

GINKGO TREE SARATOGA BAY LAUREL LITTLE GEM SOUTHERN MAGNOLIA KWANZAN FLOWERING CHERRY

COMMON NAME

N. C. N.

<u>SHRUBS</u> GAURA LINDHEIMERI LOMANDRA 'PLATINUM BEAUTY' LOROPETALUM 'PLUM DELIGHT' MUHLENBERGIA DUBIA

VARIEGATED DWARF MAT RUSH CHINESE FRINGE FLOWER PINE MUHLY

NANDINA DOM. 'GULF STREAM' RHAPHIOLEPIS UMBELLATA WESTRINGIA F. 'SMOKEY'

GULF STREAM HEAVENLY BAMBOO YEDDO HAWTHORNE SMOKEY COAST ROSEMARY

GROUNDCOVER


CAREX TUMULICOLA MUHLENBERGIA CAP. 'WHITE CLOUD' WHITE AWN MUHLY SALVIA GREGGII 'RED' WESTRINGIA F. 'LOW HORIZON'

BERKELEY SEDGE RED AUTUMN SAGE LOW HORIZON COAST ROSEMARY

HARDENBERGIA VIOLACEA LILAC VINE TRACHELOSPERMUM JASMINOIDES STAR JASMINE

#### PRELIMINARY WATER BUDGET:


1390 HOLLY AV	VE, LOS AL	105										
Eto	42.9			ZONE	WATER USE	PF	METHOD	ΙE	ETAF	НА	ETAF*HA	ETWU
Total HA	4,885			1 - SHRUB FRONT	L	0.2	DRIP	0.81	0.2	1,123	277	7,375
Special HA	164			2 - TREE FRONT	М	0.5	DRIP	0.81	0.6	200	123	3,284
ETAF Average	0.49			3 - SHRUB BACK	М	0.5	DRIP	0.81	0.6	1,533	946	25,170
ETAF Total	0.51			4 - TREE BACK	М	0.5	DRIP	0.81	0.6	320	198	5,254
				5 - SOD BACK	М	0.4	DRIP	0.81	0.5	1,545	763	20,293
MAWA = (ETo) (0.	.62) [(0.55× LA	.)] +[(1-0.55)	×SLA)]	LS TOTALS						4,721	2,308	61,376
				SLA	WATER USE				ETAF	НА	ETAF*HA	ETWU
MAWA	73,425	Gallons		WATER FEATURE	HIGH				1.0	164	164	4,362
	9,816	HCF		SLA TOTALS						164	164	4,362
	(FTAF)/ADFA)			SHRUB			4,721	100%				
	ETAF](AKEA)			LAWN (25% MAX.)			0	0%				
ETWU=(Eto)(0.62)(												

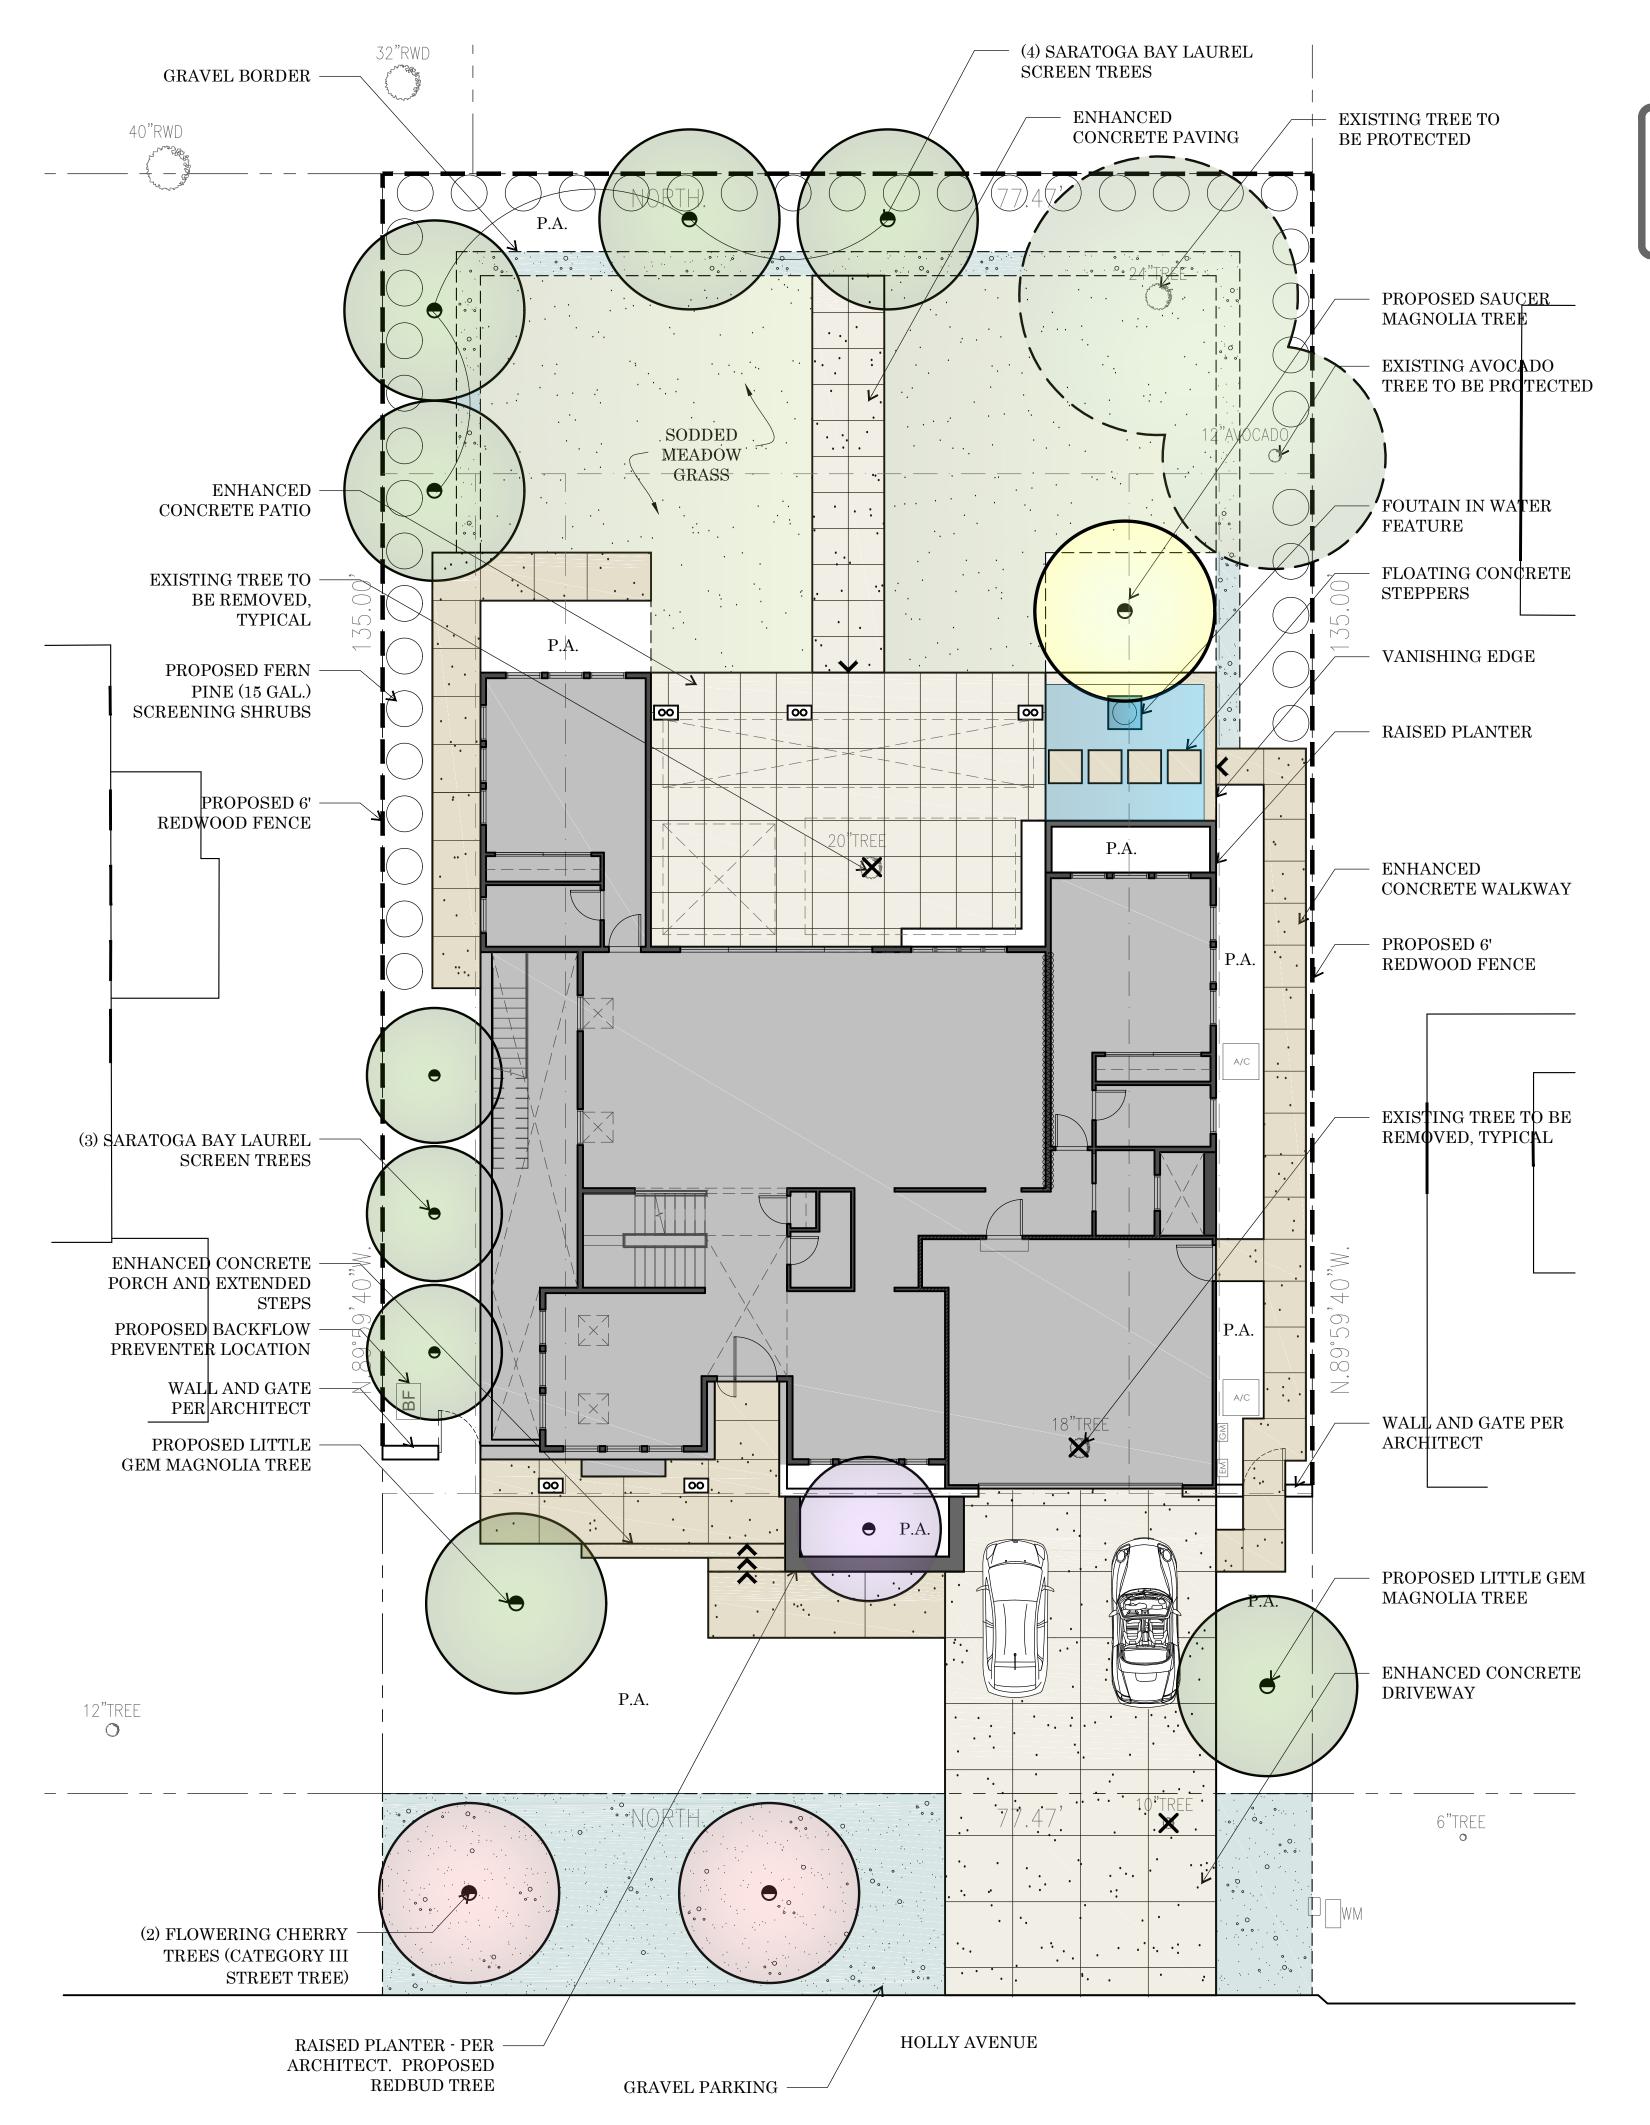






# CAO RESIDENCE 1390 HOLLY AVE. LOS ALTOS, CA PLANTING SELECTION

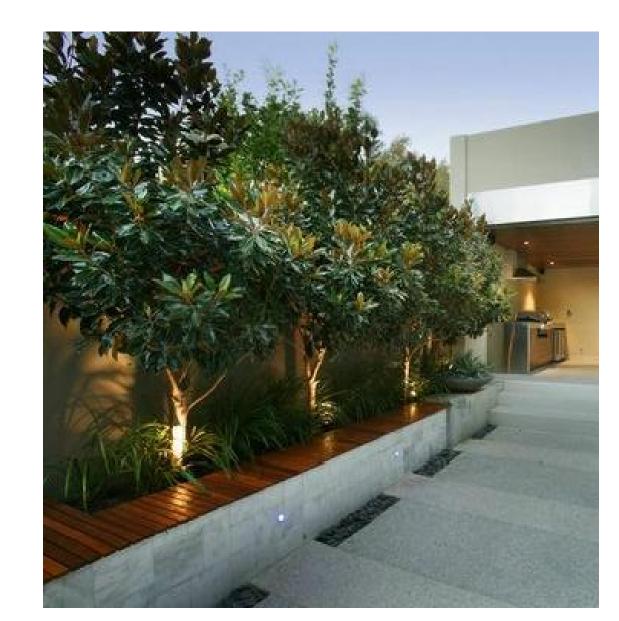

LITTLE GEM SOUTHERN MAGNOLIA MATURE SIZE: 25' Hx25' W GROWTH: SLOW USE: SCREEN/ACCENT

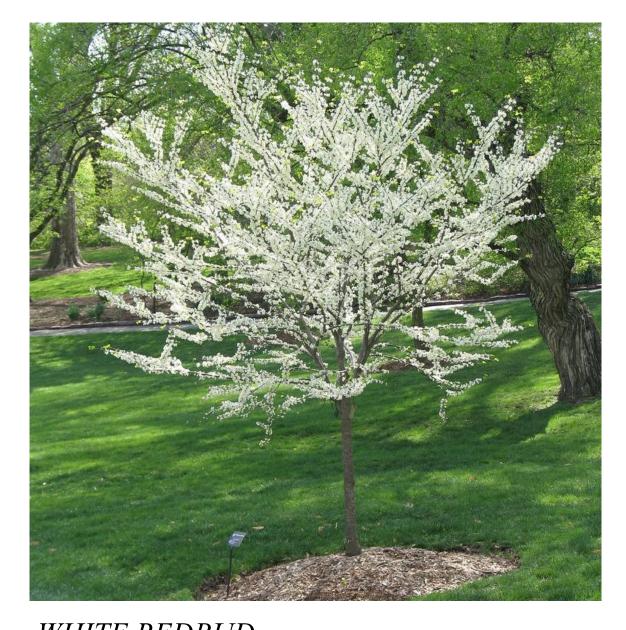

WHITE REDBUD MATURE SIZE: 15' Hx15' W GROWTH: SLOW USE: SPECIMEN




KWANZAN FLOWERING CHERRY MATURE SIZE: 20' Hx15' W USE: STREET TREE



SARATOGA BAY LAUREL MATURE SIZE: 20' Hx15' W GROWTH: MODERATE USE: SCREEN



SAUCER MAGNOLIA MATURE SIZE: 25' Hx25' W GROWTH: MODERATE-FAST USE: SPECIMEN

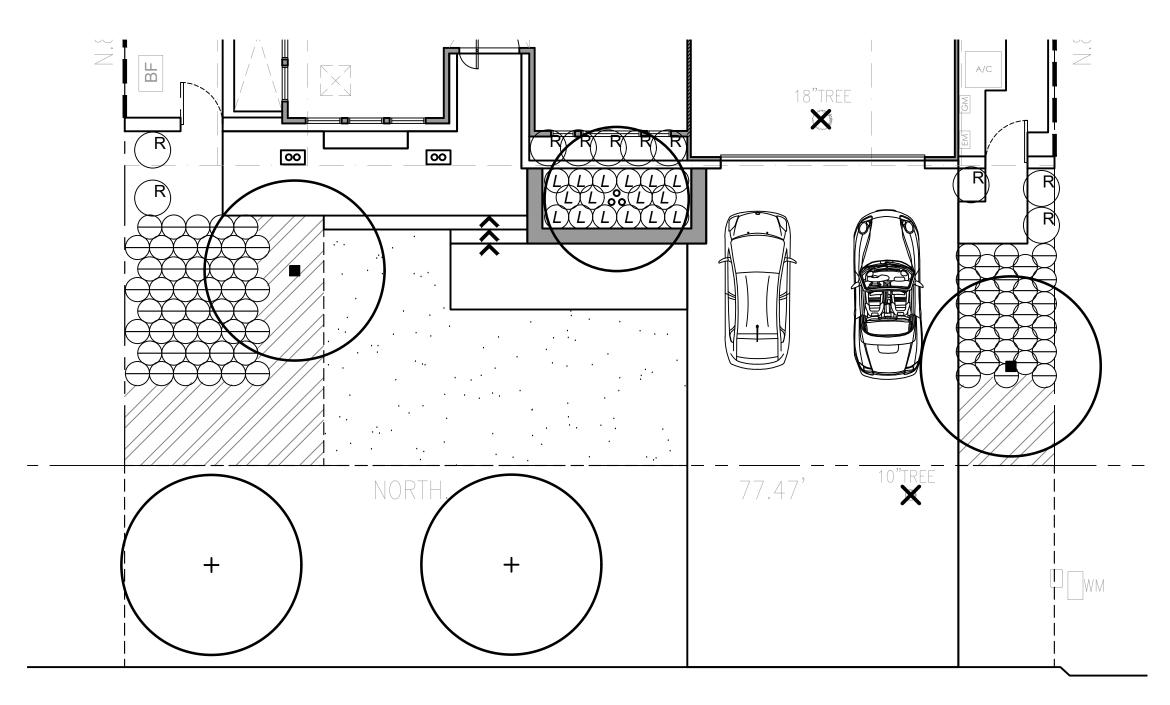

HOLLY AVENUE



FERN PINE

MATURE SIZE: 15' Hx5' W


USE: SCREEN GROWTH: FAST

	BOTANICAL NAME	COMMON NAME	SIZE/SPACING	QTY.	WUCOLS	NOTES			
	TREES								
%	CERCIS CANADENSIS 'ALBA'	WHITE REDBUD	24" BOX MULTI.	1	LOW	BEST AVAILABLE			
+ [	PRUNUS SERRULATA 'KWANZAN'	FLOWERING CHERRY	24" BOX STD.	2	MODERATE	CAT. III STREET TREE			
	MAGNOLIA G. 'LITTLE GEM'	LITTLE GEM SOUTHERN MAGNOLIA	24" BOX STD.	2	MODERATE	BEST AVAILABLE			
	SHRUBS								
	LOMANDRA L. 'PLATINUM BEAUTY'	VARIEGATED DWARF MAT RUSH	5 GALLON	16	LOW				
$\supset \Gamma$	MUHLENBERGIA DUBIA	PINE MUHLY	5 GALLON	72	LOW				
$\widetilde{R}$	RHAPHIOLEPIS UMBELLATA	YEDDO HAWTHORN	5 GALLON	10	LOW				
	GROUNDCOVER								
	SALVIA GREGGII 'RED'	RED AUTUMN SAGE	1 GAL @ 24" O.C.	70	LOW	240 SF			
	SEED MIX								
	DELTA BLUEGRASS 'NATIVE MOW FF	SOD	465 SF	LOW					

SUNSET ZONE: 15

PLANTING PLAN - FRONT YARD



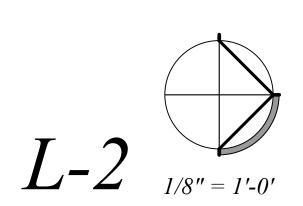

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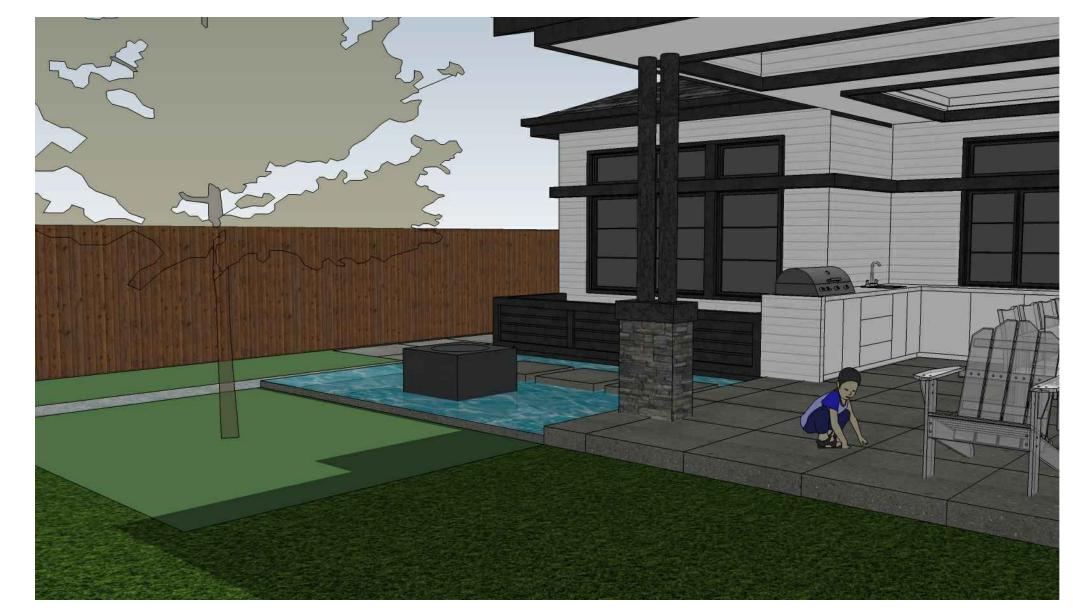
# CAO RESIDENCE 1390 HOLLY AVE. LOS ALTOS, CA LANDSCAPE IMAGERY








BACK YARD - WATER FEATURE



BACK YARD - WATER FEATURE

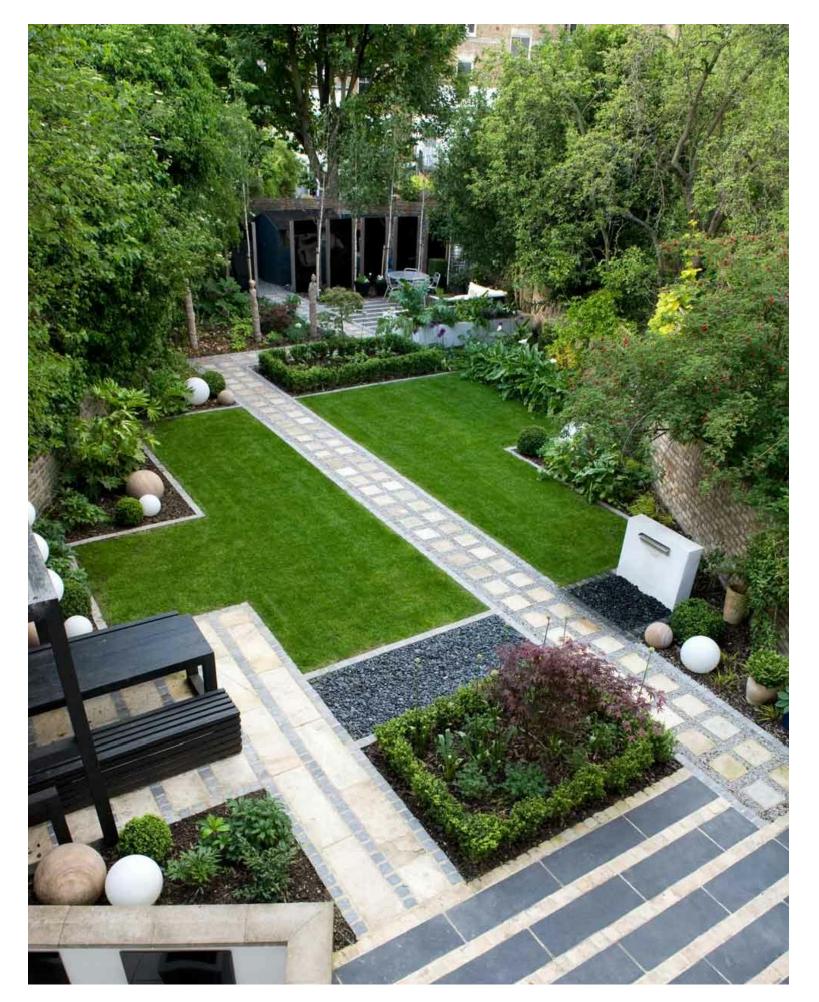

DESIGN INSPIRATION

FRONT YARD



WATER FEATURE WITH FLOATING STEPPERS



FOUNTAIN

PRELIMINARY NOT FOR

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