

DATE: August 17, 2016

AGENDA ITEM # 4

TO:

Design Review Commission

FROM:

Sean K. Gallegos, Assistant Planner

SUBJECT:

16-SC-28 – 904 Madonna Way

RECOMMENDATION:

Approve design review application 16-SC-28 subject to the listed findings and conditions

PROJECT DESCRIPTION

This is a design review application for a remodel and addition to an existing two-story house. The project includes an addition of 25 square feet on the first-story and 132 square feet on the second-story. The following table summarizes the project's technical details:

GENERAL PLAN DESIGNATION:

Single-family, Residential

ZONING:

R1-H

PARCEL SIZE:

22,709 square feet

MATERIALS:

Matching existing - tile shingle, cement plaster siding,

wood clad aluminum windows, and wood trim

	Existing	Proposed	Allowed/Required
LOT COVERAGE:	2,759 square feet	2,784 square feet	5,677 square feet
FLOOR AREA:			
First floor ¹	3,101 square feet	3,126 square feet	
Second floor	1,514 square feet	1,646 square feet	
Total	4,615 square feet	4,772 square feet	5,029 square feet
SETBACKS:			
Front	32.6 feet	32.6 feet	30 feet
Rear	38 feet	38 feet	50 feet
Right side (1 st /2 nd)	25.1 feet/25.1 feet	25.1 feet/25.1 feet	25 feet/25 feet
Left side (1 st /2 nd)	40.1 feet/41.5 feet	40.1 feet/41.5 feet	25 feet/25 feet
Неіднт:	26.7 feet	26.7 feet	27 feet

¹ Includes floor area from the lower level garage.

BACKGROUND

Neighborhood Context

The subject property is located in a Diverse Character Neighborhood, as defined in the City's Residential Design Guidelines. Madonna Way is a hillside cul-de-sac that is accessed from University Avenue. The homes on the street vary in age and design and are a combination of one and two-stories. Due to the moderate to steep slope in the area, most of the properties in the neighborhood have limited visibility from the street. The front yard landscaping is varied throughout the neighborhood.

Zoning Compliance

The house has an existing non-conforming rear yard setback of 37 feet, 11 inches, while the R1-H district requires a minimum side yard setback of 50 feet. Since the project will be maintaining more than 50 percent of the existing house, the Zoning Code allows the non-conforming setback to be maintained.

In the R1-H district, if the height exceeds 22 feet, the first floor side yard setback is 25 feet

DISCUSSION

Design Review

According to the Design Guidelines, in Diverse Character Neighborhoods, good neighbor design has its own design integrity while incorporating some design elements and materials found in the neighborhood.

The proposed addition and remodel matches the traditional architectural design style of the existing house. An expanded family room and breakfast area are proposed along the right side of the first story and the existing deck off the master bedroom is being converted into an exercise room on the second story. The design relates well to the homes in the neighborhood context with horizontal eave lines and hipped roof elements. The project uses high quality materials consistent with the existing materials, such as cement plaster siding, wood clad aluminum windows and wood trim, which are integral to the architectural design of the house. Overall, the project design has individual design integrity and the materials and forms relate well with the surrounding neighborhood.

The minor addition to the rear of the house will maintain the existing massing and maintain the traditional appearance of the house. Due to the moderate to steep slope in the immediate neighborhood and limited visibility from the adjacent properties, the minor addition to the rear of the house will not be perceived by adjacent properties.

Privacy

On the right (west) side elevation of the second story, there is one egress window in the exercise room with a two-foot, four-inch sill height. Although the exercise room includes a low sill height,

the sight line study (Sheet A-1.2) shows the existing mature trees along the right property line provides screening to obscure sight lines and maintains a reasonable degree of privacy. Additionally, the window is oriented toward the public right-of-way, which further diminishes privacy impacts. Therefore, as designed and with the existing evergreen screening, the project maintains a reasonable degree of privacy. The project does not propose revisions to the left (east) or rear (south) second story windows.

Landscaping

There are 18 existing mature trees throughout the property. No trees are proposed for removal and all existing landscaping will be maintained. With the existing trees, front yard landscaping and hardscape, the project meets the City's landscaping regulations and street tree guidelines. Since the project does not rebuild more than 2,500 square feet of landscape area, the City's Water Efficient Landscape Regulations do not apply.

ENVIRONMENTAL REVIEW

This project is categorically exempt from environmental review under Section 15301 of the California Environmental Quality Act because it involves an addition to an existing single-family structure.

PUBLIC CONTACT

A public meeting notice was posted on the property and mailed to 11 nearby property owners on Madonna Way.

Cc: Fred Blome, Applicant and Architect Bernie and Ditza Recht, Owners

Attachments:

- A. Application
- B. Neighborhood Compatibility Worksheet
- C. Area, Vicinity and Notification Maps

FINDINGS

16-SC-28 – 904 Madonna Way

With regard to the addition to the existing two-story house, the Design Review Commission finds the following in accordance with Section 14.76.050 of the Municipal Code that:

- a. The proposed addition complies with all provision of this chapter;
- b. The height, elevations, and placement on the site of the proposed addition, when considered with reference to the nature and location of residential structures on adjacent lots, will avoid unreasonable interference with views and privacy and will consider the topographic and geologic constraints imposed by particular building site conditions;
- c. The natural landscape will be preserved insofar as practicable by minimizing tree and soil removal; grade changes shall be minimized and will be in keeping with the general appearance of neighboring developed areas;
- d. The orientation of the proposed addition in relation to the immediate neighborhood will minimize the perception of excessive bulk;
- e. General architectural considerations, including the character, size, scale, and quality of the design, the architectural relationship with the site and other buildings, building materials, and similar elements have been incorporated in order to insure the compatibility of the development with its design concept and the character of adjacent buildings; and
- f. The proposed addition has been designed to follow the natural contours of the site with minimal grading, minimum impervious cover, and maximum erosion protection.

CONDITIONS

16-SC-28 - 904 Madonna Way

GENERAL

1. Approved Plans

The approval is based on the plans and materials received on July 28, 2016, except as may be modified by these conditions. The scope of work is limited to that shown on the plans and may not exceed rebuilding 50 percent of the existing structure.

2. Encroachment Permit

An encroachment permit shall be obtained from the Engineering Division prior to doing any work within the public right-of-way including the street shoulder.

3. Indemnity and Hold Harmless

The applicant/owner agrees to indemnify, defend, protect, and hold the City harmless from all costs and expenses, including attorney's fees, incurred by the City or held to be the liability of the City in connection with the City's defense of its actions in any proceedings brought in any State or Federal Court, challenging any of the City's action with respect to the applicant's project.

PRIOR TO ISSUANCE OF BUILDING OR DEMOLITION PERMIT

4. Tree Protection

Tree protection fencing shall be installed around the dripline, or as required by the project arborist, of the existing trees as shown on the site plan. Tree protection fencing shall be chain link and a minimum of five feet in height with posts driven into the ground and shall not be removed until all building construction has been completed unless approved by the Planning Division.

PRIOR TO BUILDING PERMIT SUBMITTAL

5. Conditions of Approval

Incorporate the conditions of approval into the title page of the plans.

6. Tree Protection Note

On the grading plan and/or the site plan, show all tree protection fencing and add the following note: "All tree protection fencing shall be chain link and a minimum of five feet in height with posts driven into the ground."

7. Green Building Standards

Provide verification that the house will comply with the California Green Building Standards pursuant to Section 12.26 of the Municipal Code and provide a signature from the project's Qualified Green Building Professional Designer/Architect and property owner.

8. Air Conditioner Sound Rating

Show the location of any air conditioning units on the site plan and the manufacturer's specifications showing the sound rating for each unit.

9. Storm Water Management

Show how the project is in compliance with the New Development and Construction Best Management Practices and Urban Runoff Pollution Prevention program, as adopted by the City for the purposes of preventing storm water pollution (i.e. downspouts directed to landscaped areas, minimize directly connected impervious areas, etc.).

PRIOR TO FINAL INSPECTION

10. Landscaping Installation

All front yard landscaping and privacy screening trees shall be maintained and/or installed as shown on the approved plans or as required by the Planning Division.

11. Green Building Verification

Submit verification that the house was built in compliance with the City's Green Building Ordinance (Section 12.26 of the Municipal Code).



ATTACHMENT A

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JUN 10 2016

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CITY OF LOS ALTOS GENERAL APPLICATION

Type of Review Requested: (Check all boxes that apply)

CITY OF LOS ALTOS PLANNING

Permit#

One-Story Design Review	Commercial/Multi-Family	Environmental Review
Two-Story Design Review	Sign Permit	Rezoning
Variance	Use Permit	R1-S Overlay
Lot Line Adjustment	Tenant Improvement	General Plan/Code Amendment
Tentative Map/Division of Land	Sidewalk Display Permit	Appeal
Historical Review	Preliminary Project Review	Other:
Project Address/Location: 904 Mador		
Project Proposal/Use: Single Family F	Residence Current Use of Prop	erty: Single Family Residence
Assessor Parcel Number(s): 336-44-03		
New Sq. Ft.: 157.2 Altered/	Rebuilt Sq. Ft.: Exis	ting Sq. Ft. to Remain: 4375.9
Total Existing Sq. Ft.: 4,508.6	Total Proposed Sq. Ft. (incl	uding basement): 4,850.8
Is the site fully accessible for City Staff	finspection? Yes	
Applicant's Name: Fred Blome - Blom	ne Architecture	
Telephone No.: 650-325-5443	Email Address: fred@blom	earchitecture.com
Mailing Address: 719 Regal Court		
City/State/Zip Code: Menlo Park, CA	94025	
Property Owner's Name: Berie & Ditz	a Recht	
	Email Address: rechtmd@a	aol.com
Mailing Address: 904 Madonna Way		85-32-3410
City/State/Zip Code: Los Altos, CA 94	1024	
F 1 FI	Discount A Live	
Architect/Designer's Name: Fred Bl	ome - Blome Architecture	
Telephone No.: 650-325-5443	Email Address: fred@blom	nearchitecture.com
Mailing Address: 719 Regal Ct		
City/State/Zip Code: Menlo Park, CA	94025	SOCIED SWINE STATE OF THE STATE

^{*} If your project includes complete or partial demolition of an existing residence or commercial building, a demolition permit must be issued and finaled prior to obtaining your building permit. Please contact the Building Division for a demolition package. *

BLOME architecture


6/20/2016

Design Review Commission City of Los Altos, CA

Re:

Second story addition at 904 Madonna Way, Los Altos, CA

APN 336-44-039

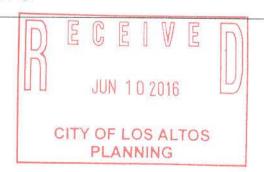

Commissioners:

We respectfully submit our project at 904 Madonna Way for a Two-Story Residential Design Review.

This project consists of a small addition on the main level floor and an addition on the upper level to enclose an existing roof balcony deck. This upper level addition is the scope of work subject to the Design Review.

- 1. The addition to the existing house complies with all provisions of the Zoning Ordinance, without exceptions.
- 2. The upper level addition has minimal impact since it is replacing and enclosing an existing balcony:
 - a. Views unchanged due to the addition as it is in front of and lower than the existing house behind.
 - b. Privacy increased due to more limited view exposure, ie 2 windows are replacing an existing open balcony.
 - c. Due to the addition's location on the existing house and the existing landscape and tree foliage, there are minimal if any views to and from adjacent properties to the addition.
- 3. There is no grading or changes to existing landscape proposed.
- 4. The addition has minimal impact on bulk of the existing house due to the location of the addition:
 - a. Replacing an existing balcony.
 - b. Lower and in front of the existing house.
 - c. Against a large chimney structure to the side of the addition.
- 5. The addition is matches all materials and details to the existing house, including roofing material and slope, eave details, and wall material & texture.
- 6. There are no changes proposed effecting the existing grading nor any foundation work related to the upper level addition. The main level addition is of minimal size and its foundation will match the existing adjacent foundation system.

To further explain the views related to the addition, we've included on the following page a panoramic photograph taken from the existing balcony deck, rotating from full left showing the existing house to full right showing the existing chimney. Although the picture is completely distorted, it does show the adjacent foliage to the left and the open but private views out front and to the right.

If you have any questions, please call.

Sincerely,

Fred Blome

Panoramic photograph from the existing balcony, where the new addition is proposed, infilling to the balcony walls.







ATTACHMENT B

Planning Division
(650) 947-2750
Planning@losaltosca.gov

CITY OF LOS ALTOS PLANNING

NEIGHBORHOOD COMPATIBILITY WORKSHEET

In order for your design review application for single-family residential remodel/addition or new construction to be successful, it is important that you consider your property, the neighborhood's special characteristics that surround that property and the compatibility of your proposal with that neighborhood. The purpose is to help you understand your neighborhood before you begin the design process with your architect/designer/builder or begin any formal process with the City of Los Altos. Please note that this worksheet must be submitted with your 1st application.

The Residential Design Guidelines encourage neighborhood compatibility without necessarily forsaking individual taste. Various factors contribute to a design that is considered compatible with a surrounding neighborhood. The factors that City officials will be considering in your design could include, but are not limited to: design theme, scale, bulk, size, roof line, lot coverage, slope of lot, setbacks, daylight plane, one or two-story, exterior materials, landscaping et cetera.

It will be helpful to have a site plan to use in conjunction with this worksheet. Your site plan should accurately depict your property boundaries. The best source for this is the legal description in your deed.

Photographs of your property and its relationship to your neighborhood (see below) will be a necessary part of your first submittal. Taking photographs before you start your project will allow you to see and appreciate that your property could be within an area that has a strong neighborhood pattern. The photographs should be taken from across the street with a standard 35mm camera and organized by address, one row for each side of the street. Photographs should also be taken of the properties on either side and behind your property from on your property.

This worksheet/check list is meant to help you as well as to help the City planners and Planning Commission understand your proposal. Reasonable guesses to your answers are acceptable. The City is not looking for precise measurements on this worksheet.

Project Address 904 Madonna Way	
Scope of Project: Addition or Remodel or New Home	
Age of existing home if this project is to be an addition or remodel?	29
Is the existing house listed on the City's Historic Resources Inventor	

Address:	904 Madonna Way		
Date:	6/1/2016	——————————————————————————————————————	
What c	onstitutes your neighb	orhood?	
		question. For the purpose of this worl	
propert	y and the five to six hom	nous homes on either side of, and directness directly across the street (eight to nouses, that you should photograph	ine hon

There is no clear answer to this question. For the purpose of this worksheet, consider first your street, the two contiguous homes on either side of, and directly behind, your property and the five to six homes directly across the street (eight to nine homes). At the minimum, these are the houses that you should photograph. If there is any question in your mind about your neighborhood boundaries, consider a radius of approximately 200 to 300 feet around your property and consider that your neighborhood.

Streetscape

1. Typical neighborhood lot size*:

	The state of the s
	Lot area: varies 10k to 38k square feet
	Lot dimensions: Length varies feet
	Width varies feet
	If your lot is significantly different than those in your neighborhood, then
	note its: area, length, and
	width
2.	Setback of homes to front property line: (Pgs. 8-11 Design Guidelines)
	1 1 7
	Existing front setback if home is a remodel? Yes
	What % of the front facing walls of the neighborhood homes are at the
	front setback 50 %
	Existing front setback for house on left 72 ft./on right
	12 ft.
	Do the front setbacks of adjacent houses line up? No
	by the from setbacks of adjacent nodees line up:
3.	Garage Location Pattern: (Pg. 19 Design Guidelines)
٥.	Garage Location 1 attern. (18. 17 Design Guidennes)
	Indicate the relationship of garage locations in your neighborhood* only on
	your street (count for each type)
	Garage facing front projecting from front of house face 5
	Garage facing front recessed from front of house face
	Garage in back yard 0
	Garage facing the side 6
	Number of 1-car garages; 2-car garages 9_; 3-car garages 2_

Addr	ess: 904 Madonna Way
100	6/1/2016
4.	Single or Two-Story Homes:
	What % of the homes in your neighborhood* are: One-story 17 Two-story 73
5.	Roof heights and shapes:
	Is the overall height of house ridgelines generally the same in your neighborhood*? No Are there mostly hip, gable style, or other style roofs*? Do the roof forms appear simple or complex? Do the houses share generally the same eave height No?
6.	Exterior Materials: (Pg. 22 Design Guidelines)
	What siding materials are frequently used in your neighborhood*?
	_ wood shingle
	What roofing materials (wood shake/shingle, asphalt shingle, flat tile, rounded tile, cement tile, slate) are consistently (about 80%) used? Flat and round tile, shingle If no consistency then explain: Varies depending on style of house.
7.	Architectural Style: (Appendix C, Design Guidelines)
	Does your neighborhood* have a <u>consistent</u> identifiable architectural style? ☐ YES ☑ NO
	Type? ☐ Ranch ☐ Shingle ☐ Tudor ☐ Mediterranean/Spanish ☐ Contemporary ☐ Colonial ☐ Bungalow ☑ Other

Address Date:	6/1/2016
8. I	Lot Slope: (Pg. 25 Design Guidelines)
	Does your property have a noticeable slope? Yes
toward	What is the direction of your slope? (relative to the street)
	Is your slope higher lower same in relationship to the neighboring properties? Is there a noticeable difference in grade between your property/house and the one across the street or directly behind?
9. I	Landscaping:
Course I had	Are there any frequently used or typical landscaping features on your street (i.e. big trees, front lawns, sidewalks, curbs, landscape to street edge, etc.)? isting street has a consistent curb and gutter, but there are no sidewalks. Landscaping is natural or developed up to the curb. There are many mature trees near the street and
	red throughout the various properties.
No ver	How visible are your house and other houses from the street or back neighbor's property? Ty visible except from a distance from street. Much of the existing on property and
171	cent property foliage and trees screen the houses.
All to r	Are there any major existing landscaping features on your property and how is the unimproved public right-of-way developed in front of your property (gravel, dirt, asphalt, landscape)? remain existing as part of this project. Existing right-of-way has mature landscaping with evel or asphalt. There is some exposed natural dirt on the sloped property up from the
7.7445000	
10.	Width of Street:
	What is the width of the roadway paving on your street in feet? 23 Is there a parking area on the street or in the shoulder area? No Is the shoulder area (unimproved public right-of-way) paved, unpaved, gravel, landscaped, and/or defined with a curb/gutter? Street has a curb and gutter. The remaining TOW is typically natural or maintained landscaping.

	With Colors and the C	04 Madonna Way
Date:	6/	/1/2016
11.	Wha	at characteristics make this neighborhood* cohesive?
	2	Such as roof material and type (hip, gable, flat), siding (board and batten, cement plaster, horizontal wood, brick), deep front yard setbacks, horizontal feel, landscape approach etc.: Varies greatly with all types
Gen	eral S	Study
	Α.	Have major visible streetscape changes occurred in your neighborhood? ■ YES ■ NO
	B.	Do you think that most (~ 80%) of the homes were originally built at the e time? YES NO
	C.	Do the lots in your neighborhood appear to be the same size? YES NO
	D.	Do the lot widths appear to be consistent in the neighborhood? YES NO
	E.	Are the front setbacks of homes on your street consistent (~80% within 5 feet)? ■ YES □ NO
	F.	Do you have active CCR's in your neighborhood? (p.36 Building Guide) YES NO
	G.	Do the houses appear to be of similar size as viewed from the street? YES NO
	Н.	Does the new exterior remodel or new construction design you are planning relate in most ways to the prevailing style(s) in your existing neighborhood? YES NO


Address: 904 Madonna Way
Date: 6/1/2016

Summary Table

Please use this table to summarize the characteristics of the houses in your immediate neighborhood (two homes on either side, directly behind and the five to six homes directly across the street).

Address	Front setback	Rear setback	Garage location	One or two stories	Height	Materials	Architecture (simple or complex)
1: 908 Madonna Way	72	25	side	2	25	stucco and tile	Meditterranean
2: 906 Madonna Way	168	10	front/side	2	25	stucco and tile	Meditterranean
3: 900 Madonna Way	20	10	front	2	25	stucco & shingle	Other
4: 890 Madonna Way	35	100	front	2	25	stucco & slate	Traditional
5: 880 Madonna Way	30	100	side	2	25	stucco/wood & sh	Ranch
6: 852 Madonna Way	65	5?	front	2	?	?	3
7: 840 Madonna Way	35?	60?	front?	1	15	Wood & shingle	Ranch
8: 901 Madonna Way	20	25	front/side	2	25	Wood &shingle	Ranch
9: 887 Madonna Way	26	56	front	2	25	Stucoo & shingle	Meditterranean
10: 893 Madonna Way	20	20	side?	2	25	Wood & shingle	Ranch




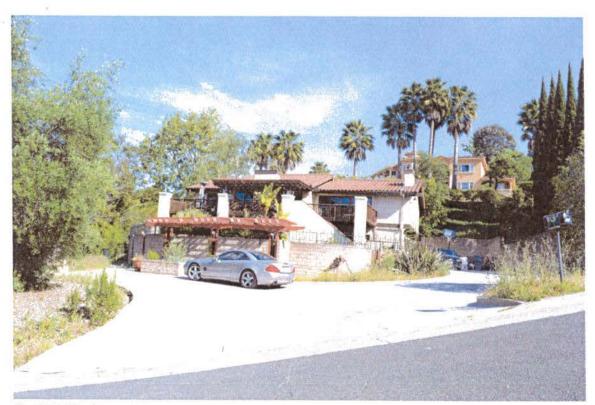

1: 908 Madonna Way



2: 906 Madonna Way

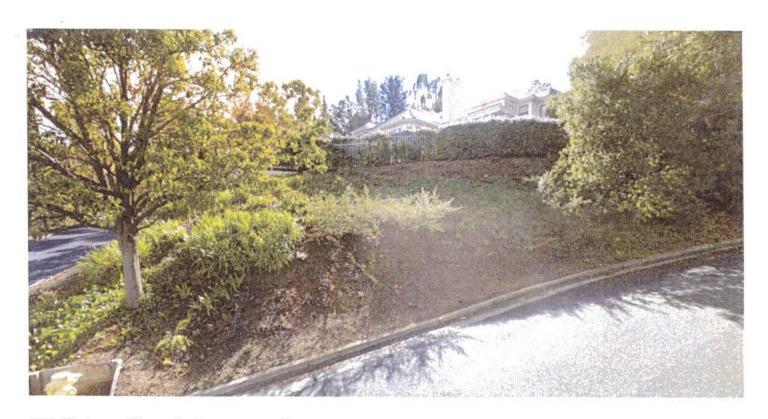


904 Madonna Way - Project property from street



904 Madonna Way - from yard




3: 900 Madonna Way

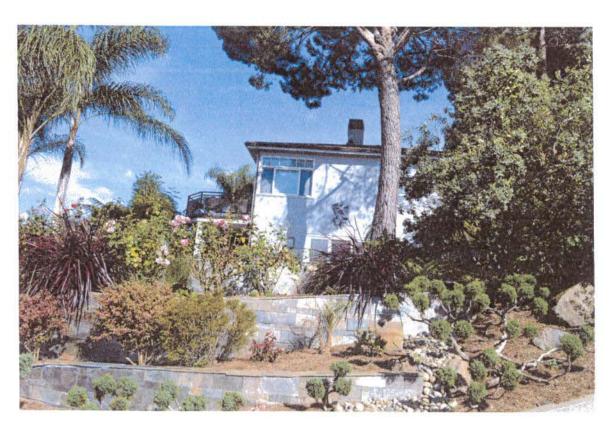


4: 890 Madonna Way



5: 880 Madonna Way

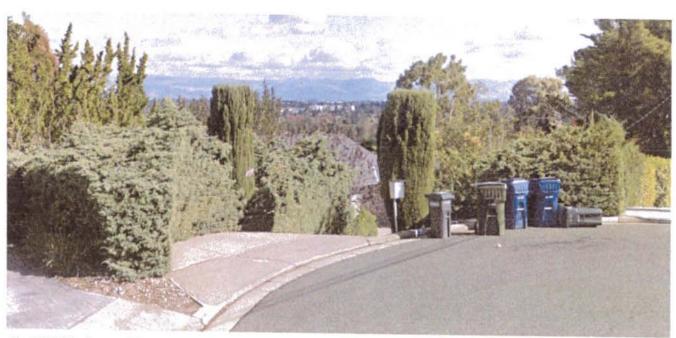


6: 852 Madonna Way

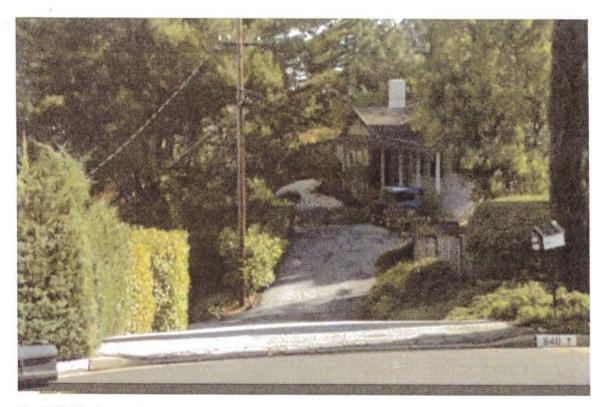

7: 840 Madonna Way



8: 901 Madonna Way

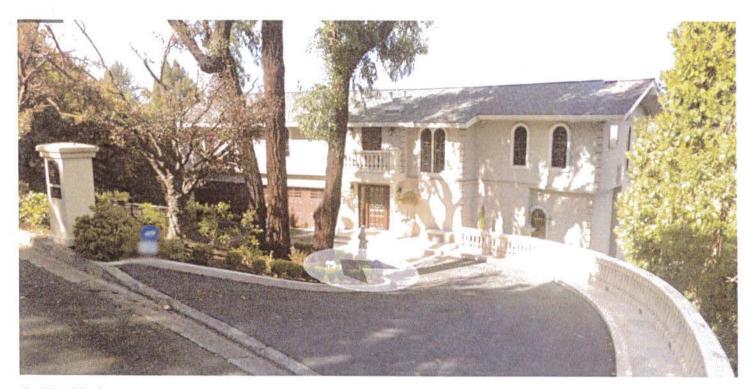


9: 887 Madonna Way



10: 893 Madonna Way

ATTACHMENT C

AREA MAP

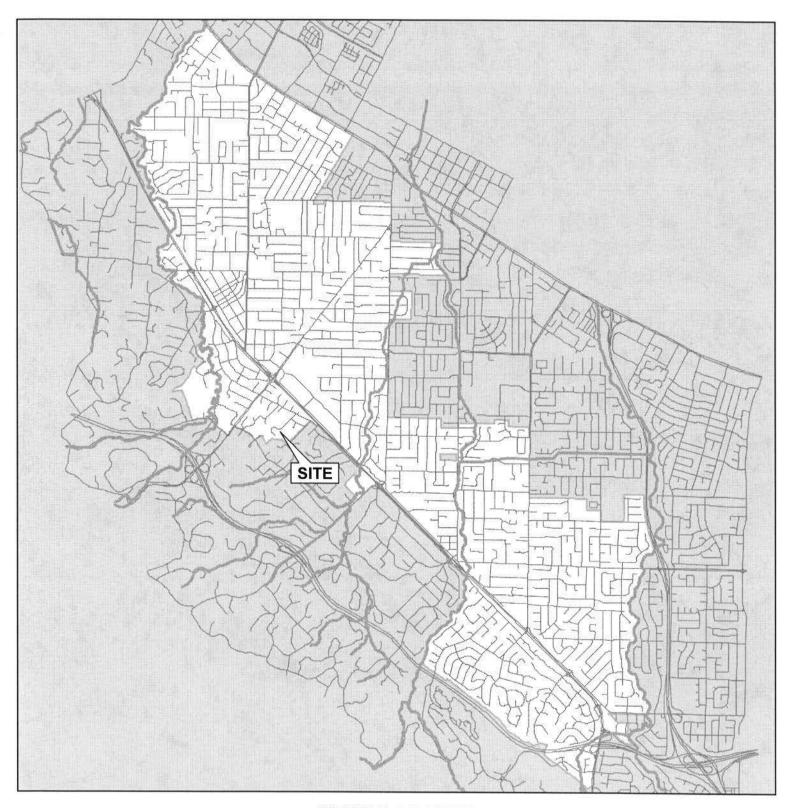

CITY OF LOS ALTOS

APPLICATION:

16-SC-28

APPLICANT:


Blome Architecture/B. and D. Recht

SITE ADDRESS: 904 Madonna Way



Not to Scale

VICINITY MAP

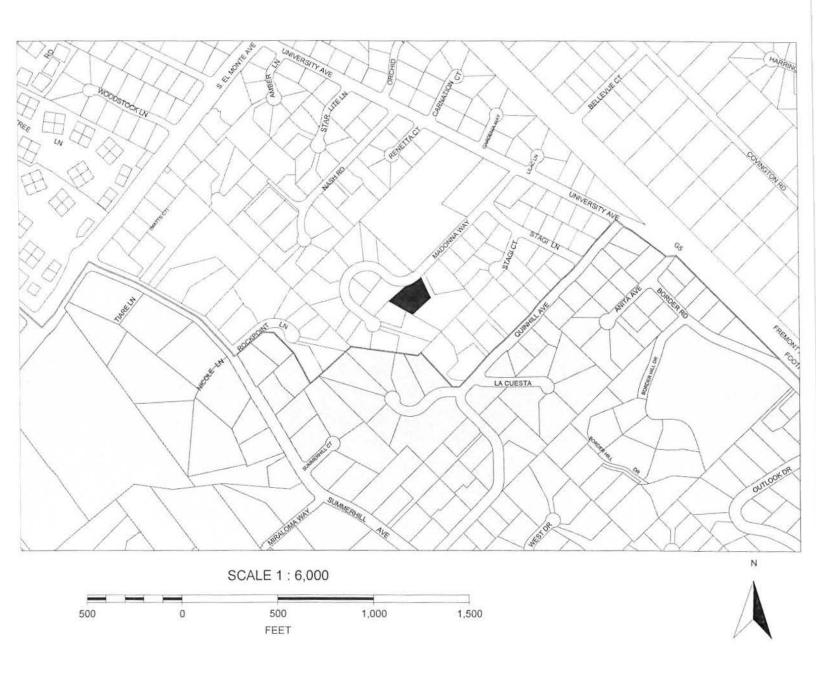

CITY OF LOS ALTOS

APPLICATION:


16-SC-28

APPLICANT:

Blome Architecture/B. and D. Recht

SITE ADDRESS: 904 Madonna Way

904 Madonna Way Notification Map

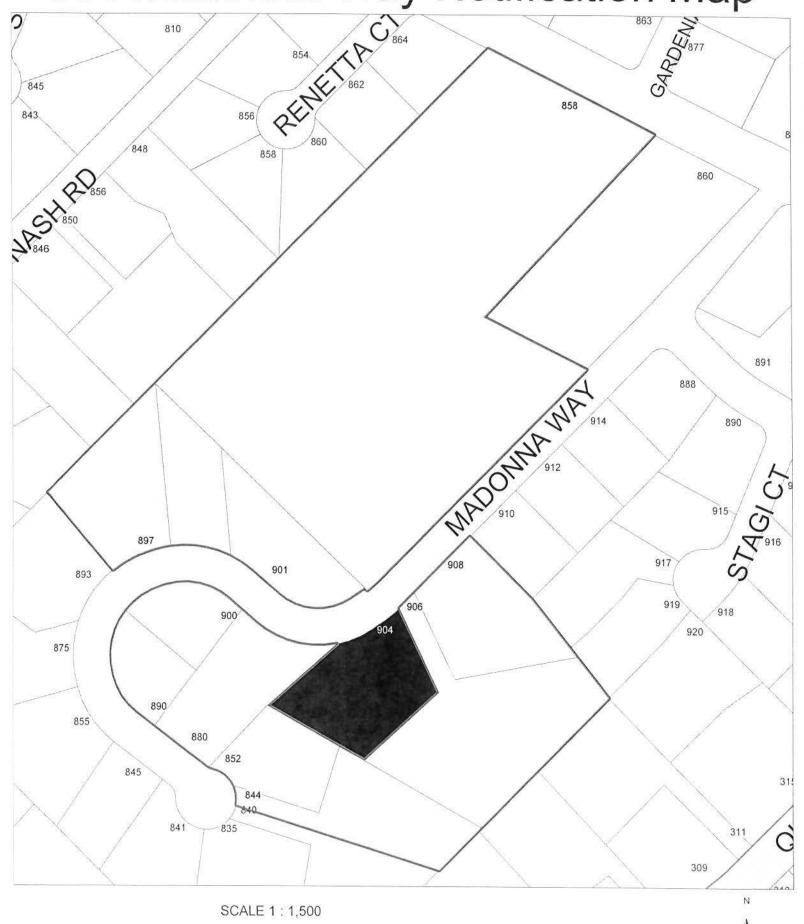

200

100 FEET

100

9

SHEET NO

7/15/2016 G-1.0

Addition & Alterations

904 Madonna Way

Los Altos, California

Vicinity Map

General Notes

- All work shall be done in strict accordance with all applicable codes adopted by local jurisdictions, latest editions, as amended by State Of California and local jurisdiction. Not all code requirements are explicitly called out on these drawings and the final responsibility for compliance is with the contractor.
- The intent of the Construction Documents is to include all labor, materials, equipment, and transportation necessary for the complete and proper execution of the Work, consistent with good practice. Any work or item not specifically called for in the drawings but required for a complete and fully functioning installation consistent with the intent of the Construction Documents shall be supplied by the Contractor as if specified. The contractor must adhere to the scope of work shown on the drawings. No work is authorized if it expands the original scope of work unless it is approved in writing by the owner. Any work undertaken by
- the contractor and any additional required documentation or cost to the project without prior written approval is the sole responsibility of the contractor. Deviations or alterations to any portion of the Work or specific details will not be allowed unless approved by
- the Architect prior to work being done. Contractor to verify all existing conditions before commencing with work in order to ensure conformance with Construction Documents. All inconsistencies shall be brought to the attention of the Architect prior to
- Any questions regarding the intent related to the layout of the new work shall be brought to the attention of the Architect prior to proceeding with any work.
- These Construction Documents (drawings, specifications and other documents), prepared by the Architect and the Architect's consultants, are instruments of professional service (Instruments of Service) for use solely with respect to this Project under contract with the Owner as listed on this sheet. This includes documents in electronic form. The Architect and the Architect's consultants shall be deemed the authors and owners of their respective Instruments of Service and shall retain all common law, statutory and other reserved rights, including copyrights. The Instruments of Service shall not be used by the Owner, or future Owner, for this Project or future additions or alterations to this Project or for other projects, without the prior written agreement of the Architect. Any unauthorized use of the Instruments of Service shall be at the Owner's sole risk and without liability to the Architect and the Architect's consultants.
- These Construction Documents, as instruments of professional service (Instruments of Service), may require interpretation or clarifications during the Construction phase. No warranties are expressed or implied in connection with providing the professional services, nor is any warranty or assurance provided as to the
- 9. Manufacturers printed or published instructions shall be strictly complied with for the incorporation of all manufactured materials and equipment into the building.

11. Contractor shall be held responsible for all loss and damage that may happen to new or existing Work or to

- 10. All materials shall be of the specified grades or better. Second hand or used material shall not be incorporated in the building without the specific approval of the Architect.
- any of the materials used thereon until the acceptance of the Work by the owner. Damage incurred to existing conditions to remain are to be returned to their original condition. 12. During the construction period, the premises shall be kept free from accumulations of waste materials or
- rubbish, and the Work shall be made broom clean from time to time. At the completion of the Work, all glass, floors, plumbing fixtures, etc., shall be left clean and free from debris, rubbish and miscellaneous
- 13. General Contractor and any subcontractors shall guarantee all work installed by him for a period of one (1) year from the date of final completion of the Work. The General Contractor and subcontractors agree that during the guarantee period, any defective work, and any other work damaged thereby, shall be replaced promptly and properly without cost to the Owner or Architect.

Project Code Summary

Los Altos, CA 94024 336-44-039 Small addition on Main Level Addition at Upper Level at existing deck California Residential Code

904 Madonna Way

California Building Code (for structural design where applicable) California Plumbing Code California Mechanical Code California Electrical Code California Energy Code California Green Building Code California Fire Code California Reference Standards Code

Building Occupancy Group

Type of Construction

Fire Protection Automatic Sprinklers

Project Address

Not required Smoke/CO Detectors Smoke detectors are required in all existing and new sleeping rooms. Smoke/CO detectors are required at adjoining halls,

> and every level. Detectors shall be hard wired with battery backup and interconnected to act as one device.

Project Data

Project Address

Net Lot Area

Softscape

	Los Altos, C	A 94024	
APN	336-44-039		
Zone	R1-H		
Lot Area	22,709 SF		
Coverage	<u>Existing</u>	<u>Proposed</u>	<u> Allowed/Required</u>
<u>House</u> Total	<u>2,759</u> 2,759	<u>2,784</u> 2,784	22,790 x .25 = 5,677.25 sf
iotai	2,733	2,764	22,790 x .23 - 3,077.23 SI
Floor Area	<u>Existing</u>	Proposed	Allowed/Required
Garage Level Floor Area	594.5	594.5	
Main Level Floor Area	2,506.0	2,531.3	
Upper Level Floo Area	<u>1,514.1</u>	1,646.0	
Total Floor Area	4,614.6	4,771.8	3850 + 10%*(22,790 -11,000)= 5,029 st
Setbacks			
Front	32-7	32-7 NC	30-0
Rear	37-11	37-11 NC	50-0
Right Side - First	25-1	25-1 NC	25-0
Right Side - Second	25-1	25-1 NC	25-0
Left Side - First	40-1	40-1 NC	25-0
Left Side - Second	41-6	41-6 NC	25-0
Height -maximum	26-8	26-8 NC	27-0
Square Footage Breakdown			
- 4	4 000 4	+157.2	4,177.3
Habital	4,020.1	+157.2	4,177.3

Existing to remain unchanged - covered

All grades to remain existing - no change

22,709

no change

904 Madonna Way

Project Directory

Index of Drawings

A-1.2 Neighborhood Context Map & Photos

A-2.1 Existing Lower & Main Level Plan

A-3.0 New Main & Upper Level Plans

A-4.0 Front-North Exterior Elevations

A-4.3 Existing South & East Exterior Elevations

A-4.2 Side-West Exterior Elevation

A-2.2 Existing Upper Level Plan

G-1.0 General Information

A-1.0 Site Plan

A-4.4 Sections

A-1.3 Area Diagrams

PROJECT ADDRESS 904 Madonna Way Los Altos, CA 94024

Bernie & Ditza Recht 904 Madonna Way Los Altos, CA 94024 Home: (650) 948-5490


Mobile: (650) 380-1370 Ditza Other: (650) 380-1371 Bernie E-mail: rechtmd@aol.com

BUILDING DEPARTMENT City of Los Altos 1 N San Antonio Rd

Los Altos, CA 94022 (650) 858-3390 **ARCHITECT**

Fred Blome - Blome Architecture 719 Regal Court Menlo Park, CA 94025 (650) 325-5443 / Fax (650) 322-3363

fred@blomearchitecture.com

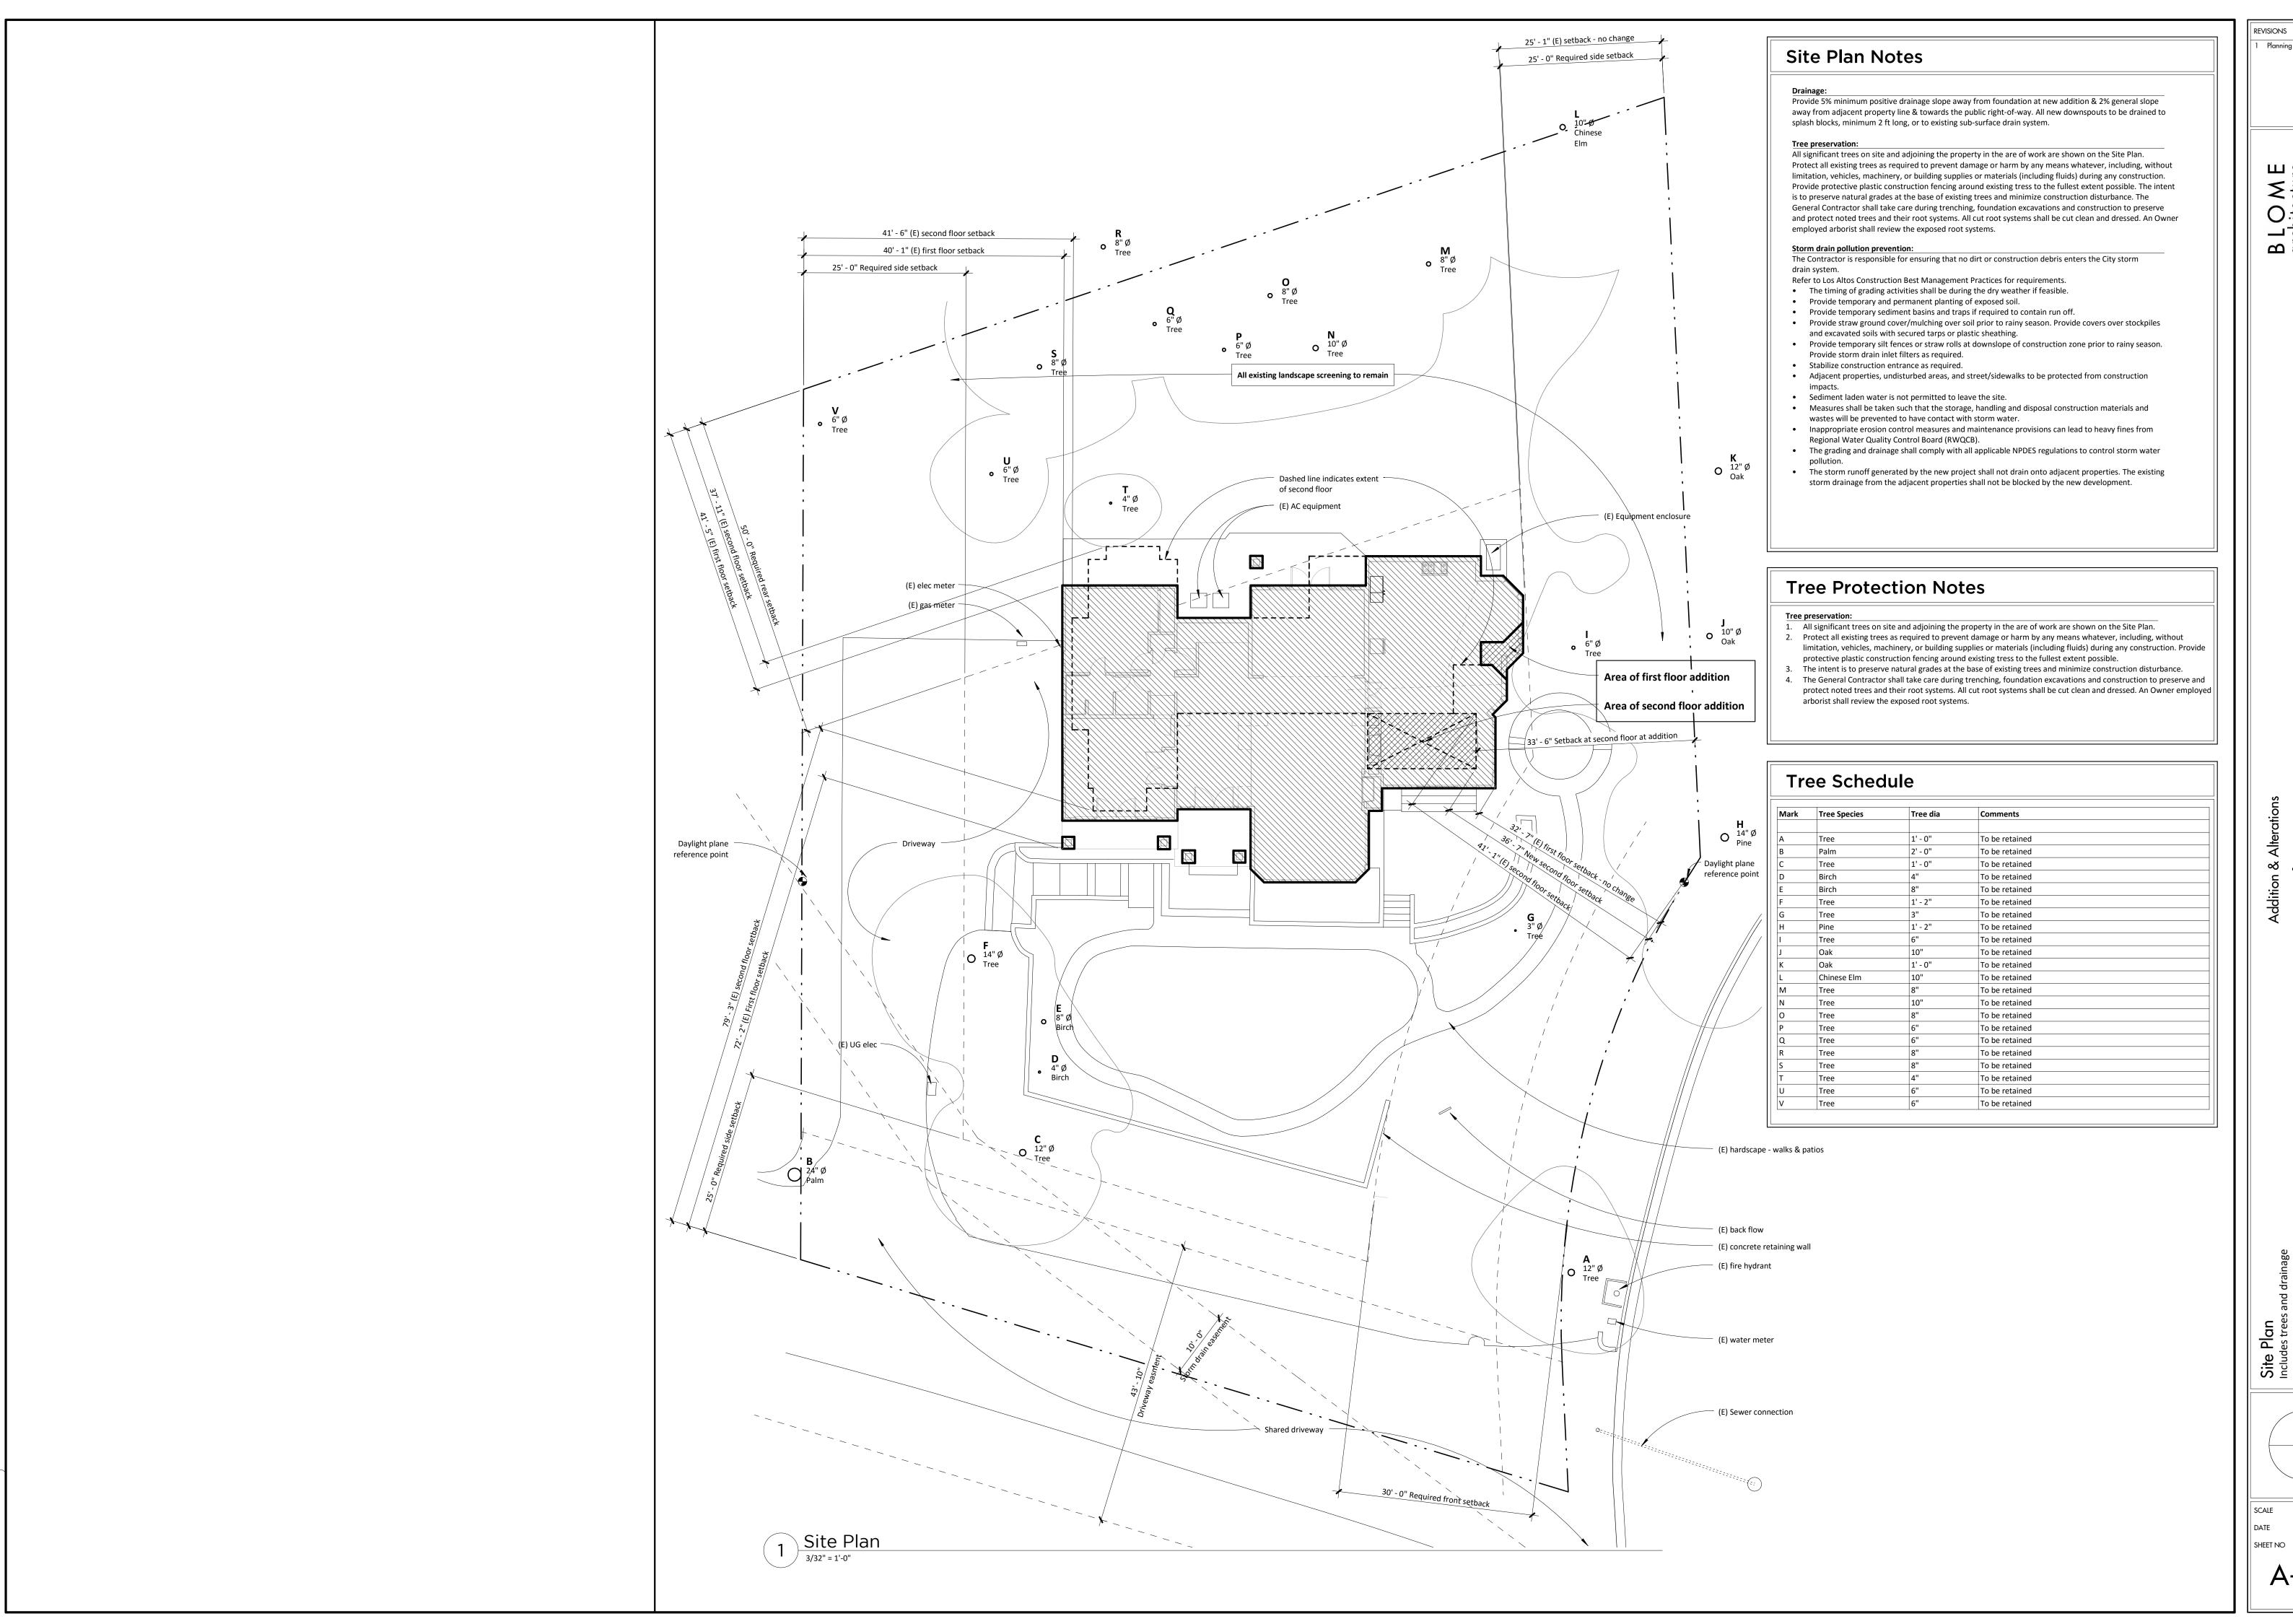

ше **B**

nna Mador Altos, Ca 904


As indicated 7/15/2016 SHEET NO

View to the North from the existing second floor deck, at new window of Exercise Room





View to the West from the existing second floor deck, at new window of Exercise Room




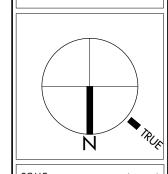

A-1.2

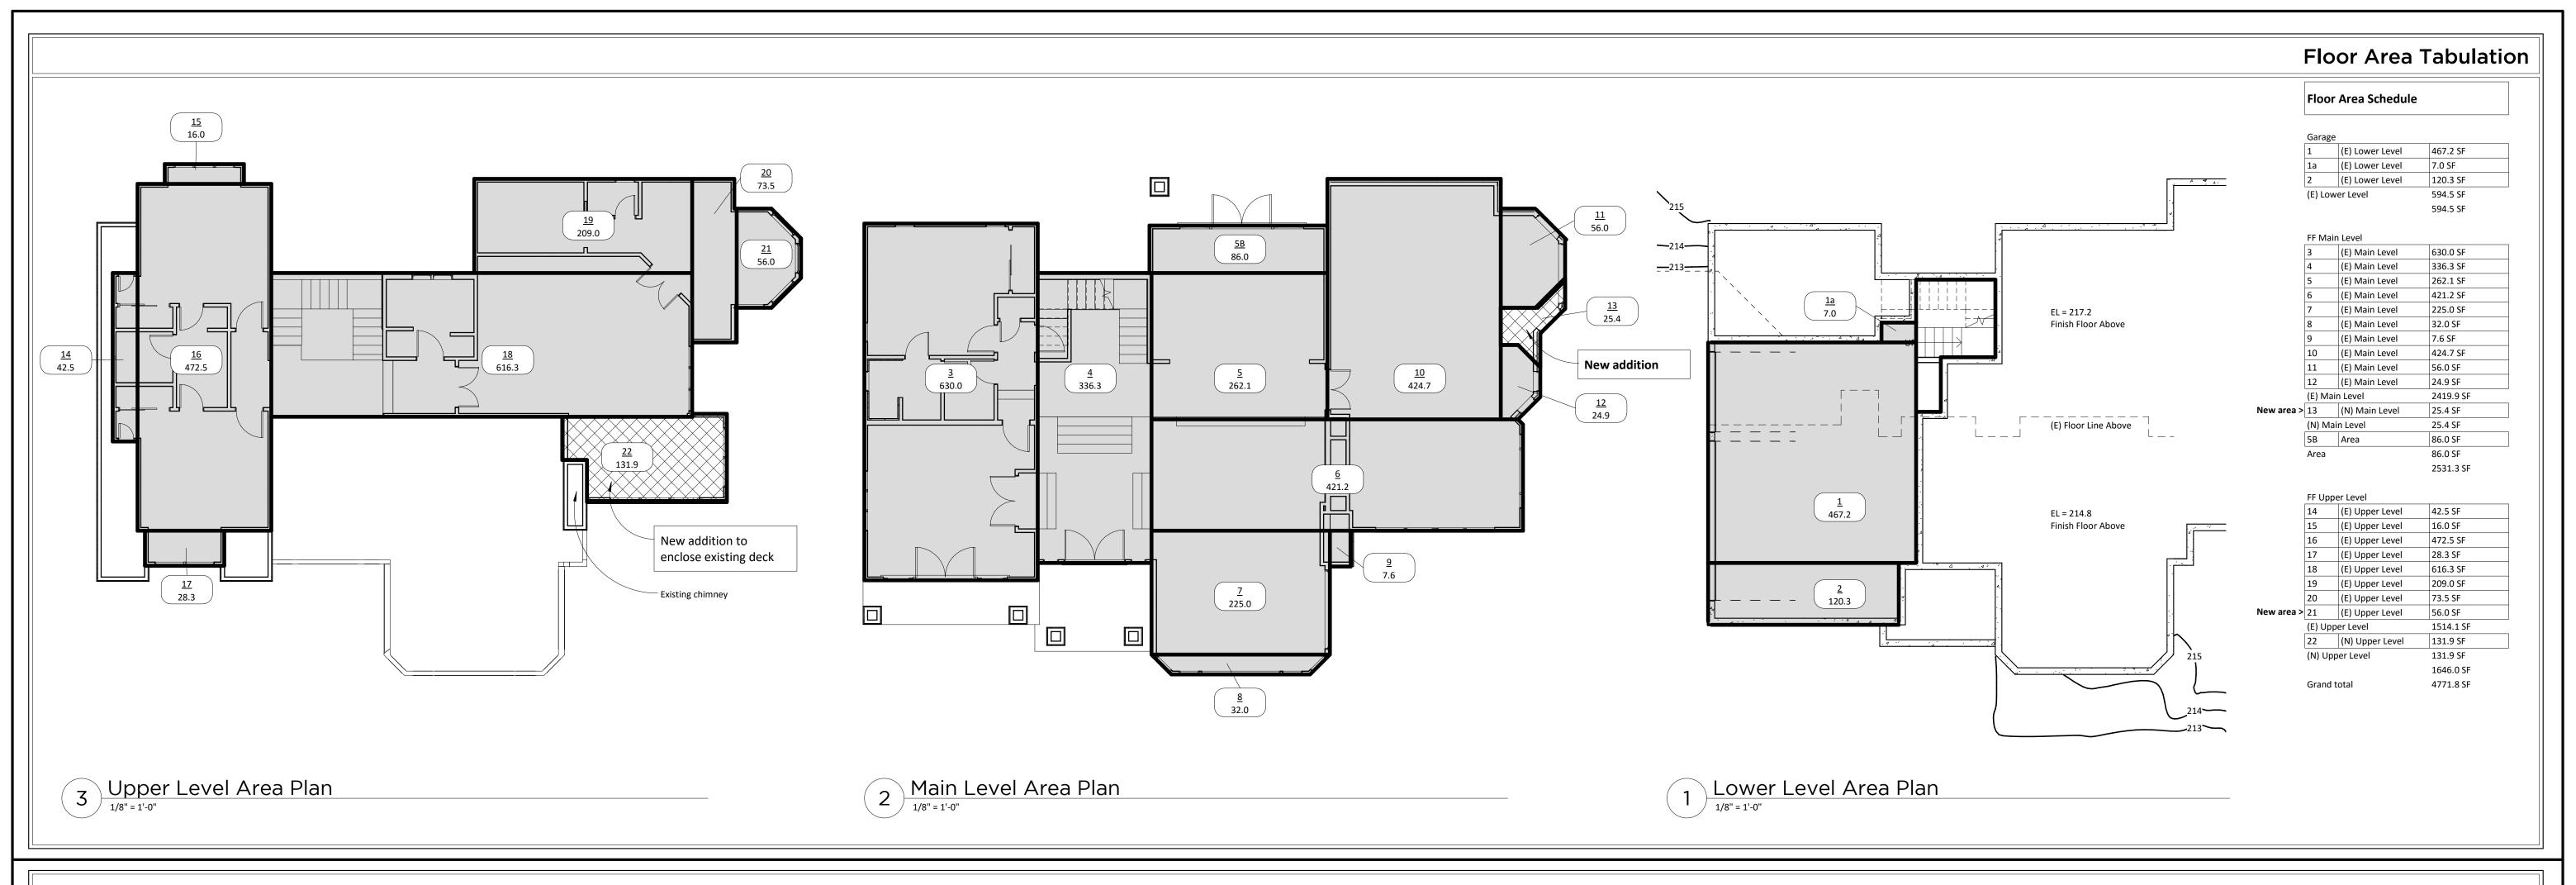


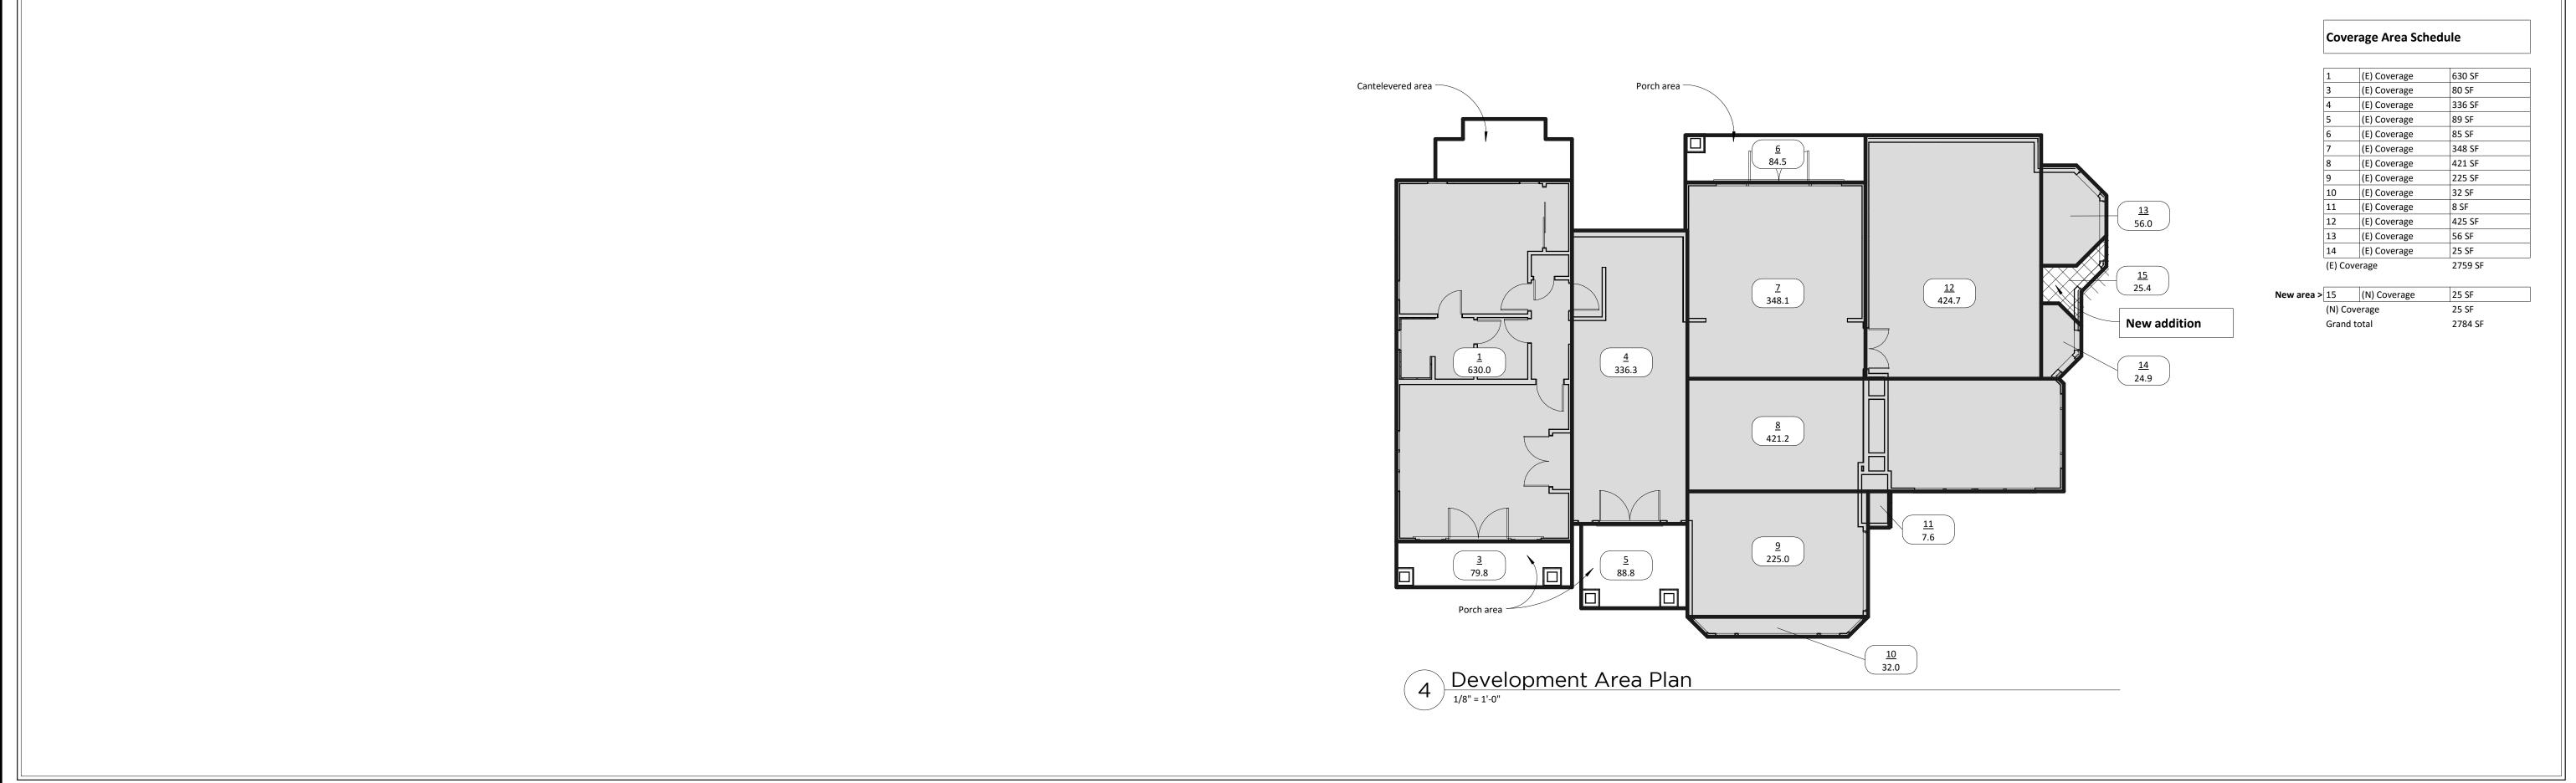

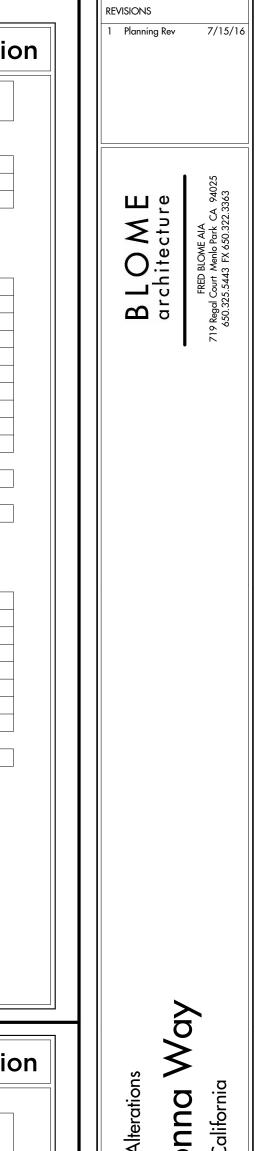


Coverage Area Tabulation

Mador Los Altos, Co 904

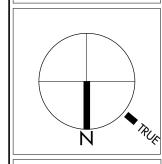

DATE 7/15/2016 SHEET NO

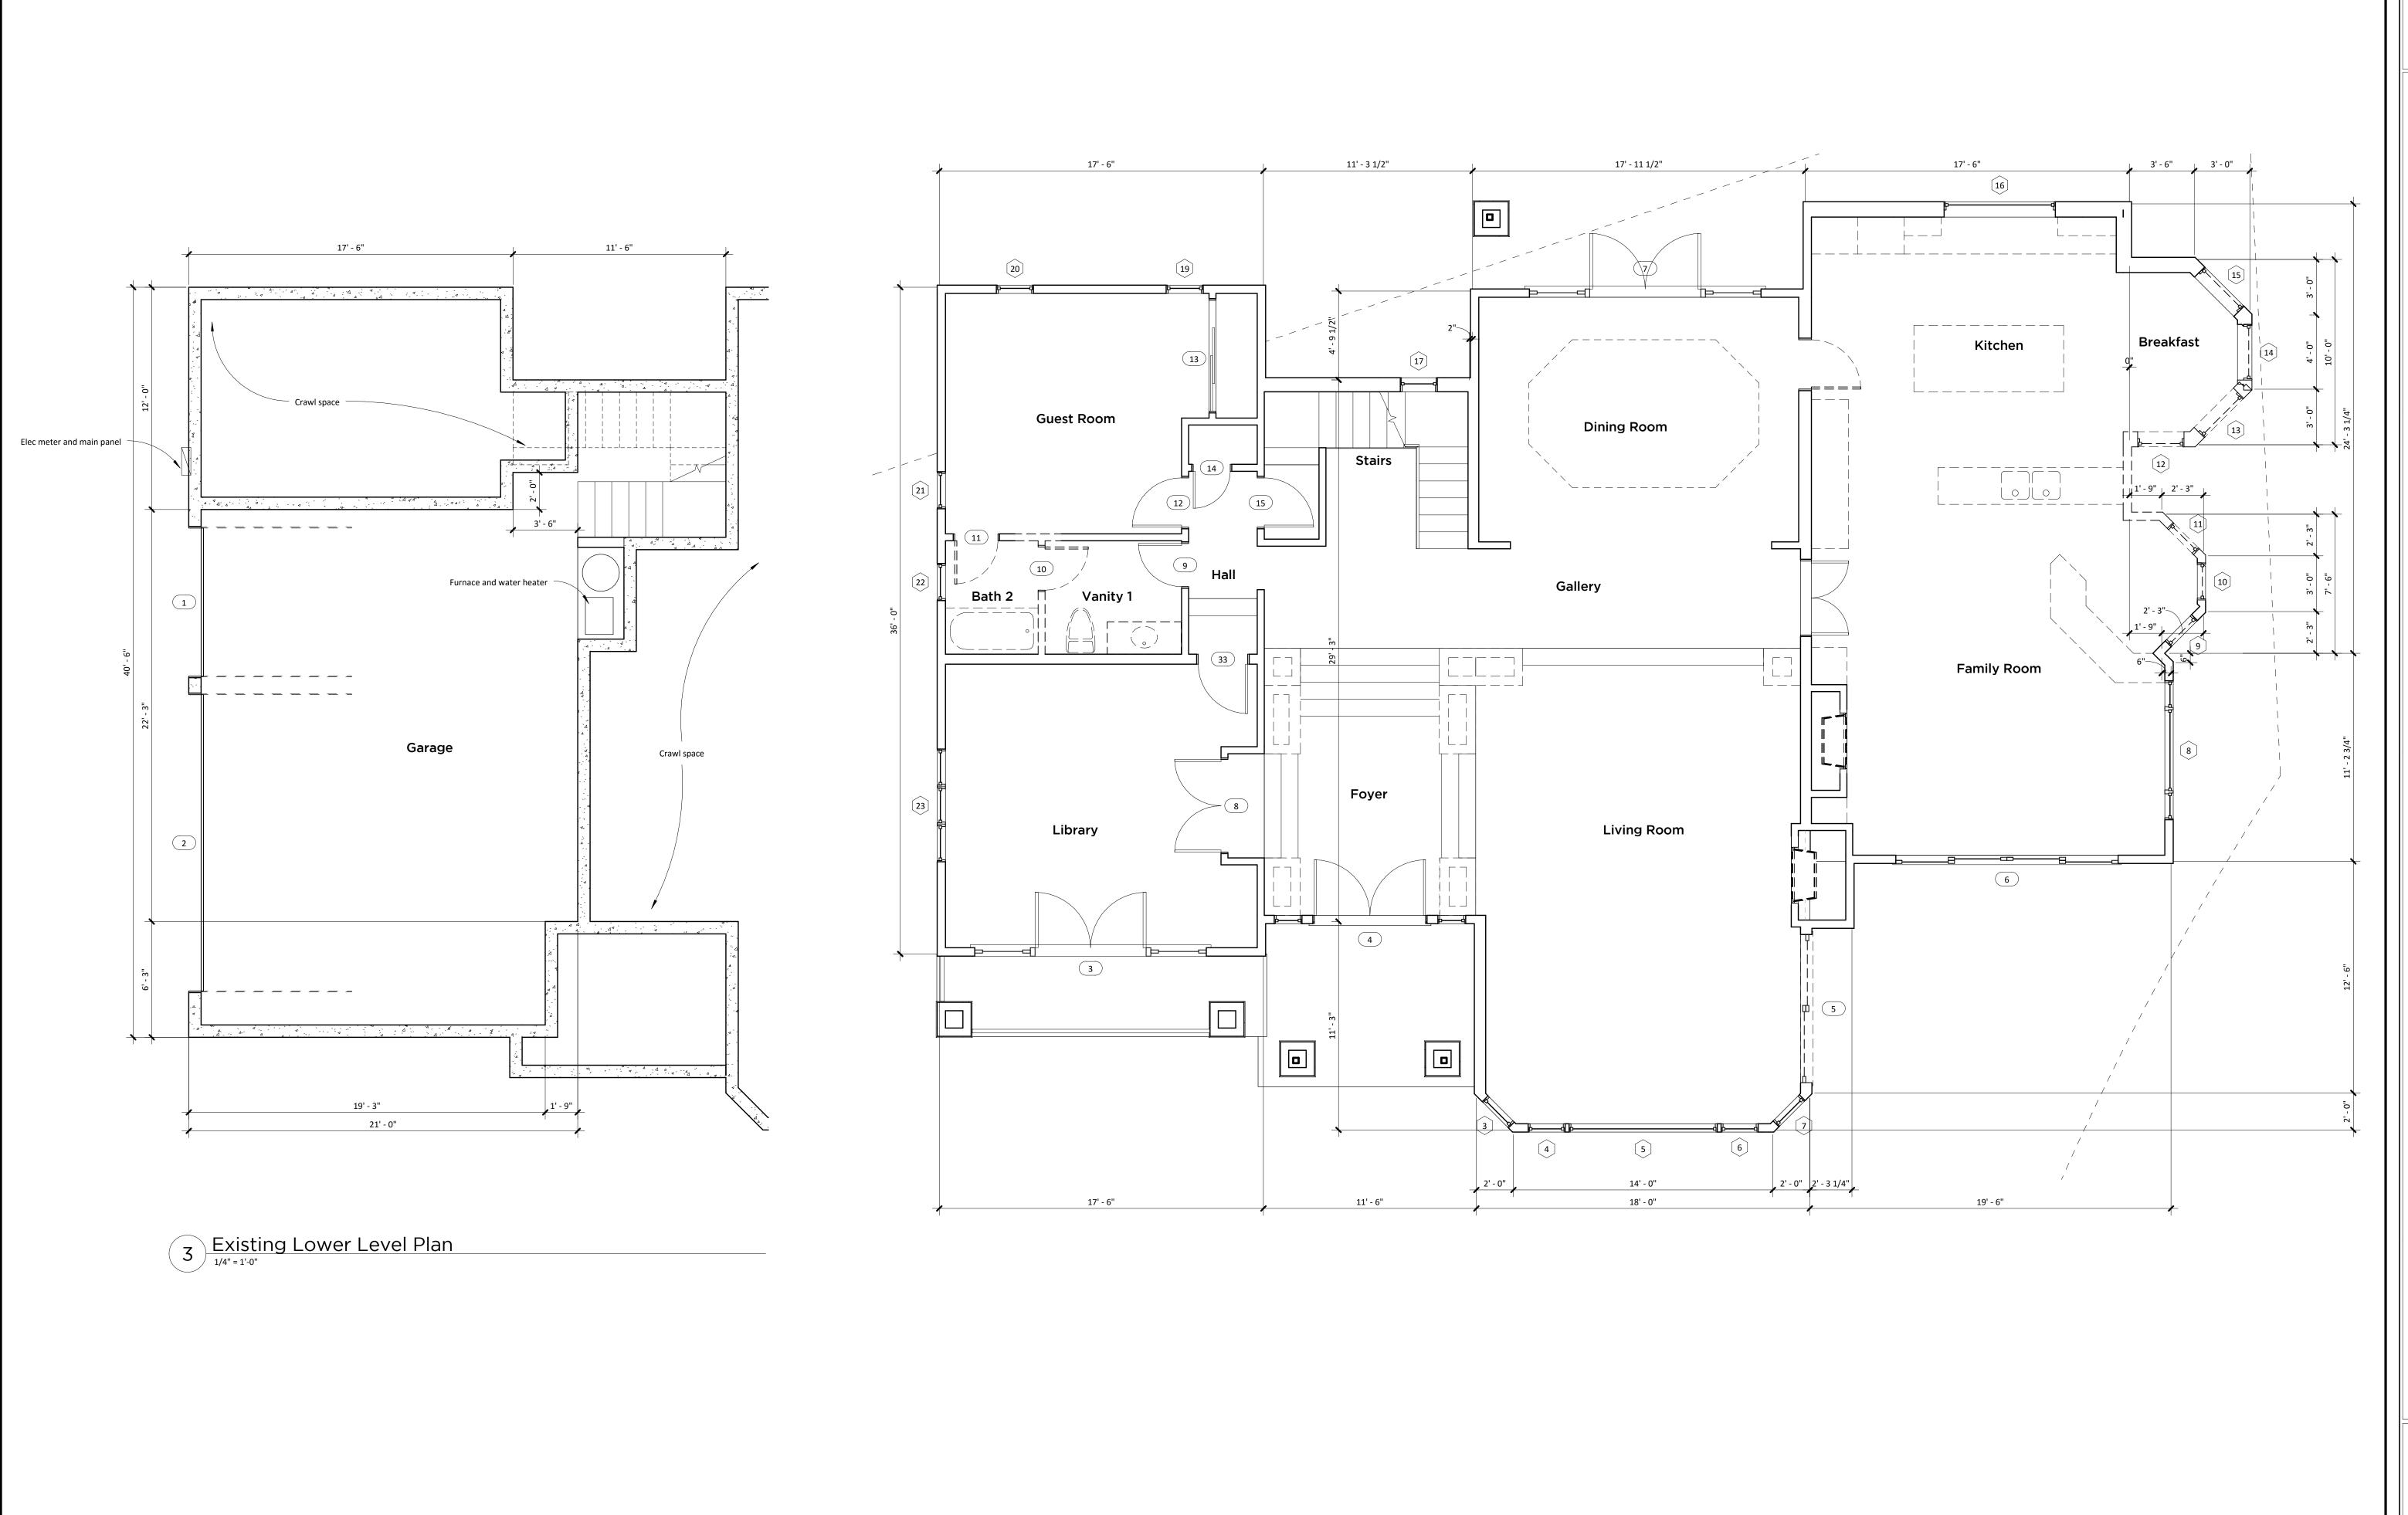


BLOME architecture

904 Mador Los Altos, Ca

7/15/2016 SHEET NO


A-2.1

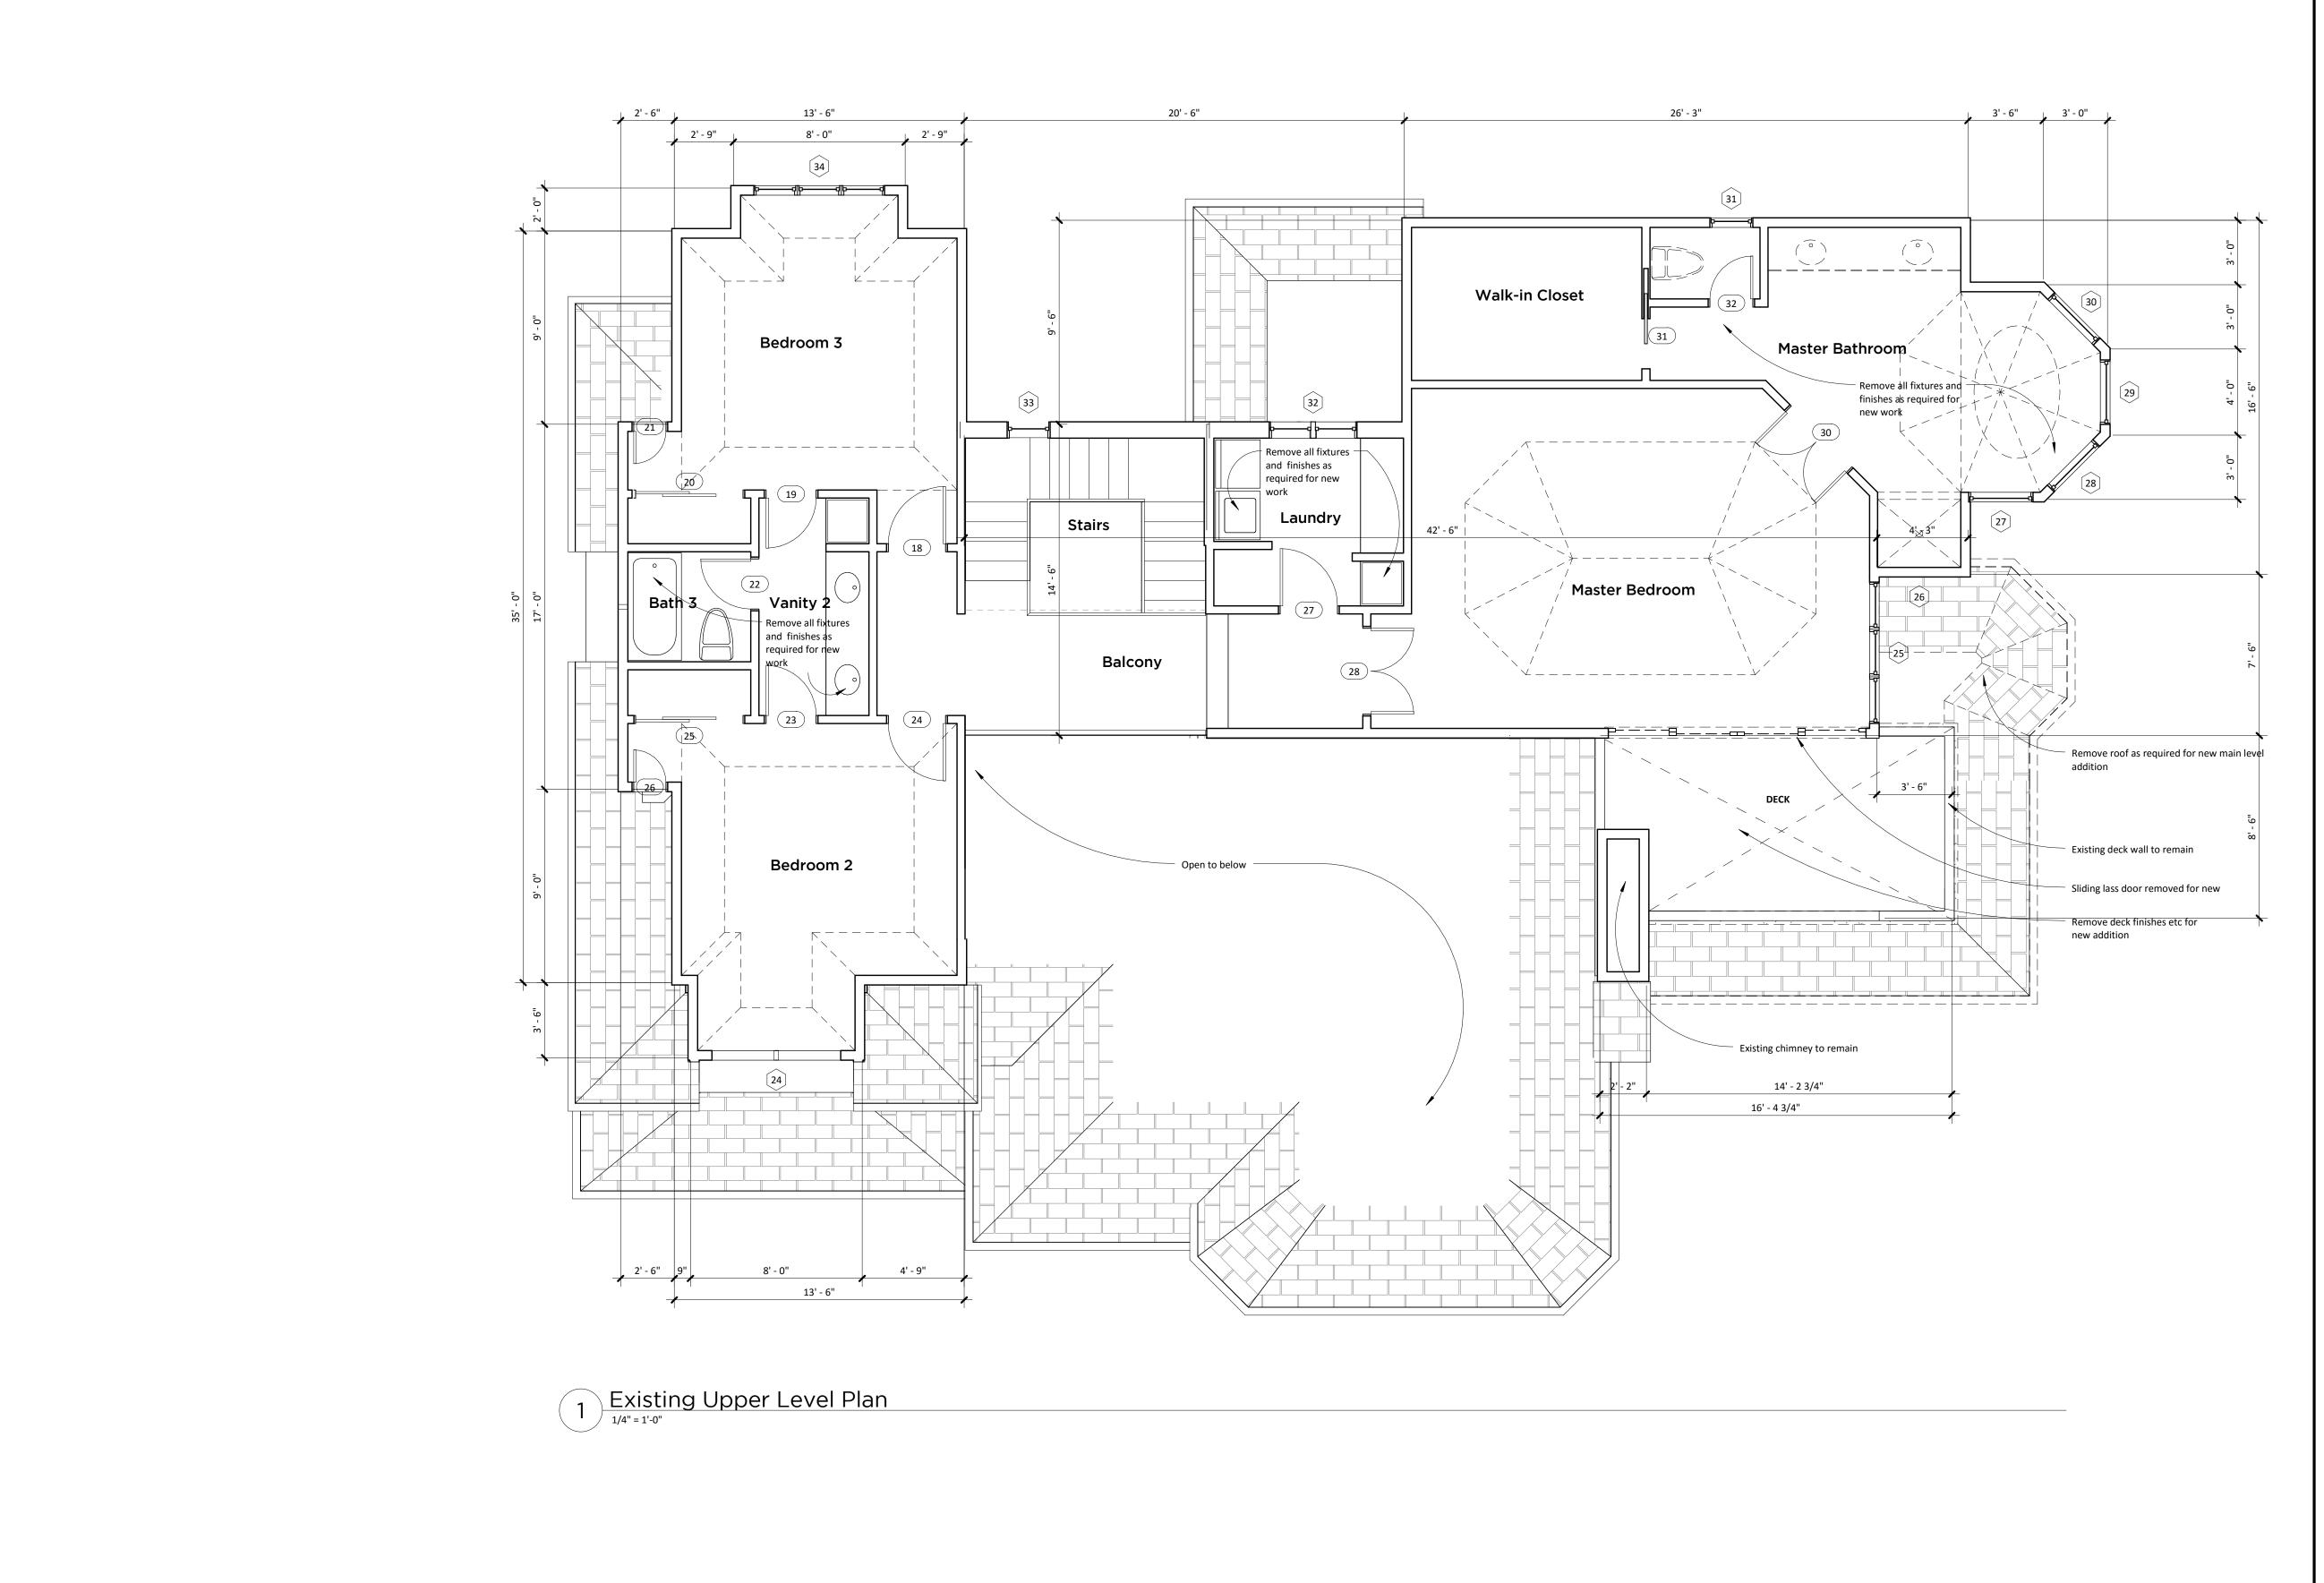


904 Madonna Los Altos, California


DATE 7/15/2016 SHEET NO

A-2.2

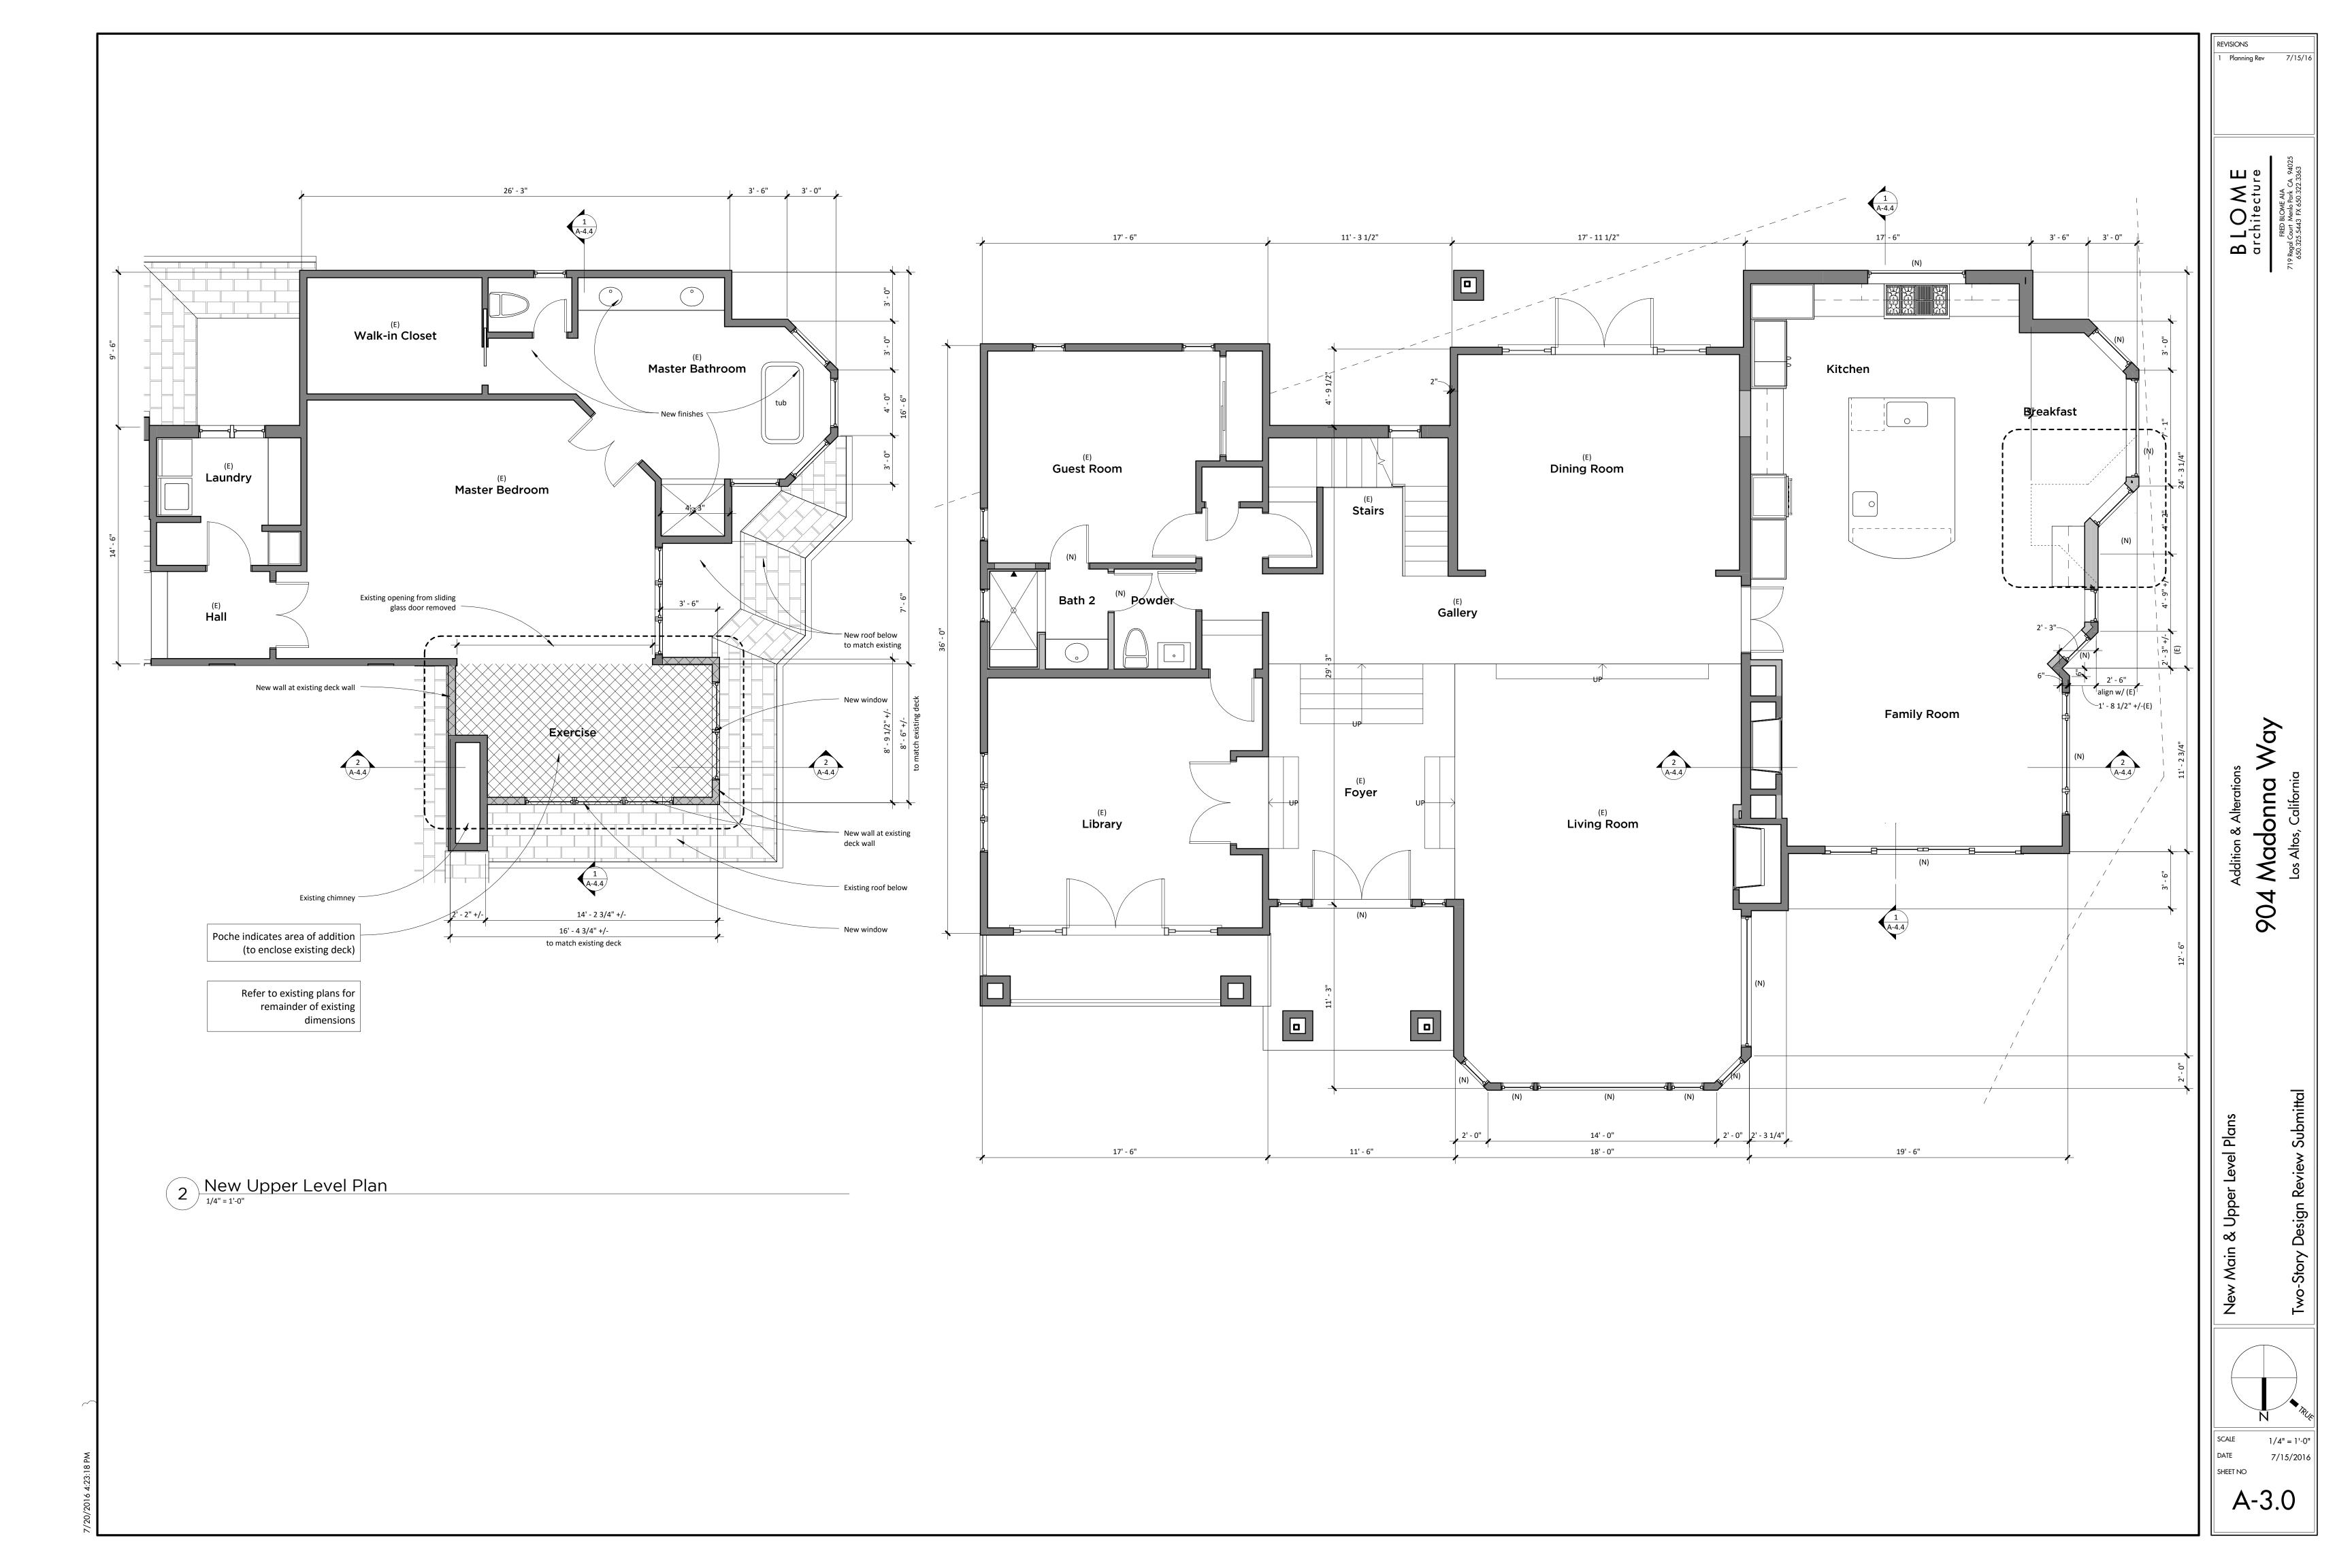

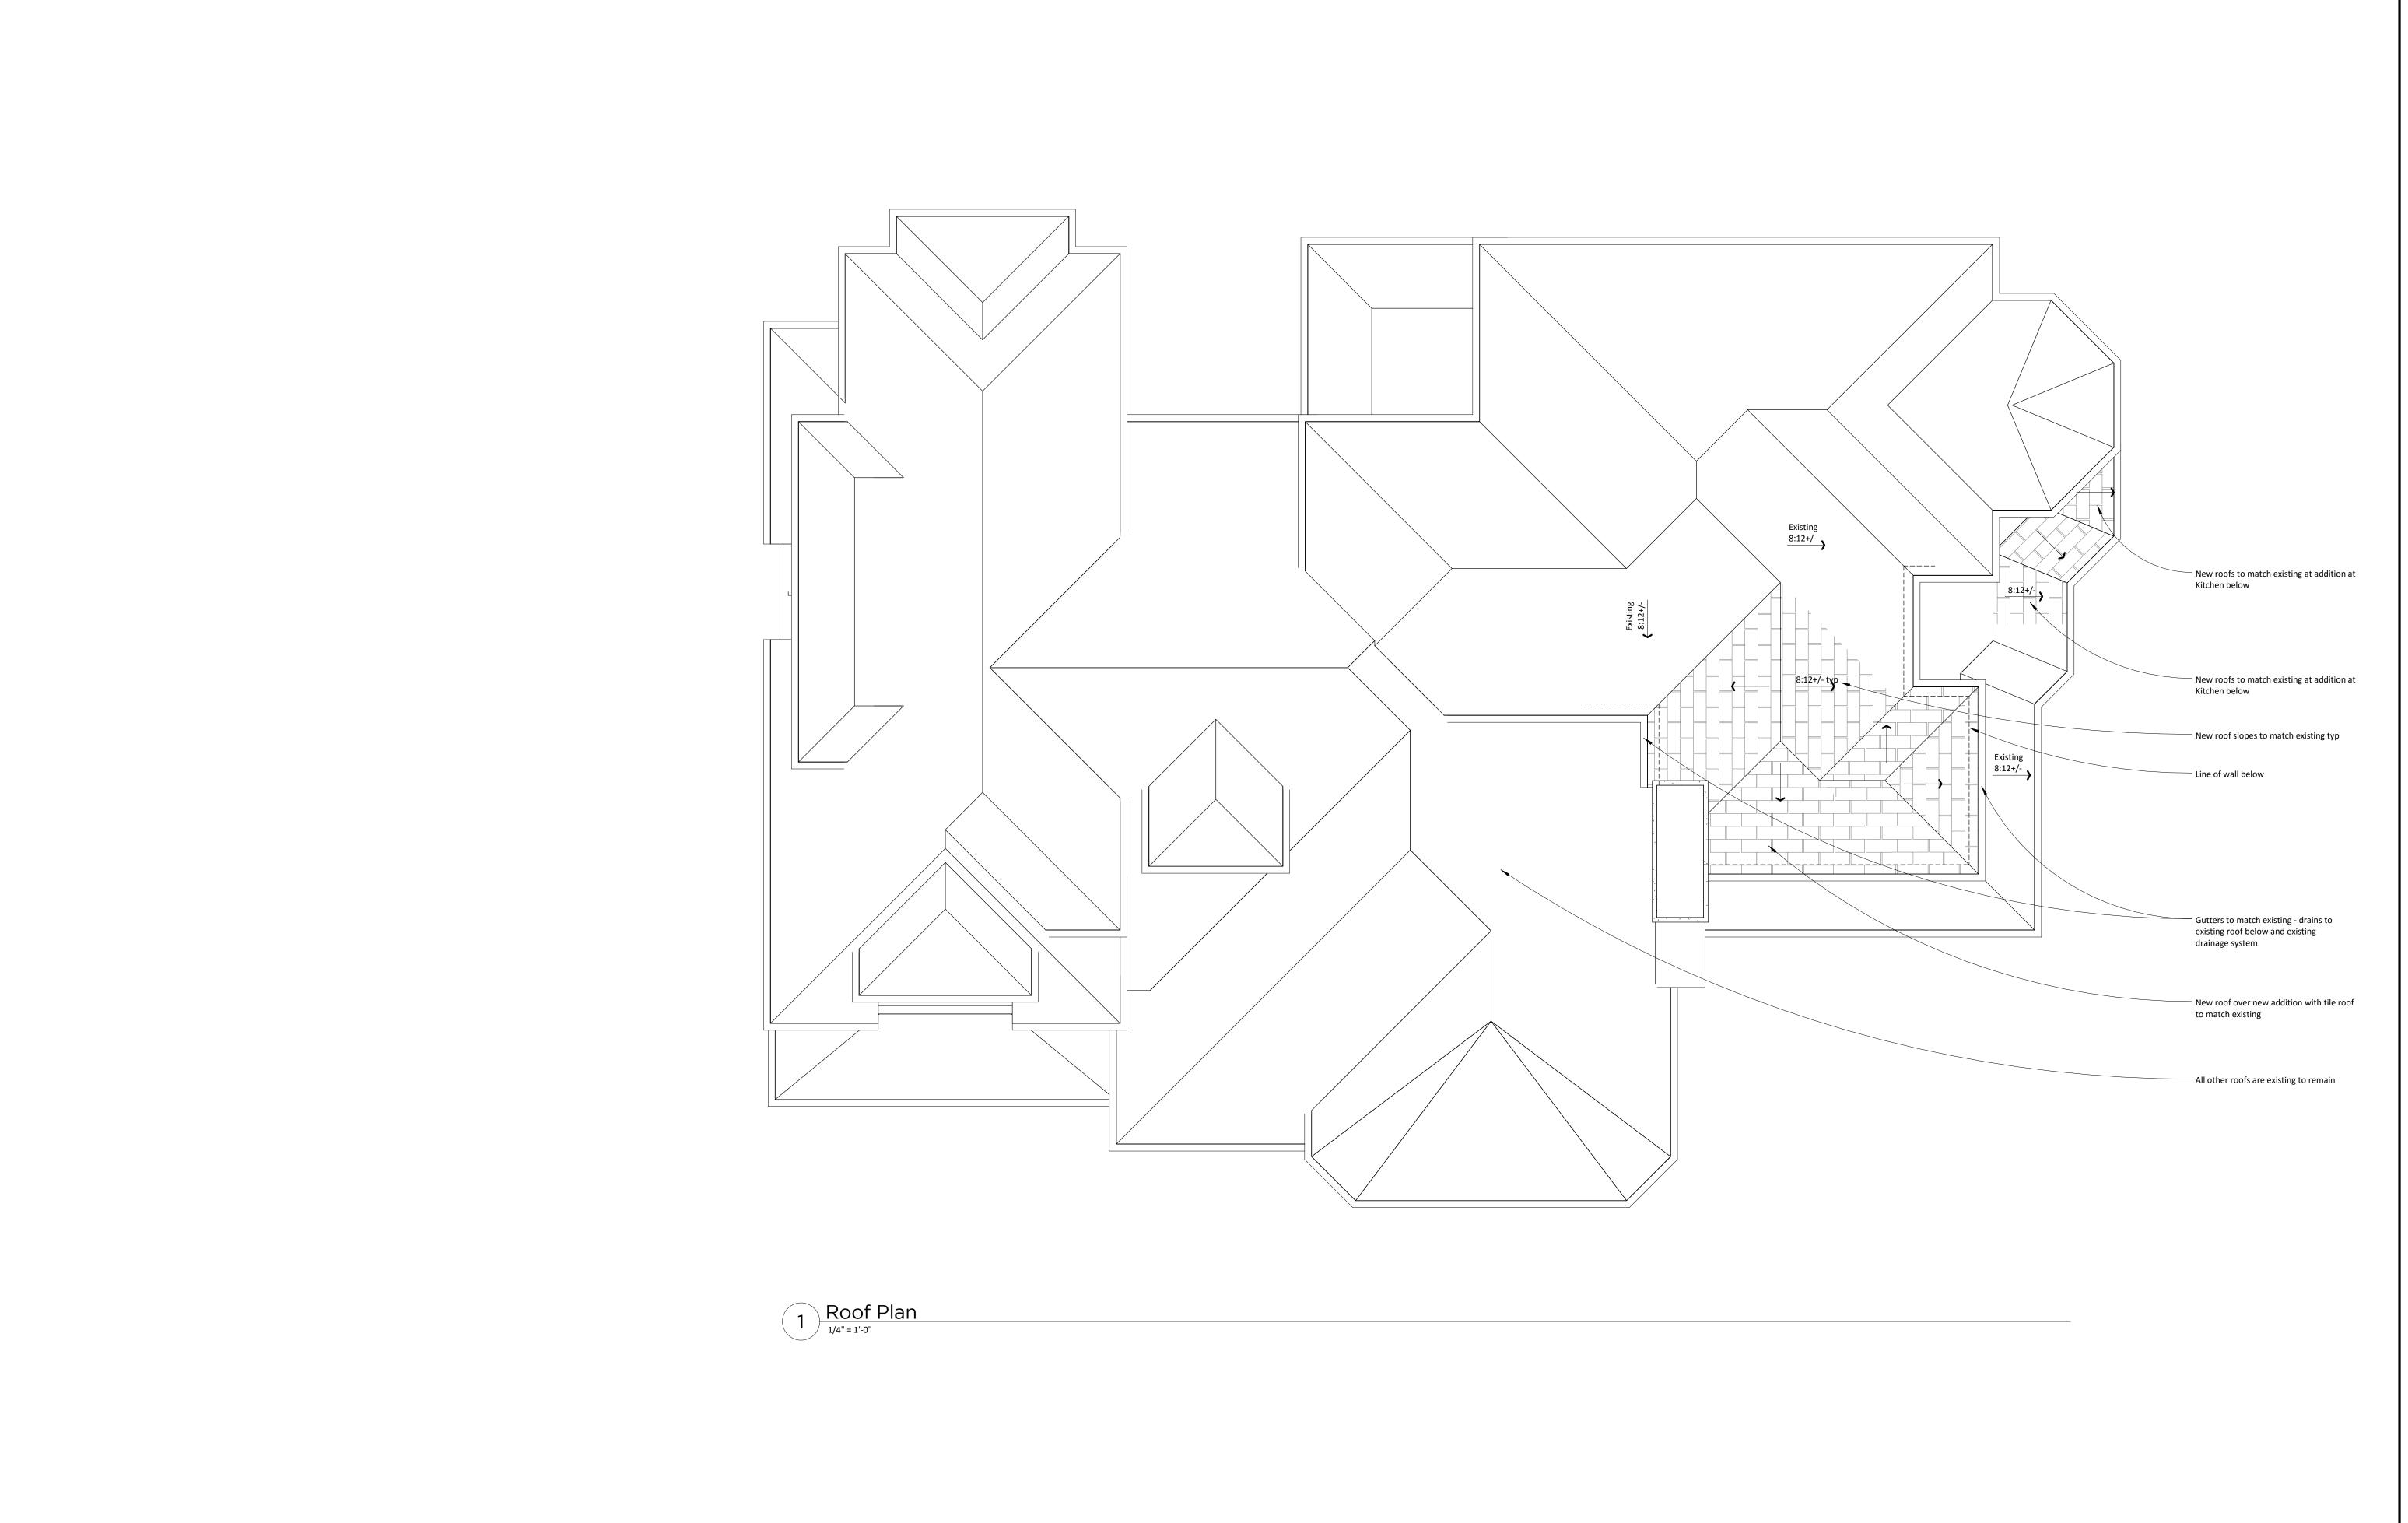


nna Way Salifornia 904 Mador Los Altos, Ca

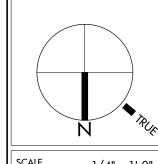

1/4" = 1'-0" DATE 7/15/2016 SHEET NO

A-3.2

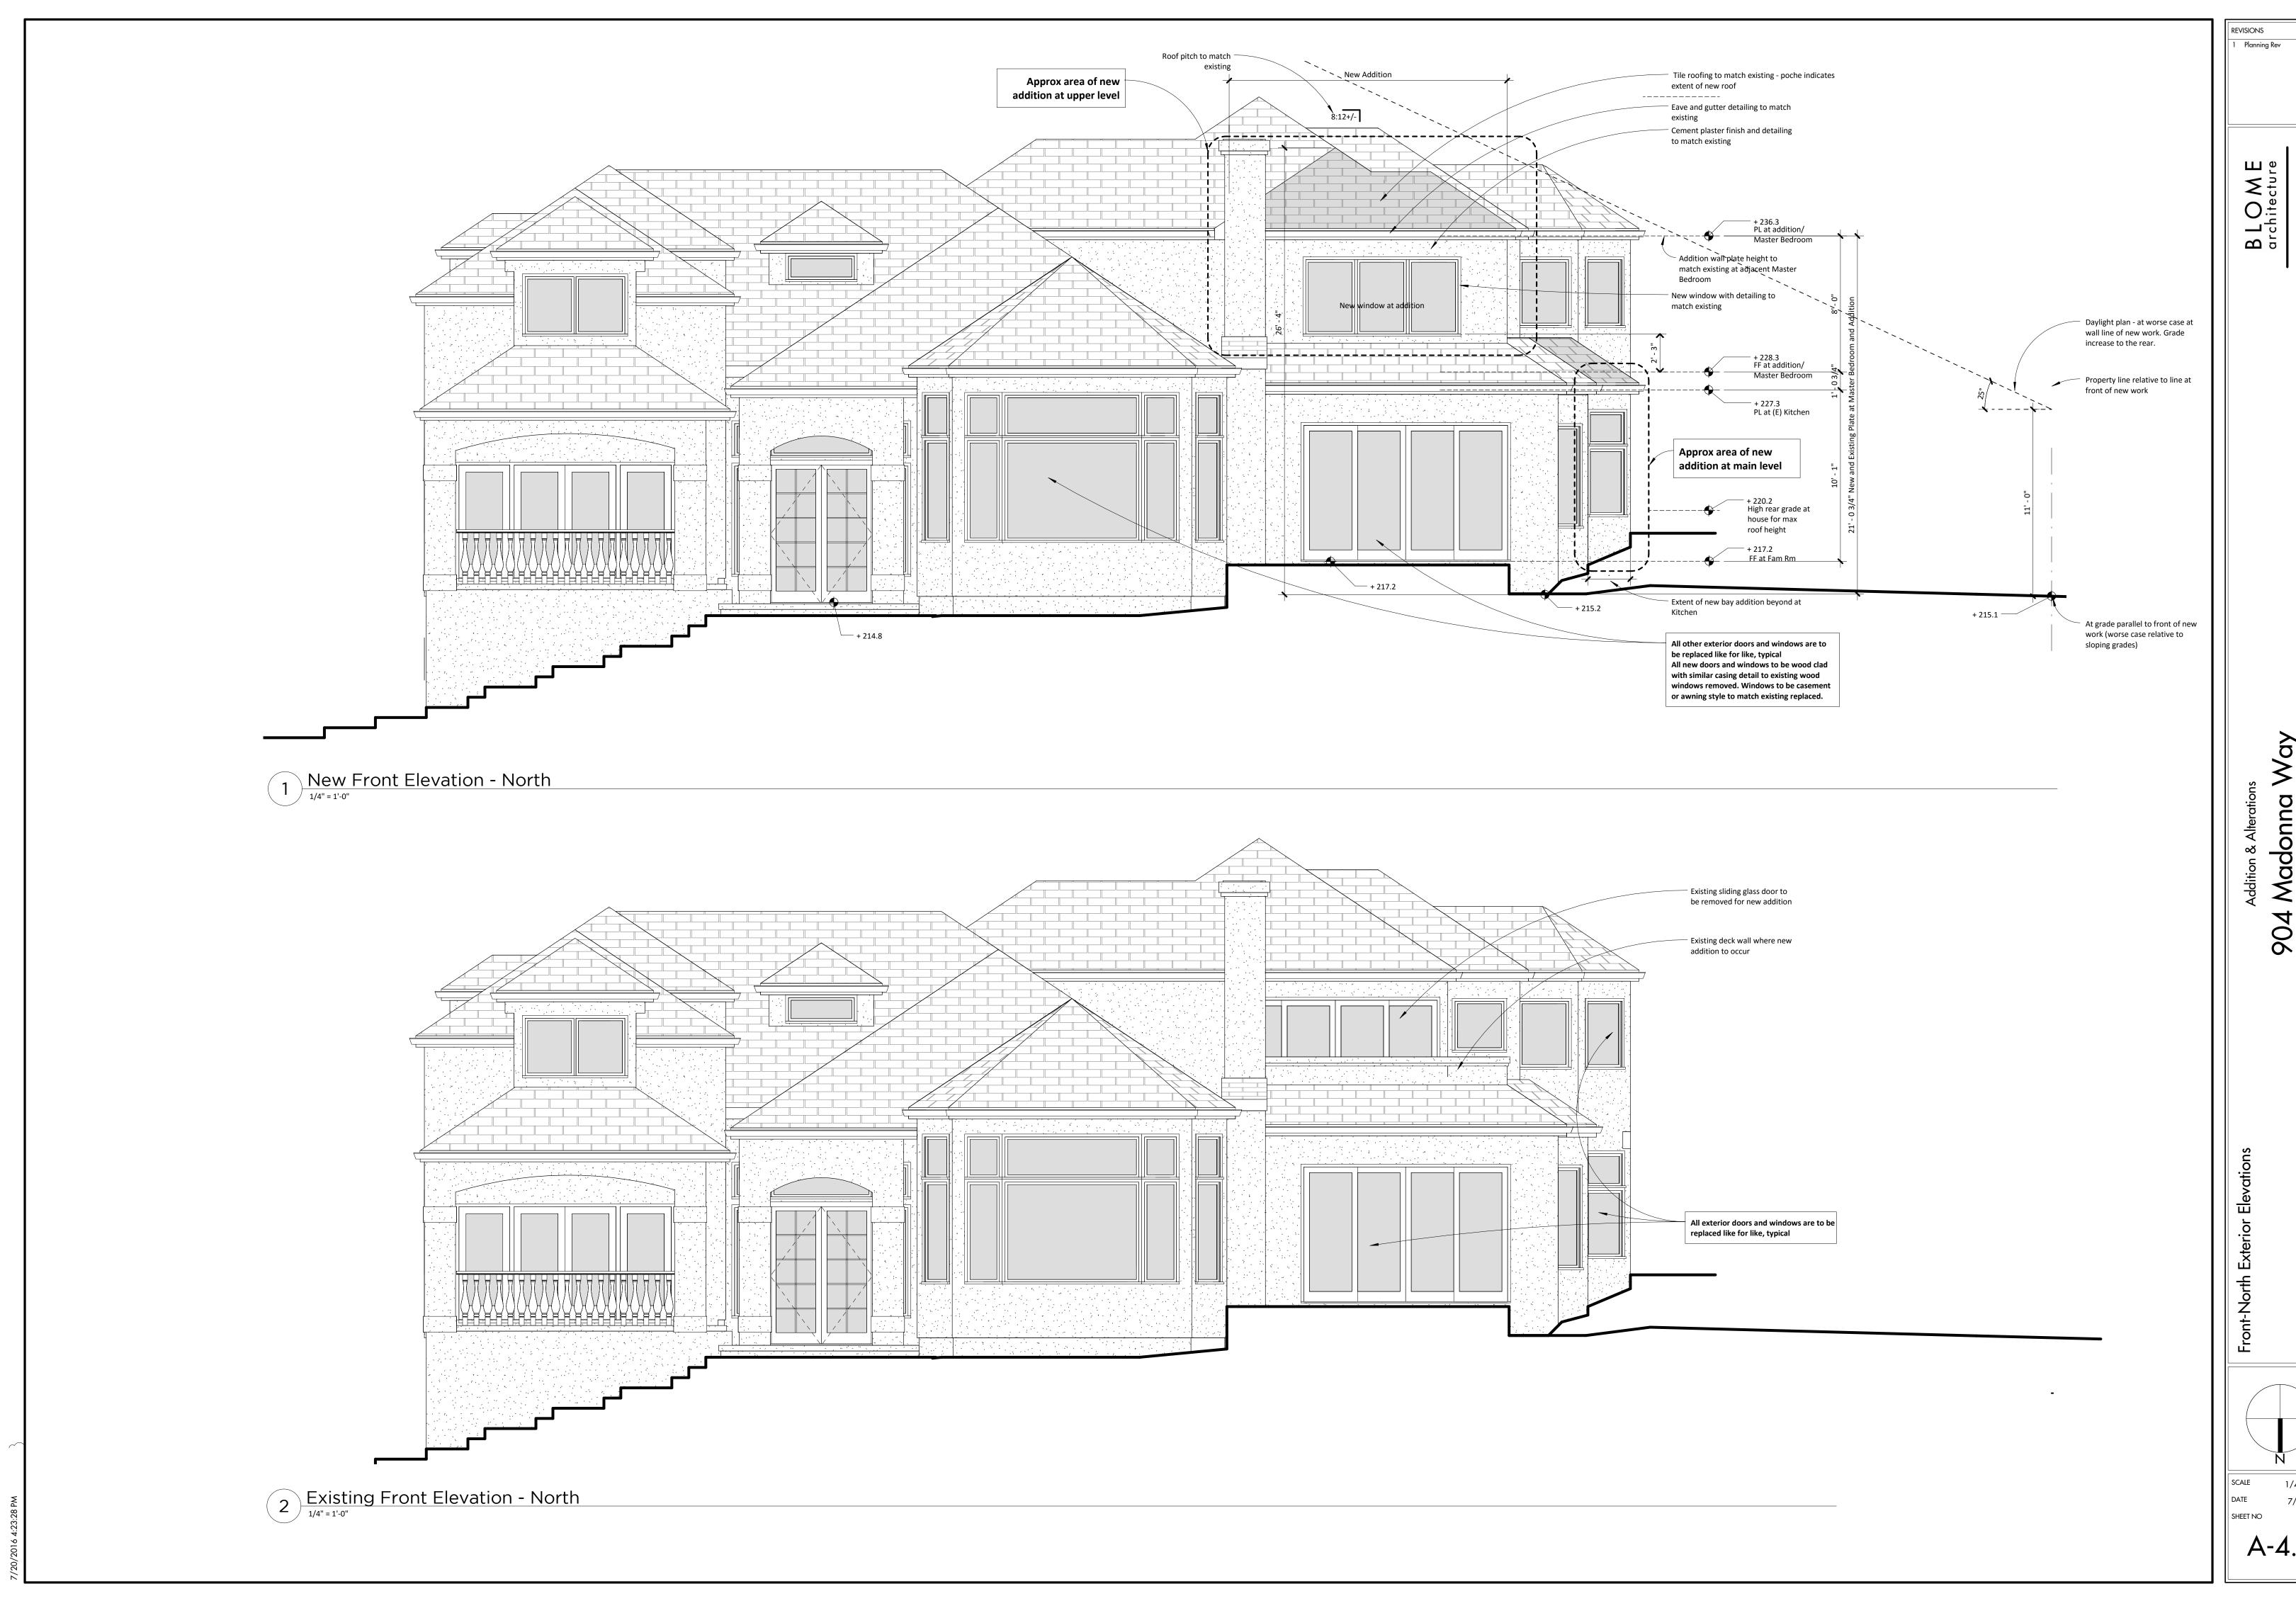

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Way nna alifornia Mador
Los Altos, Co

1/4" = 1'-0" 7/15/2016

New Side Elevation - West

1/4" = 1'-0"




2 Existing Side Elevation - West


Planning Rev 7/15/16

nna Way Salifornia 904 Mador Los Altos, Ca


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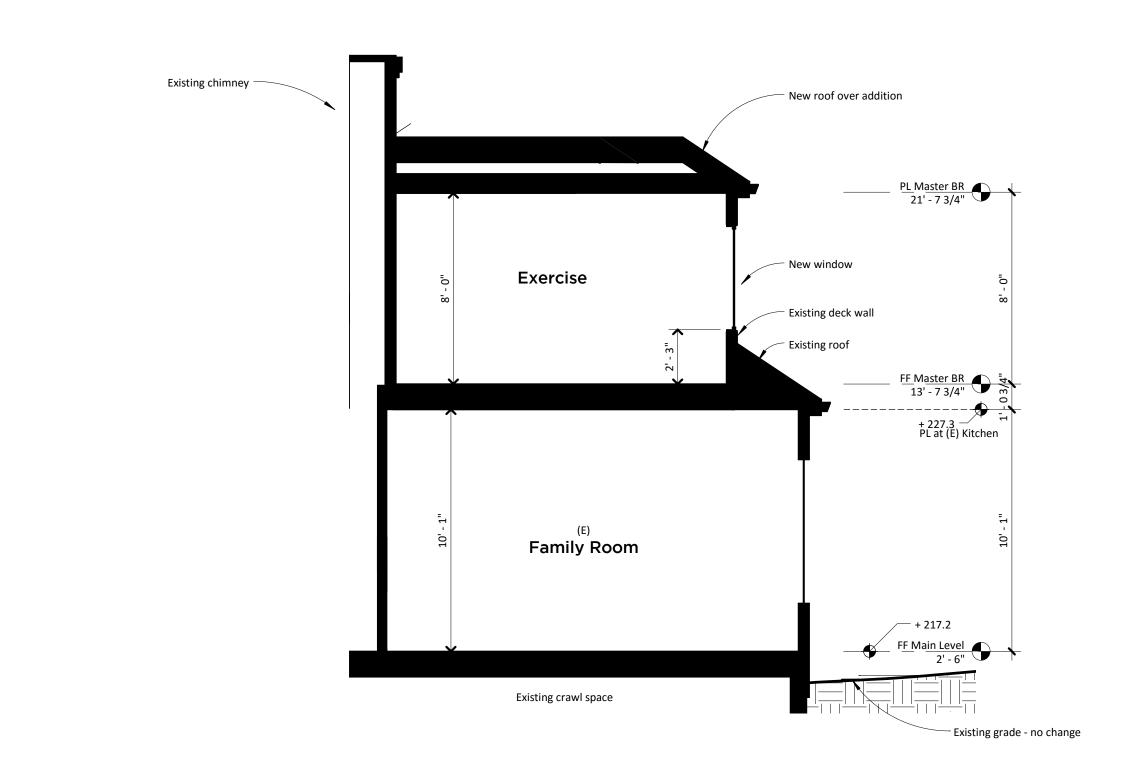
904 Madon Los Altos, Ca

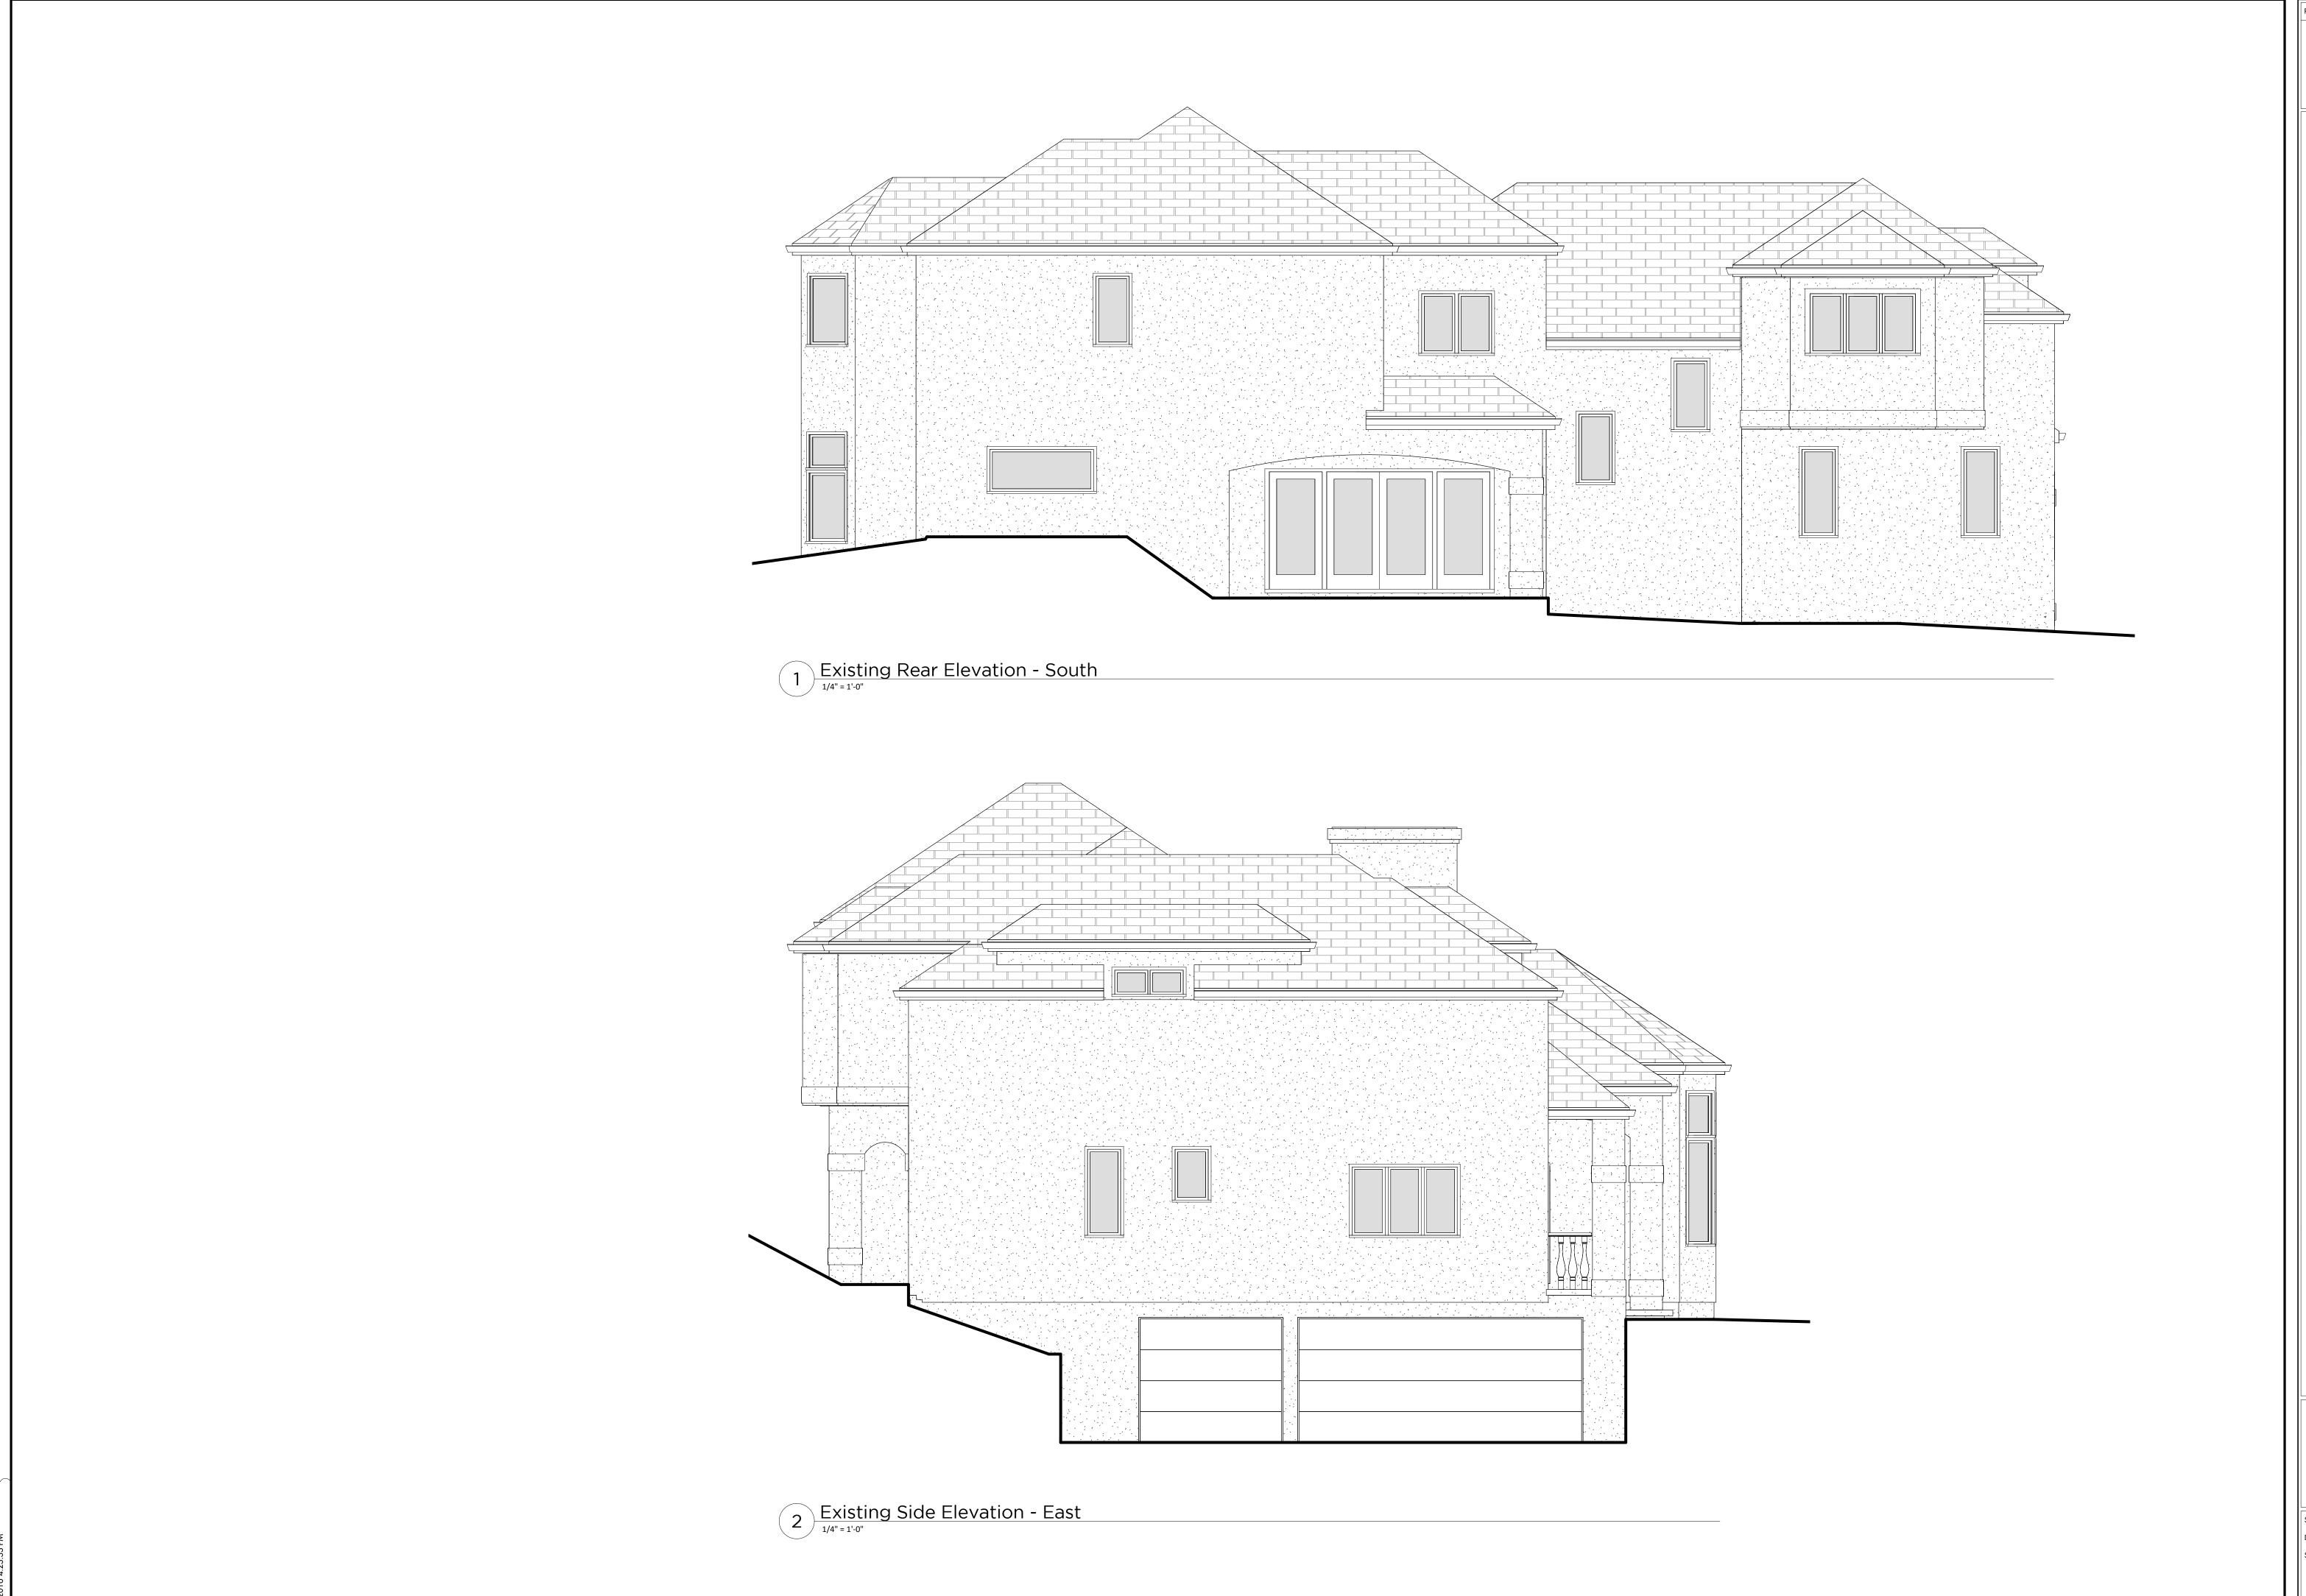

7/15/2016 SHEET NO

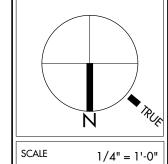

1 Cross Section 1

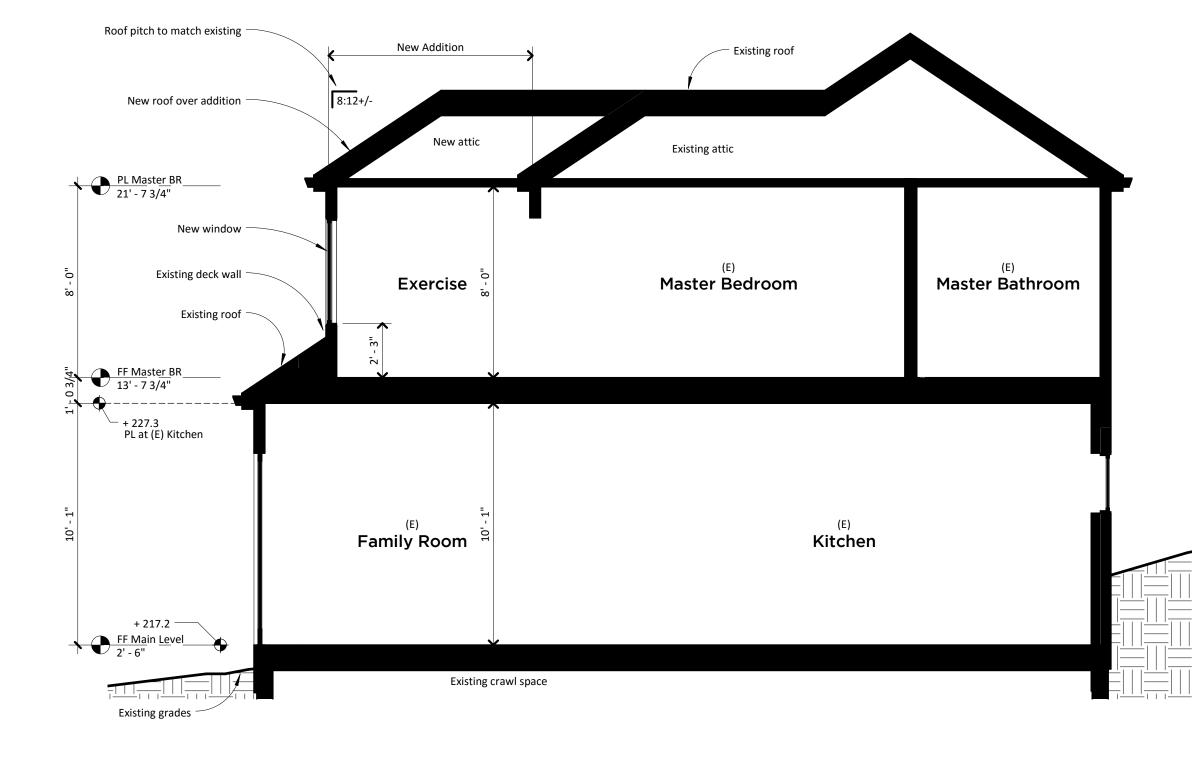

2 Cross Section 2

REVISIONS
1 Planning Rev 7/15/16

BLOME architecture

Addition & Alterations
904 Madonna Way
Los Altos, California

o-Story Design Review Subr

SCALE 1/4" = 1'-0"
DATE 7/15/2016
SHEET NO

