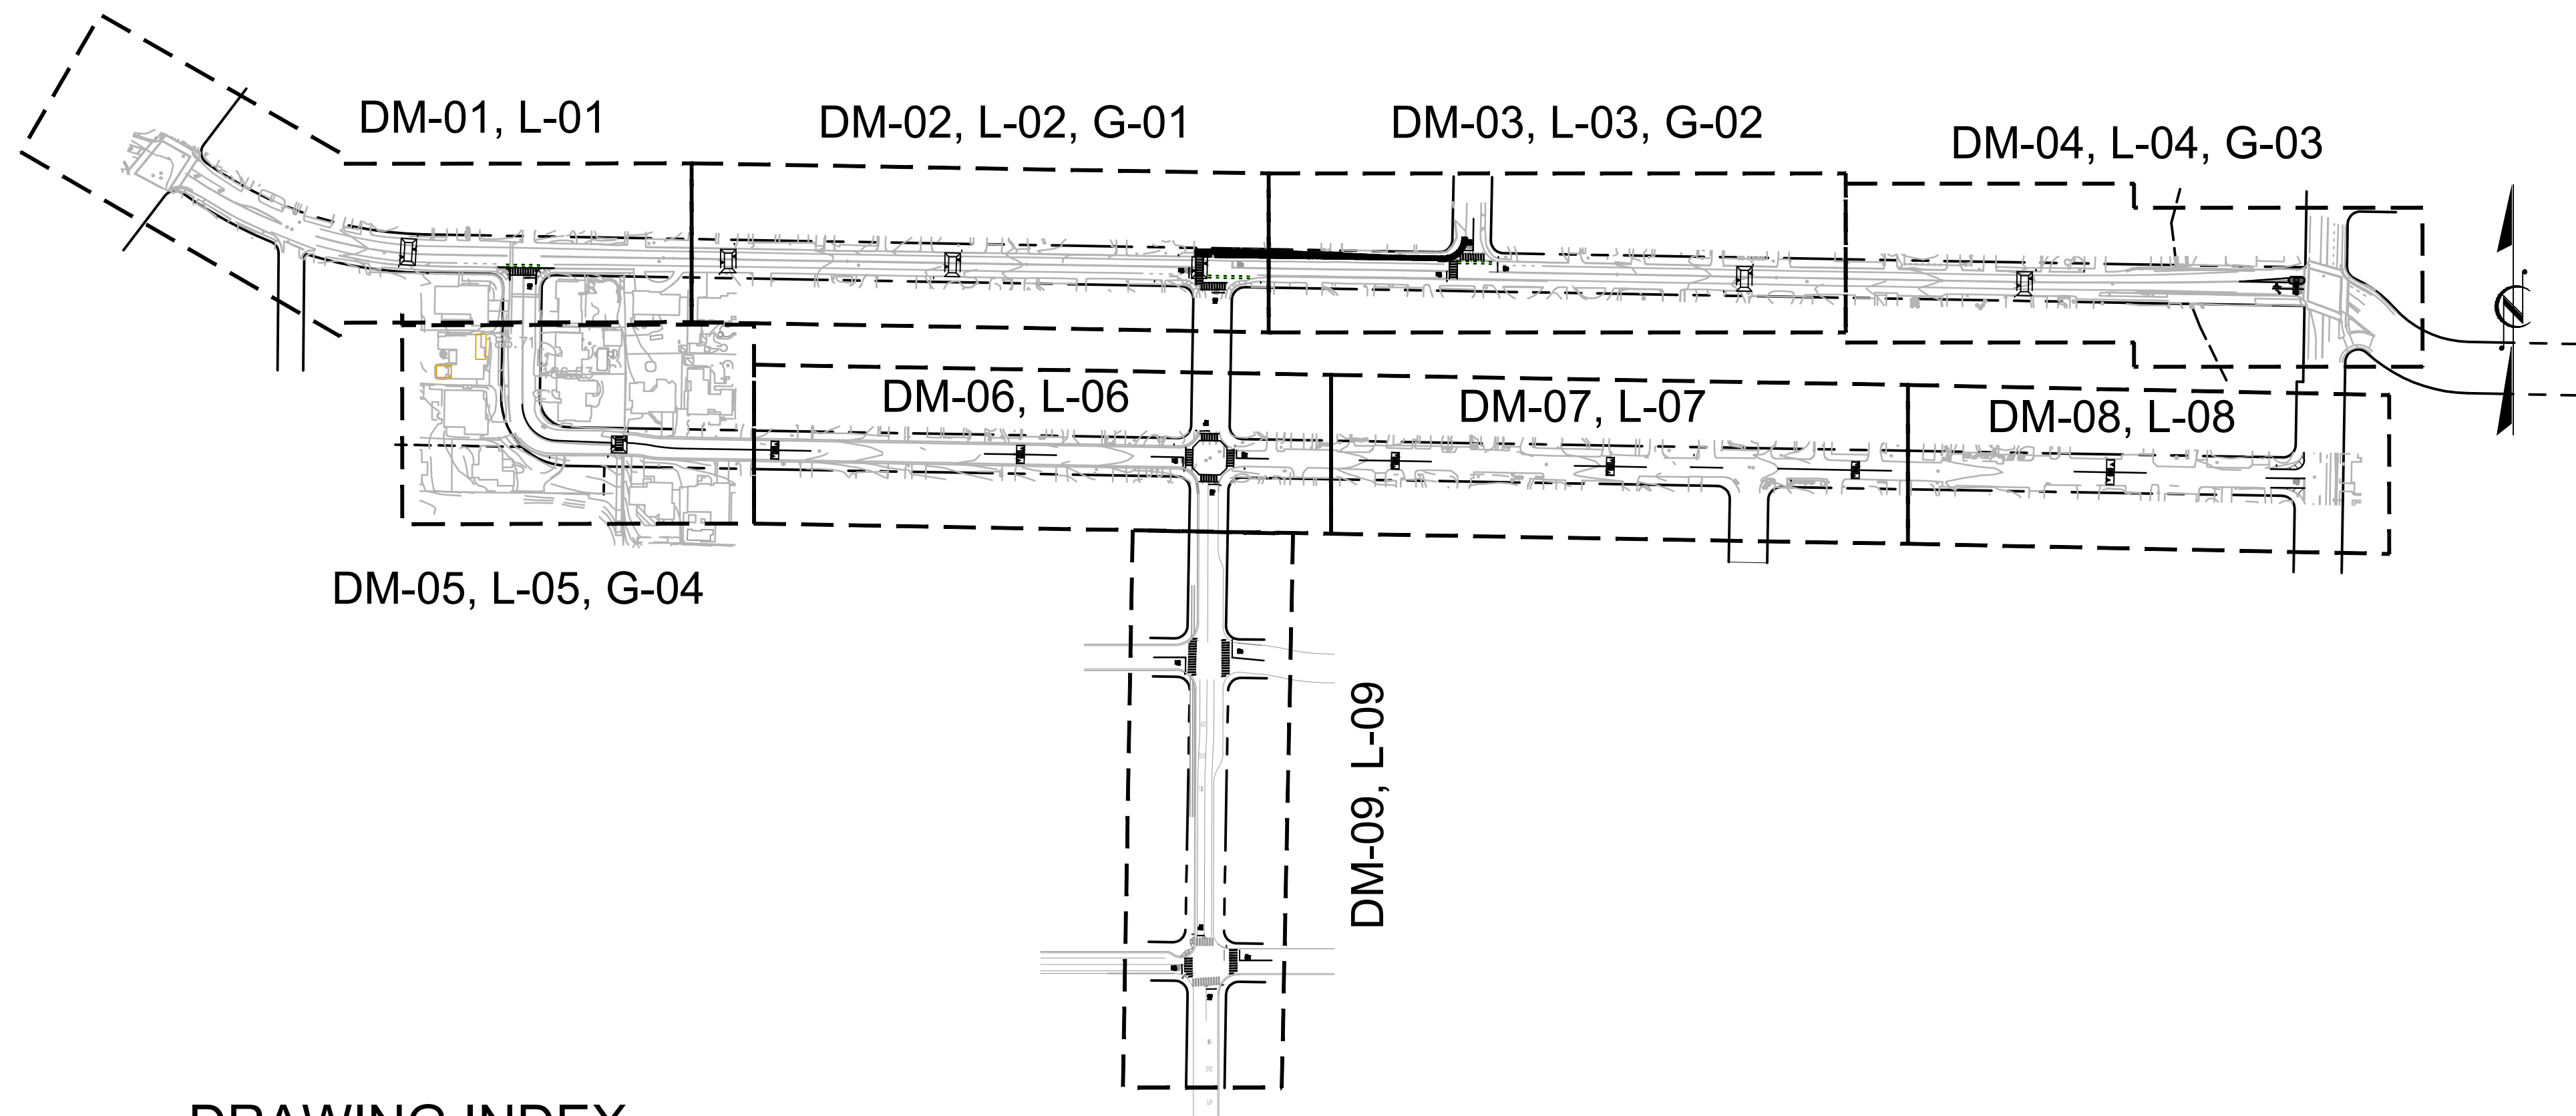
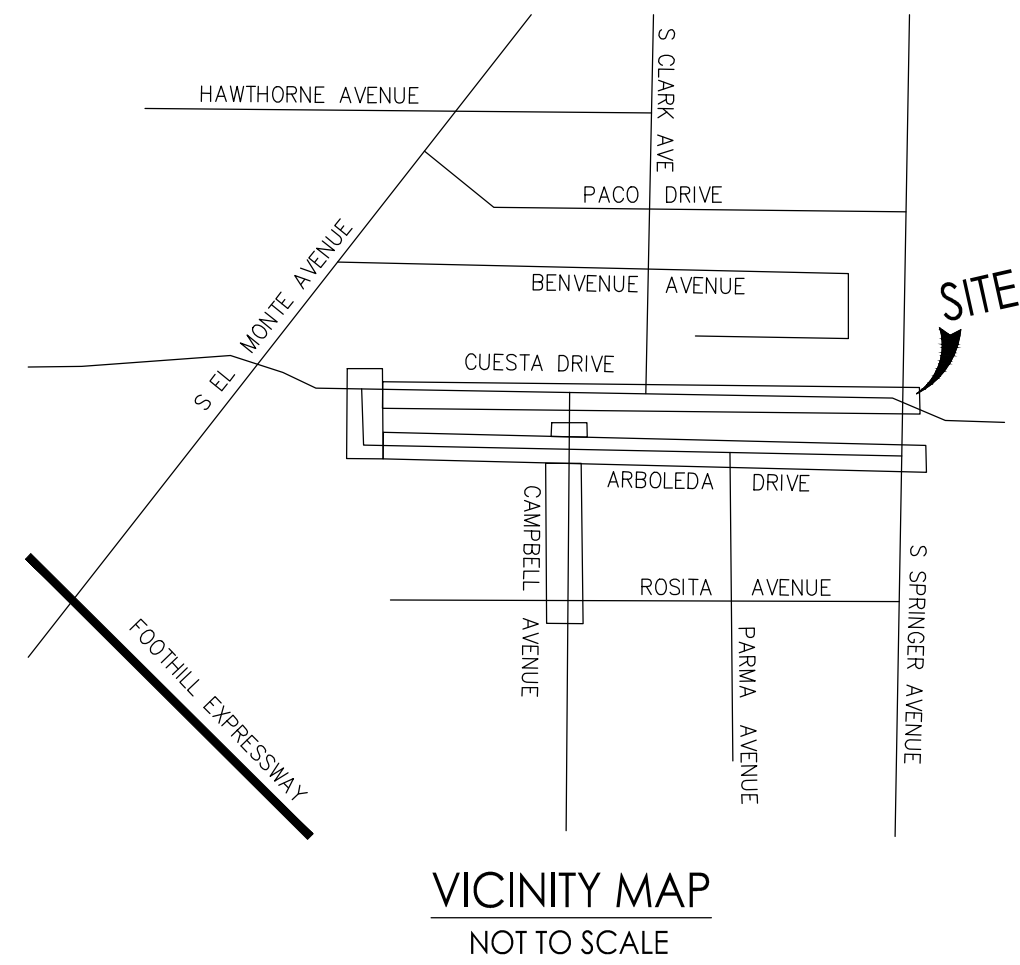


LOS ALTOS, CALIFORNIA

CUESTA DRIVE NEIGHBORHOOD TRAFFIC CALMING

65% SUBMITTAL

AUGUST, 2019



BASIS OF BEARINGS

HORIZONTAL COORDINATES ARE BASED ON CALIFORNIA STATE PLANE ZONE 3 UTILIZING THE CALIFORNIA SURVEYING AND DRAFTING SUPPLY REAL-TIME NETWORK. DATA WAS COLLECTED IN NOVEMBER 2018.

BENCHMARK

BRASS DISK ON TOP OF CONCRETE NORTHEASTERN HEADWALL LOCATED AT THE NORTHWEST END OF SAID HEADWALL ON HALE CREEK BRIDGE AT COVINGTON ROAD. CITY OF LOS ALTOS.

SCVWD BM 350
ELEVATION (NAVD88) FEET: 174.20

DIG ALERT
DIAL TOLL FREE



**AT LEAST 2 DAYS
BEFORE YOU DIG**

DRAWING INDEX

SHEET	TITLE	CONTENT
1	T-01	TITLE SHEET
2, 3	GN-01, GN-02	GENERAL NOTES
4-12	DM-01 TO DM-09	DEMOLITION PLANS
13-21	L-01 TO L-09	LAYOUT PLANS
22-25	G-01 TO G-04	GRADING & DRAINAGE PLANS
26, 27	D-01, D-02	CONSTRUCTION DETAILS
28	D-03	SIGNING DETAILS
29, 30	D-04, D-05	CITY STANDARD DETAILS

KEY MAP

SCALE: 1" = 200'

PROJECT OWNER

CITY OF LOS ALTOS
1 N. San Antonio Road
Los Altos, CA 94022
www.losaltosca.gov


PROJECT CONSULTANTS

Alta Planning + Design, Inc.
304 12th Street, Suite 2A
Oakland, CA 94607
T: 510.540.5008
F: 510.788.6485
www.altaplanning.com

PROJECT SURVEYOR

Wood Rogers, Inc.
4670 Willow Road, Suite 125
Pleasanton, CA 94588
T: 925.847.1556
F: 925.847.1557
www.woodrogers.com

DESIGNED:	CV	REVISIONS
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DRAWN:	JP	
2018-248	8/22/19	
PROJECT NO.	DATE	
NTS	18-248-Title	
SCALE	FILE	

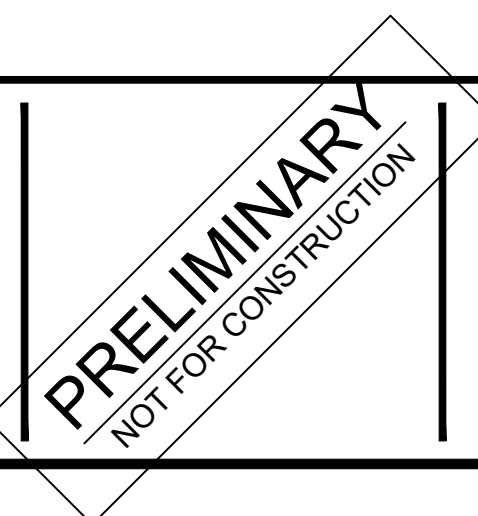

**CUESTA DRIVE
TRAFFIC CALMING**
Los Altos, California

SHEET NO.

TITLE SHEET

T-01
1 OF 30

GENERAL NOTES:

- IT SHALL BE THE RESPONSIBILITY OF THE CONTRACTOR TO VERIFY THE LOCATIONS OF UNDERGROUND UTILITIES PRIOR TO CONSTRUCTION. THE CONTRACTOR SHALL COORDINATE WITH THE APPROPRIATE UTILITY COMPANY AS REQUIRED. THE CONTRACTOR SHALL NOTIFY UNDERGROUND SERVICE ALERT (U.S.A.) AT 1-800-227-2600 (OR DIAL 811) 72 HOURS PRIOR TO COMMENCING DEMOLITION OR EXCAVATION.
- CONTRACTOR TO CONFIRM IF TRUCKS/EQUIPMENT CAN ACCESS SITE. IF TREE BRANCHES ARE AN OBSTRUCTION, THE CONTRACTOR SHALL REMOVE THE BRANCHES IN THE PRESENCE OF THE CITY ARBORIST.
- THE CONTRACTOR SHALL COMPLY WITH ALL STATE, COUNTY, AND CITY LAWS AND ORDINANCES, REGULATIONS OF THE DEPARTMENT OF INDUSTRIAL RELATIONS, STATE CONSTRUCTION SAFETY ORDERS, AND CAL/OSHA. THIS REQUIREMENT SHALL BE MADE TO APPLY AT ALL TIMES.
- REQUIREMENTS FOR ALLOWABLE WORK HOURS AND TRAFFIC CONTROL ARE IN THE PROJECT SPECIFICATIONS.
- THE CONTRACTOR SHALL PROVIDE FOR CONTINUOUS INGRESS AND EGRESS TO ALL PRIVATE PROPERTIES ADJACENT TO THE WORK THROUGHOUT THE PERIOD OF CONSTRUCTION UNLESS OTHERWISE SHOWN.
- THE CONTRACTOR SHALL LOCATE, REFERENCE, AND SET SUFFICIENT MARKS FOR ALL EXISTING UTILITY BOXES, MANHOLE COVERS, MONUMENT LIDS, ETC., PRIOR TO ANY DEMOLITION OR PAVING WORK WITHIN THE PROJECT LIMITS AND SHALL REMOVE THE MARKS UPON COMPLETION OF THE WORK.
- THE FINAL ADJUSTMENT TO FINISHED GRADE OF ALL FRAMES, COVERS, AND MANHOLES SHALL BE MADE FOLLOWING PLACEMENT OF THE TOP LAYER OF ASPHALT CONCRETE UNLESS OTHERWISE NOTED.
- ALL WORK SHALL BE DONE IN ACCORDANCE WITH THE CITY OF LOS ALTOS STANDARD DRAWINGS, THE CALIFORNIA MANUAL ON UNIFORM TRAFFIC CONTROL DEVICES, DATED 2014, REVISION 4, AND THE CALIFORNIA DEPARTMENT OF TRANSPORTATION STANDARD SPECIFICATIONS AND STANDARD PLANS, DATED 2018, INCLUDING ALL PUBLISHED REVISIONS.
- THE ENGINEER ASSUMES NO RESPONSIBILITY BEYOND THE ADEQUACY OF THE DESIGN CONTAINED HEREIN. THE CONTRACTOR AGREES TO ASSUME SOLE AND COMPLETE RESPONSIBILITY FOR JOB SITE CONDITIONS DURING THE COURSE OF CONSTRUCTION OF THE PROJECT, INCLUDING SAFETY OF ALL PERSONS AND PROPERTY, THAT THIS REQUIREMENT SHALL APPLY CONTINUOUSLY AND NOT BE LIMITED TO NORMAL WORKING HOURS, AND THAT THE CONTRACTOR SHALL DEFEND, INDEMNIFY AND HOLD THE OWNER AND ENGINEER HARMLESS FROM ANY AND ALL LIABILITY IN CONNECTION WITH THE PERFORMANCE OF THE WORK ON THIS PROJECT, EXCEPTING FOR LIABILITY ARISING FROM THE SOLE NEGLIGENCE OF THE OWNER OR ENGINEER.
- THE CONTRACTOR SHALL BE RESPONSIBLE FOR ANY FIELD CHANGES MADE WITHOUT WRITTEN AUTHORIZATION FROM THE CITY.
- THE CONTRACTOR IS RESPONSIBLE FOR MATCHING EXISTING STREETS, SURROUNDING LANDSCAPE, AND ALL OTHER EXISTING CONDITIONS WITH A SMOOTH TRANSITION IN PAVING, CURBS, GUTTERS, SIDEWALKS, GRADING, ETC., AND TO AVOID ANY ABRUPT OR APPARENT CHANGES IN GRADES OR CROSS SLOPES, LOW SPOTS, AND HAZARDOUS CONDITIONS.
- THE CONTRACTOR SHALL NOTIFY ALL TRANSIT AGENCIES, TRASH COLLECTION AGENCY, AND EMERGENCY SERVICES OF THE CONSTRUCTION SCHEDULE TO ALLOW COORDINATION.
- THE CONTRACTOR SHALL BE SOLELY RESPONSIBLE FOR ANY DAMAGES TO THE SITE OR SURROUNDING AREA AS A RESULT OF THE CONTRACTOR'S WORK OR OPERATIONS. EXISTING CURB, GUTTER, AND OTHER IMPROVEMENTS THAT ARE DAMAGED BY THE CONTRACTOR SHALL BE REPLACED AT THE CONTRACTOR'S EXPENSE.
- ANY STREET SIGNS AND STREET SIGN POSTS NOT IDENTIFIED WITHIN THESE PLANS THAT EXIST WITHIN THE PROJECT EXTENTS SHALL BE PROTECTED IN PLACE, OR ARE TO REMAIN, UNLESS OTHERWISE DIRECTED BY THE CITY ENGINEER.
- ANY EXISTING PAVEMENT MARKINGS AND PAVEMENT STRIPING NOT IDENTIFIED WITHIN THESE PLANS THAT EXIST WITHIN THE PROJECT EXTENTS SHALL BE PROTECTED IN PLACE, OR ARE TO REMAIN, UNLESS OTHERWISE DIRECTED BY THE CITY ENGINEER.

UTILITY NOTE

THE TYPES, LOCATIONS, SIZES AND/OR DEPTHS OF EXISTING UNDERGROUND UTILITIES AS SHOWN ON THIS TOPOGRAPHIC SURVEY ARE APPROXIMATE AND WERE OBTAINED FROM SOURCES OF VARYING RELIABILITY. ONLY ACTUAL EXCAVATION WILL REVEAL THE TYPES, EXTENT, SIZES, LOCATIONS, AND DEPTHS OF SUCH UNDERGROUND UTILITIES. THE ENGINEER CAN ASSUME NO RESPONSIBILITY FOR THE COMPLETENESS OR ACCURACY OF ITS DELINEATION OF SUCH UNDERGROUND UTILITIES WHICH MAY BE ENCOUNTERED, BUT WHICH ARE NOT SHOWN ON THIS SURVEY.

ABBREVIATIONS:

A.B.	AGGREGATE BASE
A.C.	ASPHALT CONCRETE
B.C.	BEGINNING OF CURVE
BOW	BACK OF WALK
CALTRANS	CALIFORNIA DEPARTMENT OF TRANSPORTATION
CB	CATCH BASIN
CONT.	CONTINUED
CL	CENTERLINE
DI	STORM DRAIN INLET
(E)	EAST
E:	EASTING
EC	END OF CURVE
EOP	EDGE OF PAVEMENT
EX.	EXISTING
FG	FINISHED GRADE
FH	FIRE HYDRANT
FL	FLOWLINE
G	GAS UTILITY
HMA	HOT MIXED ASPHALT
INV.	INVERT ELEVATION
JP	JOINT POLE
LF	LINEAR FEET (FOOT)
L	LEFT
MAX.	MAXIMUM
MH	MANHOLE
MIN.	MINIMUM
(N)	NORTH
N:	NORTHING
NTS	NOT TO SCALE
O.G.	ORIGINAL GROUND
OH	OVERHEAD UTILITY
O.C.	ON CENTER
PB	PULLBOX
PCC	PORTLAND CEMENT CONCRETE
PRC	POINT OF REVERSE CURVE
PVC	POLYVINYL CHLORIDE PIPE
R	RIGHT (DIRECTIONAL)
R:	RADIUS
RCP	REINFORCED CEMENT PIPE
RIM	RIM ELEVATION
R/W	RIGHT OF WAY
(S)	SOUTH
SD	STORM DRAIN
SS	SANITARY SEWER
STA	STATION
STD.	STANDARD
SW	SIDEWALK
TC	TOP OF CURB
TS	TRAFFIC SIGNAL
TYP.	TYPICAL
VLT	VAULT
W	WATER UTILITY
(W)	WEST

PROPOSED WORK LEGEND:

	PCC SECTION
	DETECTABLE WARNING SURFACE
	D.G. SECTION
	ASPHALT SECTION
	COBBLE STONE MEDIAN PAVING
	LANDSCAPING AREA

DEMOLITION LEGEND:

	REMOVE EXISTING STRIPING BY SANDBLASTING. ALL DEBRIS SHALL BE REMOVED BY THE END OF EACH WORKDAY.
	SAWCUT EXISTING PAVEMENT SURFACE. ALL DEBRIS SHALL BE REMOVED BY THE END OF EACH WORKDAY.
	PROTECT IN PLACE EX. STRIPING AND PAVEMENT MARKINGS
	GRIND 3" OF EXISTING ASPHALT PAVEMENT SURFACE (PER PLANS)
	CLEAR AND GRUB
	REMOVE AND DISPOSE OF ASPHALT AND BASE MATERIAL
	REMOVE AND DISPOSE OF CONCRETE AND BASE MATERIAL
	REMOVE AND DISPOSE OF EMBEDDED COBBLE STONE IN CEMENT AND BASE MATERIAL
	REMOVE AND DISPOSE OF EXISTING CURB / BERM (PER PLANS)

DIG ALERT

DIAL TOLL FREE



AT LEAST 2 DAYS BEFORE YOU DIG


TEMPORARY EROSION CONTROL NOTE:

CONTRACTOR SHALL PROVIDE TEMPORARY STORM WATER POLLUTION CONTROL DURING CONSTRUCTION PER CALTRANS STD. PLAN T62. PROVIDE DRAINAGE INLET PROTECTION AT STORM DRAINS LOCATED WITHIN 500' OF PROJECT EXTENTS. CONTRACTOR TO VERIFY ALL STORM WATER DRAIN INLET LOCATIONS

DESIGNED: CV	REVISIONS
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DRAWN: JP	
2018-248 PROJECT NO.	8/22/19 DATE
NTS SCALE	18-248-General Notes FILE



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p:510.540.5008

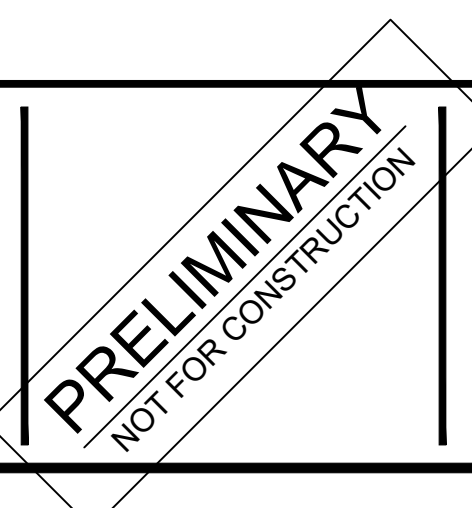

CUESTA DRIVE TRAFFIC CALMING

Los Altos, California

GENERAL NOTES

SHEET NO.

GN-01

2 OF 30

ALIGNMENT LINE DATA					
LINE #	ALIGNMENT	LENGTH	BEARING	Beg. STA	END STA
L1	C	30.00	S52°45'55.69"E	1+00.00	1+30.00
L2	C	2953.90	S88°59'40.69"E	5+32.52	34+86.42
L3	A	275.00	S1°00'19.31"W	6+33.83	9+08.83
L4	A	2725.00	S88°59'40.69"E	10+26.64	37+51.64
L5	CB	1000.00	S0°55'13.92"W	19+51.24	29+51.24

ALIGNMENT CURVE DATA						
CURVE #	ALIGNMENT	RADIUS	LENGTH	DELTA	Beg. STA	END STA
C1	C	636.58	402.52	36°13'45.00"	1+30.00	5+32.52
C2	A	75.00	117.81	90°00'00.00"	9+08.83	10+26.64


BASIS OF BEARINGS

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BENCHMARK

BRASS DISK ON TOP OF CONCRETE NORTHEASTERN HEADWALL LOCATED AT THE NORTHWEST END OF SAID HEADWALL ON HALE CREEK BRIDGE AT COVINGTON ROAD, CITY OF LOS ALTOS.

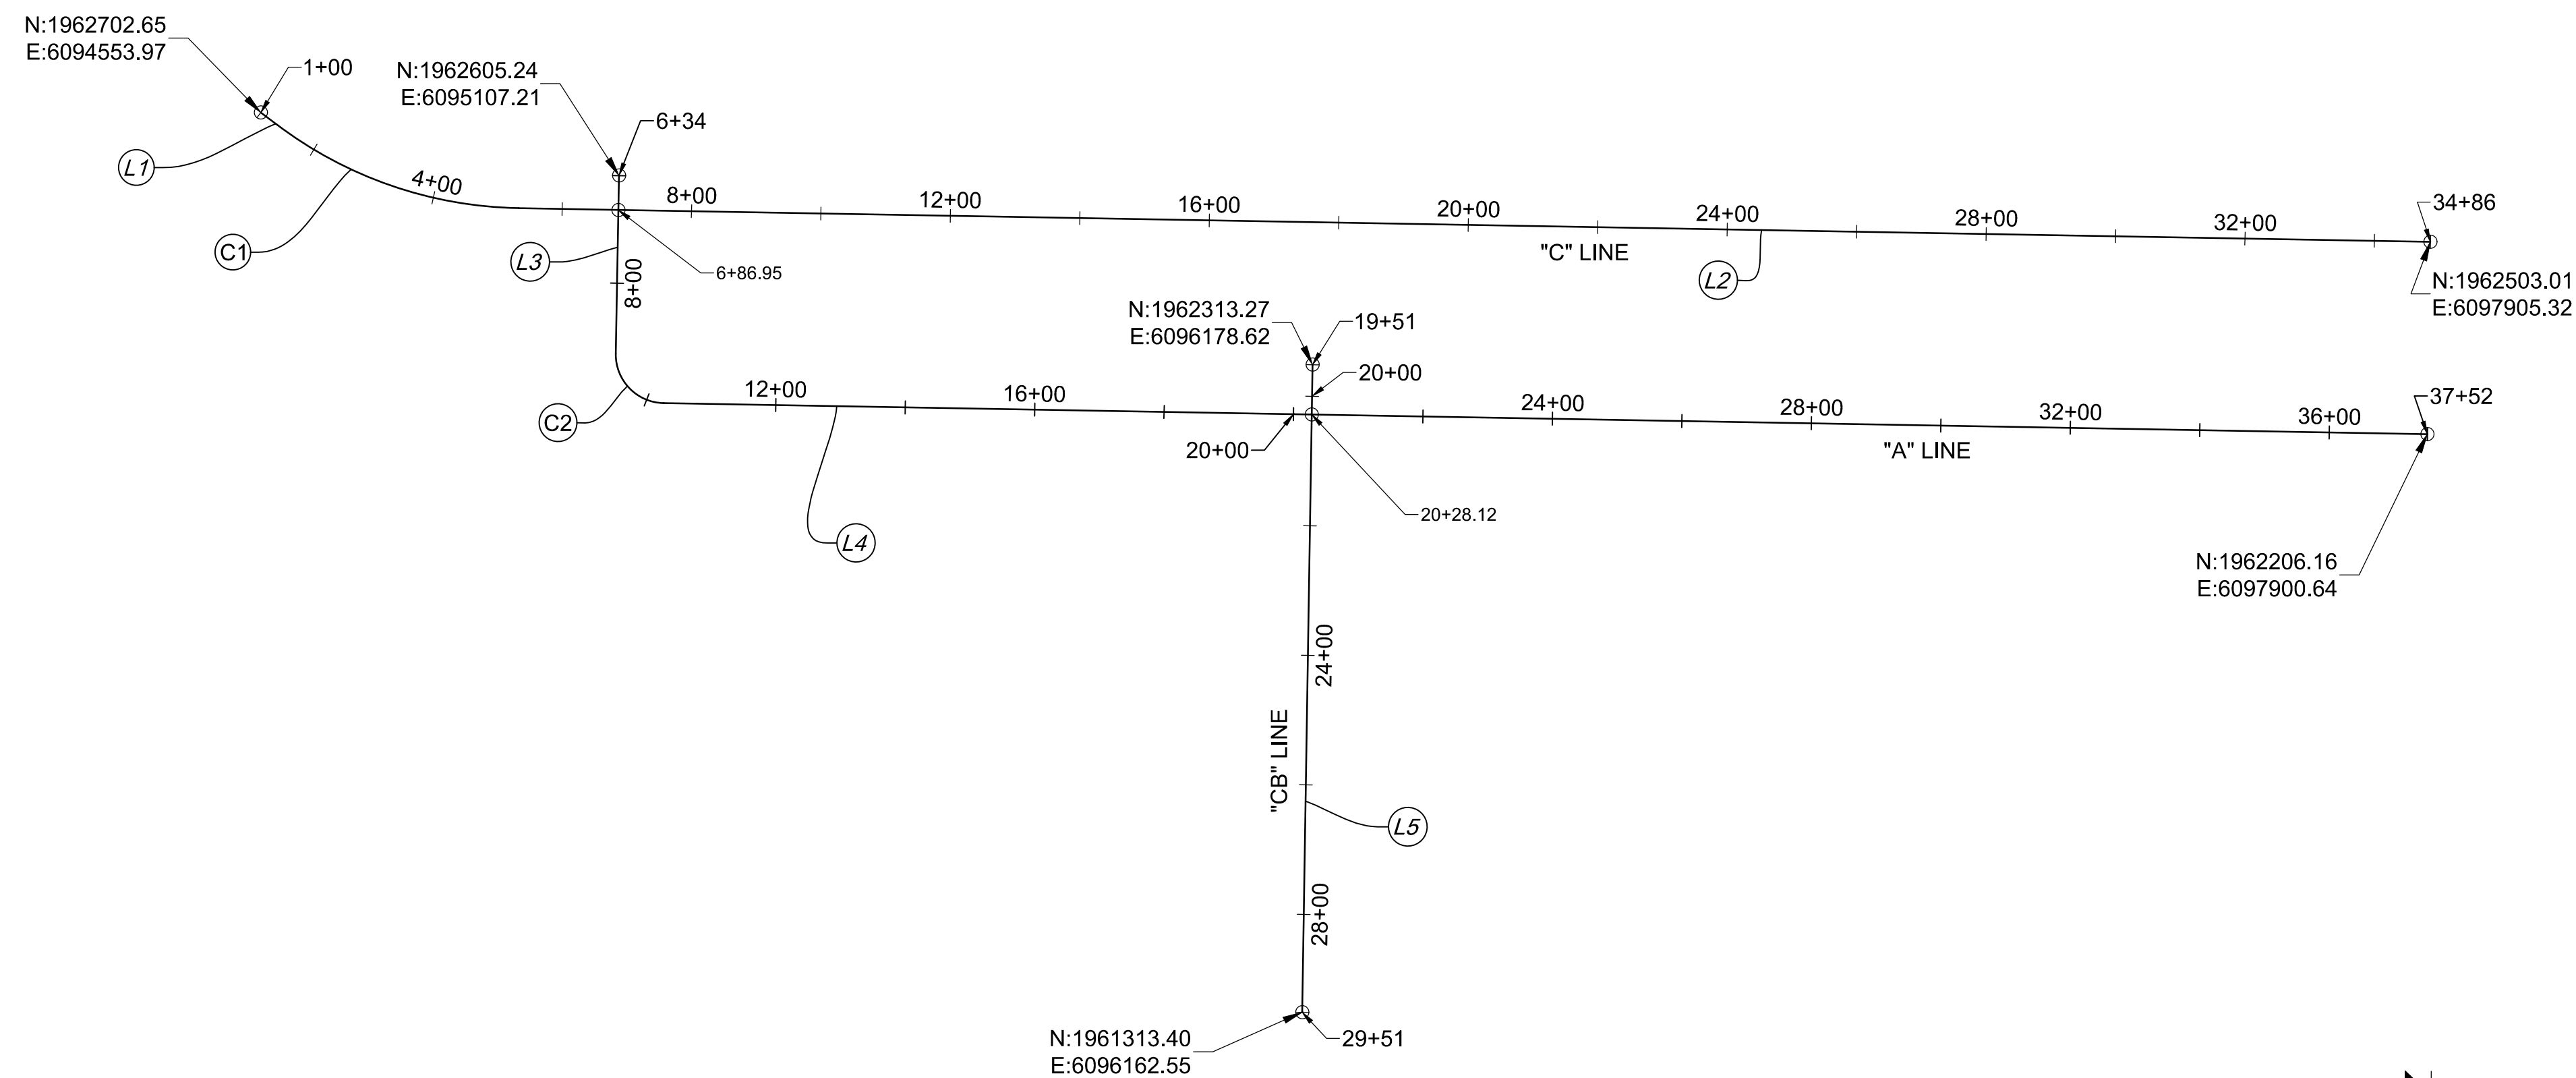SCVWD BM 350
ELEVATION (NAVD88) FEET: 174.20



ALIGNMENT GEOMETRY

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p:510.540.5008



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**CUESTA DRIVE
TRAFFIC CALMING**
Los Altos, California

GENERAL NOTES

SHEET NO.

GN-02
3 OF 30

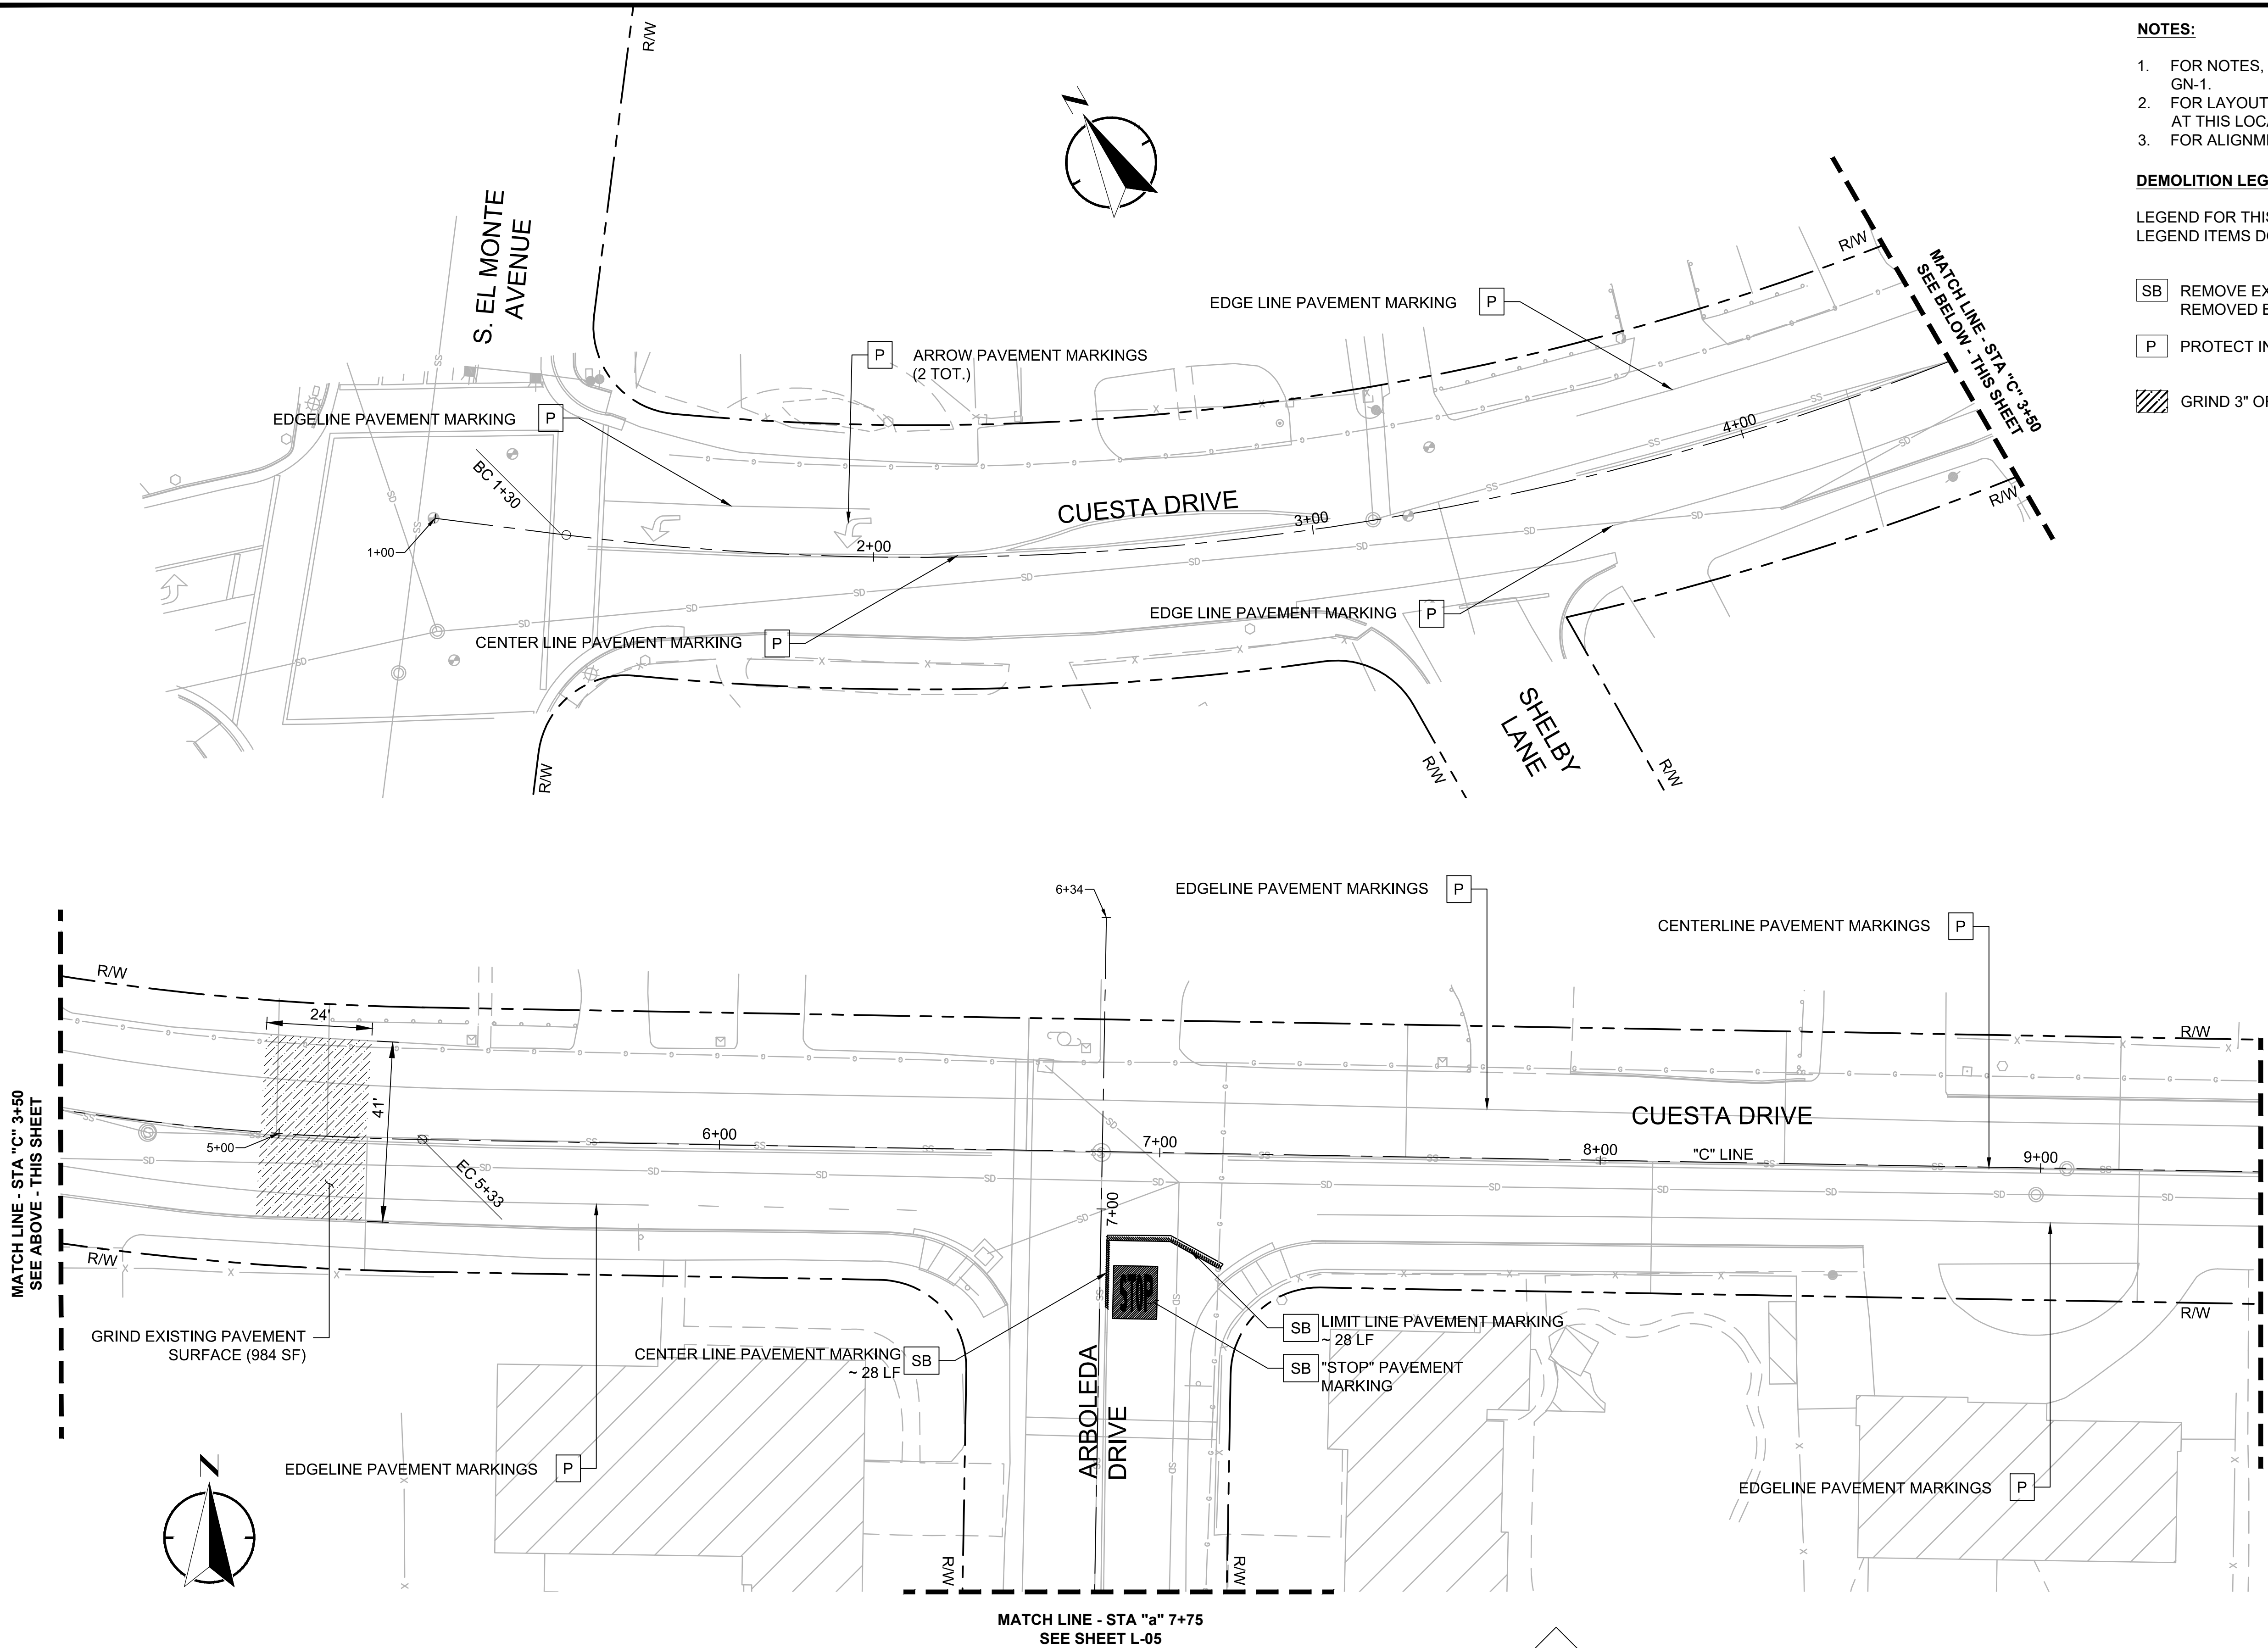
NOTES:

- FOR NOTES, LEGEND AND ABBREVIATIONS SEE SHEET GN-1.
- FOR LAYOUT, GRADING & DRAINAGE DRAWING NUMBERS AT THIS LOCATION, SEE SHEET T-1, KEY MAP.
- FOR ALIGNMENT CURVE AND LINE DATA, SEE SHEET GN-02.

DEMOLITION LEGEND:

LEGEND FOR THIS SHEET ONLY.
LEGEND ITEMS DO NOT NECESSARILY APPEAR ON EVERY SHEET.

- SB REMOVE EXISTING STRIPING BY SANDBLASTING. ALL DEBRIS SHALL BE REMOVED BY THE END OF EACH WORKDAY.
- P PROTECT IN PLACE EX. STRIPING AND PAVEMENT MARKINGS
- GRIND 3" OF EXISTING ASPHALT PAVEMENT SURFACE.



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REVIEWED: _____	SF	NO DATE ITEM
DRAWN: _____	JP	
2018-248	8/22/19	
PROJECT NO.	DATE	
18-248-Demo	Plans	
1"=20'	FILE	
SCALE		



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**CUESTA DRIVE
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Los Altos, California



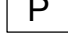
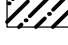
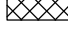

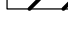
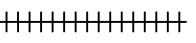
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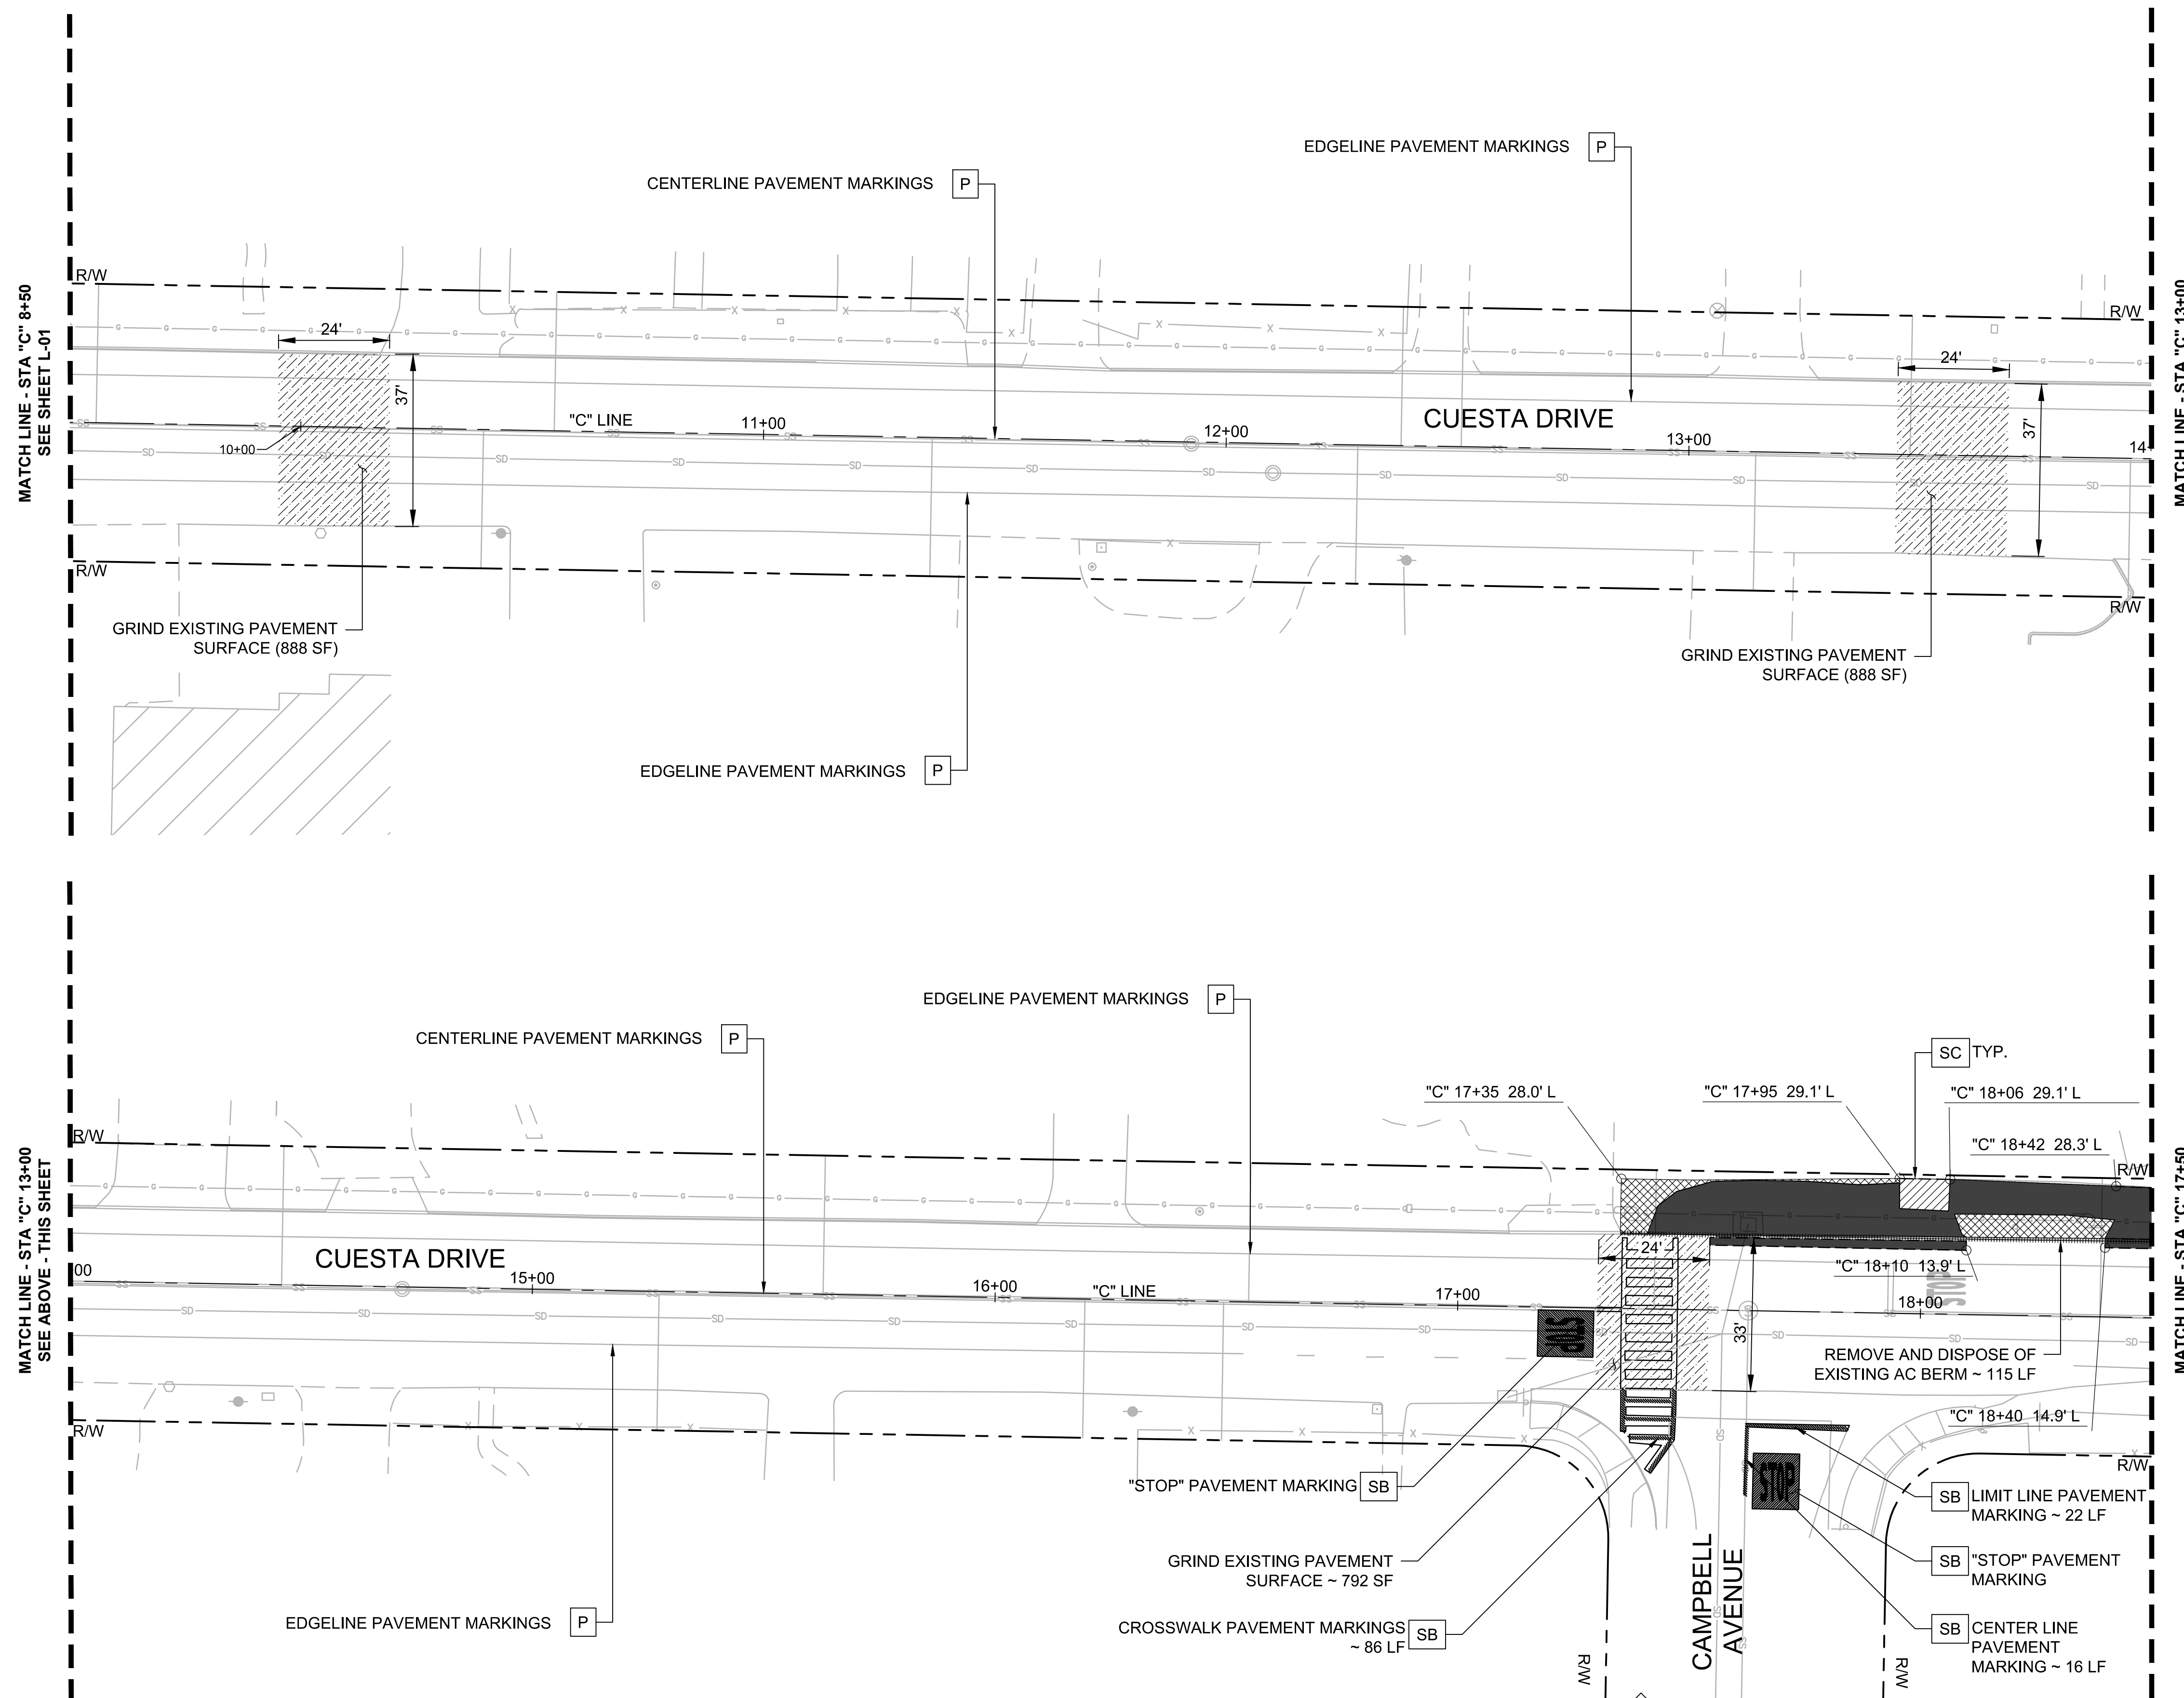
SHEET NO.
DM-01
4 OF 30

- NOTES:**
- FOR NOTES, LEGEND AND ABBREVIATIONS SEE SHEET GN-1.
 - FOR LAYOUT, GRADING & DRAINAGE DRAWING NUMBERS AT THIS LOCATION, SEE SHEET T-1, KEY MAP.
 - FOR ALIGNMENT CURVE AND LINE DATA, SEE SHEET GN-02.

DEMOLITION LEGEND:

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-  SAWCUT EXISTING PAVEMENT SURFACE. ALL DEBRIS SHALL BE REMOVED BY THE END OF EACH WORKDAY.
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-  GRIND 3" OF EXISTING ASPHALT PAVEMENT SURFACE (PER PLANS)
-  CLEAR AND GRUB
-  REMOVE AND DISPOSE OF ASPHALT AND BASE MATERIAL
-  REMOVE AND DISPOSE OF CONCRETE AND BASE MATERIAL
-  REMOVE AND DISPOSE OF EXISTING CURB / BERM (PER PLANS)




MATCH LINE - STA "C" 13+00
SEE BELOW - THIS SHEET

MATCH LINE - STA "C" 8+50
SEE SHEET L-01

MATCH LINE - STA "C" 17+50
SEE SHEET L-03


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SEE ABOVE - THIS SHEET

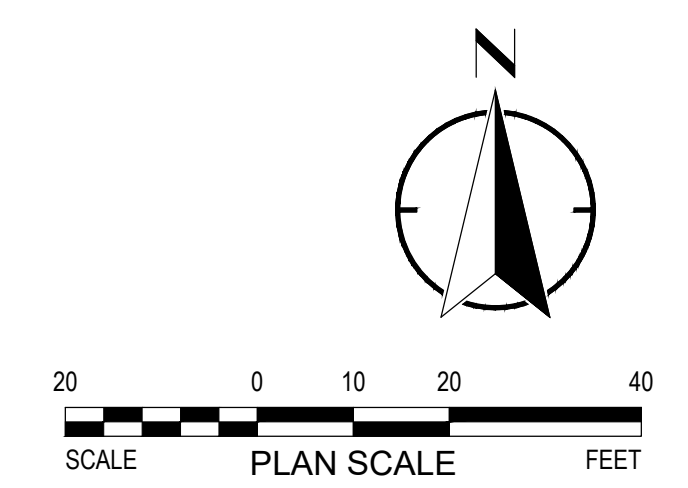

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2018-248 8/22/19	
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18-248-Demo	
1"=20' Plans	
SCALE FILE	


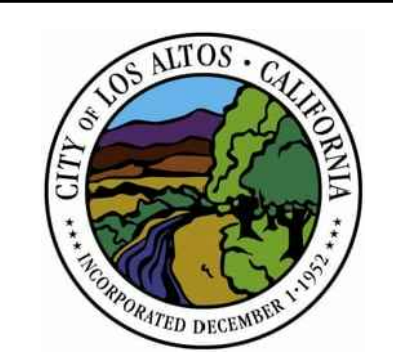
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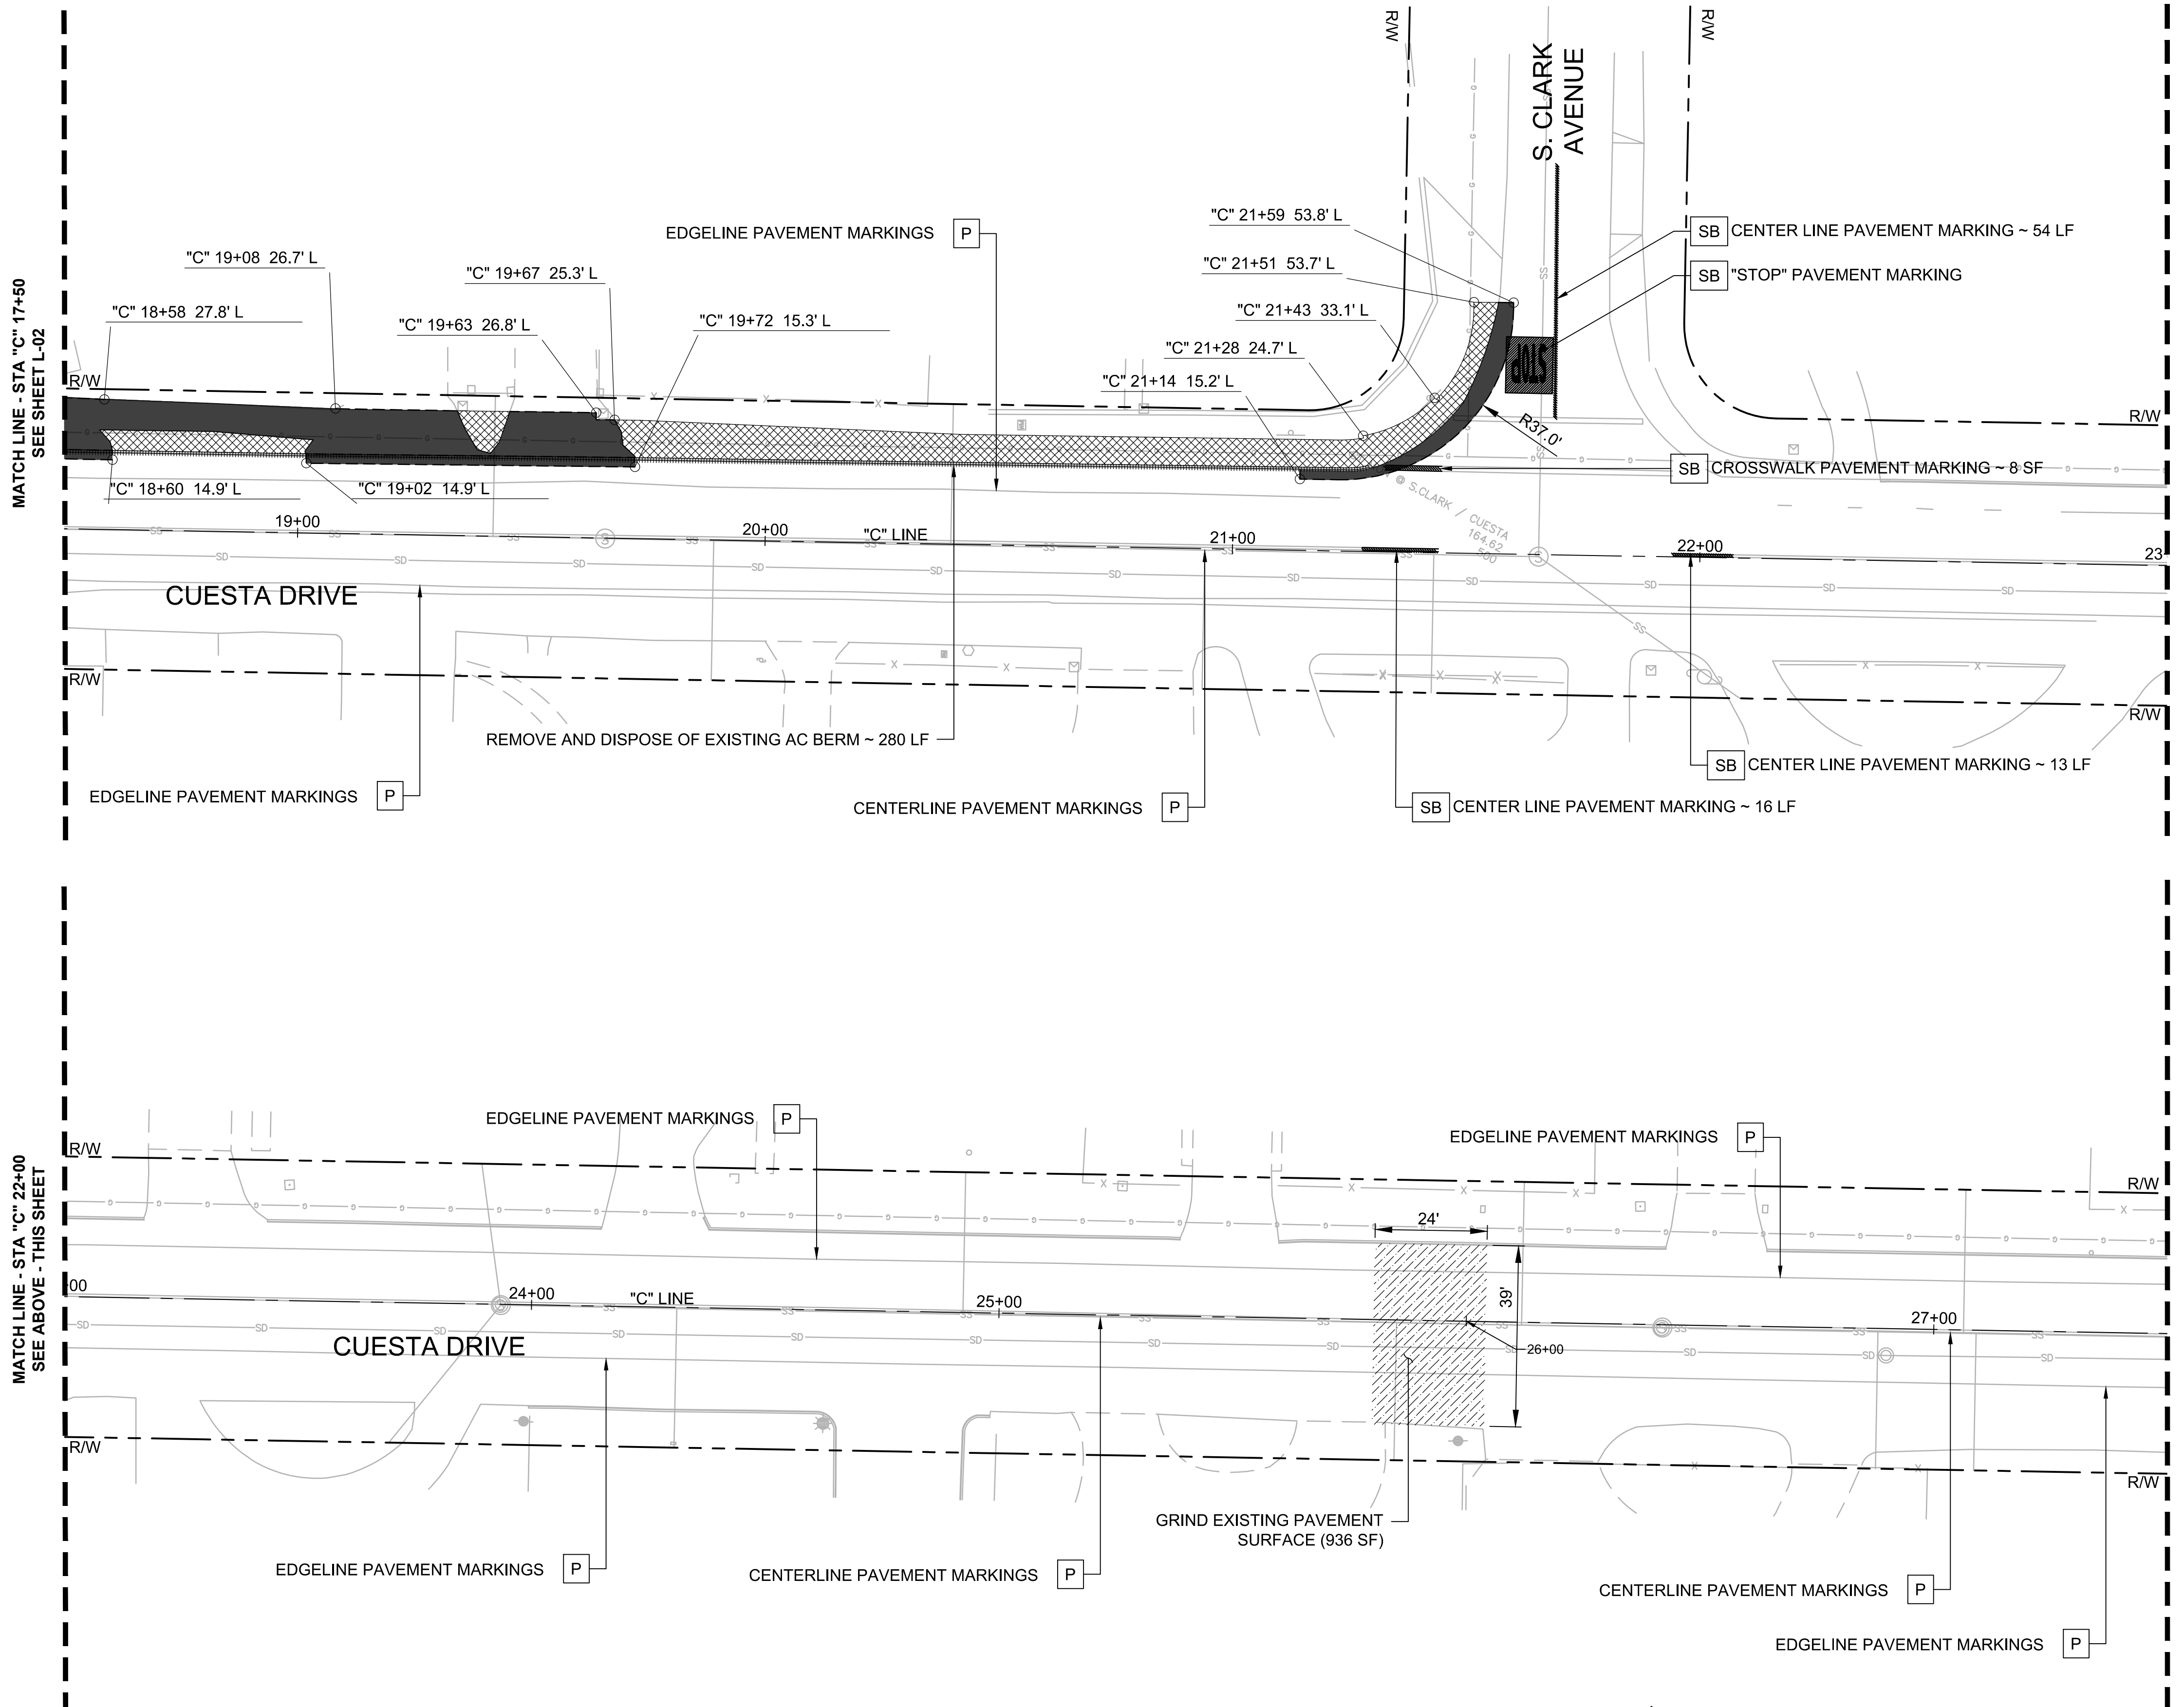


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Los Altos, California

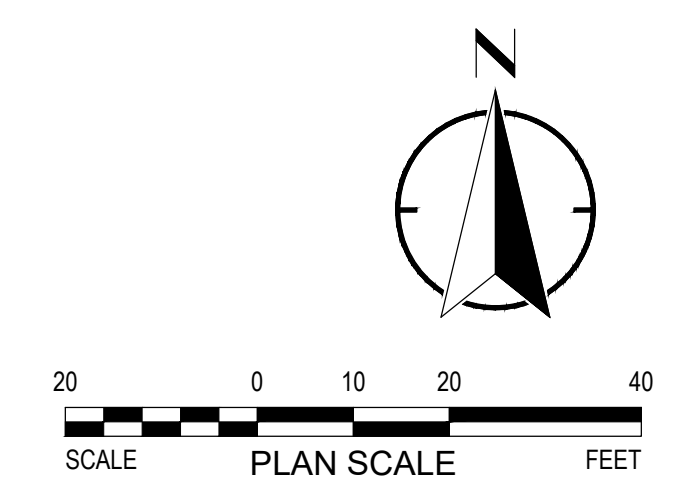
DEMOLITION
PLANS

SHEET NO.
DM-02
5 OF 30



- NOTES:**
- FOR NOTES, LEGEND AND ABBREVIATIONS SEE SHEET GN-1.
 - FOR LAYOUT, GRADING & DRAINAGE DRAWING NUMBERS AT THIS LOCATION, SEE SHEET T-1, KEY MAP.
 - FOR ALIGNMENT CURVE AND LINE DATA, SEE SHEET GN-02.

- DEMOLITION LEGEND:**
- LEGEND FOR THIS SHEET ONLY.
LEGEND ITEMS DO NOT NECESSARILY APPEAR ON EVERY SHEET.
- SB REMOVE EXISTING STRIPING BY SANDBLASTING. ALL DEBRIS SHALL BE REMOVED BY THE END OF EACH WORKDAY.
 - SC SAWCUT EXISTING PAVEMENT SURFACE. ALL DEBRIS SHALL BE REMOVED BY THE END OF EACH WORKDAY.
 - P PROTECT IN PLACE EX. STRIPING AND PAVEMENT MARKINGS
 - GRIND 3" OF EXISTING ASPHALT PAVEMENT SURFACE (PER PLANS)
 - CLEAR AND GRUB
 - REMOVE AND DISPOSE OF ASPHALT AND BASE MATERIAL
 - REMOVE AND DISPOSE OF EXISTING CURB / BERM (PER PLANS)



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

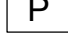
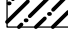




DEMOLITION
PLANS




SHEET NO.
DM-03
6 OF 30

- NOTES:**
- FOR NOTES, LEGEND AND ABBREVIATIONS SEE SHEET GN-1.
 - FOR LAYOUT, GRADING & DRAINAGE DRAWING NUMBERS AT THIS LOCATION, SEE SHEET T-1, KEY MAP.
 - FOR ALIGNMENT CURVE AND LINE DATA, SEE SHEET GN-02.

DEMOLITION LEGEND:

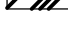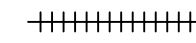LEGEND FOR THIS SHEET ONLY.
LEGEND ITEMS DO NOT NECESSARILY APPEAR ON EVERY SHEET.

-  REMOVE EXISTING STRIPING BY SANDBLASTING. ALL DEBRIS SHALL BE REMOVED BY THE END OF EACH WORKDAY.
-  SAWCUT EXISTING PAVEMENT SURFACE. ALL DEBRIS SHALL BE REMOVED BY THE END OF EACH WORKDAY.
-  PROTECT IN PLACE EX. STRIPING AND PAVEMENT MARKINGS
-  GRIND 3" OF EXISTING ASPHALT PAVEMENT SURFACE (PER PLANS)
-  CLEAR AND GRUB
-  REMOVE AND DISPOSE OF ASPHALT AND BASE MATERIAL
-  REMOVE AND DISPOSE OF EMBEDDED COBBLE STONE IN CEMENT AND BASE MATERIAL
-  REMOVE AND DISPOSE OF EXISTING CURB / BERM (PER PLANS)

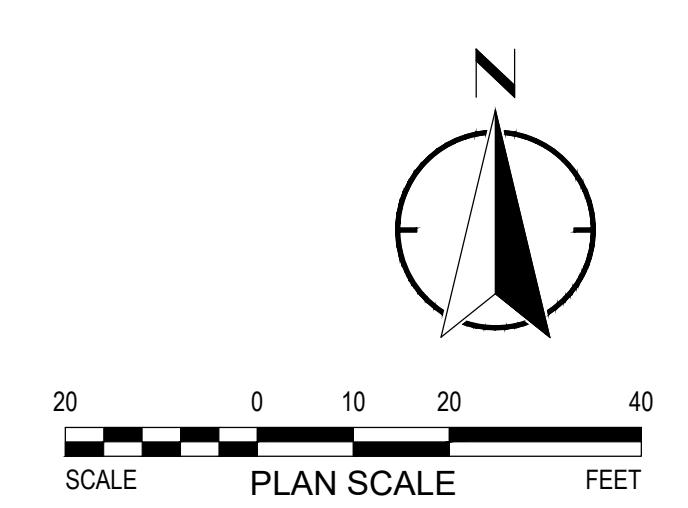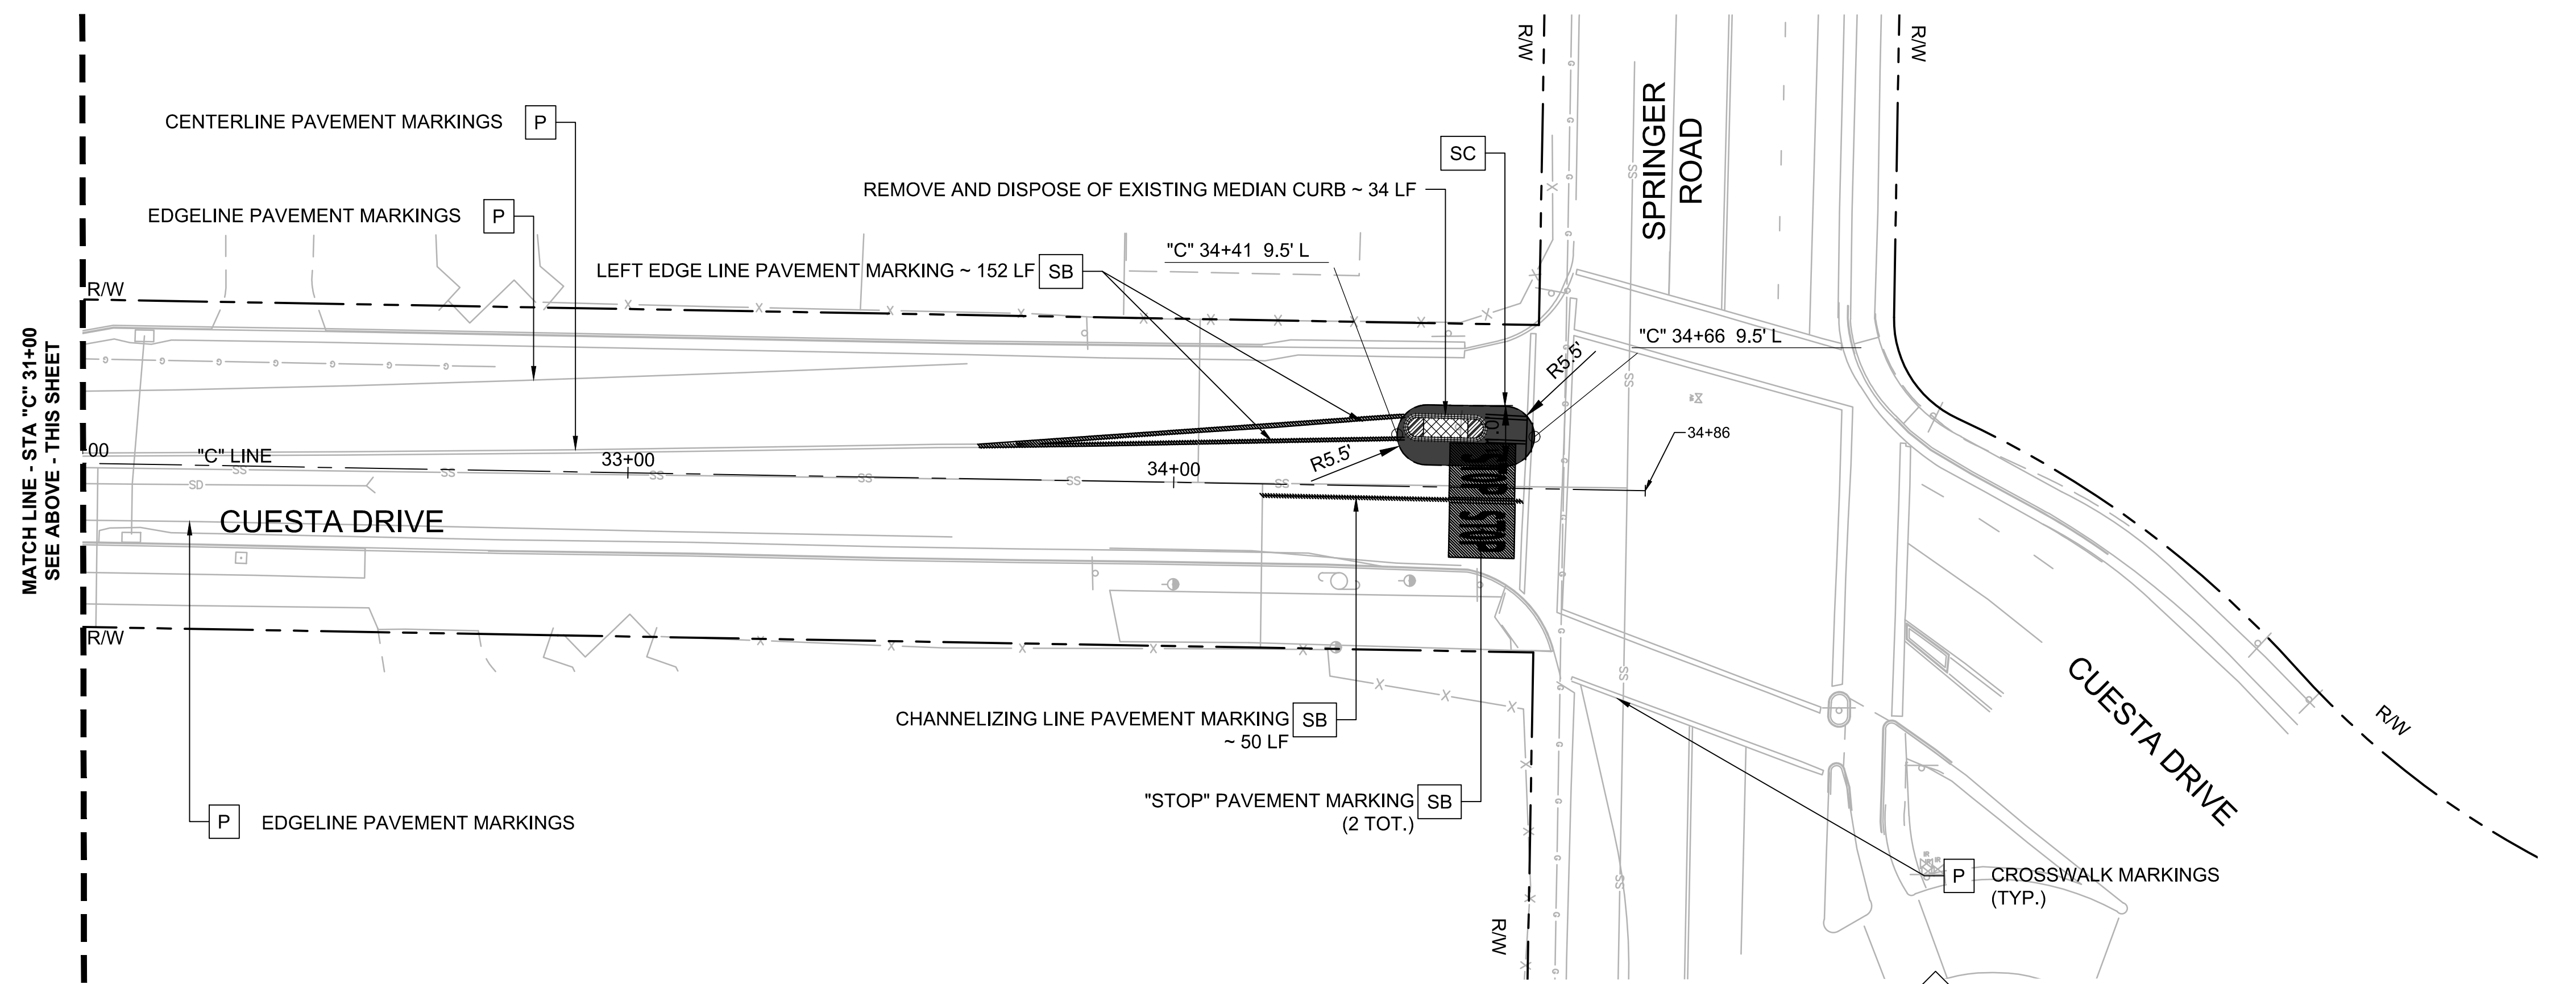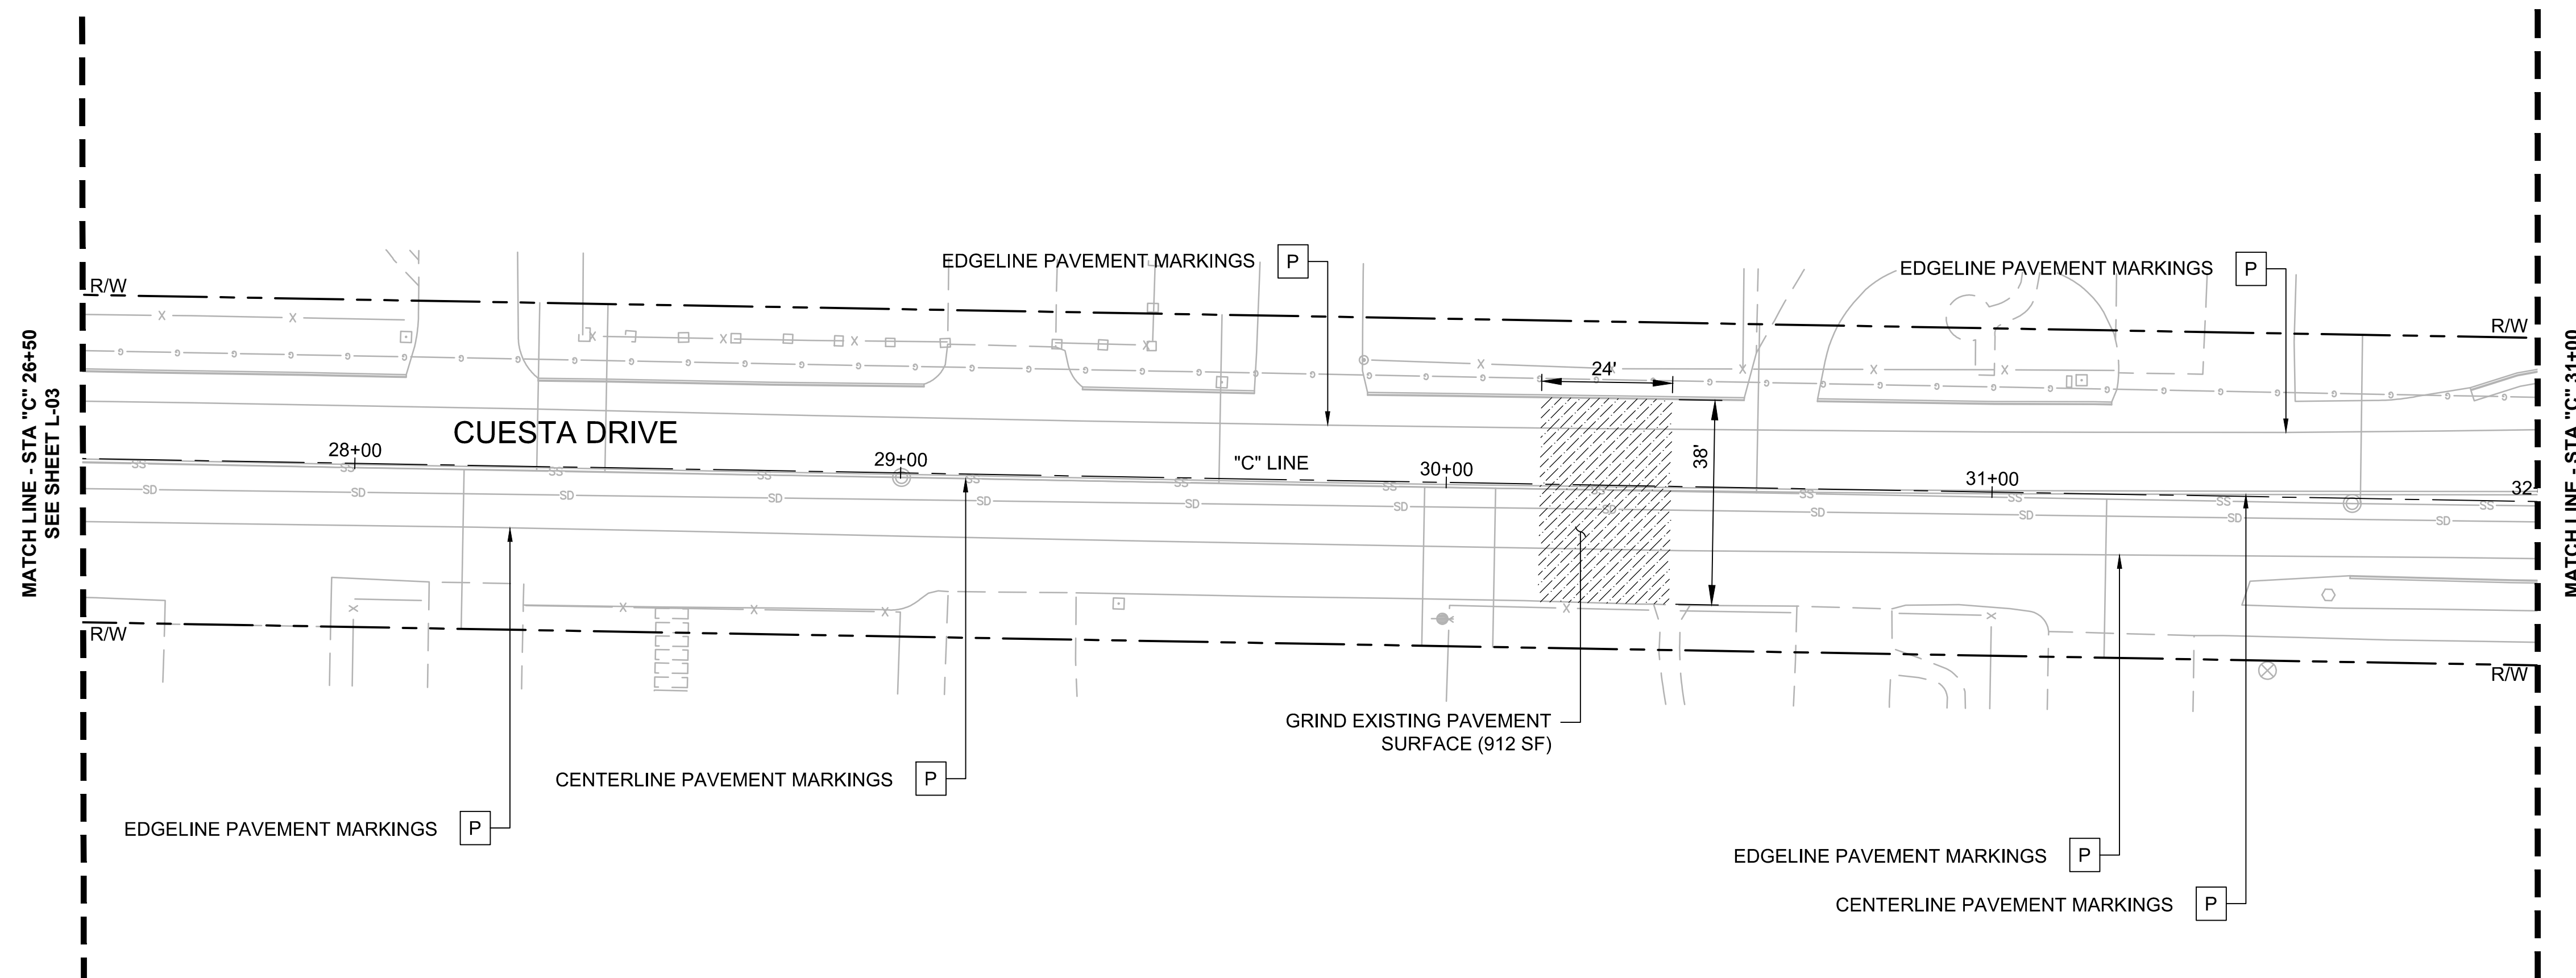

DESIGNED: CV	REVISIONS
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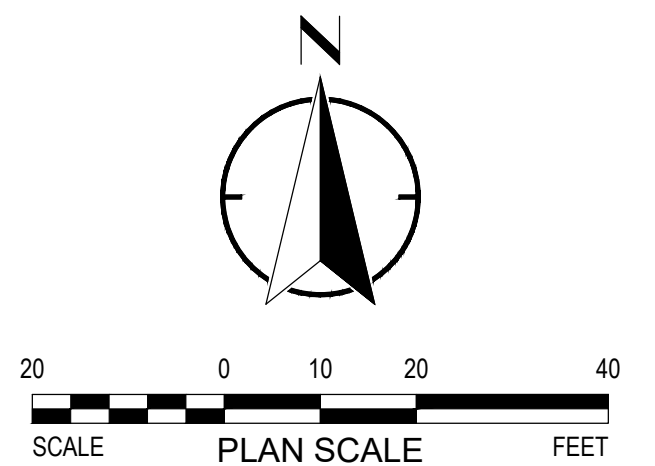
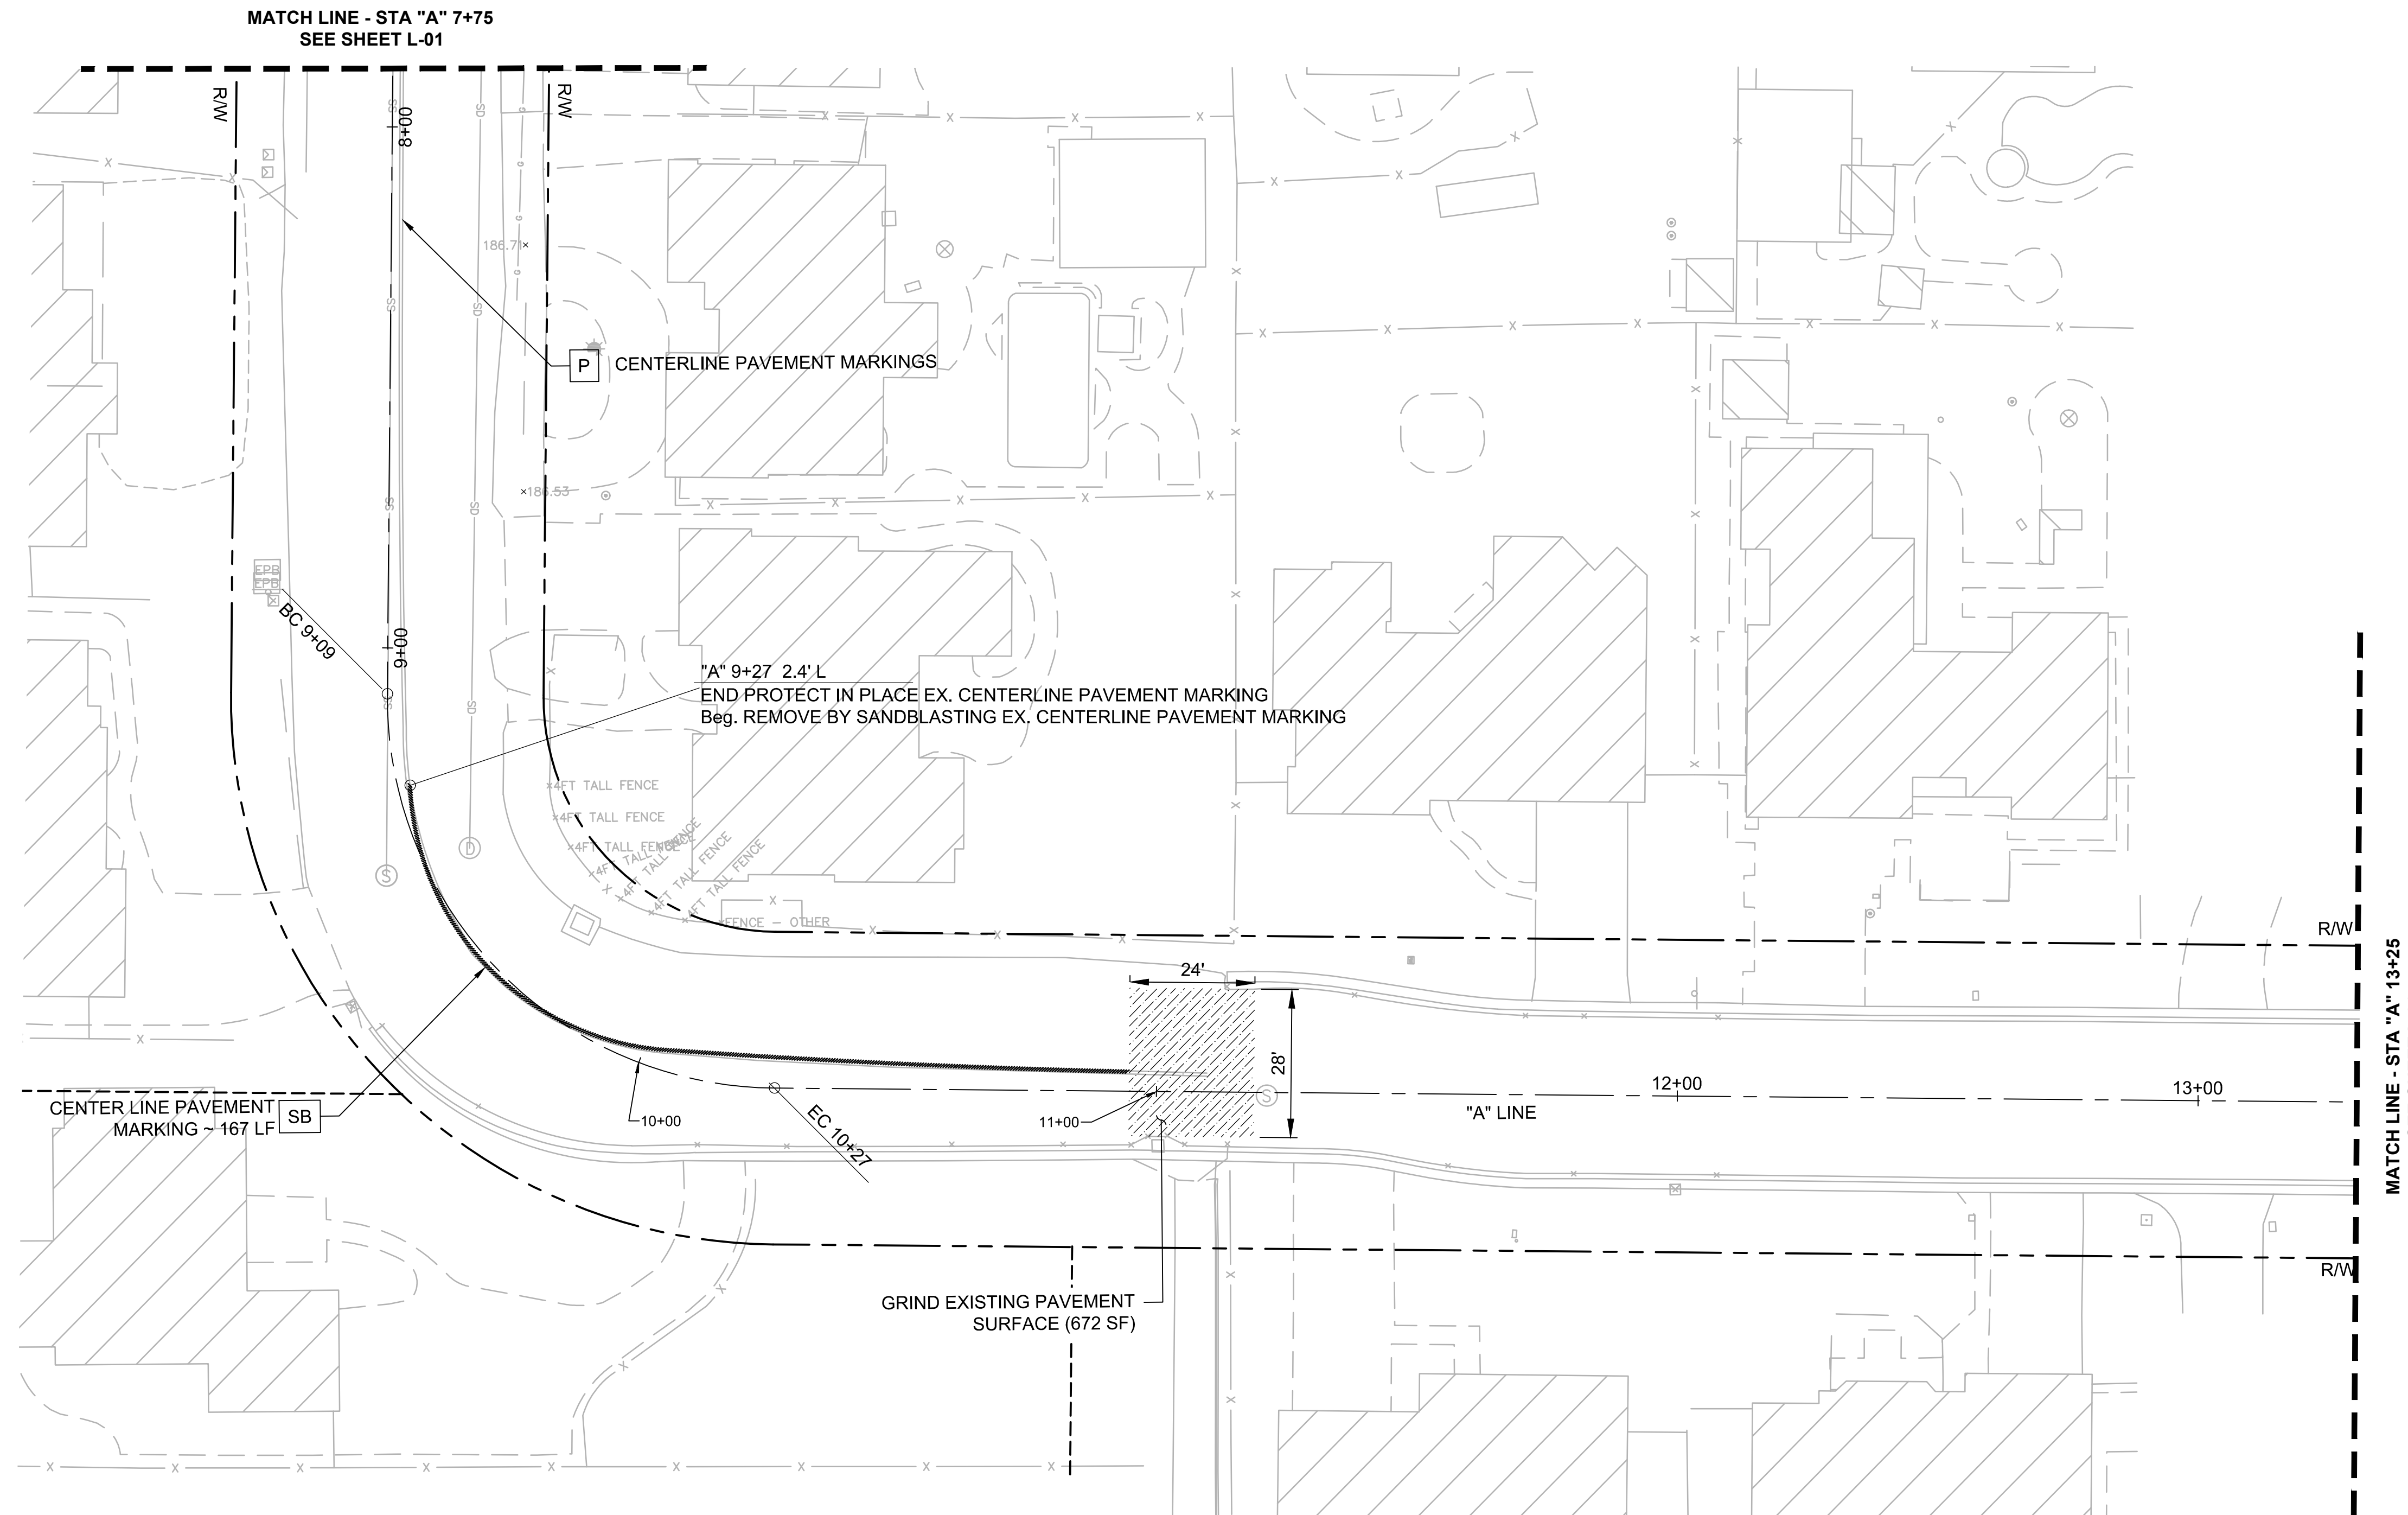
**CUESTA DRIVE
TRAFFIC CALMING**
Los Altos, California

DEMOLITION
PLANS

SHEET NO.
DM-04
7 OF 30

- NOTES:**
- FOR NOTES, LEGEND AND ABBREVIATIONS SEE SHEET GN-1.
 - FOR LAYOUT, GRADING & DRAINAGE DRAWING NUMBERS AT THIS LOCATION, SEE SHEET T-1, KEY MAP.
 - FOR ALIGNMENT CURVE AND LINE DATA, SEE SHEET GN-02.

- DEMOLITION LEGEND:**
- LEGEND FOR THIS SHEET ONLY.
LEGEND ITEMS DO NOT NECESSARILY APPEAR ON EVERY SHEET.
- SB REMOVE EXISTING STRIPING BY SANDBLASTING. ALL DEBRIS SHALL BE REMOVED BY THE END OF EACH WORKDAY.
 - P PROTECT IN PLACE EX. STRIPING AND PAVEMENT MARKINGS
 - GRIND 3" OF EXISTING ASPHALT PAVEMENT SURFACE (PER PLANS)



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2018-248	8/22/19	
PROJECT NO.	DATE	
18-248-Demo	Plans	
1"=20'	FILE	
SCALE		



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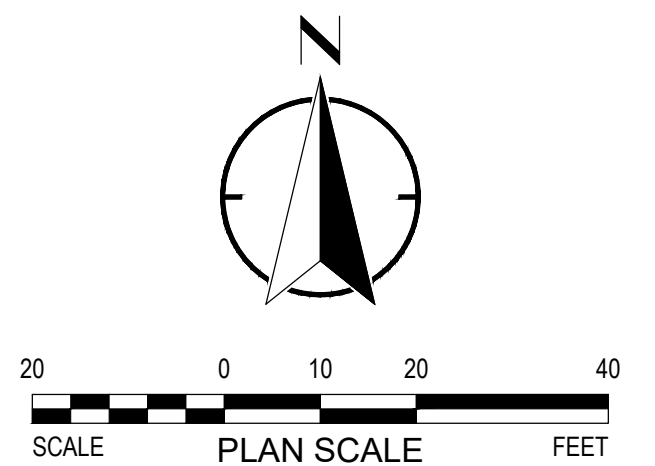
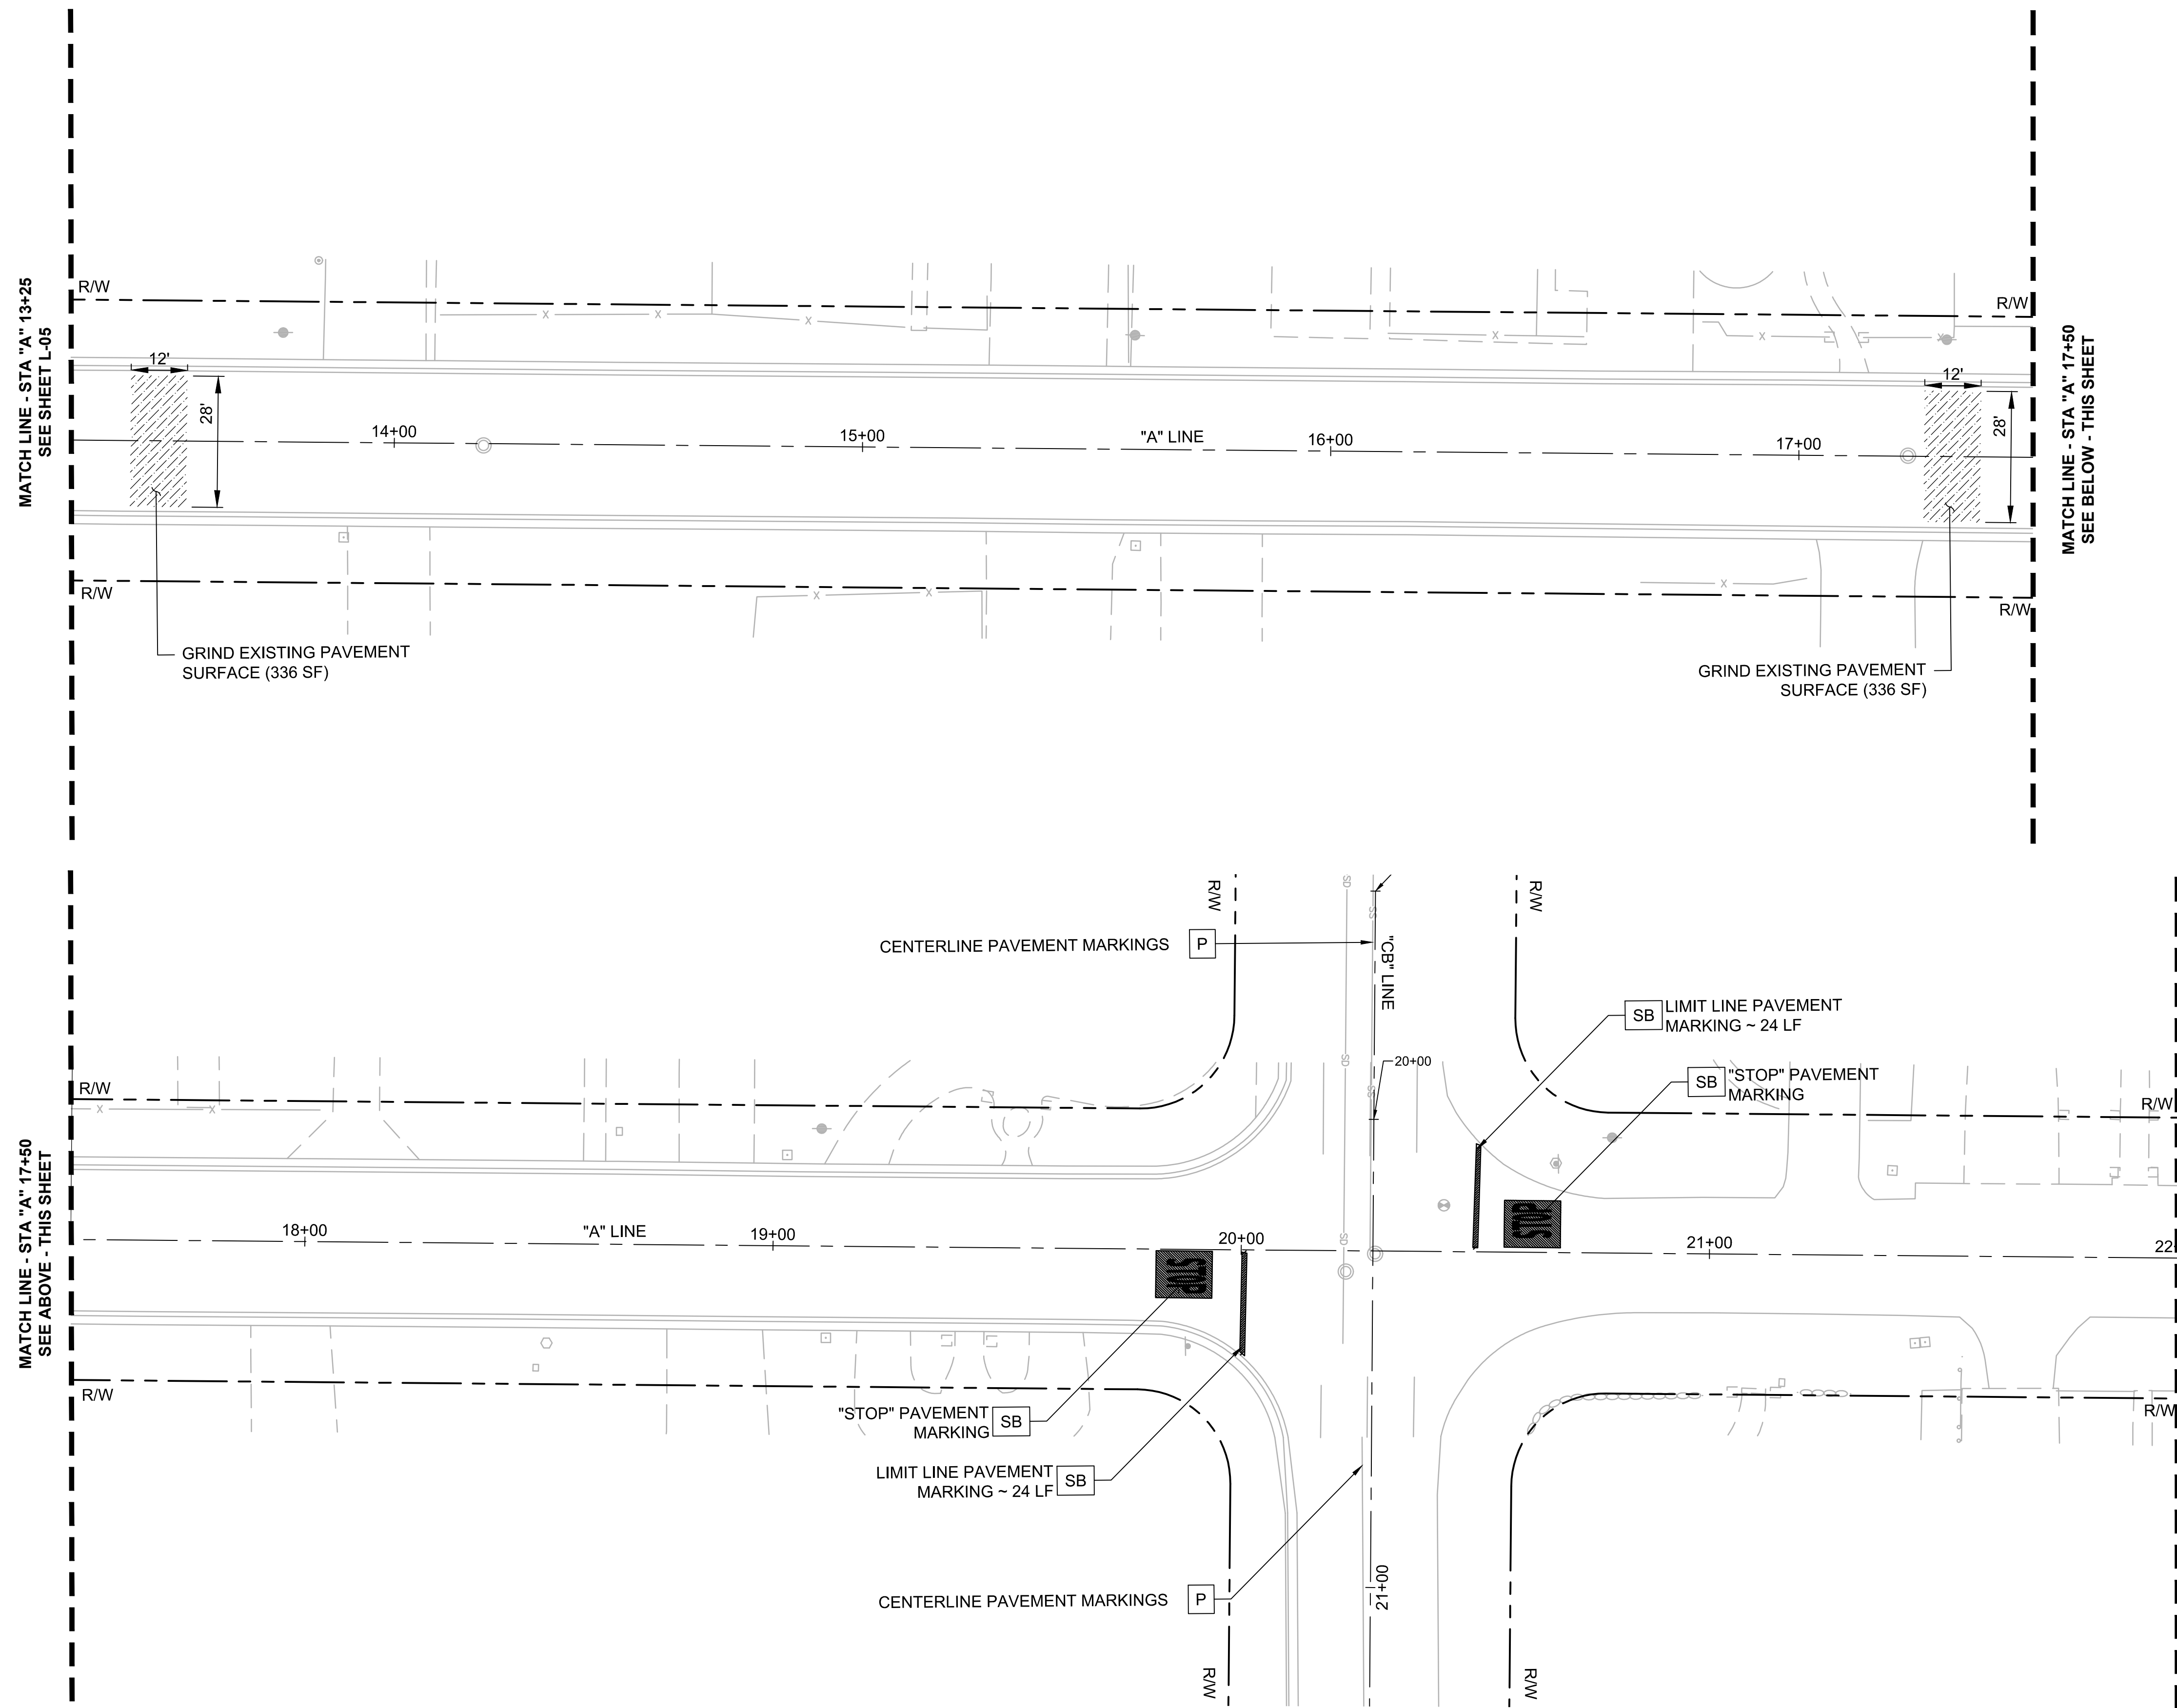
**CUESTA DRIVE
TRAFFIC CALMING**
Los Altos, California

DEMOLITION
PLANS

SHEET NO.
DM-05
8 OF 30

- NOTES:**
- FOR NOTES, LEGEND AND ABBREVIATIONS SEE SHEET GN-1.
 - FOR LAYOUT, GRADING & DRAINAGE DRAWING NUMBERS AT THIS LOCATION, SEE SHEET T-1, KEY MAP.
 - FOR ALIGNMENT CURVE AND LINE DATA, SEE SHEET GN-02.

- DEMOLITION LEGEND:**
- LEGEND FOR THIS SHEET ONLY.
LEGEND ITEMS DO NOT NECESSARILY APPEAR ON EVERY SHEET.
- SB REMOVE EXISTING STRIPING BY SANDBLASTING. ALL DEBRIS SHALL BE REMOVED BY THE END OF EACH WORKDAY.
 - P PROTECT IN PLACE EX. STRIPING AND PAVEMENT MARKINGS
 - GRIND 3" OF EXISTING ASPHALT PAVEMENT SURFACE (PER PLANS)



DESIGNED: CV	REVISIONS
REVIEWED: SF	NO DATE ITEM
DRAWN: JP	
2018-248 8/22/19	
PROJECT NO. DATE	
18-248-Demo	
1"=20'	
SCALE FILE	



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**CUESTA DRIVE
TRAFFIC CALMING**
Los Altos, California


SHEET NO.
DM-06
9 OF 30

NOTES:

1. FOR NOTES, LEGEND AND ABBREVIATIONS SEE SHEET GN-1.
2. FOR LAYOUT, GRADING & DRAINAGE DRAWING NUMBERS AT THIS LOCATION, SEE SHEET T-1, KEY MAP.
3. FOR ALIGNMENT CURVE AND LINE DATA, SEE SHEET GN-02.

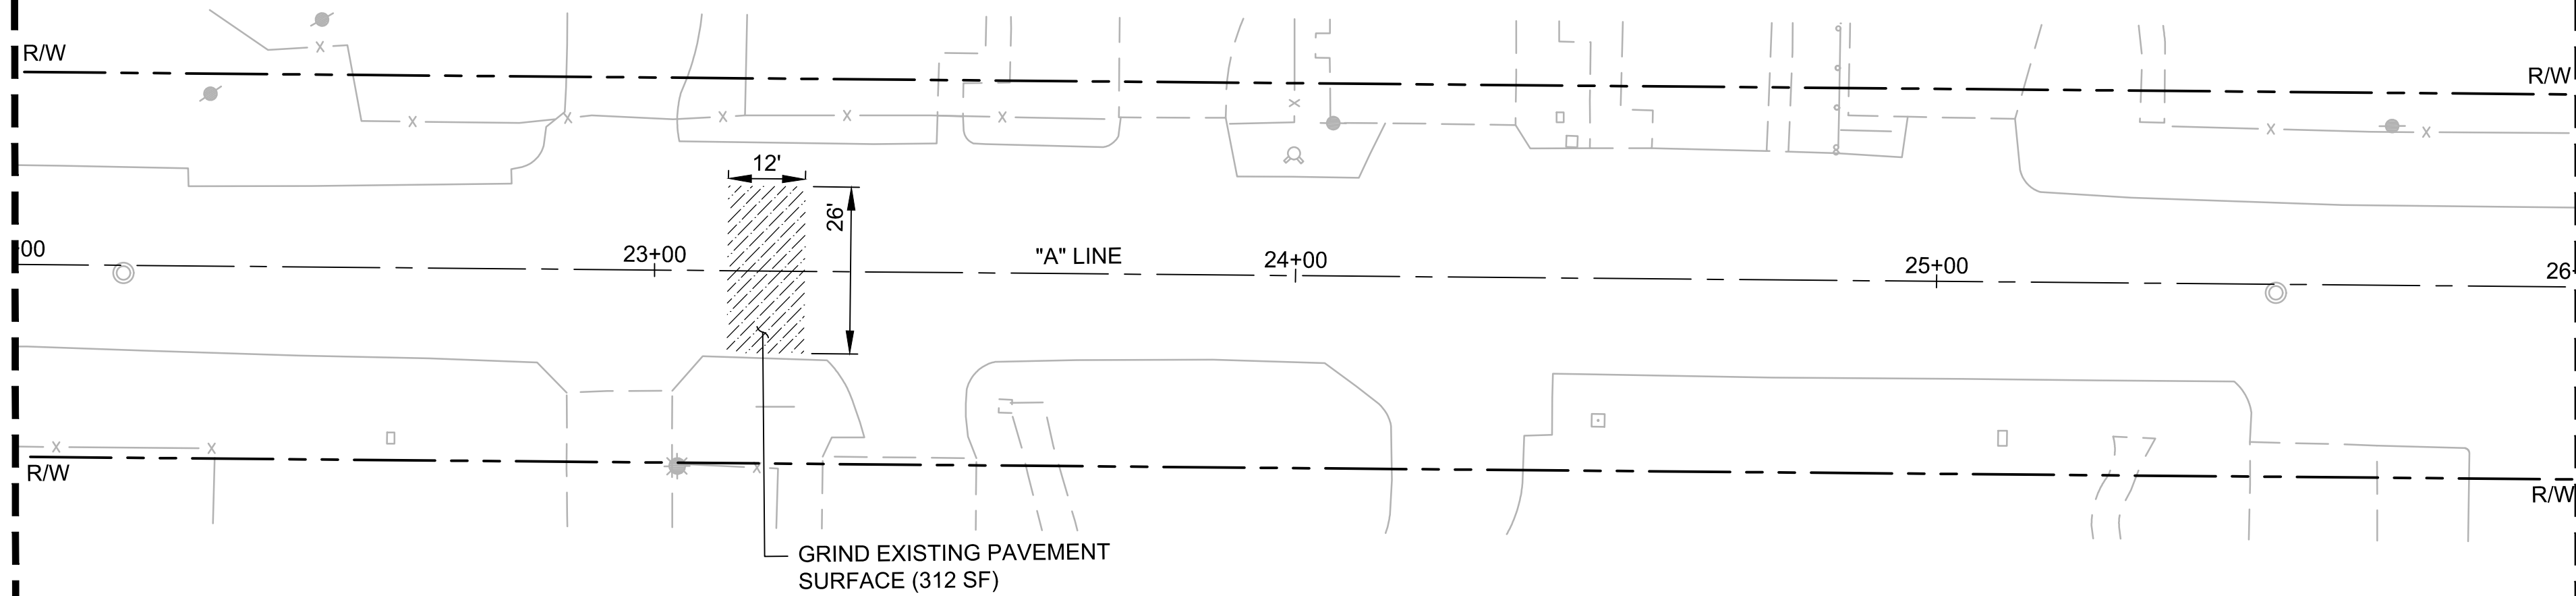
DEMOLITION LEGEND:

LEGEND FOR THIS SHEET ONLY.
LEGEND ITEMS DO NOT NECESSARILY APPEAR ON EVERY SHEET.

 GRIND 3" OF EXISTING ASPHALT PAVEMENT SURFACE (PER PLANS)



MATCH LINE - STA "A" 22+00
SEE SHEET L-06

MATCH LINE - STA "A" 26+00
SEE BELOW - THIS SHEET



MATCH LINE - STA "A" 26+00
SEE ABOVE - THIS SHEET

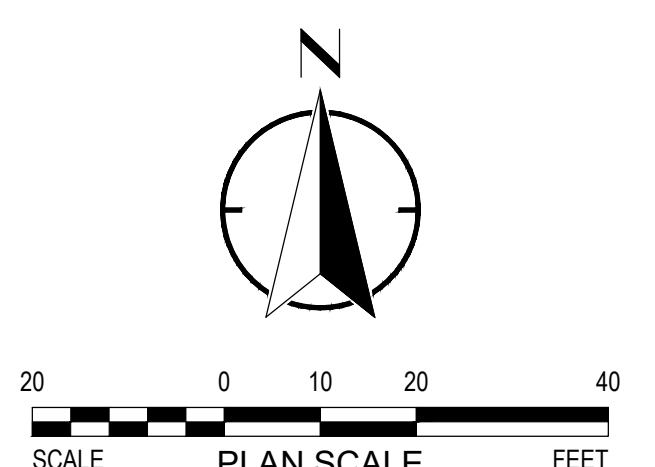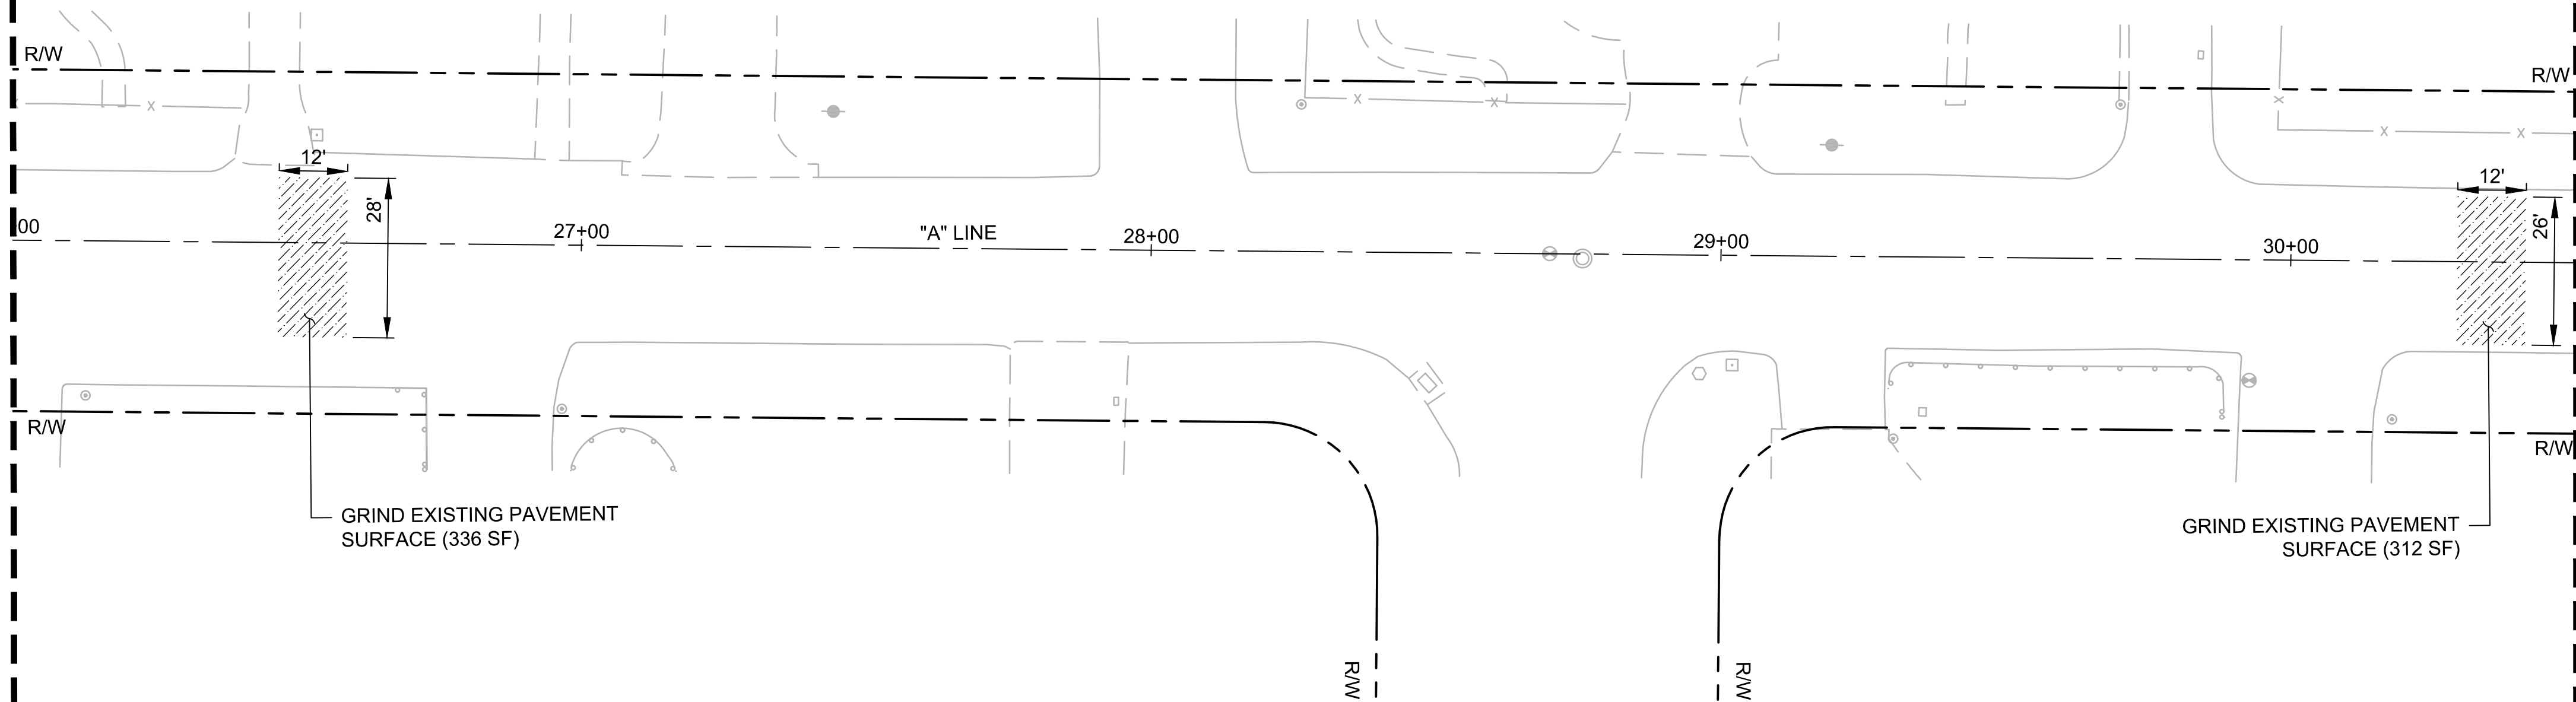MATCH LINE - STA "A" 30+50
SEE SHEET L-08



DESIGNED: _____	CV	REVISIONS
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2018-248	8/22/19	_____
PROJECT NO.	DATE	_____
18-248-Demo	Plans	_____
1"=20'	FILE	_____
SCALE		_____



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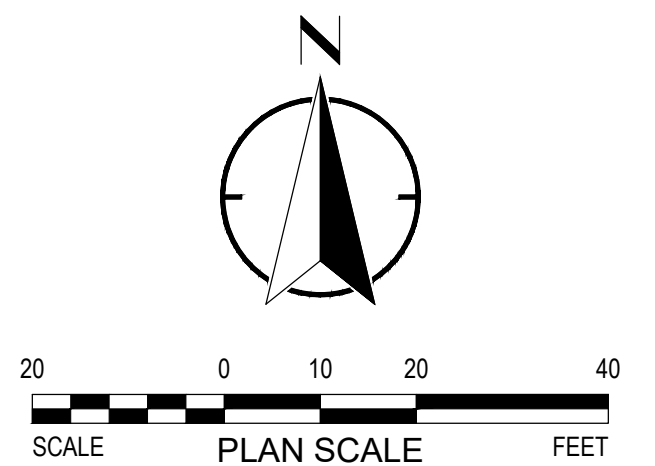
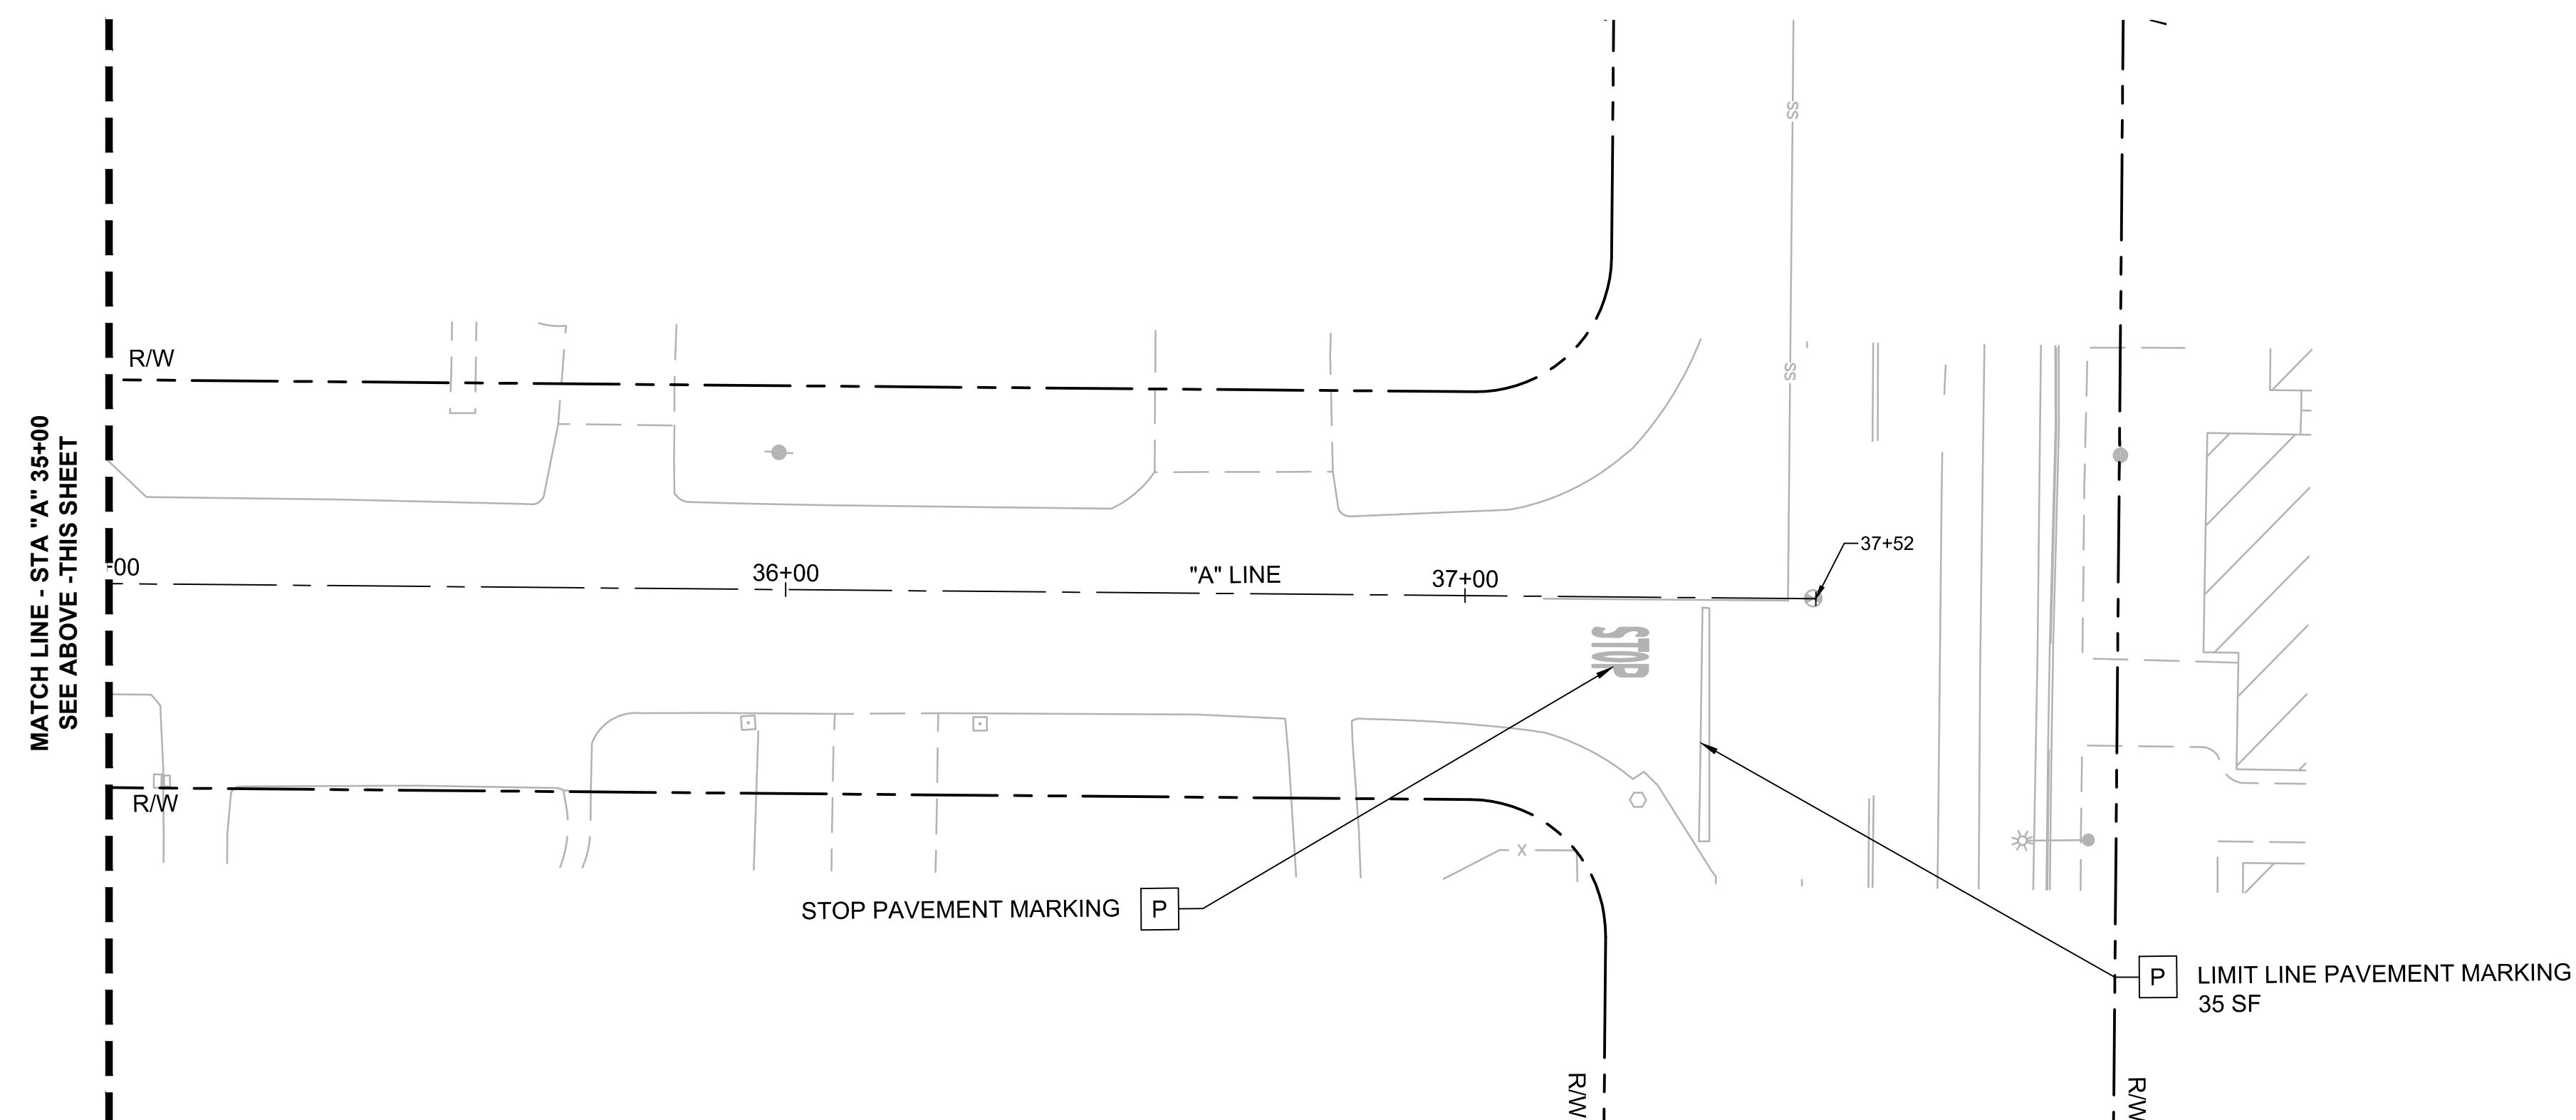
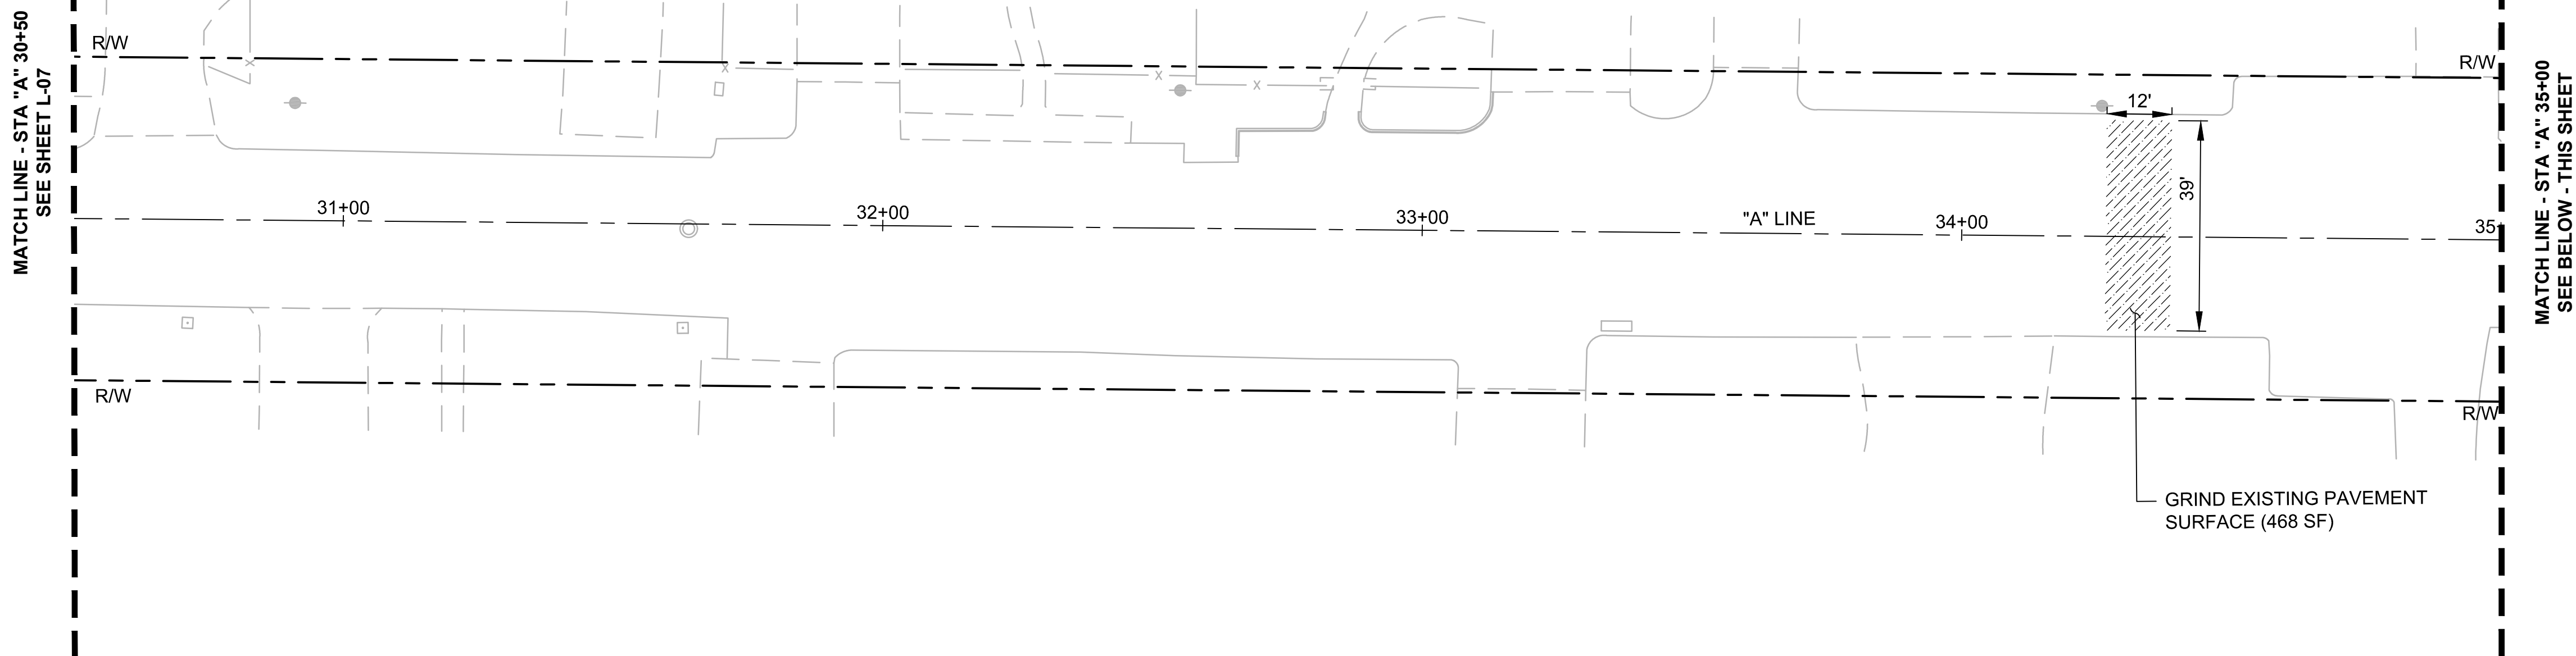
**CUESTA DRIVE
TRAFFIC CALMING**
Los Altos, California

DEMOLITION
PLANS

SHEET NO.
DM-07
10 OF 30

- NOTES:**
- FOR NOTES, LEGEND AND ABBREVIATIONS SEE SHEET GN-1.
 - FOR LAYOUT, GRADING & DRAINAGE DRAWING NUMBERS AT THIS LOCATION, SEE SHEET T-1, KEY MAP.
 - FOR ALIGNMENT CURVE AND LINE DATA, SEE SHEET GN-02.

- DEMOLITION LEGEND:**
- LEGEND FOR THIS SHEET ONLY.
LEGEND ITEMS DO NOT NECESSARILY APPEAR ON EVERY SHEET.
- P PROTECT IN PLACE EX. STRIPING AND PAVEMENT MARKINGS
 - GRIND 3" OF EXISTING ASPHALT PAVEMENT SURFACE (PER PLANS)



DESIGNED: _____	CV	REVISIONS
REVIEWED: _____	SF	NO DATE ITEM
DRAWN: _____	JP	_____
2018-248	8/22/19	_____
PROJECT NO.	DATE	_____
18-248-Demo	Plans	_____
1"=20'	FILE	_____
SCALE		_____



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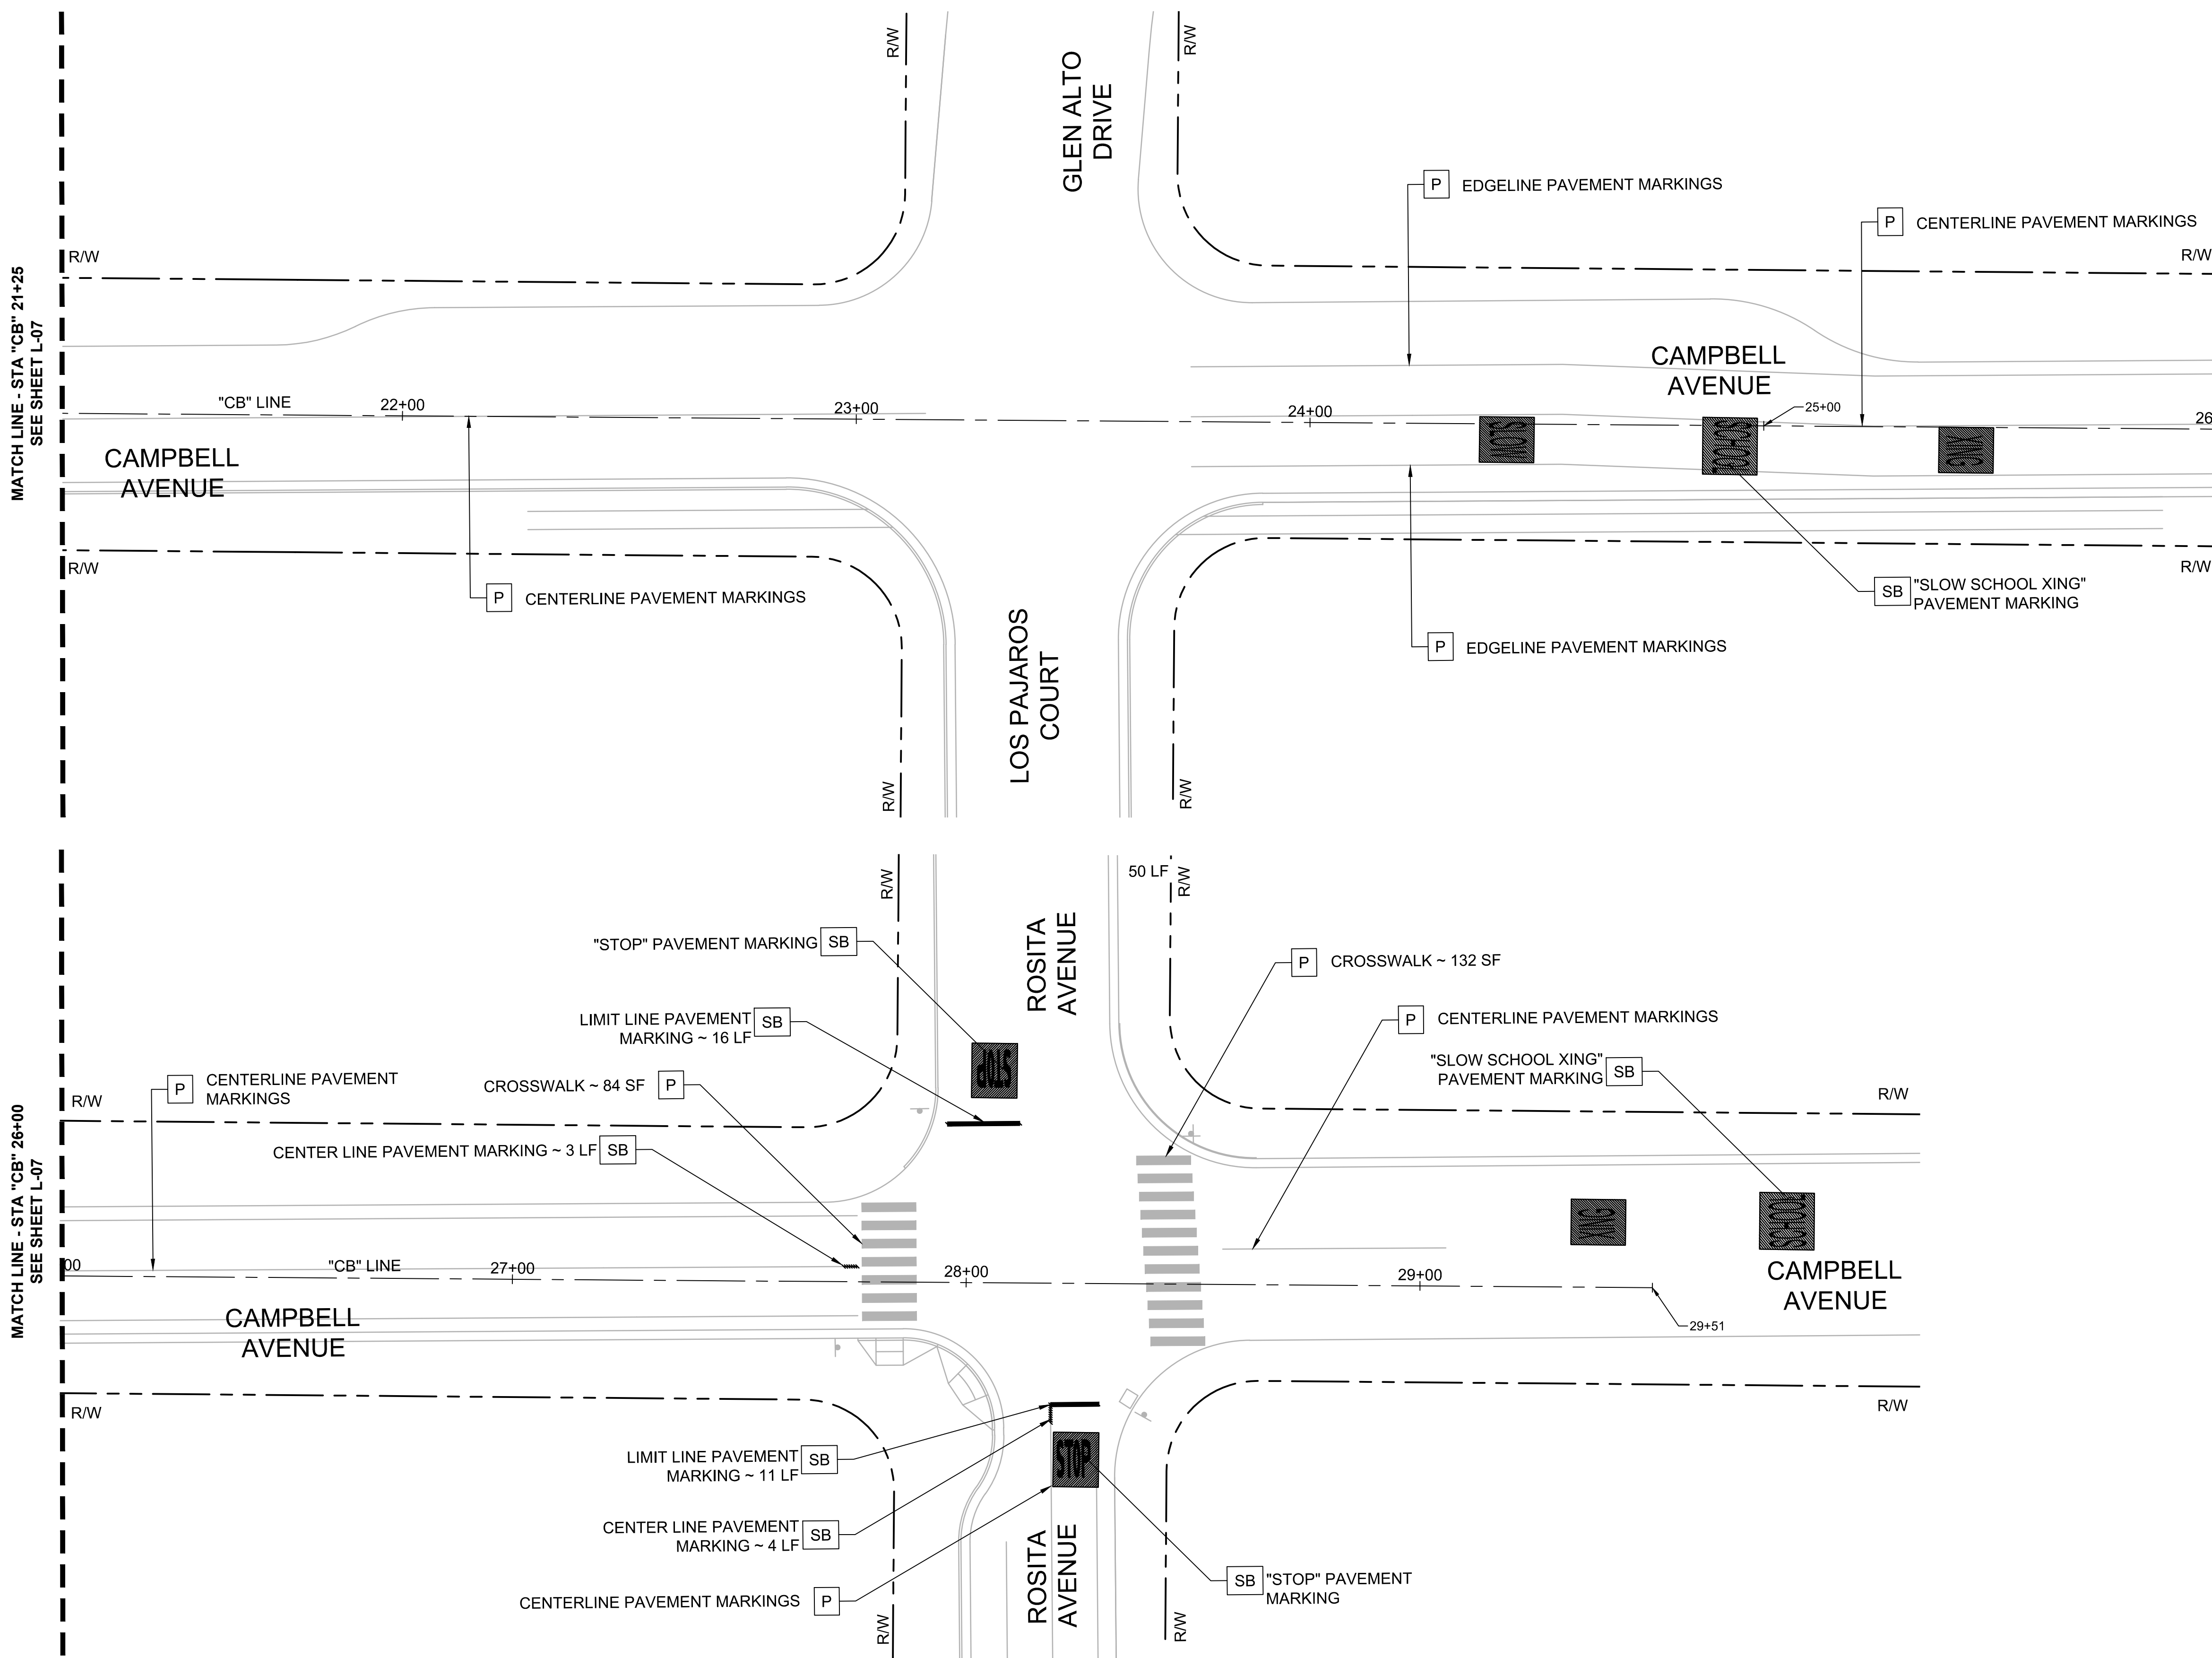


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**CUESTA DRIVE
TRAFFIC CALMING**
Los Altos, California

DEMOLITION
PLANS

SHEET NO.
DM-08
11 OF 30

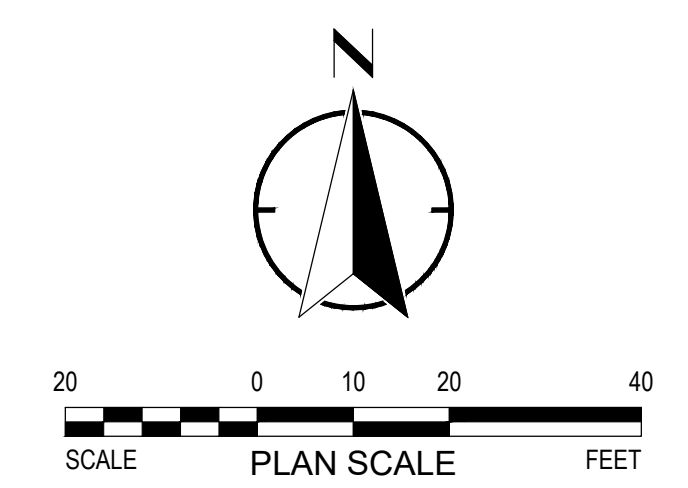


- NOTES:**
- FOR NOTES, LEGEND AND ABBREVIATIONS SEE SHEET GN-1.
 - FOR LAYOUT, GRADING & DRAINAGE DRAWING NUMBERS AT THIS LOCATION, SEE SHEET T-1, KEY MAP.
 - FOR ALIGNMENT CURVE AND LINE DATA, SEE SHEET GN-02.

- DEMOLITION LEGEND:**
- LEGEND FOR THIS SHEET ONLY.
LEGEND ITEMS DO NOT NECESSARILY APPEAR ON EVERY SHEET.
- SB REMOVE EXISTING STRIPING BY SANDBLASTING. ALL DEBRIS SHALL BE REMOVED BY THE END OF EACH WORKDAY.
 - P PROTECT IN PLACE EX. STRIPING AND PAVEMENT MARKINGS

MATCH LINE - STA "CB" 26+00
SEE SHEET L-07

MATCH LINE - STA "CB" 26+00
SEE BELOW - THIS SHEET



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REVIEWED: _____	SF	NO DATE ITEM
DRAWN: _____	JP	_____
2018-248	8/22/19	_____
PROJECT NO.	DATE	_____
18-248-Demo	Plans	_____
1"=20'	FILE	_____
SCALE		_____



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**CUESTA DRIVE
TRAFFIC CALMING**
Los Altos, California

DEMOLITION
PLANS

SHEET NO.
DM-09
12 OF 30

NOTES:

- FOR NOTES, LEGEND AND ABBREVIATIONS SEE SHEET GN-1.
- FOR DEMOLITION, GRADING & DRAINAGE DRAWING NUMBERS AT THIS LOCATION, SEE SHEET T-1, KEY MAP.
- FOR ALIGNMENT CURVE AND LINE DATA, SEE SHEET GN-02.

CONSTRUCTION NOTES:

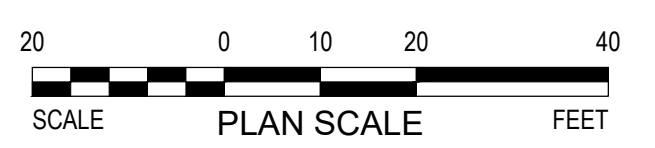
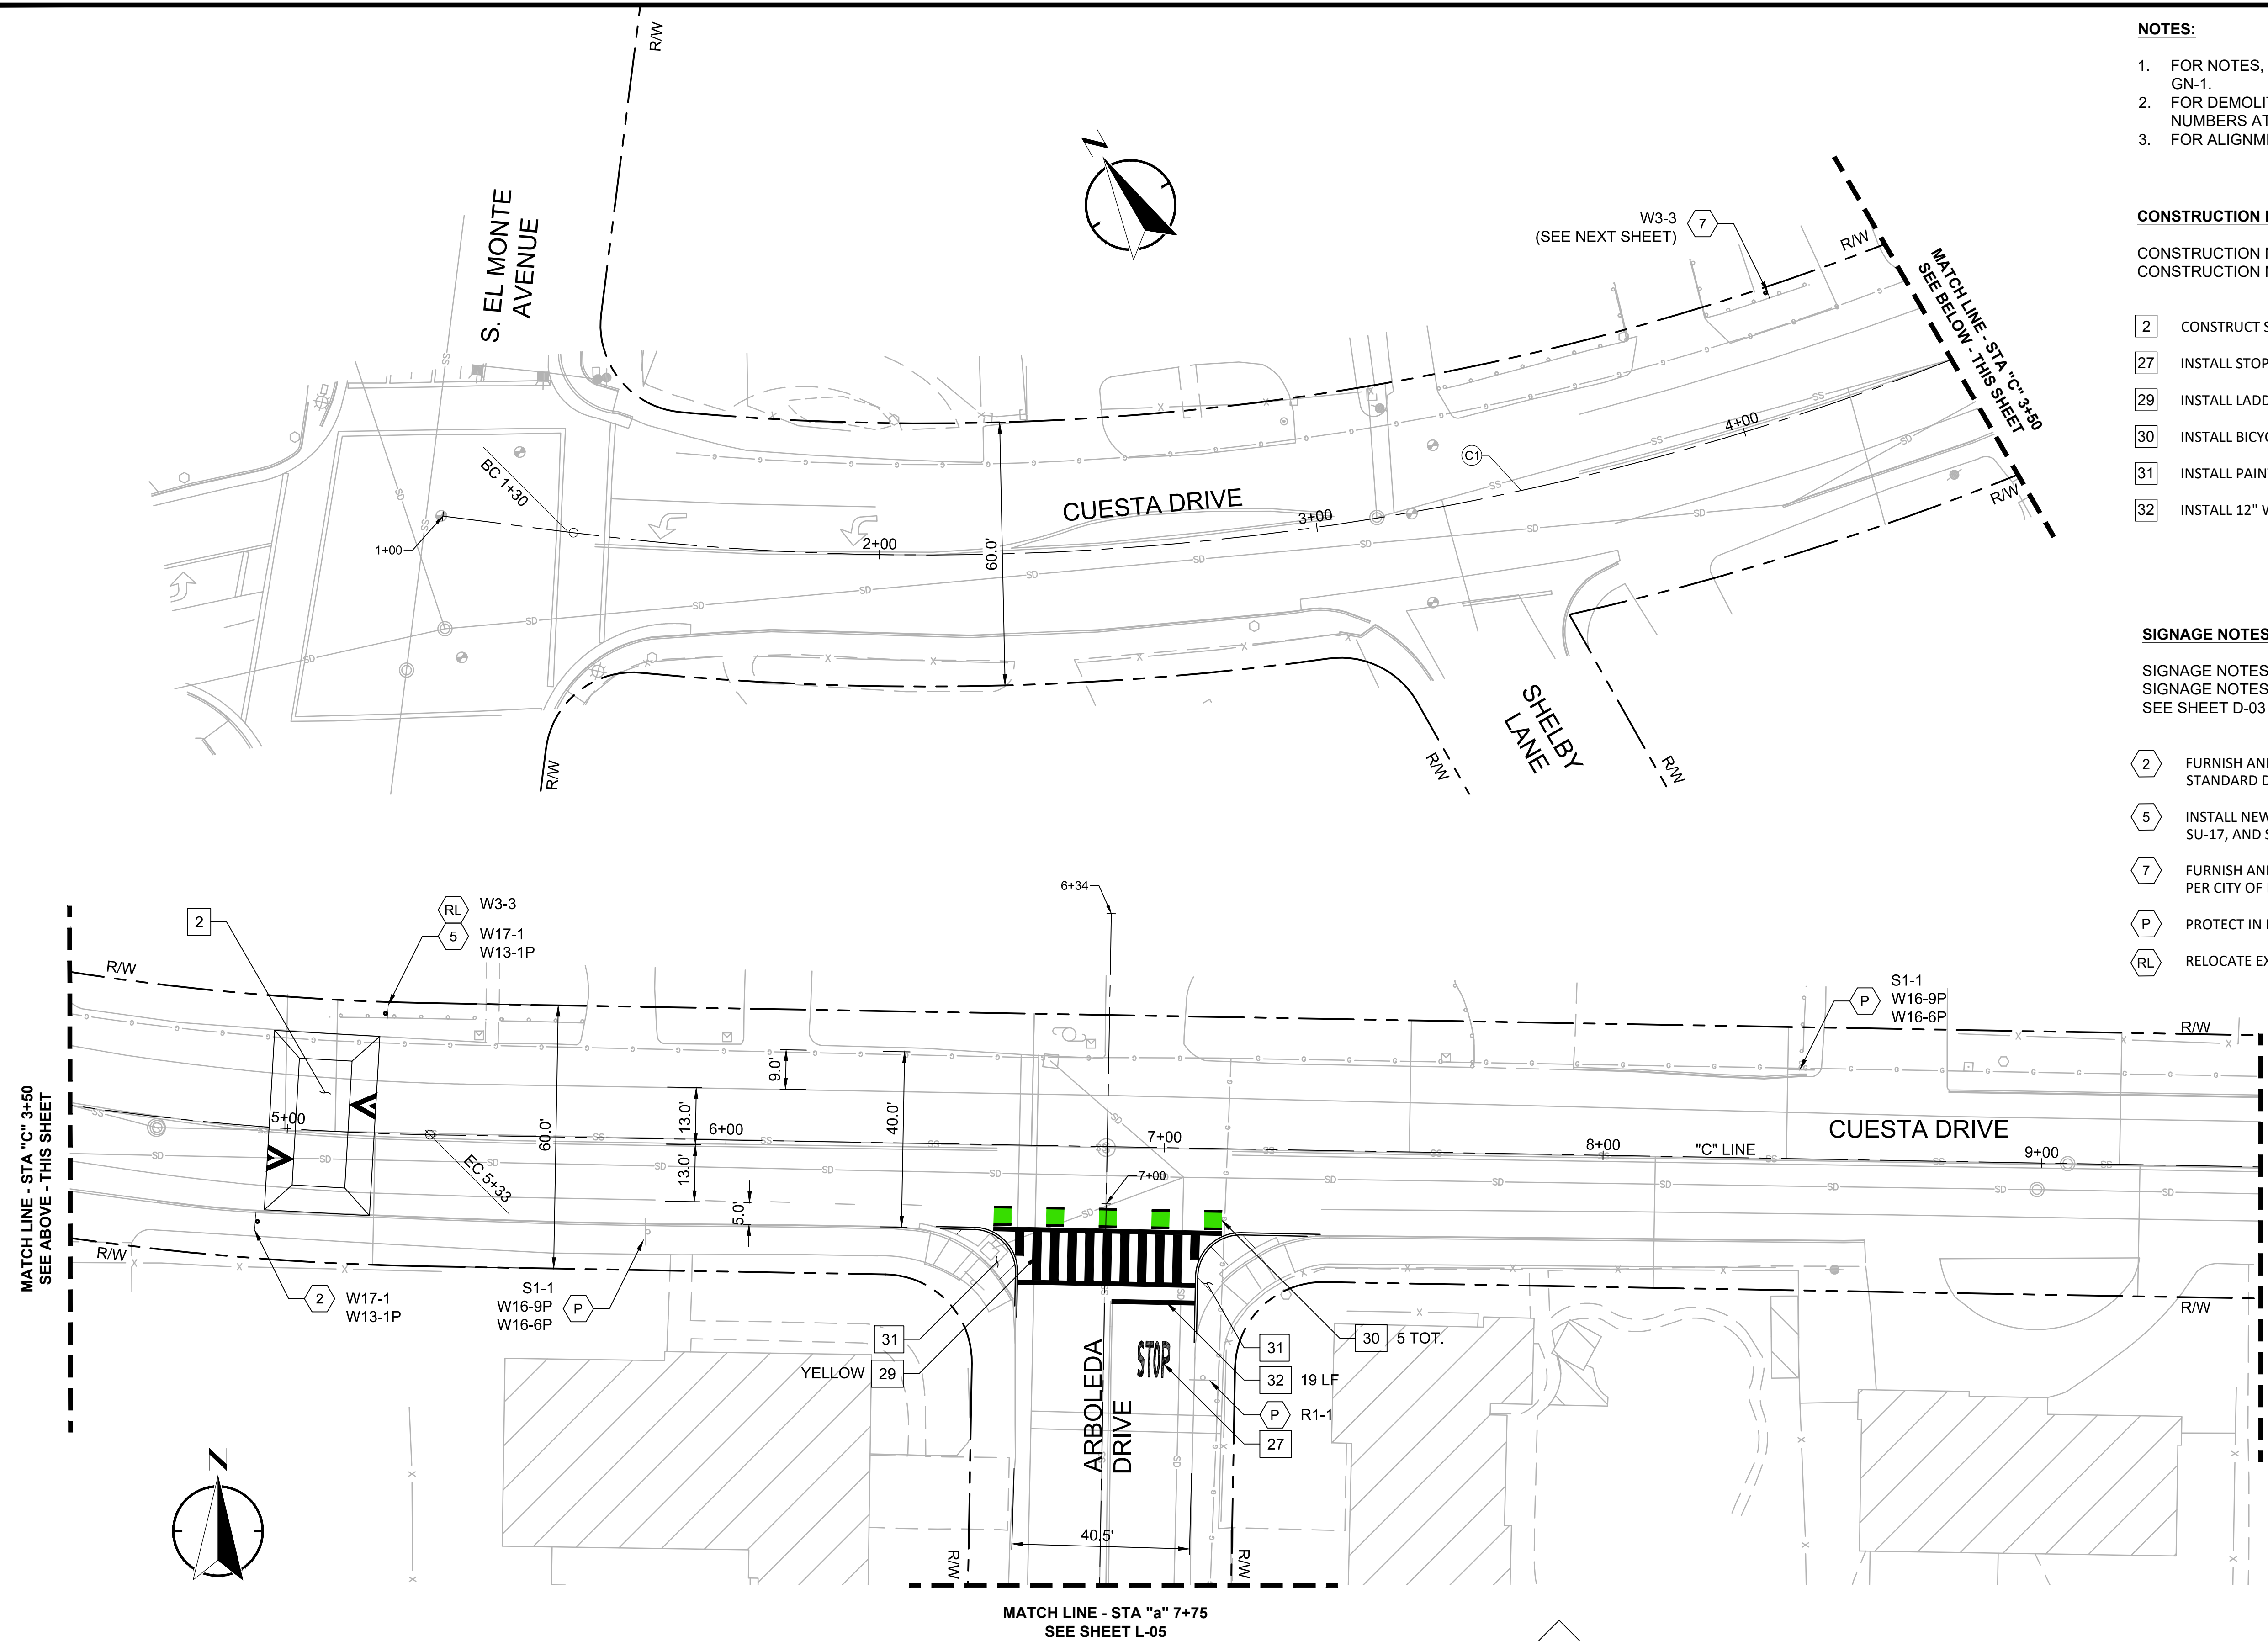
CONSTRUCTION NOTES FOR THIS SHEET ONLY.
CONSTRUCTION NOTES DO NOT NECESSARILY APPEAR ON EVERY SHEET.

- 2 CONSTRUCT SPEED TABLE PER DETAIL 2, SHEET D-01
- 27 INSTALL STOP LANE MARKING PER CALTRANS STD. PLAN A24D
- 29 INSTALL LADDER STYLE HIGH VISIBILITY CROSSWALK PER DETAIL 1, SHEET D-02
- 30 INSTALL BICYCLE CONFLICT MARKINGS PER DETAIL 2, SHEET D-02
- 31 INSTALL PAINTED CURB EXTENSION PER DETAIL 3, SHEET D-02
- 32 INSTALL 12" WHITE LIMIT LINE


SIGNAGE NOTES:

SIGNAGE NOTES FOR THIS SHEET ONLY.
SIGNAGE NOTES DO NOT NECESSARILY APPEAR ON EVERY SHEET.
SEE SHEET D-03 FOR SIGNING SCHEDULES.

- 2 FURNISH AND INSTALL NEW SINGLE SIDED SIGN PER CITY OF LOS ALTOS STANDARD DETAIL SU-17, AND SHEET D-05
- 5 INSTALL NEW SIGN ON EXISTING POST PER CITY OF LOS ALTOS STANDARD DETAIL SU-17, AND SHEET D-05
- 7 FURNISH AND INSTALL NEW SIGN POST AND INSTALL RELOCATED EXISTING SIGN, PER CITY OF LOS ALTOS STANDARD DETAIL SU-17, AND SHEET D-05
- P PROTECT IN PLACE EXISTING SIGN(S) AND POST
- RL RELOCATE EXISTING SIGN, PROTECT IN PLACE EXISTING POST




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REVIEWED: SF	NO DATE ITEM
DRAWN: JP	
2018-248 PROJECT NO.	8/22/19 DATE
1"=20' SCALE	18-248-Layouts FILE

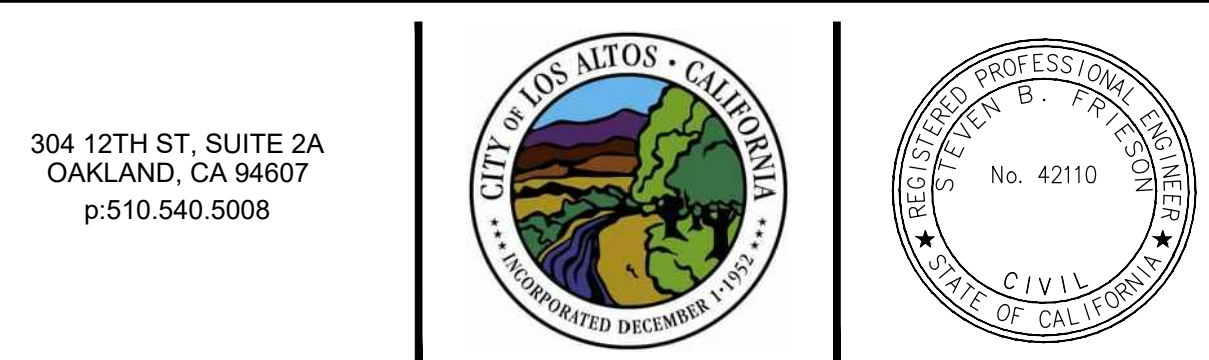

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CUESTA DRIVE TRAFFIC CALMING
Los Altos, California

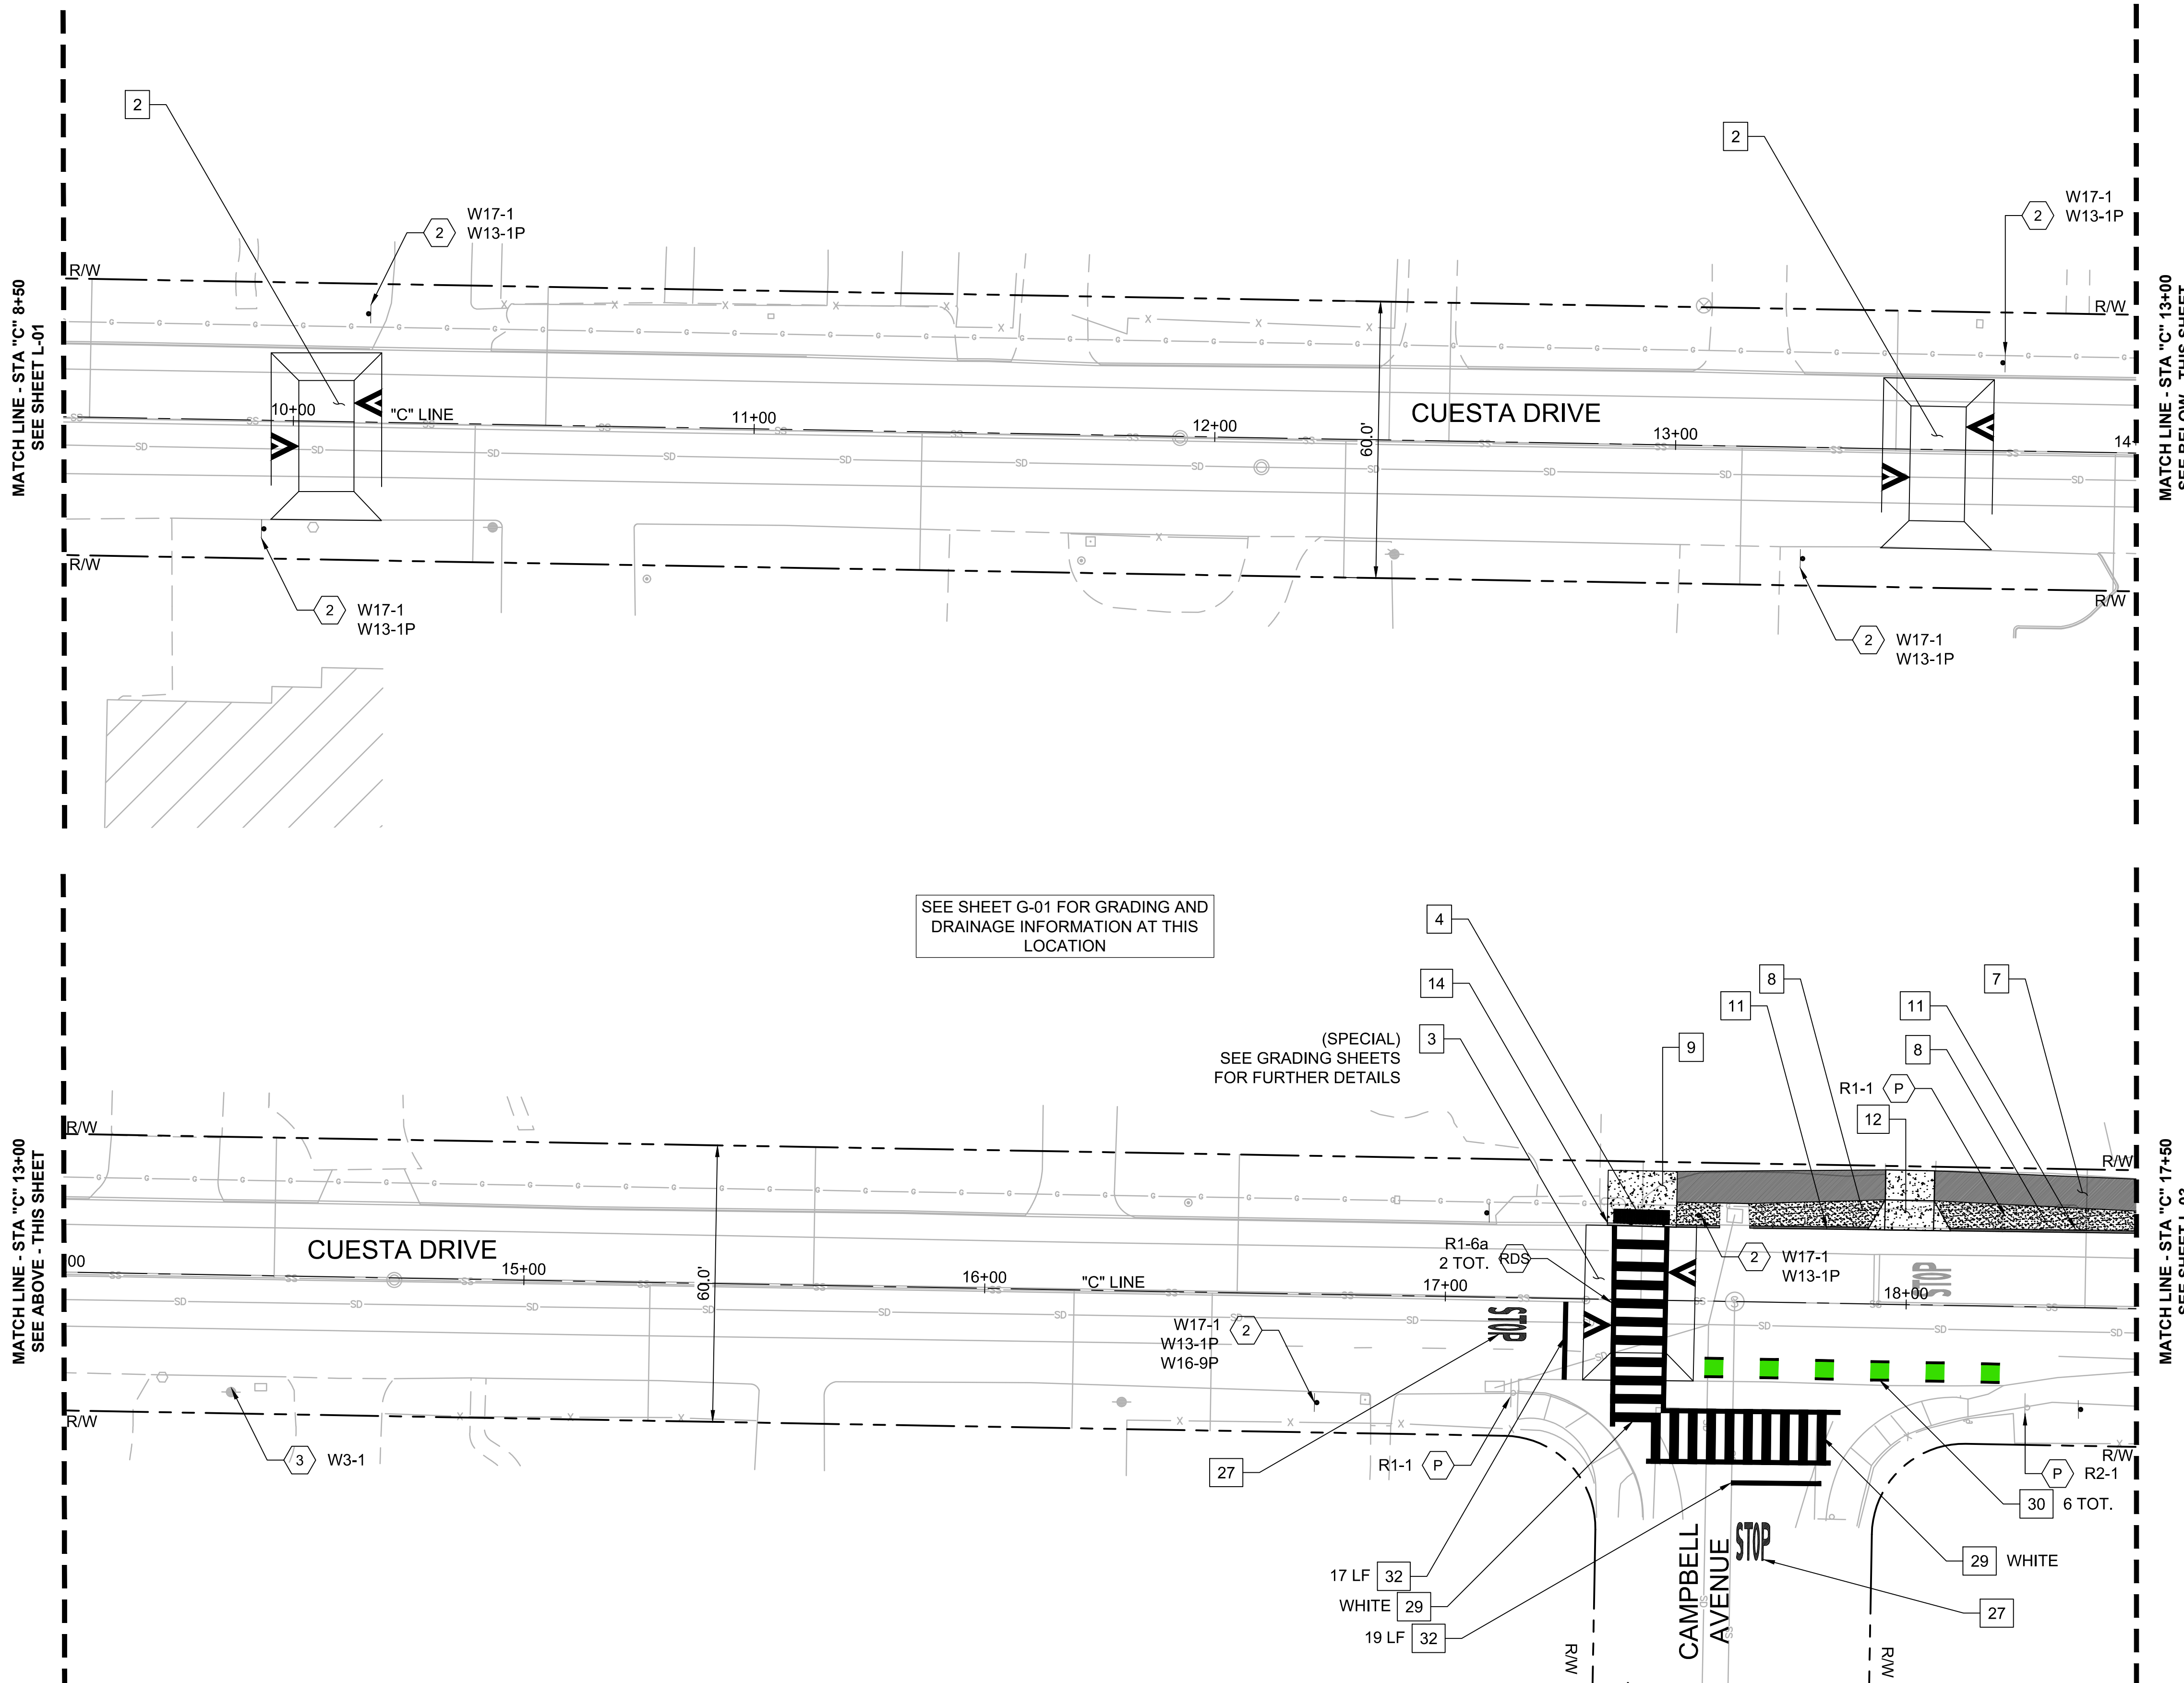LAYOUT PLANS SHEET NO. **L-01**
13 OF **30**



- NOTES:**
- FOR NOTES, LEGEND AND ABBREVIATIONS SEE SHEET GN-1.
 - FOR DEMOLITION, GRADING & DRAINAGE DRAWING NUMBERS AT THIS LOCATION, SEE SHEET T-1, KEY MAP.
 - FOR ALIGNMENT CURVE AND LINE DATA, SEE SHEET GN-02.

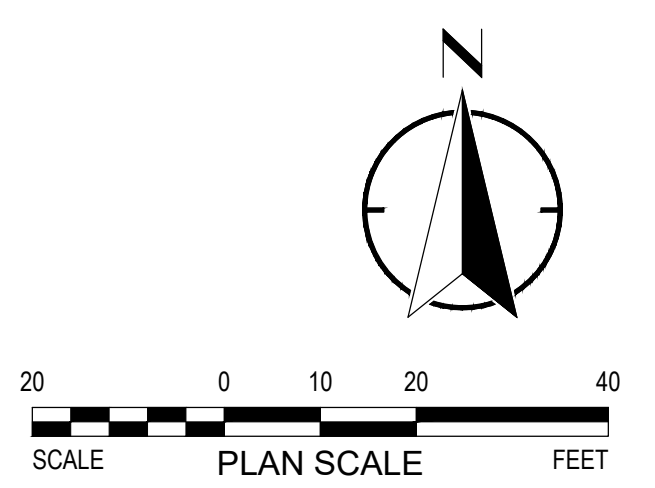
CONSTRUCTION NOTES:
 CONSTRUCTION NOTES FOR THIS SHEET ONLY.
 CONSTRUCTION NOTES DO NOT NECESSARILY APPEAR ON EVERY SHEET.

- 2 CONSTRUCT SPEED TABLE PER DETAIL 2, SHEET D-01
- 3 CONSTRUCT SPEED TABLE RAISED CROSSWALK PER DETAIL 3, SHEET D-01
- 4 FURNISH AND INSTALL 36" IN WIDTH CAST IRON DETECTABLE WARNING SURFACE, PER CALTRANS STD. PLAN A88A
- 7 INSTALL A.C. SECTION PER DETAIL 4, SHEET D-02
- 8 INSTALL DG SECTION PER DETAIL 4, SHEET D-02
- 9 INSTALL PCC SIDEWALK SECTION PER CITY OF LOS ALTOS STAND DETAIL SU-8, AND SHEET D-04
- 11 INSTALL AC BERM PER CITY OF LOS ALTOS STAND DETAIL SU-7, AND SHEET D-04
- 12 RECONSTRUCT EXISTING DRIVEWAY PER CITY OF LOS ALTOS STANDARD DETAIL SU-11, AND SHEET D-04
- 14 INSTALL PCC CURB PER CITY OF LOS ALTOS STAND DETAIL SU-7, AND SHEET D-04
- 27 INSTALL STOP LANE MARKING PER CALTRANS STD. PLAN A24D
- 29 INSTALL LADDER STYLE HIGH VISIBILITY CROSSWALK PER DETAIL 1, SHEET D-02
- 30 INSTALL BICYCLE CONFLICT MARKINGS PER DETAIL 2, SHEET D-02
- 32 INSTALL 12" WHITE LIMIT LINE

SIGNAGE NOTES:
 SIGNAGE NOTES FOR THIS SHEET ONLY.
 SIGNAGE NOTES DO NOT NECESSARILY APPEAR ON EVERY SHEET.
 SEE SHEET D-03 FOR SIGNING SCHEDULES.

- 2 FURNISH AND INSTALL NEW SINGLE SIDED SIGN PER CITY OF LOS ALTOS STANDARD DETAIL SU-17, AND SHEET D-05
- 3 FURNISH AND INSTALL NEW STOP SIGN OR STOP PLAQUE ON EXISTING SIGN POST PER CITY OF LOS ALTOS STANDARD DETAIL SU-17, AND SHEET D-05
- P PROTECT IN PLACE EXISTING SIGN(S) AND POST

- LEGEND:**
- PCC SECTION
 - DETECTABLE WARNING SURFACE
 - D.G. SECTION
 - ASPHALT SECTION



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2018-248 PROJECT NO.	8/22/19 DATE
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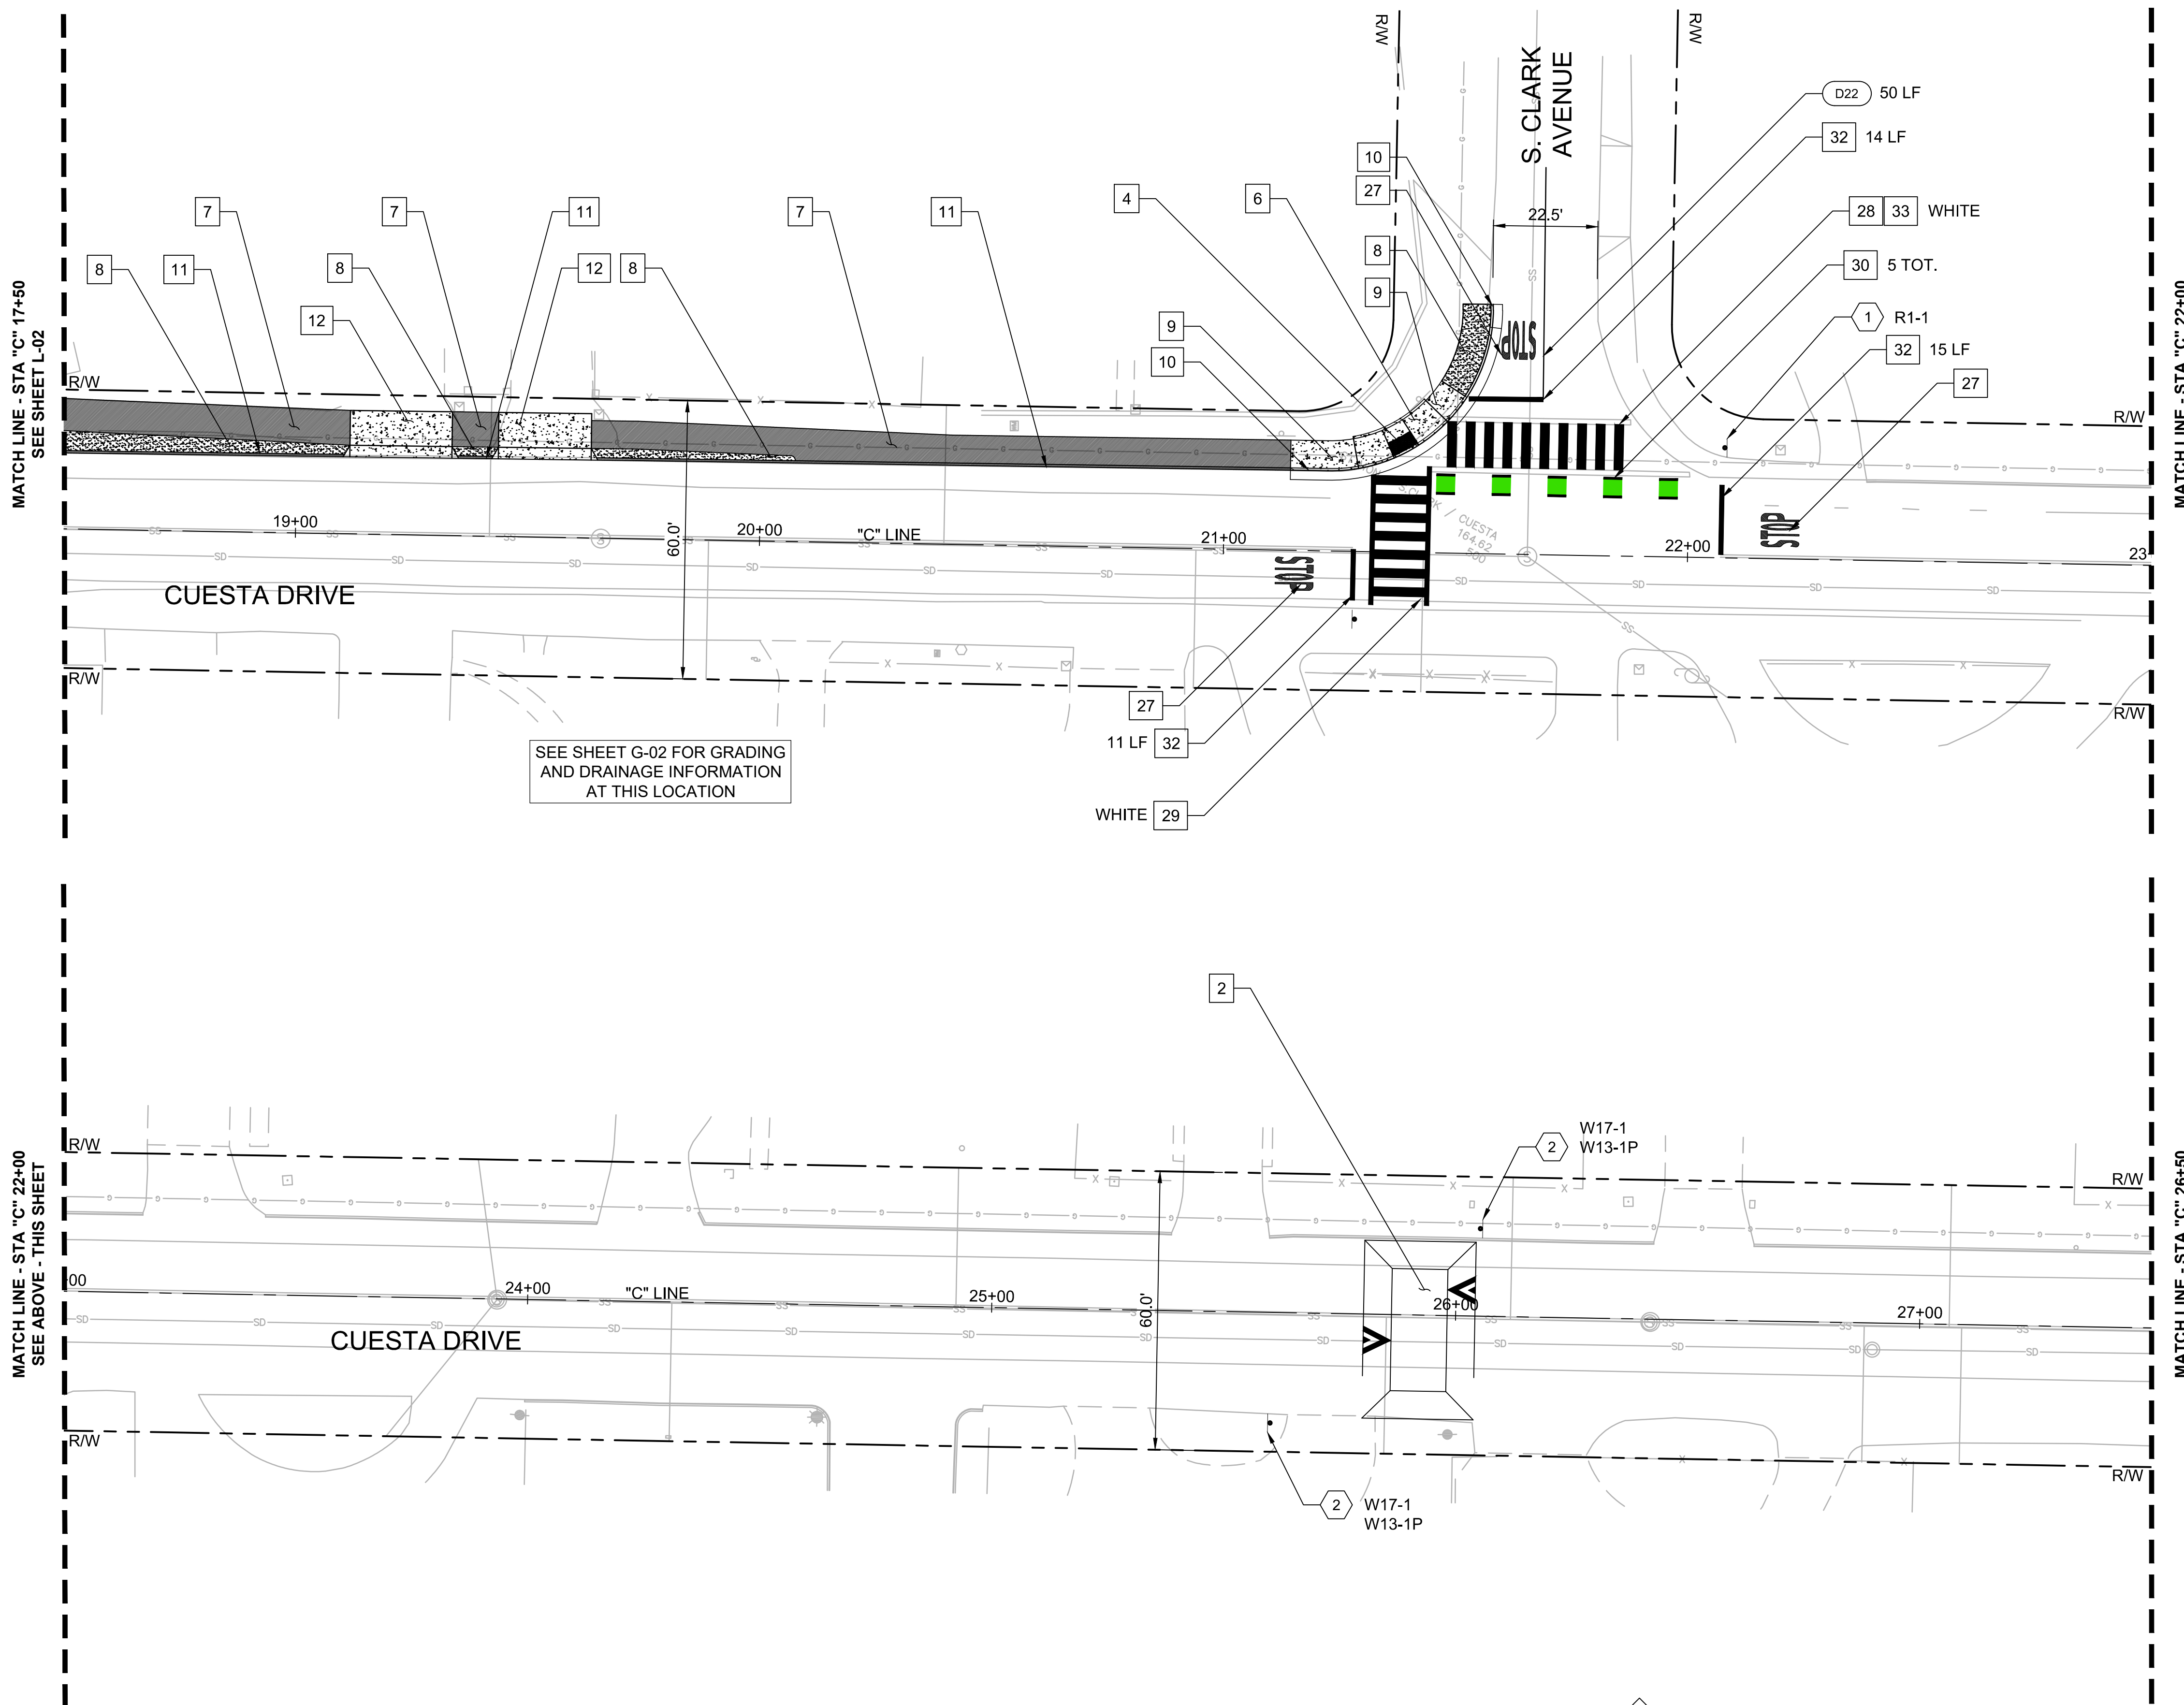
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**CUESTA DRIVE
 TRAFFIC CALMING**
 Los Altos, California

SHEET NO.
 LAYOUT PLANS
L-02
 14 OF 30



- NOTES:**
- FOR NOTES, LEGEND AND ABBREVIATIONS SEE SHEET GN-1.
 - FOR DEMOLITION, GRADING & DRAINAGE DRAWING NUMBERS AT THIS LOCATION, SEE SHEET T-1, KEY MAP.
 - FOR ALIGNMENT CURVE AND LINE DATA, SEE SHEET GN-02.

CONSTRUCTION NOTES:
 CONSTRUCTION NOTES FOR THIS SHEET ONLY.
 CONSTRUCTION NOTES DO NOT NECESSARILY APPEAR ON EVERY SHEET.

- 2 CONSTRUCT SPEED TABLE PER DETAIL 2, SHEET D-01
- 3 CONSTRUCT SPEED TABLE RAISED CROSSWALK PER DETAIL 3, SHEET D-01
- 4 FURNISH AND INSTALL 36" IN WIDTH CAST IRON DETECTABLE WARNING SURFACE, PER CALTRANS STD. PLAN A88A
- 7 INSTALL A.C. SECTION PER DETAIL 4, SHEET D-02
- 8 INSTALL DG SECTION PER DETAIL 4, SHEET D-02
- 9 INSTALL PCC SIDEWALK SECTION PER CITY OF LOS ALTOS STAND DETAIL SU-8, AND SHEET D-04
- 10 INSTALL PCC CURB AND GUTTER PER CITY OF LOS ALTOS STAND DETAIL SU-6, AND SHEET D-04
- 11 INSTALL AC BERM PER CITY OF LOS ALTOS STAND DETAIL SU-7, AND SHEET D-04
- 12 RECONSTRUCT EXISTING DRIVEWAY PER CITY OF LOS ALTOS STANDARD DETAIL SU-11, AND SHEET D-04
- 27 INSTALL STOP LANE MARKING PER CALTRANS STD. PLAN A24D
- 28 INSTALL CONTINENTAL STYLE HIGH VISIBILITY CROSSWALK PER DETAIL 1, SHEET D-02
- 29 INSTALL LADDER STYLE HIGH VISIBILITY CROSSWALK PER DETAIL 1, SHEET D-02
- 30 INSTALL BICYCLE CONFLICT MARKINGS PER DETAIL 2, SHEET D-02
- 32 INSTALL 12" WHITE LIMIT LINE
- 33 INSTALL CONTINENTAL STYLE CROSSWALK WITHIN LIMITS OF EXISTING TRAVERSE CROSSWALK
- D## INSTALL PAVEMENT MARKING PER CALTRANS STD PLANS A10A - 10AE, PER DETAIL ##

SIGNAGE NOTES:
 SIGNAGE NOTES FOR THIS SHEET ONLY.
 SIGNAGE NOTES DO NOT NECESSARILY APPEAR ON EVERY SHEET.
 SEE SHEET D-03 FOR SIGNING SCHEDULES.

- 1 FURNISH AND INSTALL NEW STOP SIGN PER CITY OF LOS ALTOS STANDARD DETAIL SU-17, AND SHEET D-05
- 2 FURNISH AND INSTALL NEW SINGLE SIDED SIGN PER CITY OF LOS ALTOS STANDARD DETAIL SU-17, AND SHEET D-05
- P PROTECT IN PLACE EXISTING SIGN(S) AND POST

LEGEND:

- PCC SECTION
- DETECTABLE WARNING SURFACE
- D.G. SECTION
- ASPHALT SECTION

SCALE PLAN SCALE FEET

DESIGNED: CV	REVISIONS
REVIEWED: SF	NO DATE ITEM
DRAWN: JP	
2018-248 PROJECT NO.	8/22/19 DATE
1"=20' SCALE	18-248-Layouts FILE

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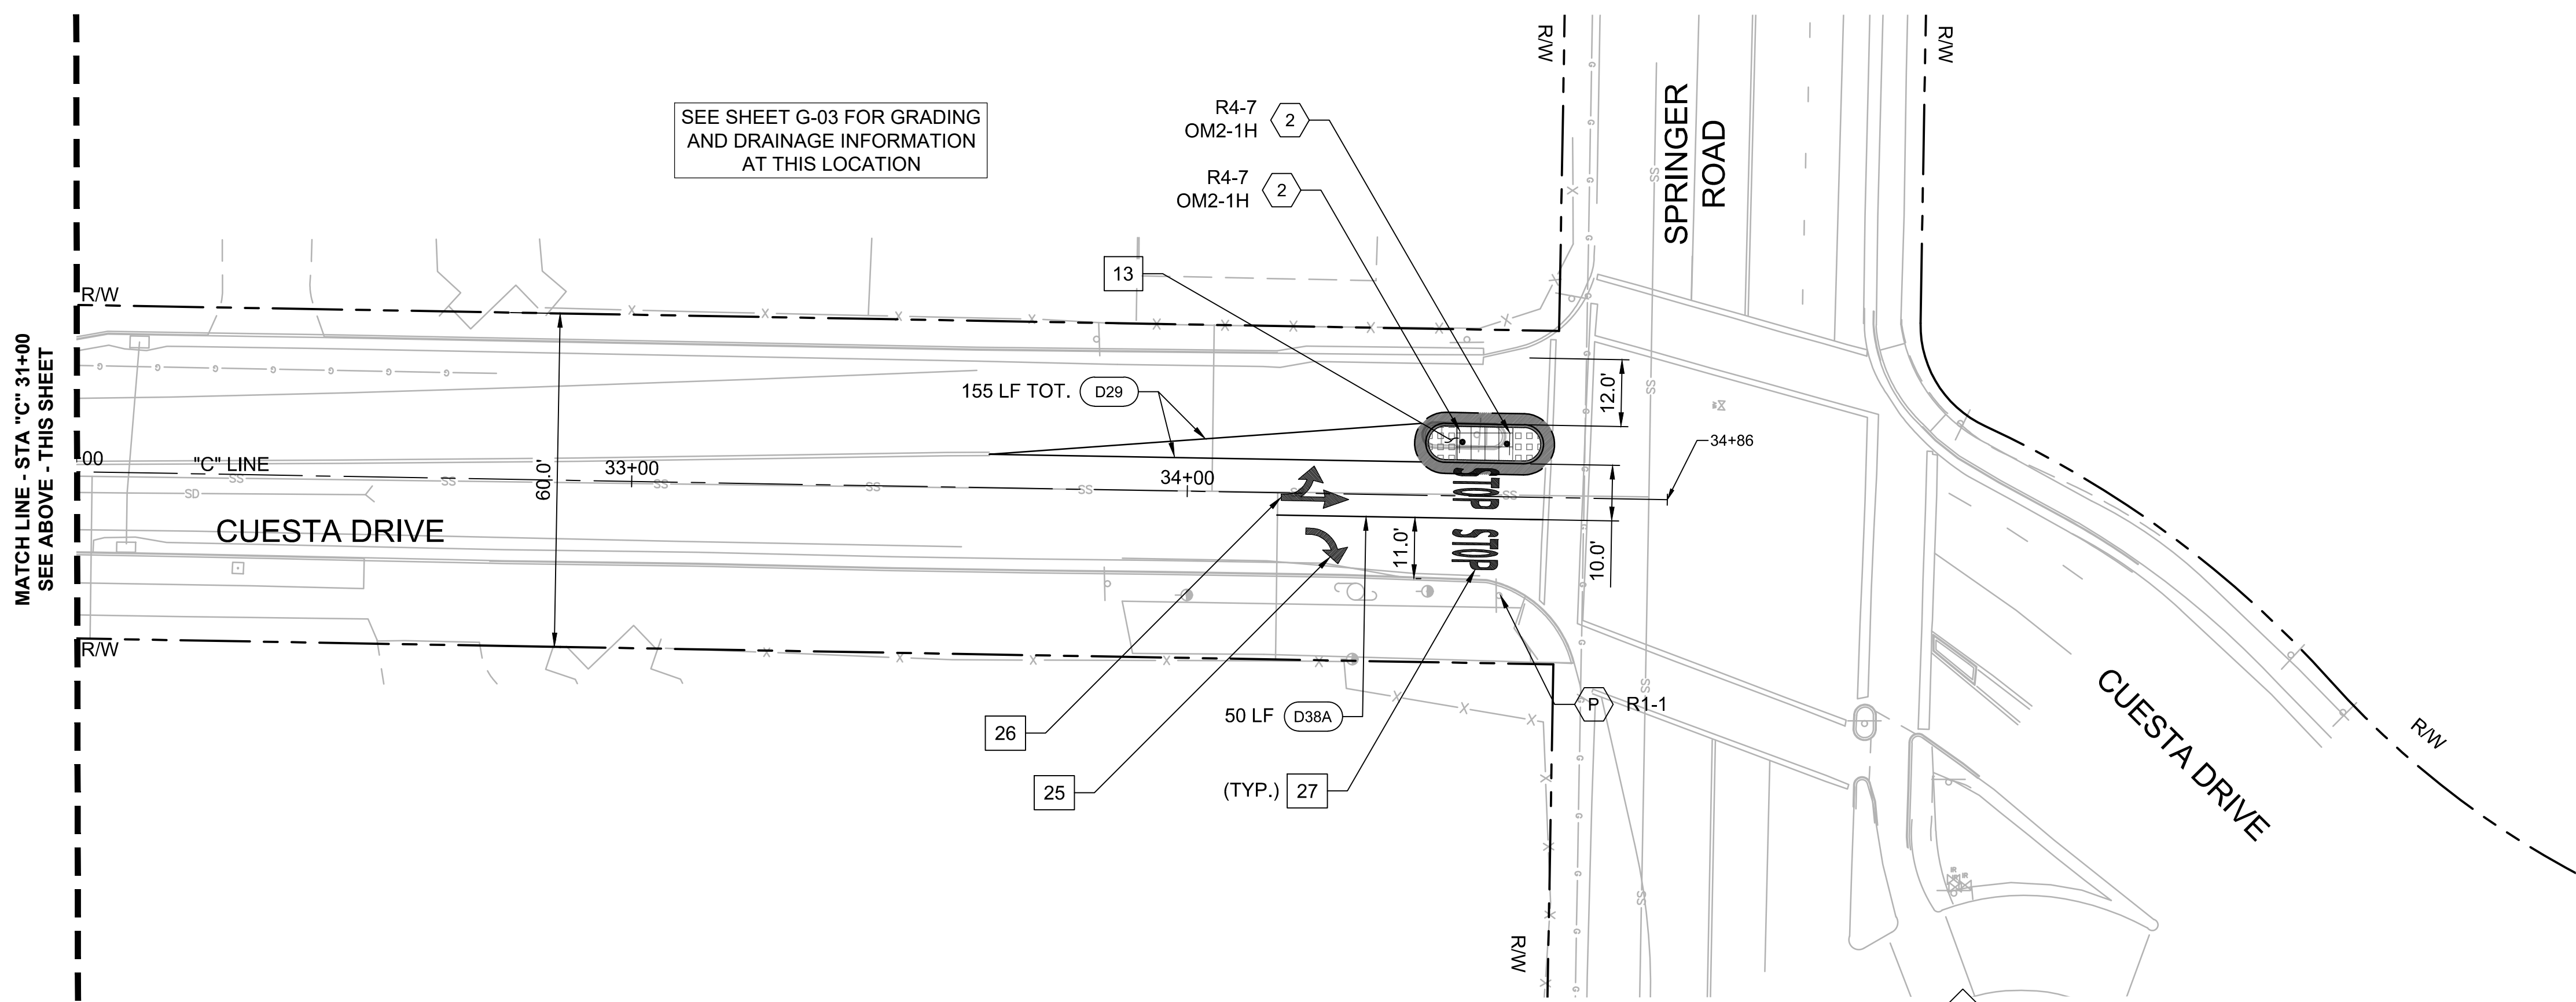
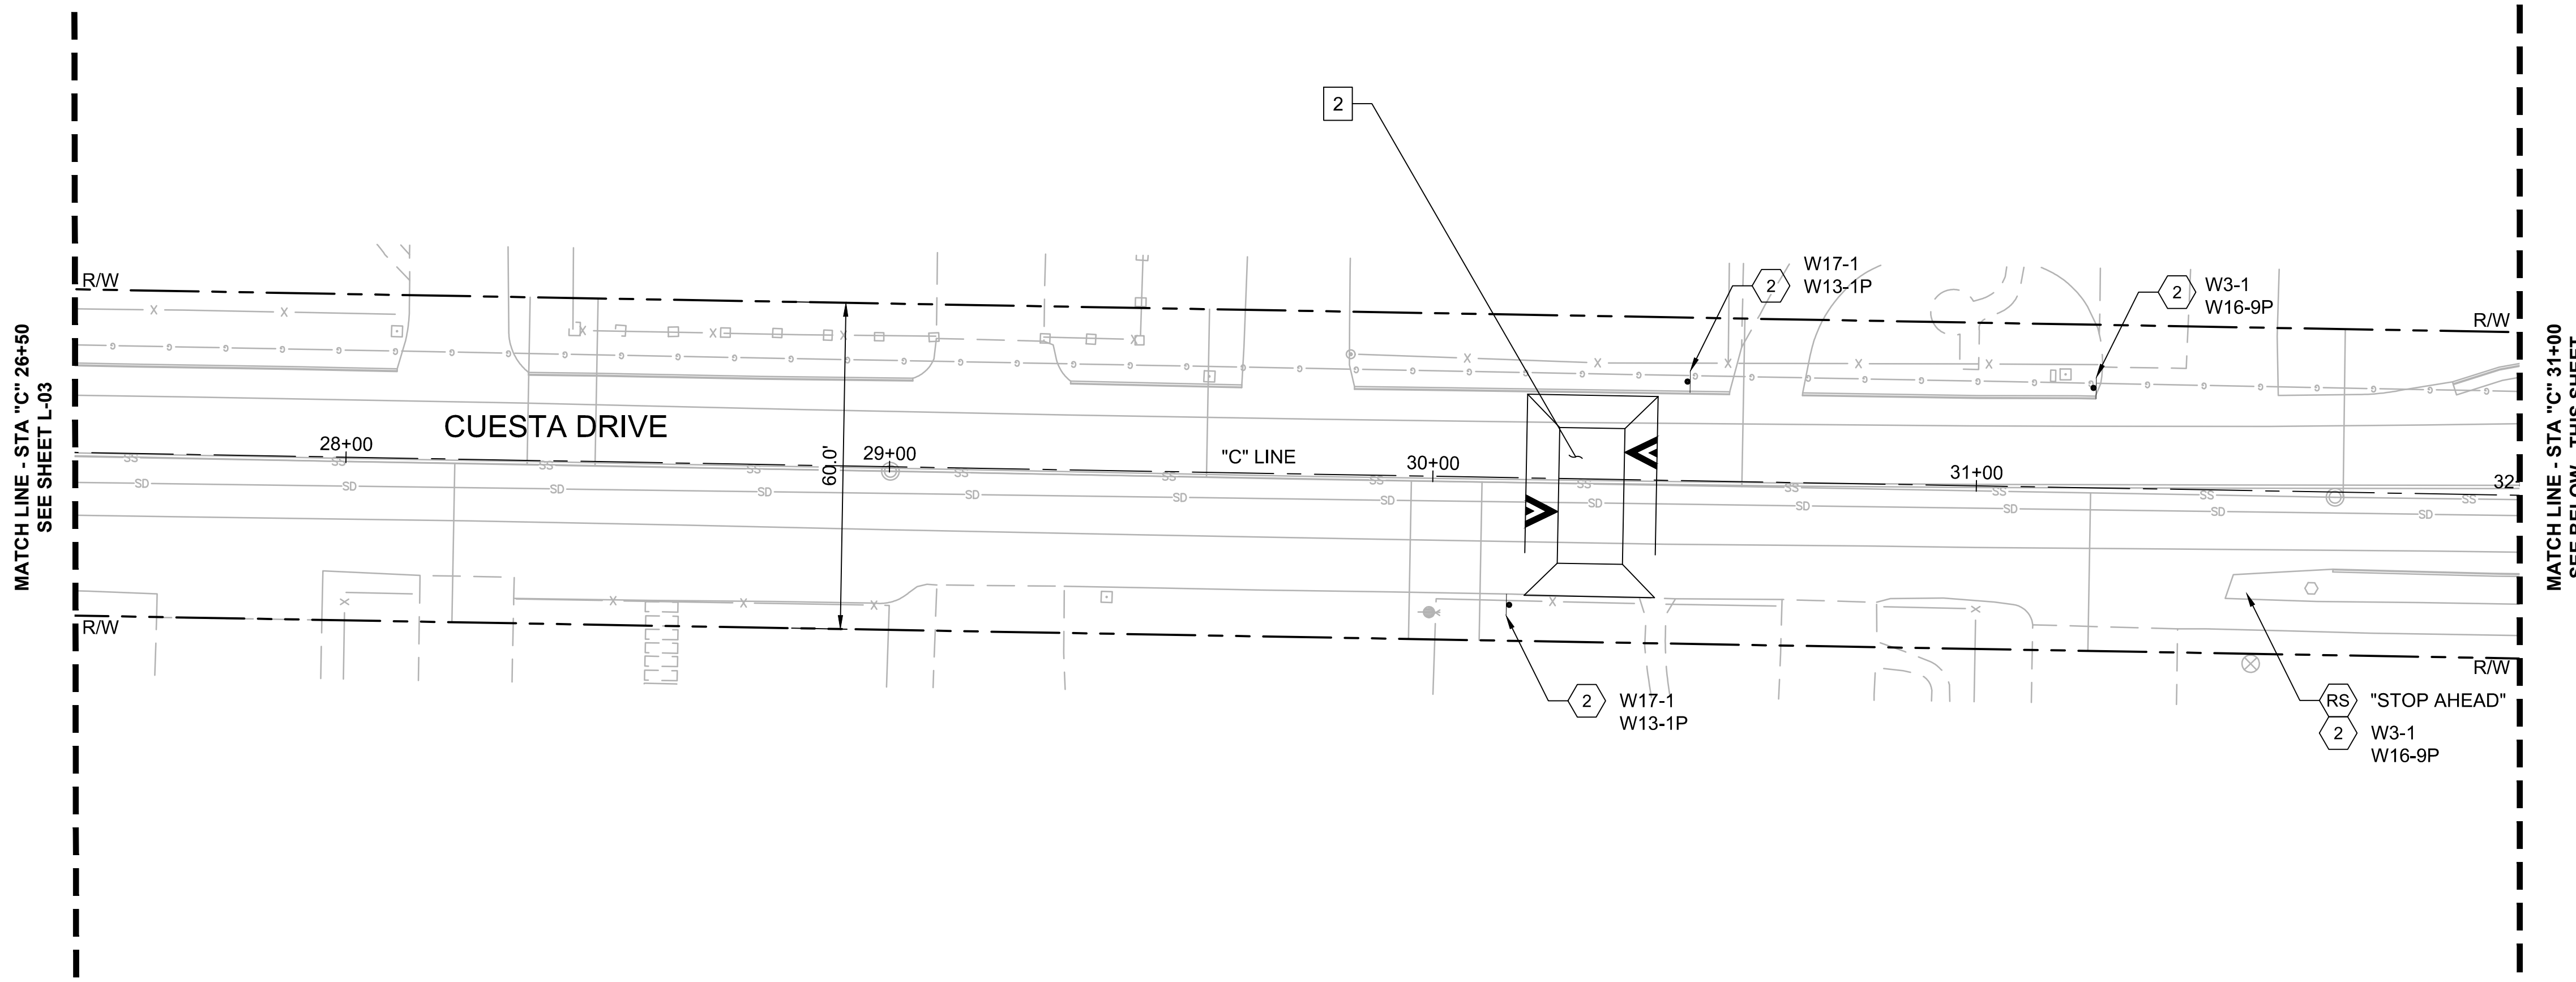
304 12TH ST, SUITE 2A
 OAKLAND, CA 94607
 p:510.540.5008

CITY OF LOS ALTOS - CALIFORNIA

REGISTERED PROFESSIONAL ENGINEER
 STEPHEN B. FRYLSON
 No. 42110
 CIVIL
 STATE OF CALIFORNIA

PRELIMINARY
 NOT FOR CONSTRUCTION

CUESTA DRIVE TRAFFIC CALMING
 Los Altos, California



- NOTES:**
- FOR NOTES, LEGEND AND ABBREVIATIONS SEE SHEET GN-1.
 - FOR DEMOLITION, GRADING & DRAINAGE DRAWING NUMBERS AT THIS LOCATION, SEE SHEET T-1, KEY MAP.
 - FOR ALIGNMENT CURVE AND LINE DATA, SEE SHEET GN-02.

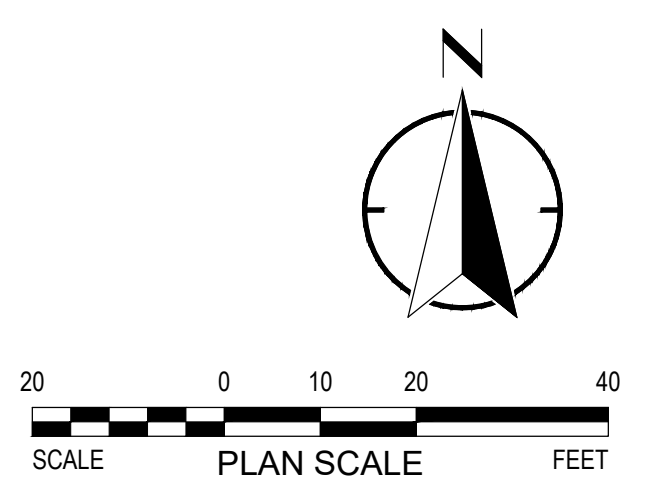
CONSTRUCTION NOTES:
 CONSTRUCTION NOTES FOR THIS SHEET ONLY.
 CONSTRUCTION NOTES DO NOT NECESSARILY APPEAR ON EVERY SHEET.

- 2 CONSTRUCT SPEED TABLE PER DETAIL 2, SHEET D-01
- 13 CONSTRUCT MEDIAN ISLAND PER DETAIL 3, SHEET D-01
- 25 INSTALL TYPE IV (R) ARROW PAVEMENT MARKING PER CALTRANS STD. PLAN A24A
- 26 INSTALL TYPE VII (L) ARROW PAVEMENT MARKING PER CALTRANS STD. PLAN A24A
- 27 INSTALL STOP LANE MARKING PER CALTRANS STD. PLAN A24D
- D## INSTALL PAVEMENT MARKING PER CALTRANS STD PLANS A10A - 10AE, PER DETAIL ##

SIGNAGE NOTES:
 SIGNAGE NOTES FOR THIS SHEET ONLY.
 SIGNAGE NOTES DO NOT NECESSARILY APPEAR ON EVERY SHEET.
 SEE SHEET D-03 FOR SIGNING SCHEDULES.

- 2 FURNISH AND INSTALL NEW SINGLE SIDED SIGN PER CITY OF LOS ALTOS STANDARD DETAIL SU-17, AND SHEET D-05
- P PROTECT IN PLACE EXISTING SIGN(S) AND POST
- RS REMOVE AND SALVAGE EXISTING SIGN AND POST

- LEGEND:**
- ASPHALT SECTION
 - COBBLE STONE MEDIAN PAVING
 - LANDSCAPING AREA



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DRAWN: JP	
2018-248 PROJECT NO.	8/22/19 DATE
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**CUESTA DRIVE
 TRAFFIC CALMING**
 Los Altos, California

SHEET NO.
L-04
 LAYOUT PLANS
16 OF 30

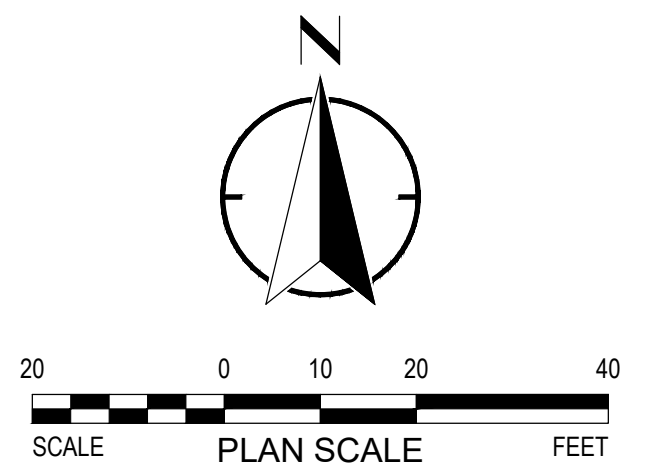
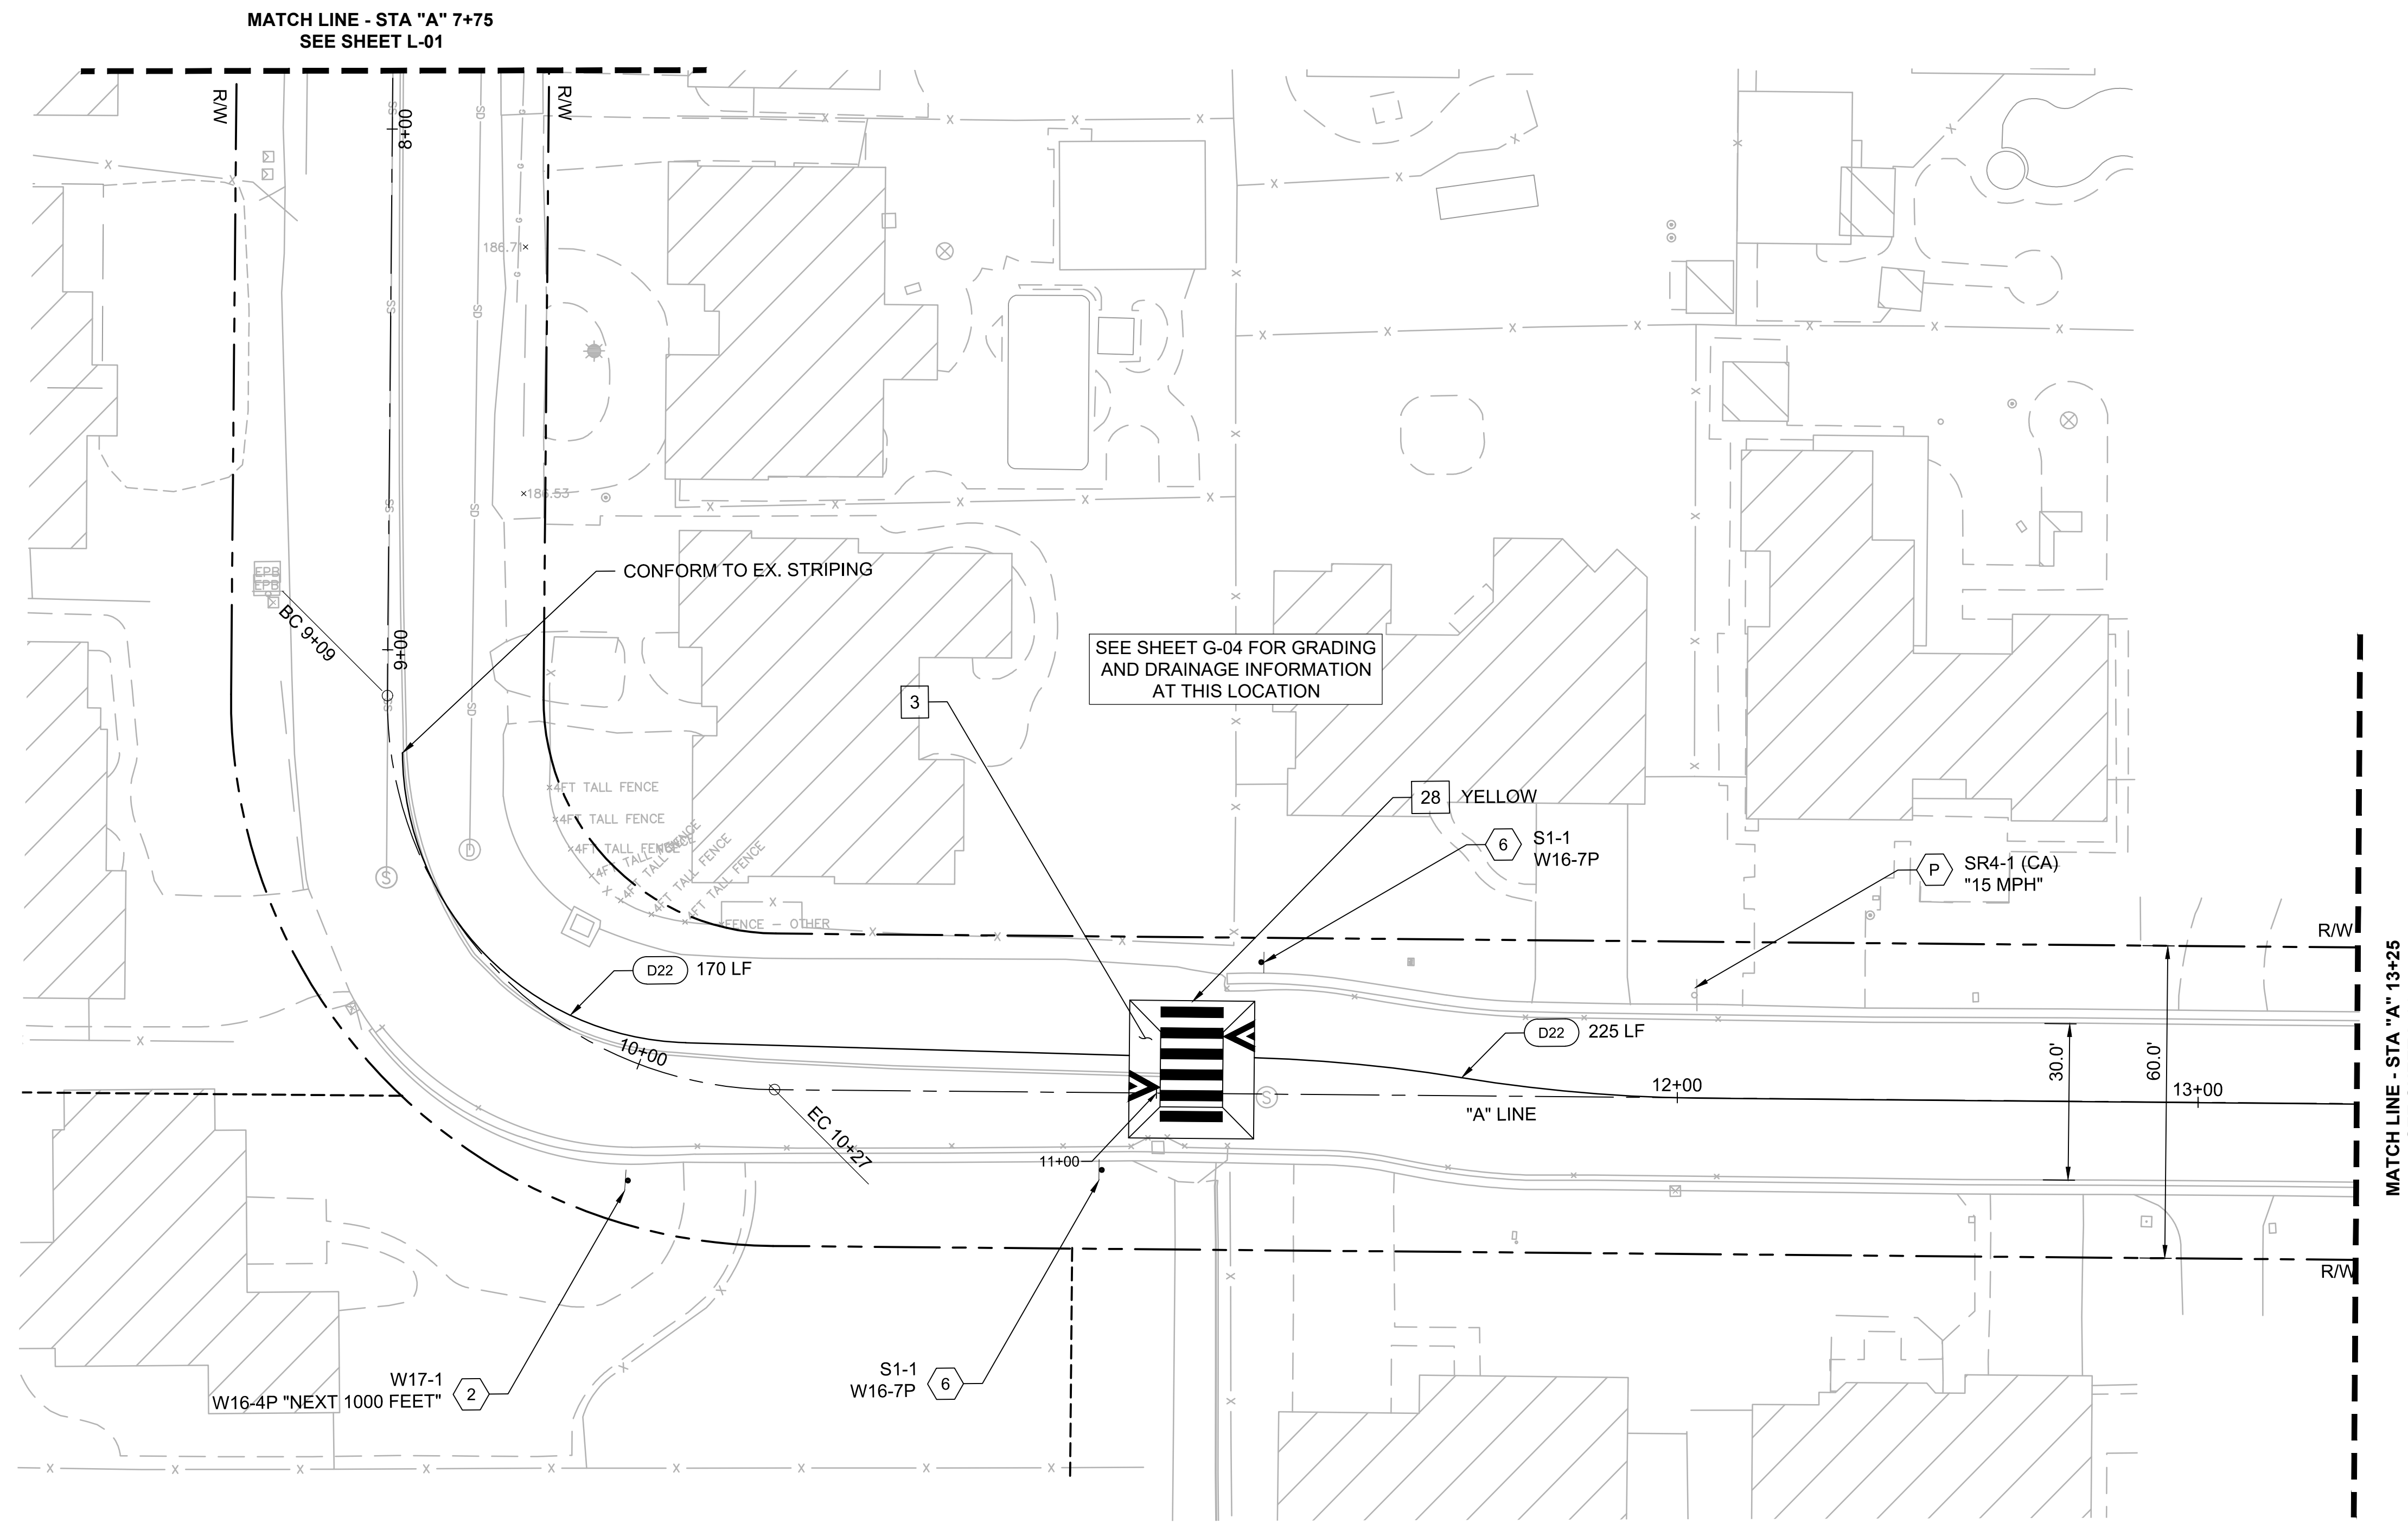
- NOTES:**
- FOR NOTES, LEGEND AND ABBREVIATIONS SEE SHEET GN-1.
 - FOR DEMOLITION, GRADING & DRAINAGE DRAWING NUMBERS AT THIS LOCATION, SEE SHEET T-1, KEY MAP.
 - FOR ALIGNMENT CURVE AND LINE DATA, SEE SHEET GN-02.

CONSTRUCTION NOTES:
 CONSTRUCTION NOTES FOR THIS SHEET ONLY.
 CONSTRUCTION NOTES DO NOT NECESSARILY APPEAR ON EVERY SHEET.

- 1 CONSTRUCT SPEED HUMP PER DETAIL 1, SHEET D-01
- 3 CONSTRUCT SPEED TABLE RAISED CROSSWALK PER DETAIL 3, SHEET D-01
- 28 INSTALL CONTINENTAL STYLE HIGH VISIBILITY CROSSWALK PER DETAIL 1, SHEET D-02
- D## INSTALL PAVEMENT MARKING PER CALTRANS STD PLANS A10A - 10AE, PER DETAIL ##

SIGNAGE NOTES:
 SIGNAGE NOTES FOR THIS SHEET ONLY.
 SIGNAGE NOTES DO NOT NECESSARILY APPEAR ON EVERY SHEET.
 SEE SHEET D-03 FOR SIGNING SCHEDULES.

- 2 FURNISH AND INSTALL NEW SINGLE SIDED SIGN PER CITY OF LOS ALTOS STANDARD DETAIL SU-17, AND SHEET D-05
- 6 FURNISH AND INSTALL NEW DOUBLE SIDED SIGN PER CITY OF LOS ALTOS STANDARD DETAIL SU-17, AND SHEET D-05
- P PROTECT IN PLACE EXISTING SIGN(S) AND POST



DESIGNED: CV	REVISIONS
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DRAWN: JP	
2018-248 8/22/19	
PROJECT NO. DATE	
1"=20' 18-248-Layouts	
SCALE FILE	

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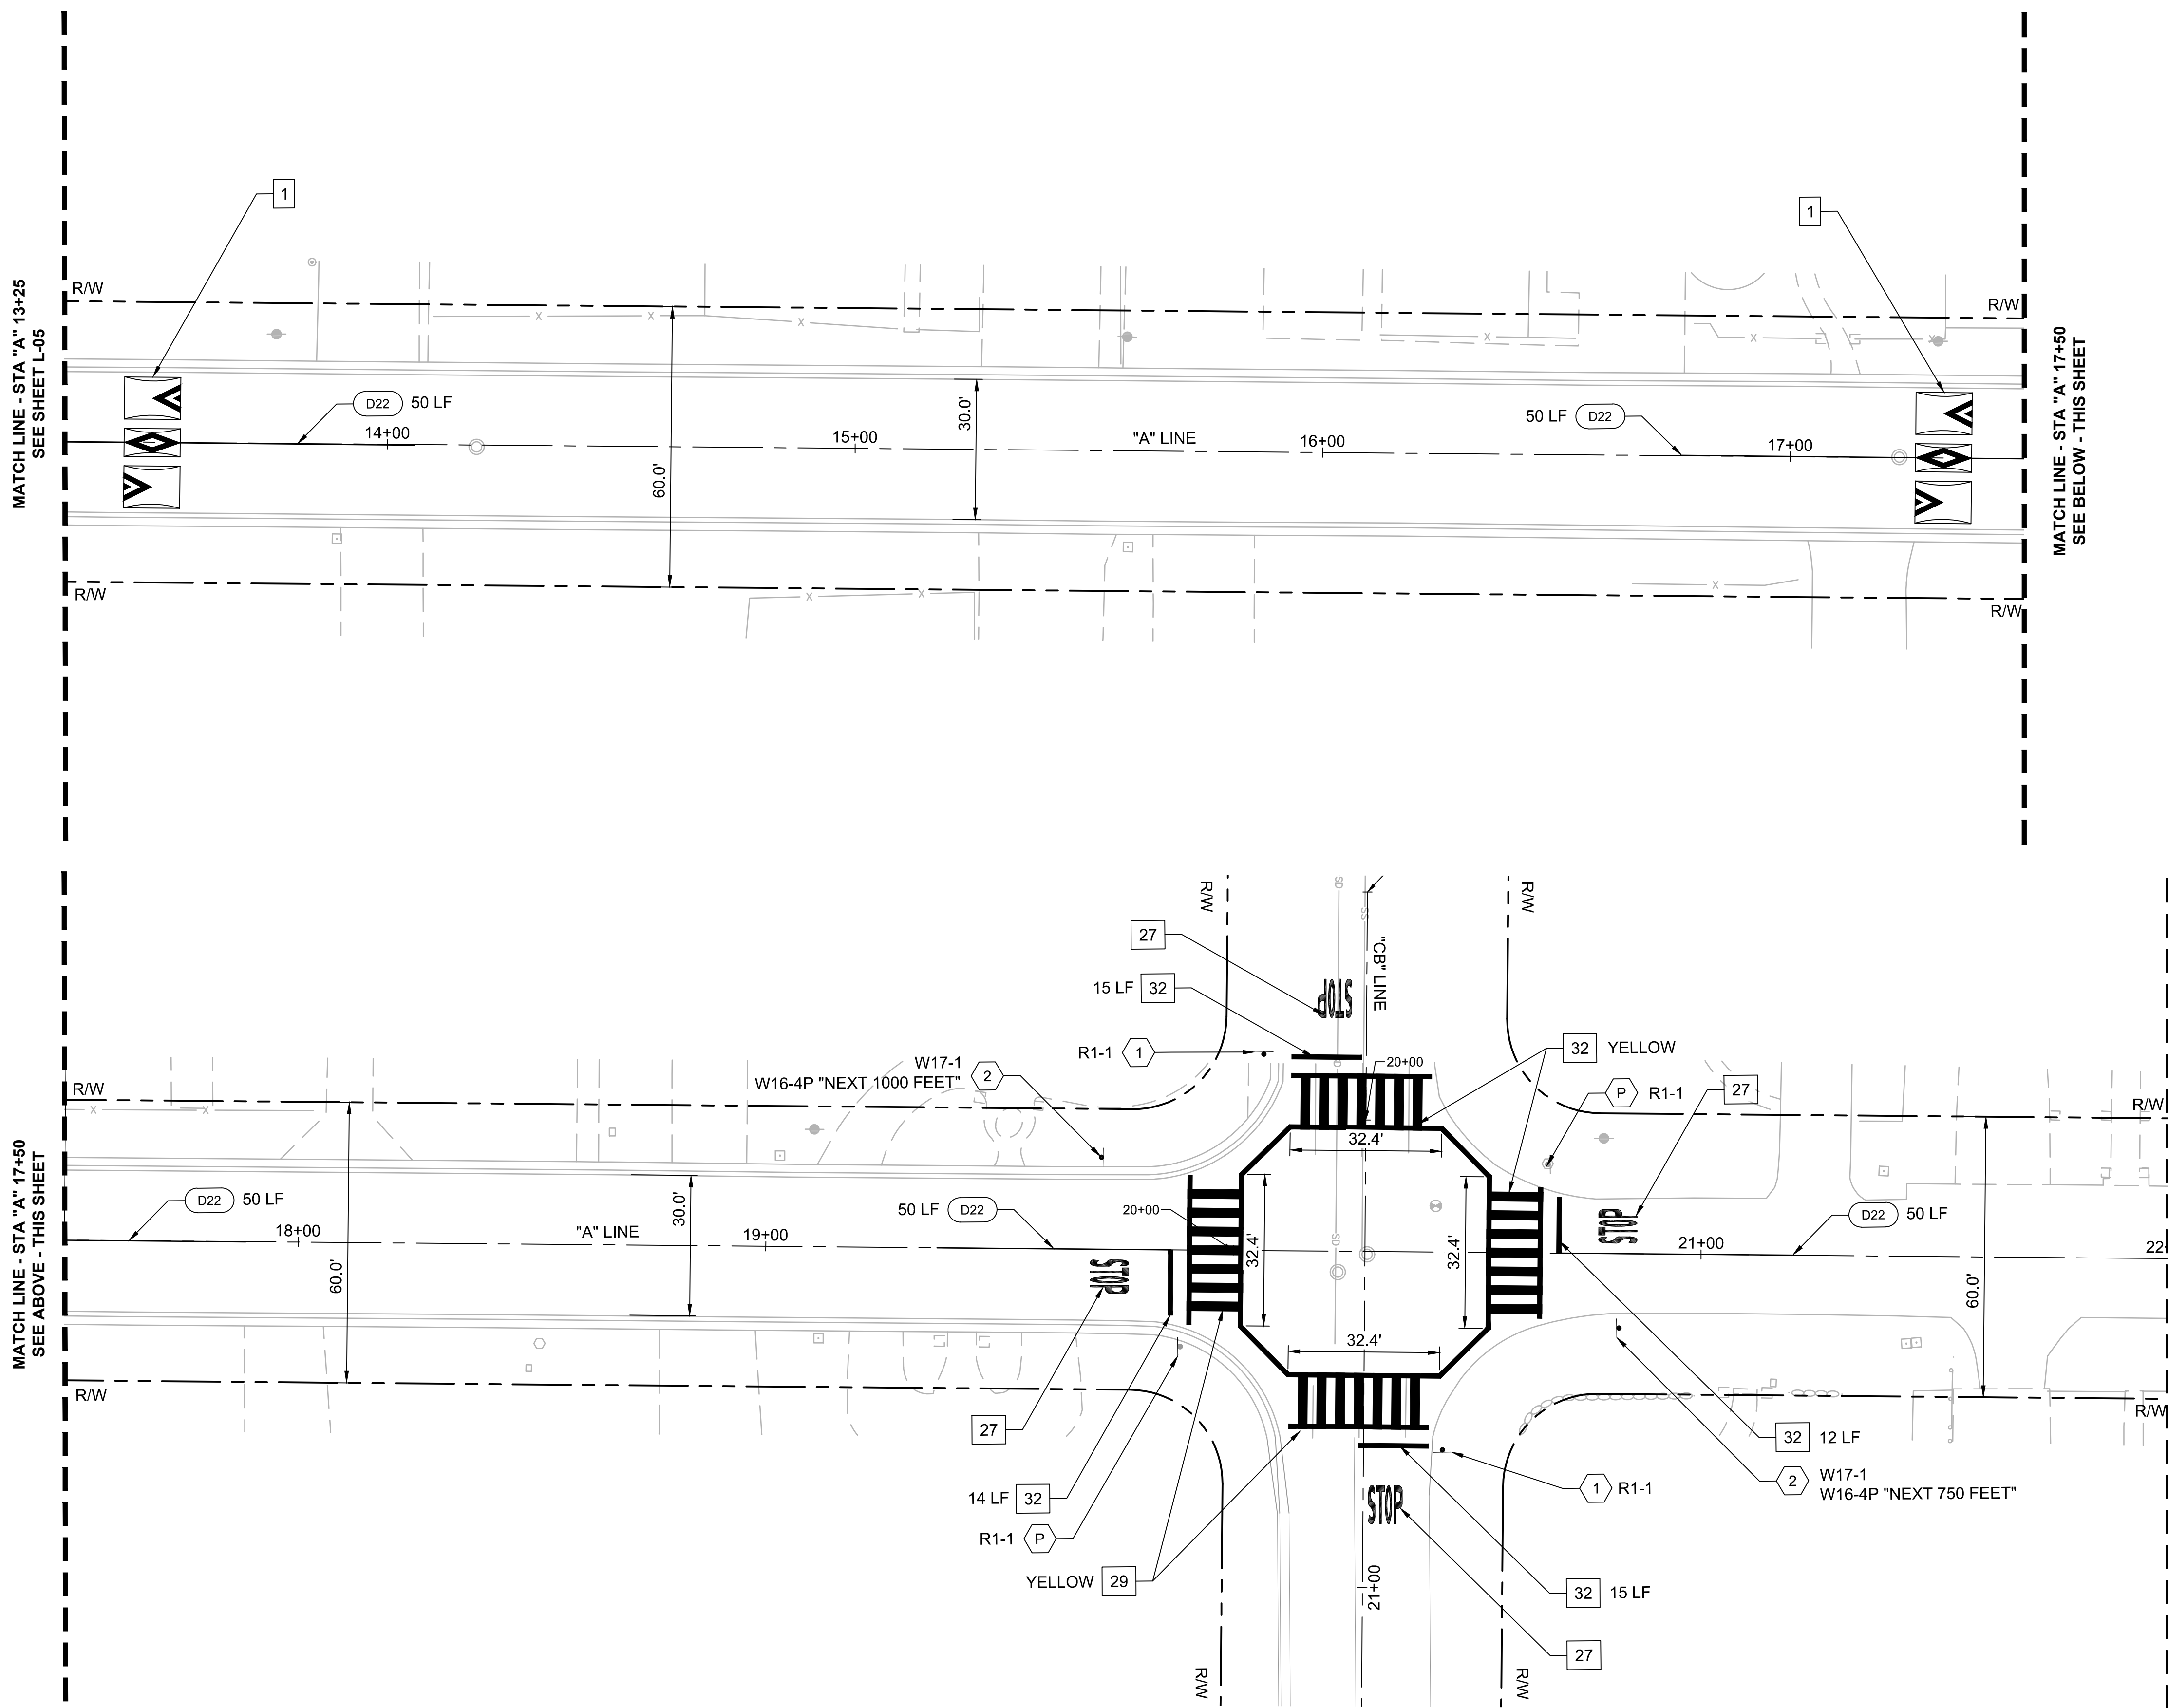
REGISTERED PROFESSIONAL ENGINEER
 STEPHEN B. FRYLSON
 No. 42110
 CIVIL
 STATE OF CALIFORNIA

PRELIMINARY
 NOT FOR CONSTRUCTION

**CUESTA DRIVE
 TRAFFIC CALMING**
 Los Altos, California

LAYOUT PLANS

SHEET NO. **L-05**
 17 OF 30



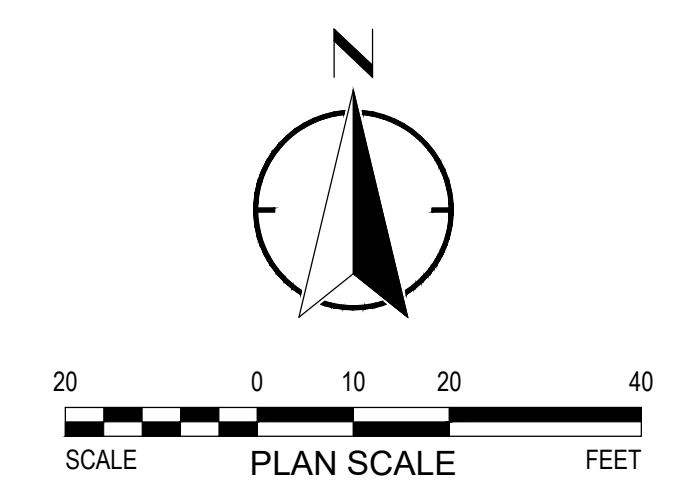
- NOTES:**
- FOR NOTES, LEGEND AND ABBREVIATIONS SEE SHEET GN-1.
 - FOR DEMOLITION, GRADING & DRAINAGE DRAWING NUMBERS AT THIS LOCATION, SEE SHEET T-1, KEY MAP.
 - FOR ALIGNMENT CURVE AND LINE DATA, SEE SHEET GN-02.

CONSTRUCTION NOTES:
 CONSTRUCTION NOTES FOR THIS SHEET ONLY.
 CONSTRUCTION NOTES DO NOT NECESSARILY APPEAR ON EVERY SHEET.

- 1 CONSTRUCT SPEED HUMP PER DETAIL 1, SHEET D-01
- 27 INSTALL STOP LANE MARKING PER CALTRANS STD. PLAN A24D
- 29 INSTALL LADDER STYLE HIGH VISIBILITY CROSSWALK PER DETAIL 1, SHEET D-02
- 32 INSTALL 12" WHITE LIMIT LINE
- D## INSTALL PAVEMENT MARKING PER CALTRANS STD PLANS A10A - 10AE, PER DETAIL ##

SIGNAGE NOTES:
 SIGNAGE NOTES FOR THIS SHEET ONLY.
 SIGNAGE NOTES DO NOT NECESSARILY APPEAR ON EVERY SHEET.
 SEE SHEET D-03 FOR SIGNING SCHEDULES.

- 1 FURNISH AND INSTALL NEW STOP SIGN PER CITY OF LOS ALTOS STANDARD DETAIL SU-17, AND SHEET D-05
- 2 FURNISH AND INSTALL NEW SINGLE SIDED SIGN PER CITY OF LOS ALTOS STANDARD DETAIL SU-17, AND SHEET D-05
- P PROTECT IN PLACE EXISTING SIGN(S) AND POST



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REVIEWED: SF	NO DATE ITEM
DRAWN: JP	
2018-248 8/22/19	
PROJECT NO. DATE	
1"=20' 18-248-Layouts	
SCALE FILE	



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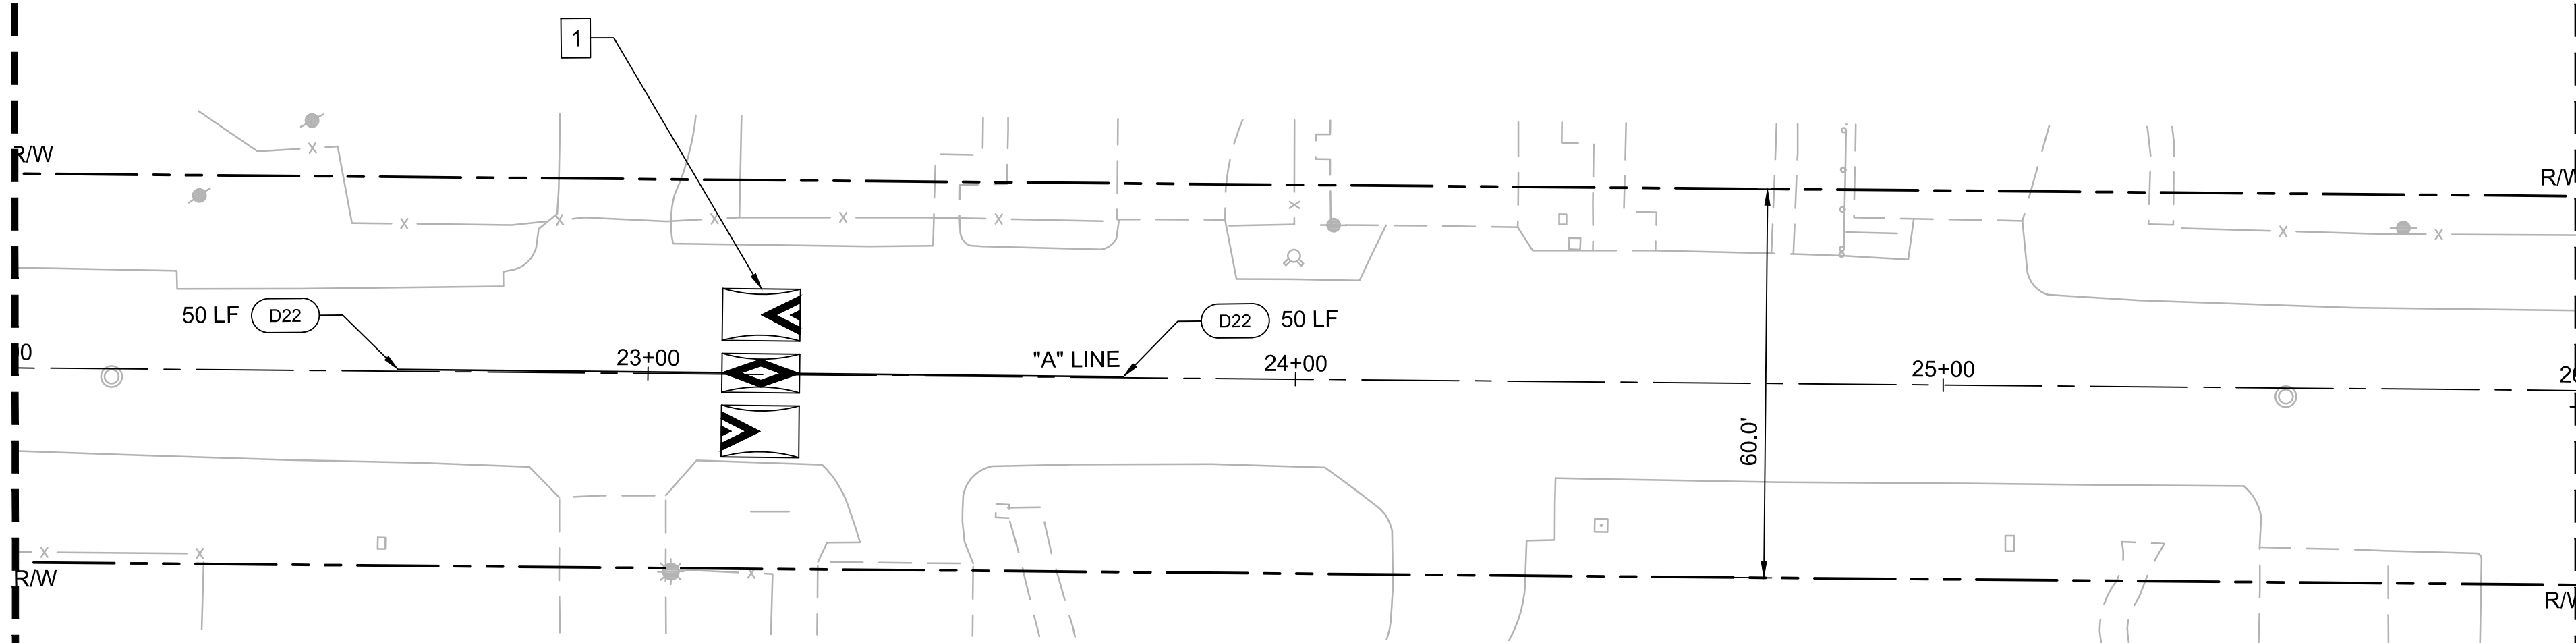
PRELIMINARY
 NOT FOR CONSTRUCTION

**CUESTA DRIVE
 TRAFFIC CALMING**
 Los Altos, California

SHEET NO.
L-06
 LAYOUT PLANS
18 OF 30

MATCH LINE - STA "A" 22+00
SEE SHEET L-06

MATCH LINE - STA "A" 26+00
SEE BELOW - THIS SHEET



- NOTES:**
- FOR NOTES, LEGEND AND ABBREVIATIONS SEE SHEET GN-1.
 - FOR DEMOLITION, GRADING & DRAINAGE DRAWING NUMBERS AT THIS LOCATION, SEE SHEET T-1, KEY MAP.
 - FOR ALIGNMENT CURVE AND LINE DATA, SEE SHEET GN-02.

CONSTRUCTION NOTES:
CONSTRUCTION NOTES FOR THIS SHEET ONLY.
CONSTRUCTION NOTES DO NOT NECESSARILY APPEAR ON EVERY SHEET.

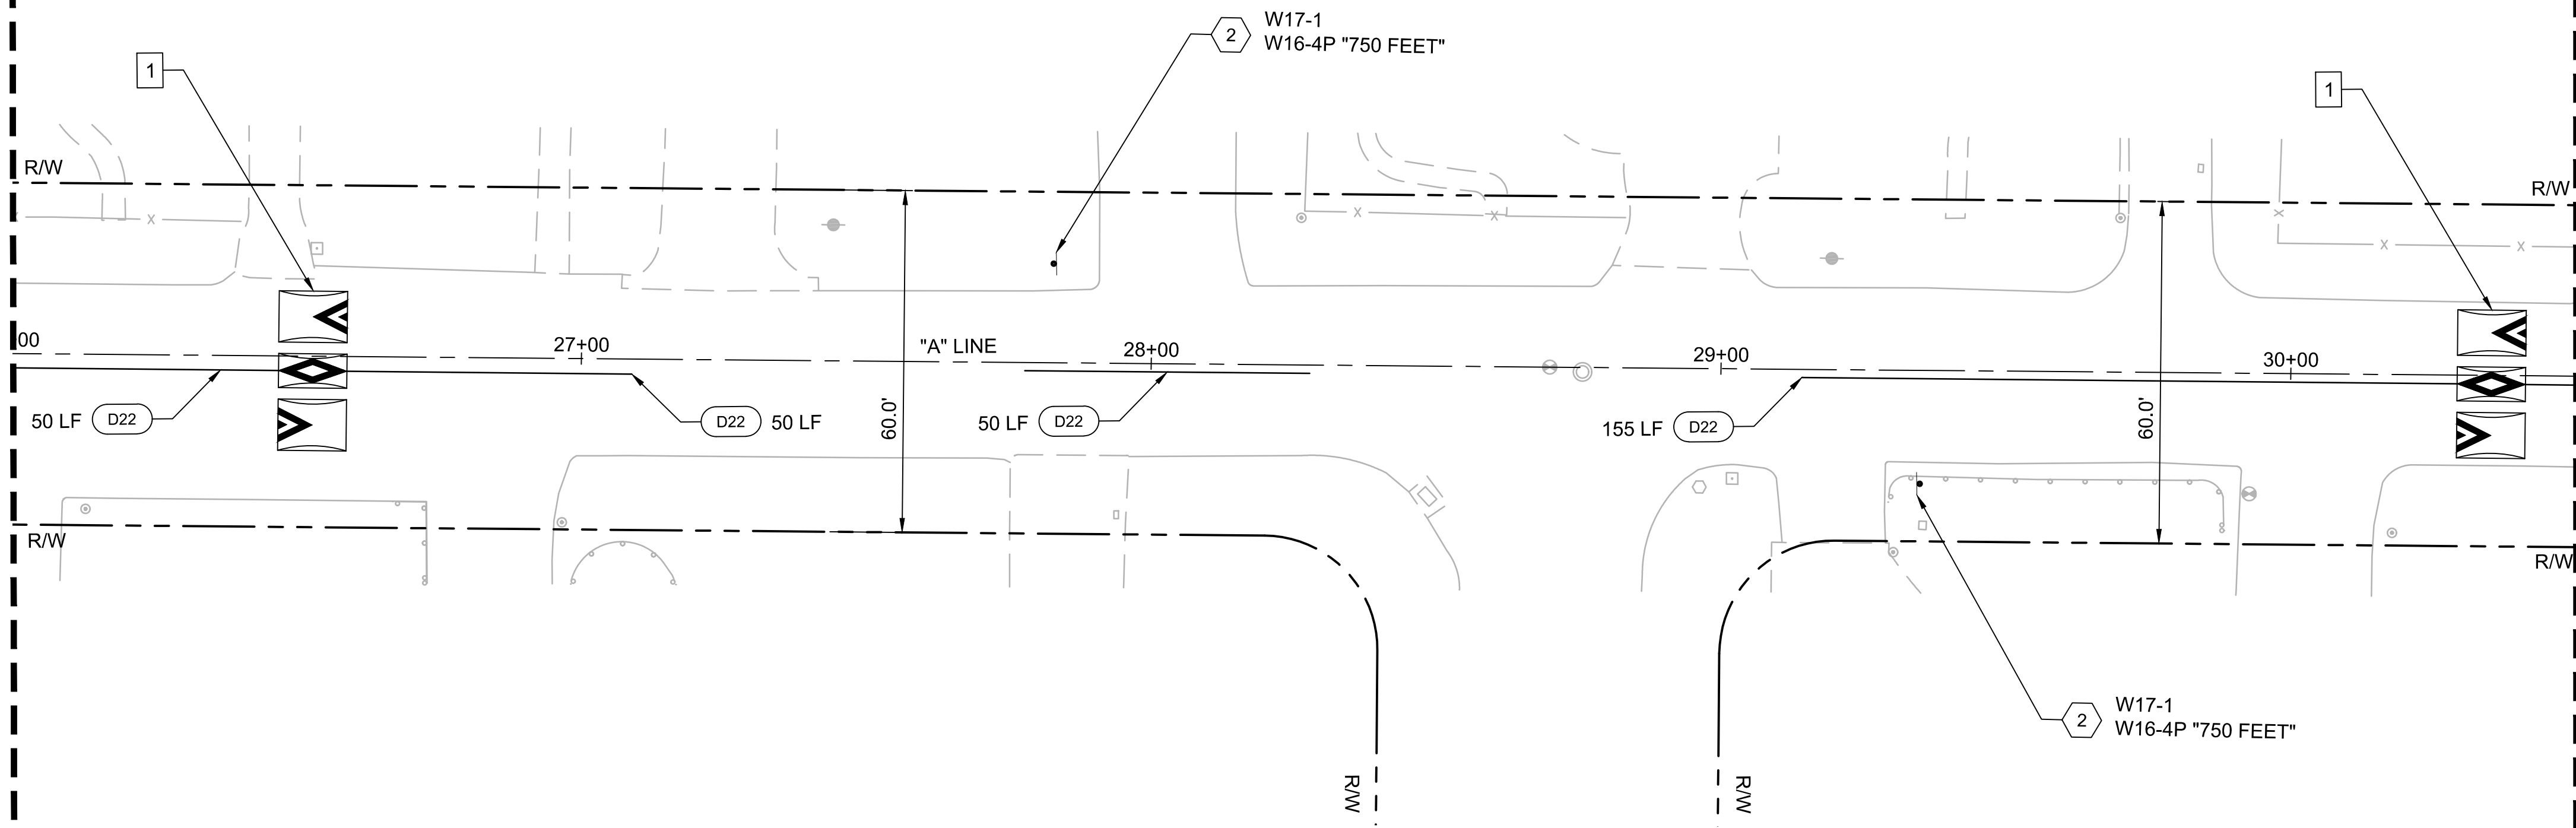
- 1 CONSTRUCT SPEED HUMP PER DETAIL 1, SHEET D-01
- D## INSTALL PAVEMENT MARKING PER CALTRANS STD PLANS A10A - 10AE, PER DETAIL ##

SIGNAGE NOTES:
SIGNAGE NOTES FOR THIS SHEET ONLY.
SIGNAGE NOTES DO NOT NECESSARILY APPEAR ON EVERY SHEET.
SEE SHEET D-03 FOR SIGNING SCHEDULES.

- 2 FURNISH AND INSTALL NEW SINGLE SIDED SIGN PER CITY OF LOS ALTOS STANDARD DETAIL SU-17, AND SHEET D-05

MATCH LINE - STA "A" 26+00
SEE ABOVE - THIS SHEET

MATCH LINE - STA "A" 30+50
SEE SHEET L-08



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REVIEWED: SF	NO DATE ITEM
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2018-248 8/22/19	
PROJECT NO. DATE	
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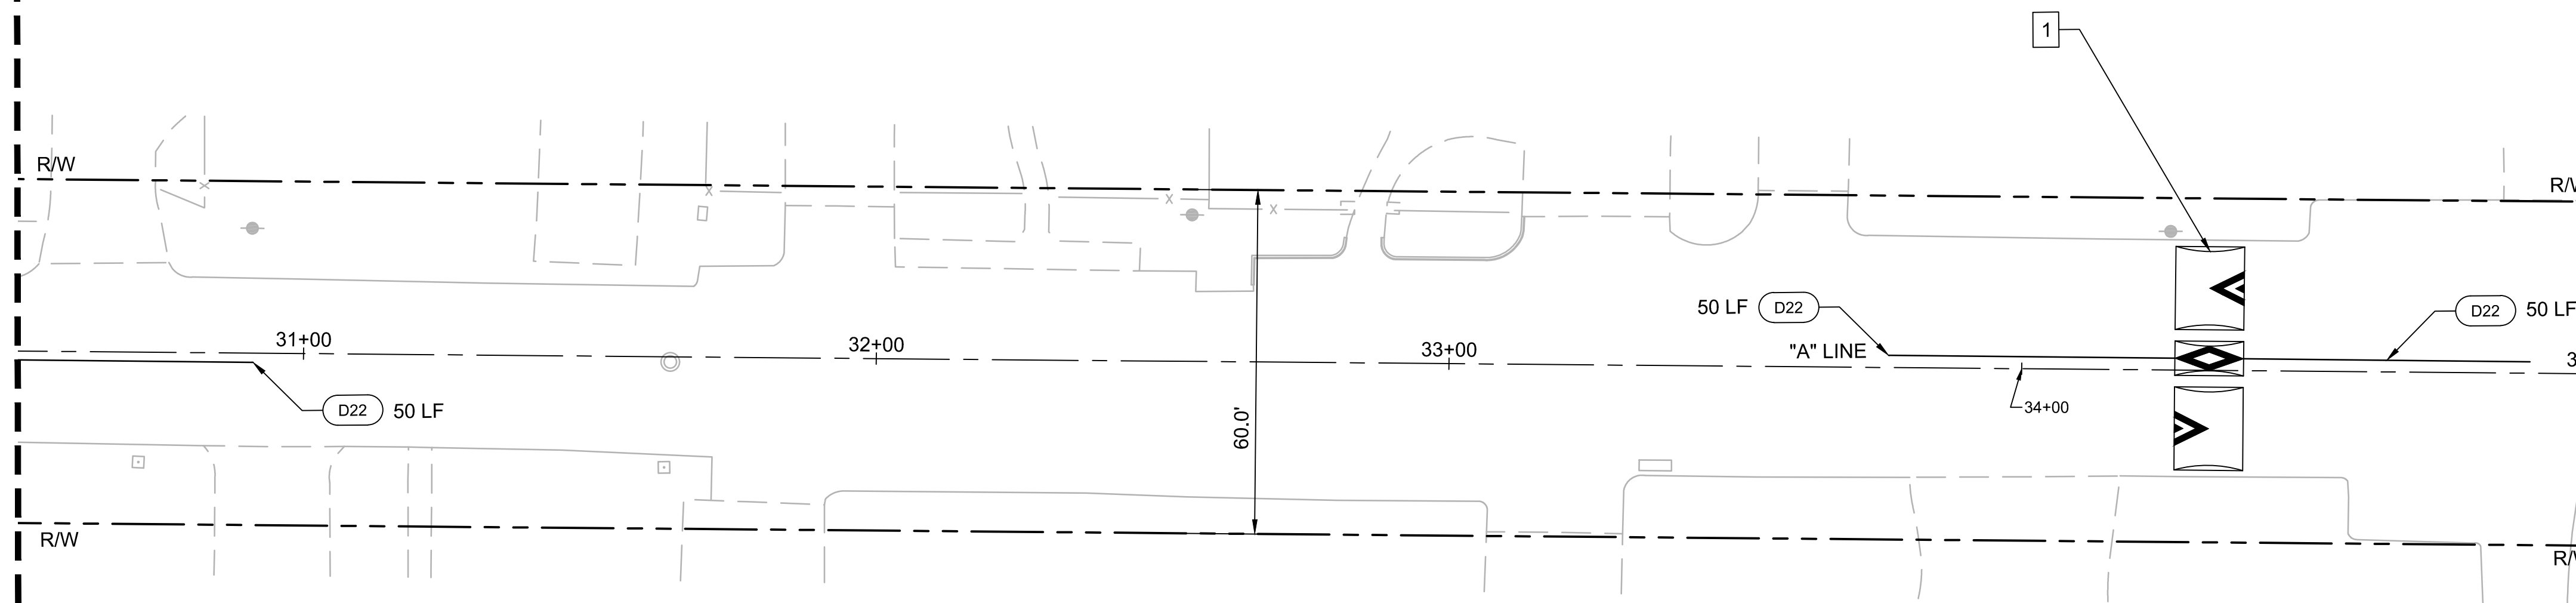


PRELIMINARY
NOT FOR CONSTRUCTION

**CUESTA DRIVE
TRAFFIC CALMING**
Los Altos, California

LAYOUT PLANS	SHEET NO. L-07 19 OF 30
--------------	--------------------------------------

MATCH LINE - STA "A" 30+50
SEE SHEET L-07



MATCH LINE - STA "A" 35+00
SEE BELOW - THIS SHEET

- NOTES:**
- FOR NOTES, LEGEND AND ABBREVIATIONS SEE SHEET GN-1.
 - FOR DEMOLITION, GRADING & DRAINAGE DRAWING NUMBERS AT THIS LOCATION, SEE SHEET T-1, KEY MAP.
 - FOR ALIGNMENT CURVE AND LINE DATA, SEE SHEET GN-02.

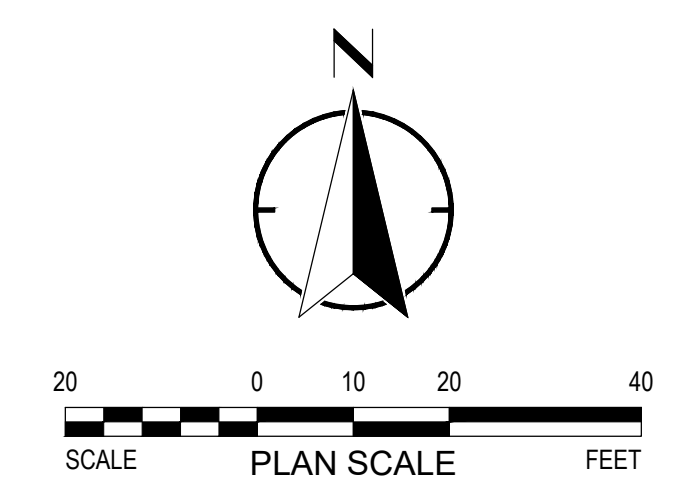
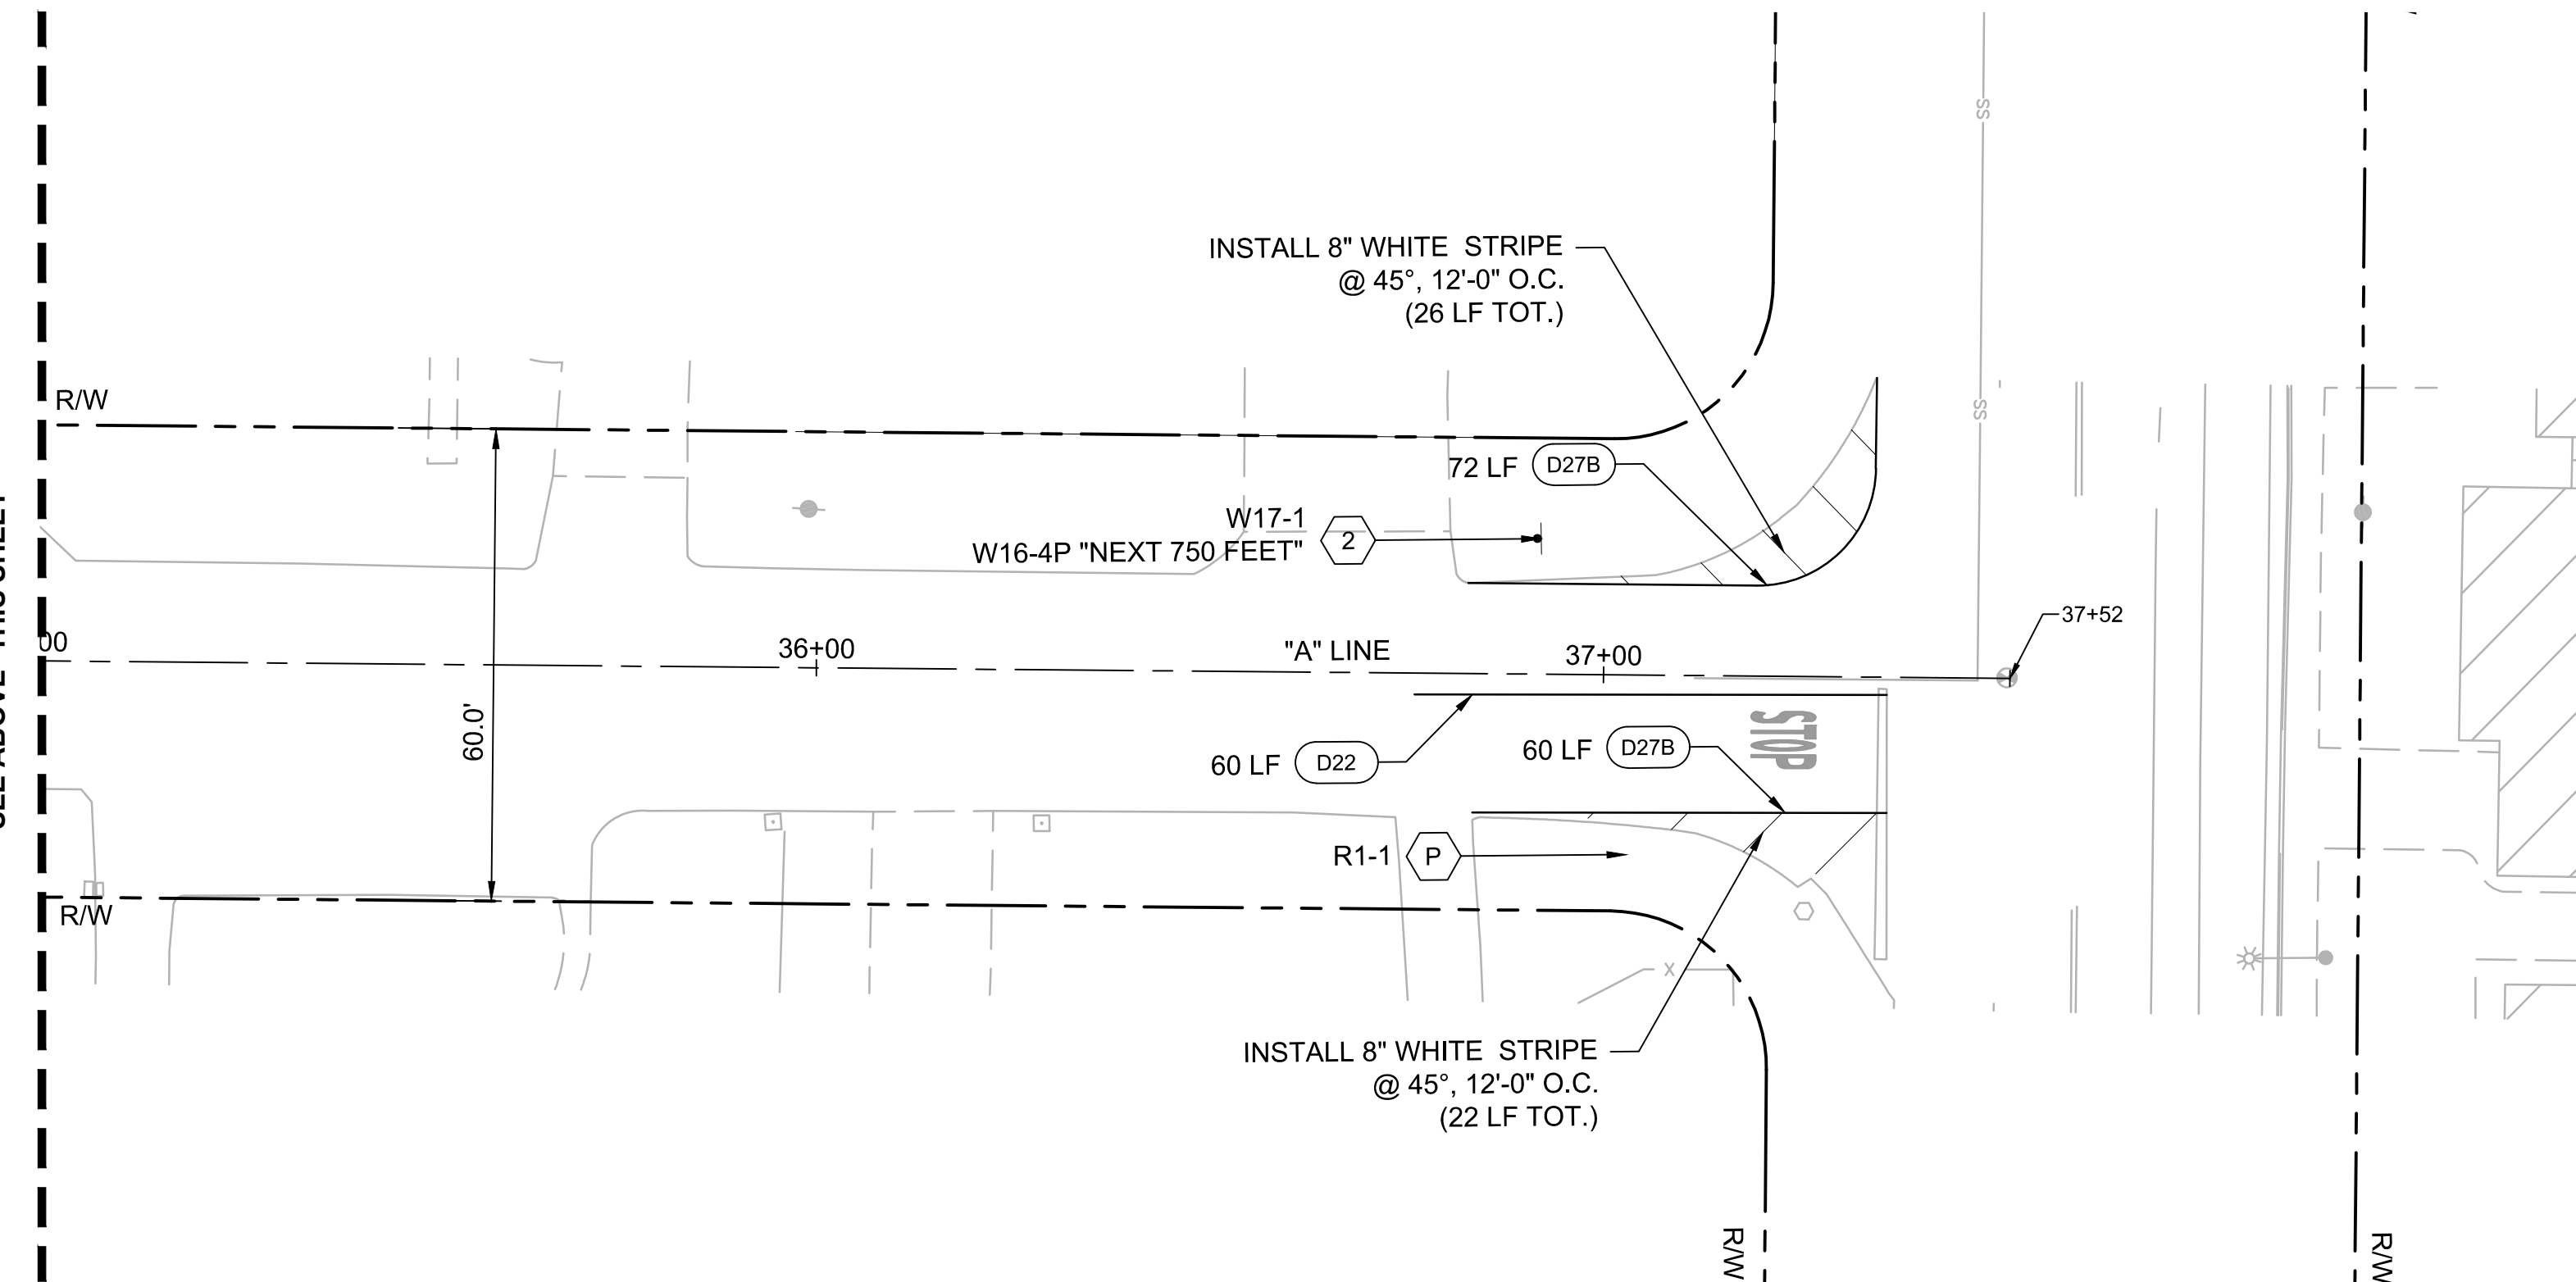
CONSTRUCTION NOTES:
CONSTRUCTION NOTES FOR THIS SHEET ONLY.
CONSTRUCTION NOTES DO NOT NECESSARILY APPEAR ON EVERY SHEET.

- 1 CONSTRUCT SPEED HUMP PER DETAIL 1, SHEET D-01
- D## INSTALL PAVEMENT MARKING PER CALTRANS STD PLANS A10A - 10AE, PER DETAIL ##

SIGNAGE NOTES:
SIGNAGE NOTES FOR THIS SHEET ONLY.
SIGNAGE NOTES DO NOT NECESSARILY APPEAR ON EVERY SHEET.
SEE SHEET D-03 FOR SIGNING SCHEDULES.

- 2 FURNISH AND INSTALL NEW SINGLE SIDED SIGN PER CITY OF LOS ALTOS STANDARD DETAIL SU-17, AND SHEET D-05
- P PROTECT IN PLACE EXISTING SIGN(S) AND POST

MATCH LINE - STA "A" 35+00
SEE ABOVE - THIS SHEET



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DRAWN: JP	
2018-248 PROJECT NO.	8/22/19 DATE
1"=20' SCALE	18-248-Layouts FILE



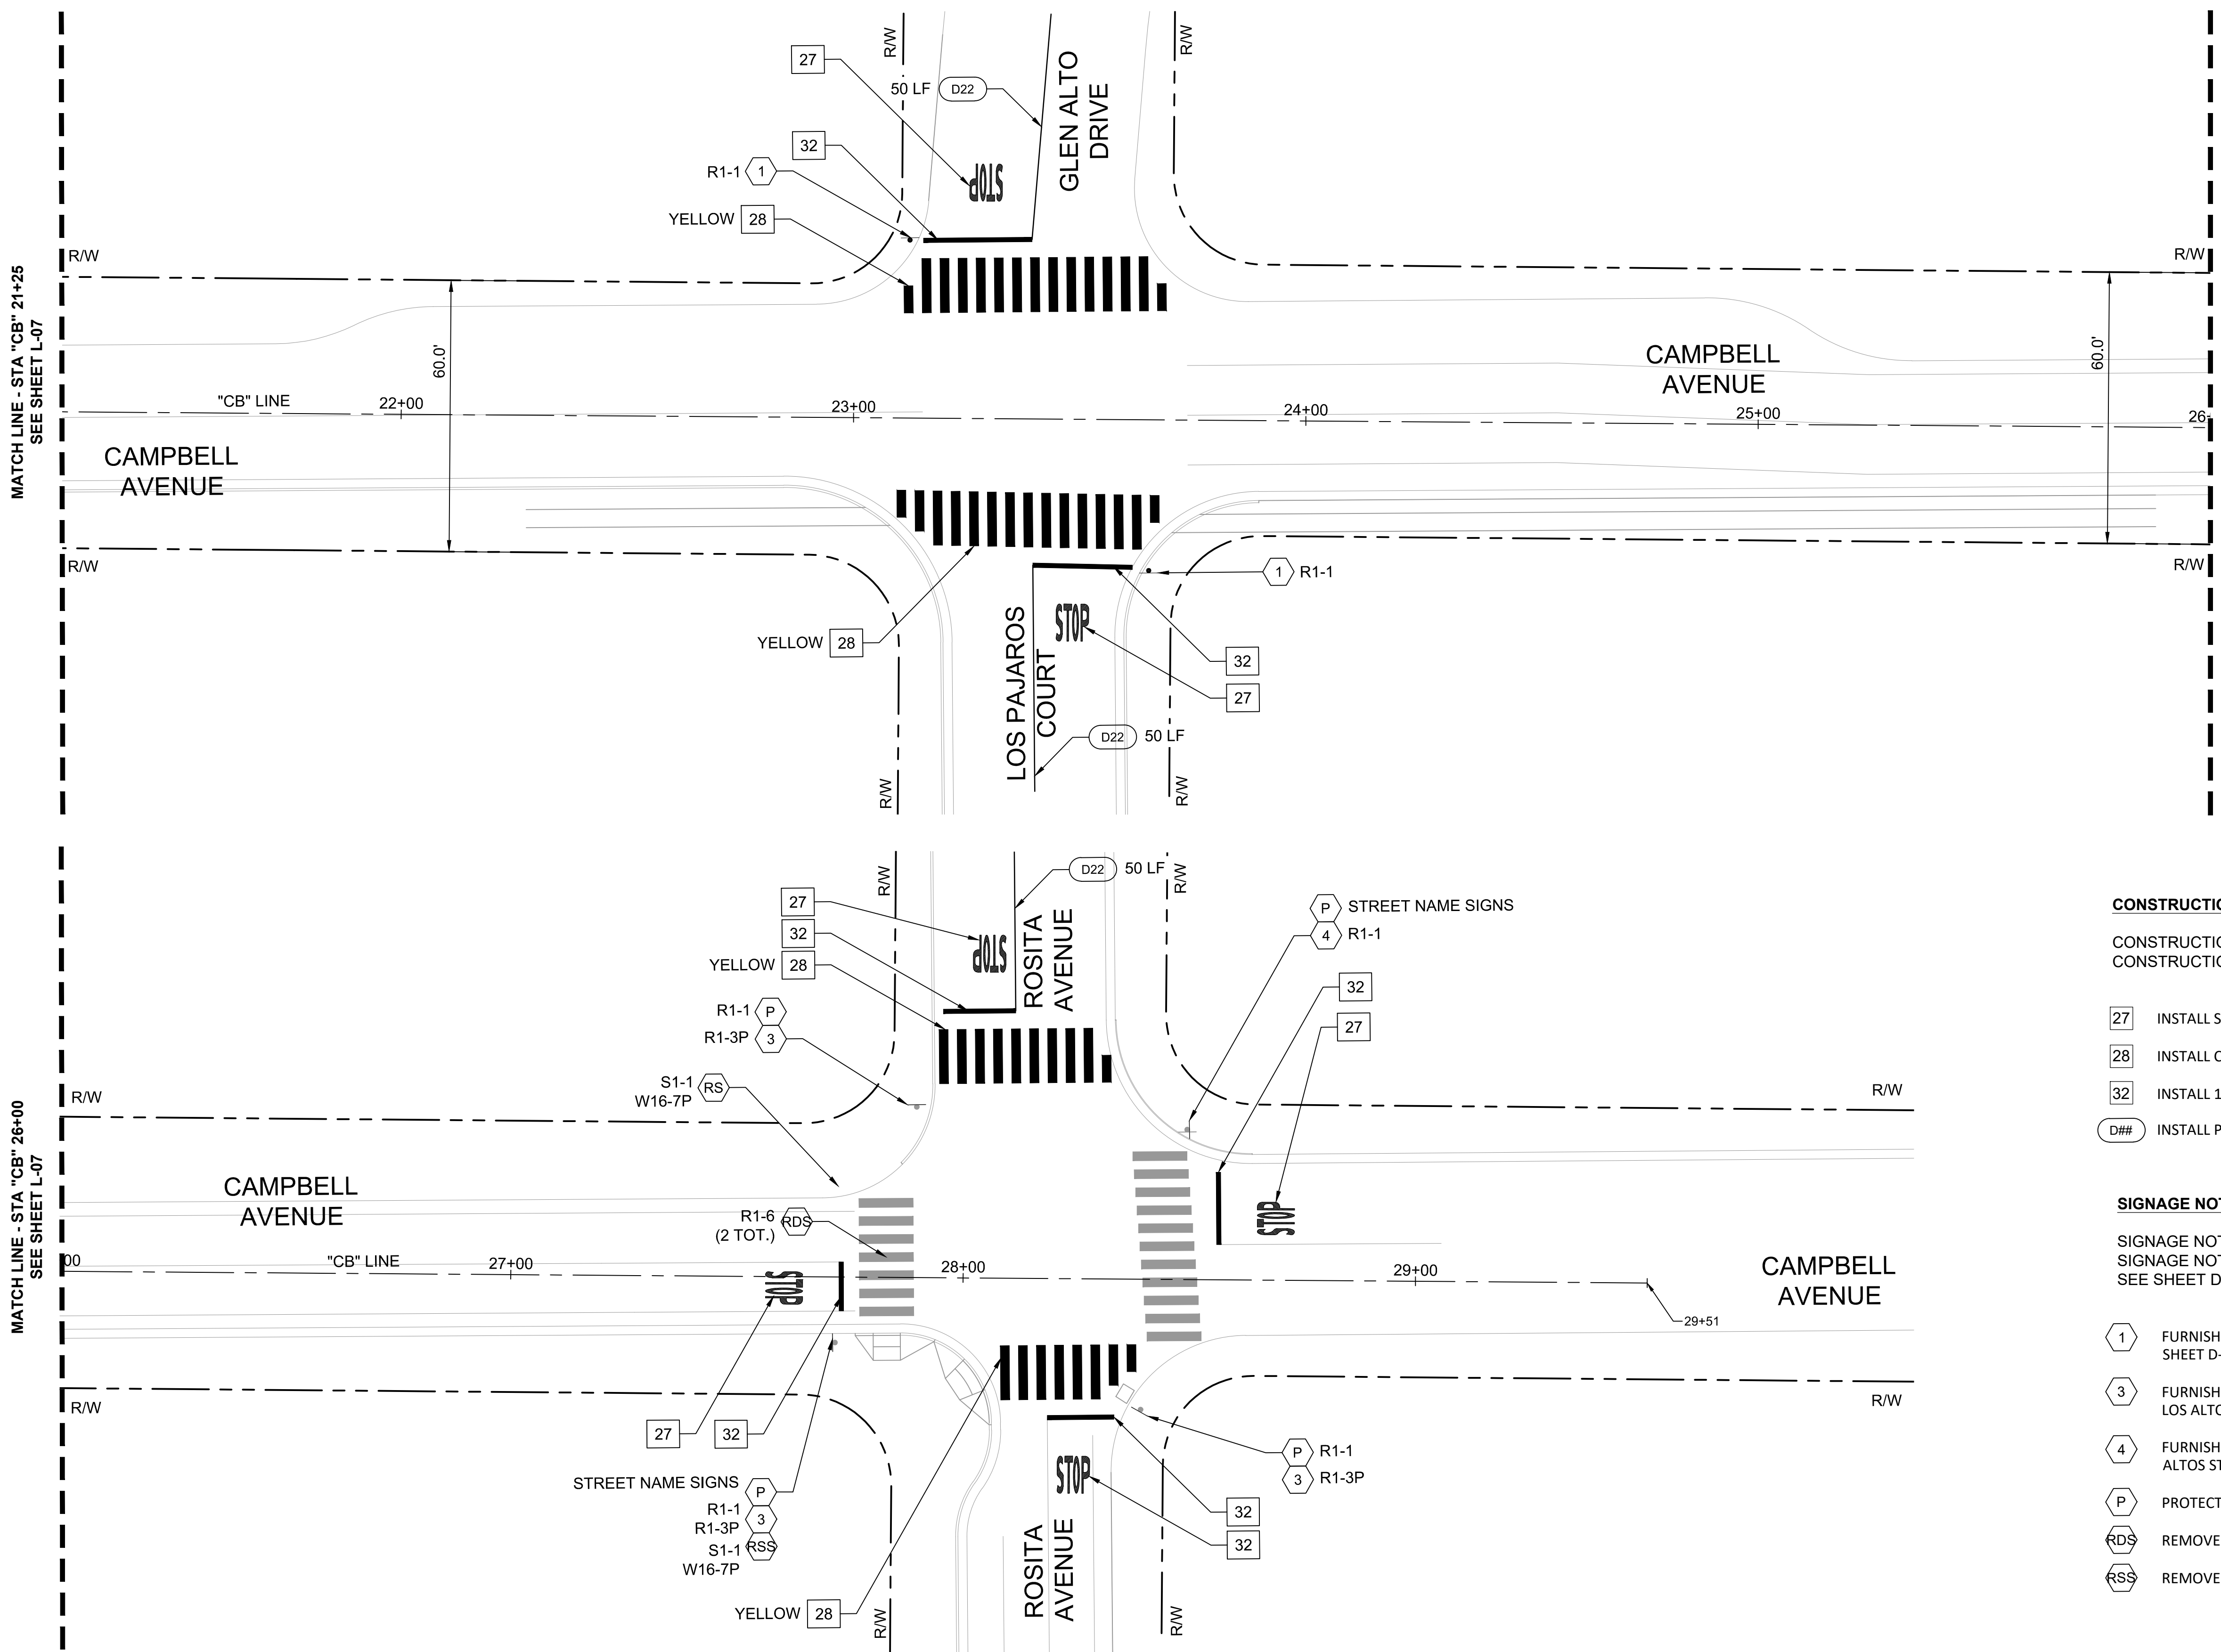
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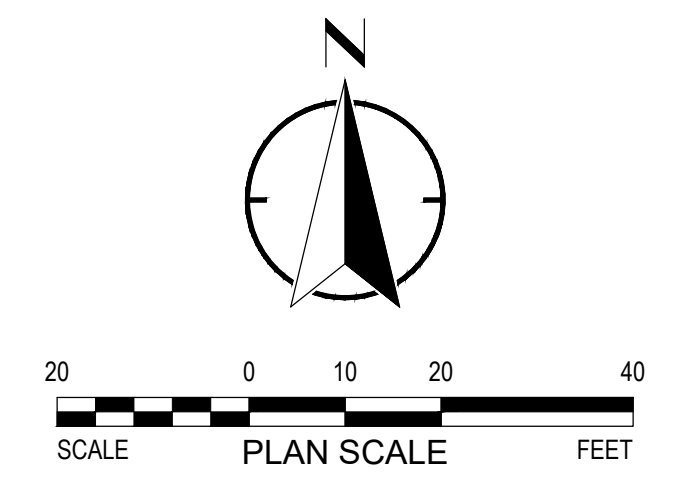
PRELIMINARY
NOT FOR CONSTRUCTION

**CUESTA DRIVE
TRAFFIC CALMING**
Los Altos, California

LAYOUT PLANS
SHEET NO. **L-08**
20 OF 30



- NOTES:**
- FOR NOTES, LEGEND AND ABBREVIATIONS SEE SHEET GN-1.
 - FOR DEMOLITION, GRADING & DRAINAGE DRAWING NUMBERS AT THIS LOCATION, SEE SHEET T-1, KEY MAP.
 - FOR ALIGNMENT CURVE AND LINE DATA, SEE SHEET GN-02.



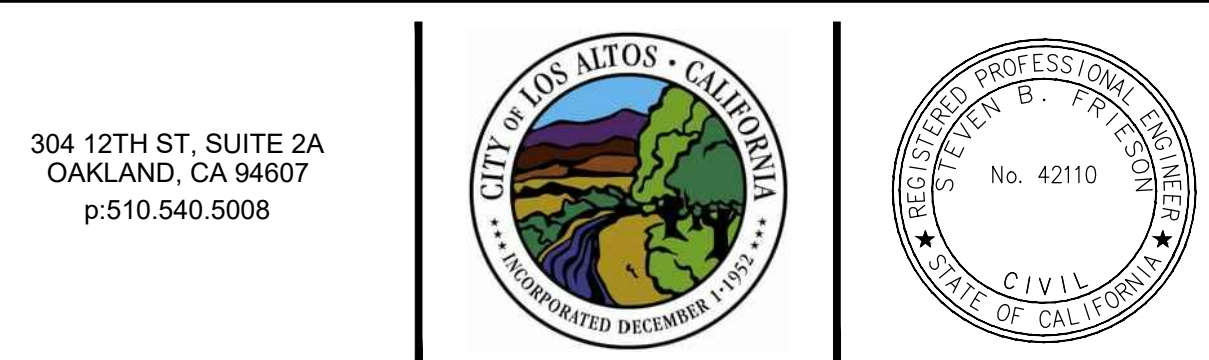
CONSTRUCTION NOTES:
 CONSTRUCTION NOTES FOR THIS SHEET ONLY.
 CONSTRUCTION NOTES DO NOT NECESSARILY APPEAR ON EVERY SHEET.

- 27 INSTALL STOP LANE MARKING PER CALTRANS STD. PLAN A24D
- 28 INSTALL CONTINENTAL STYLE HIGH VISIBILITY CROSSWALK PER DETAIL 1, SHEET D-02
- 32 INSTALL 12" WHITE LIMIT LINE
- D## INSTALL PAVEMENT MARKING PER CALTRANS STD PLANS A10A - A10E, PER DETAIL ##

SIGNAGE NOTES:
 SIGNAGE NOTES FOR THIS SHEET ONLY.
 SIGNAGE NOTES DO NOT NECESSARILY APPEAR ON EVERY SHEET.
 SEE SHEET D-03 FOR SIGNING SCHEDULES.

- 1 FURNISH AND INSTALL NEW STOP SIGN PER CITY OF LOS ALTOS STANDARD DETAIL SU-17, AND SHEET D-05
- 3 FURNISH AND INSTALL NEW STOP SIGN OR STOP PLAQUE ON EXISTING SIGN POST PER CITY OF LOS ALTOS STANDARD DETAIL SU-17, AND SHEET D-05
- 4 FURNISH AND INSTALL NEW STOP SIGN ON EXISTING STREET SIGN POST PER CITY OF LOS ALTOS STANDARD DETAIL SU-16, AND SHEET D-05
- P PROTECT IN PLACE EXISTING SIGN(S) AND POST
- RDS REMOVE AND DISPOSE OF SIGN AND POST
- RSS REMOVE AND SALVAGE EXISTING SIGN, PROTECT IN PLACE EXISTING POST

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DRAWN: JP	
2018-248 PROJECT NO.	8/22/19 DATE
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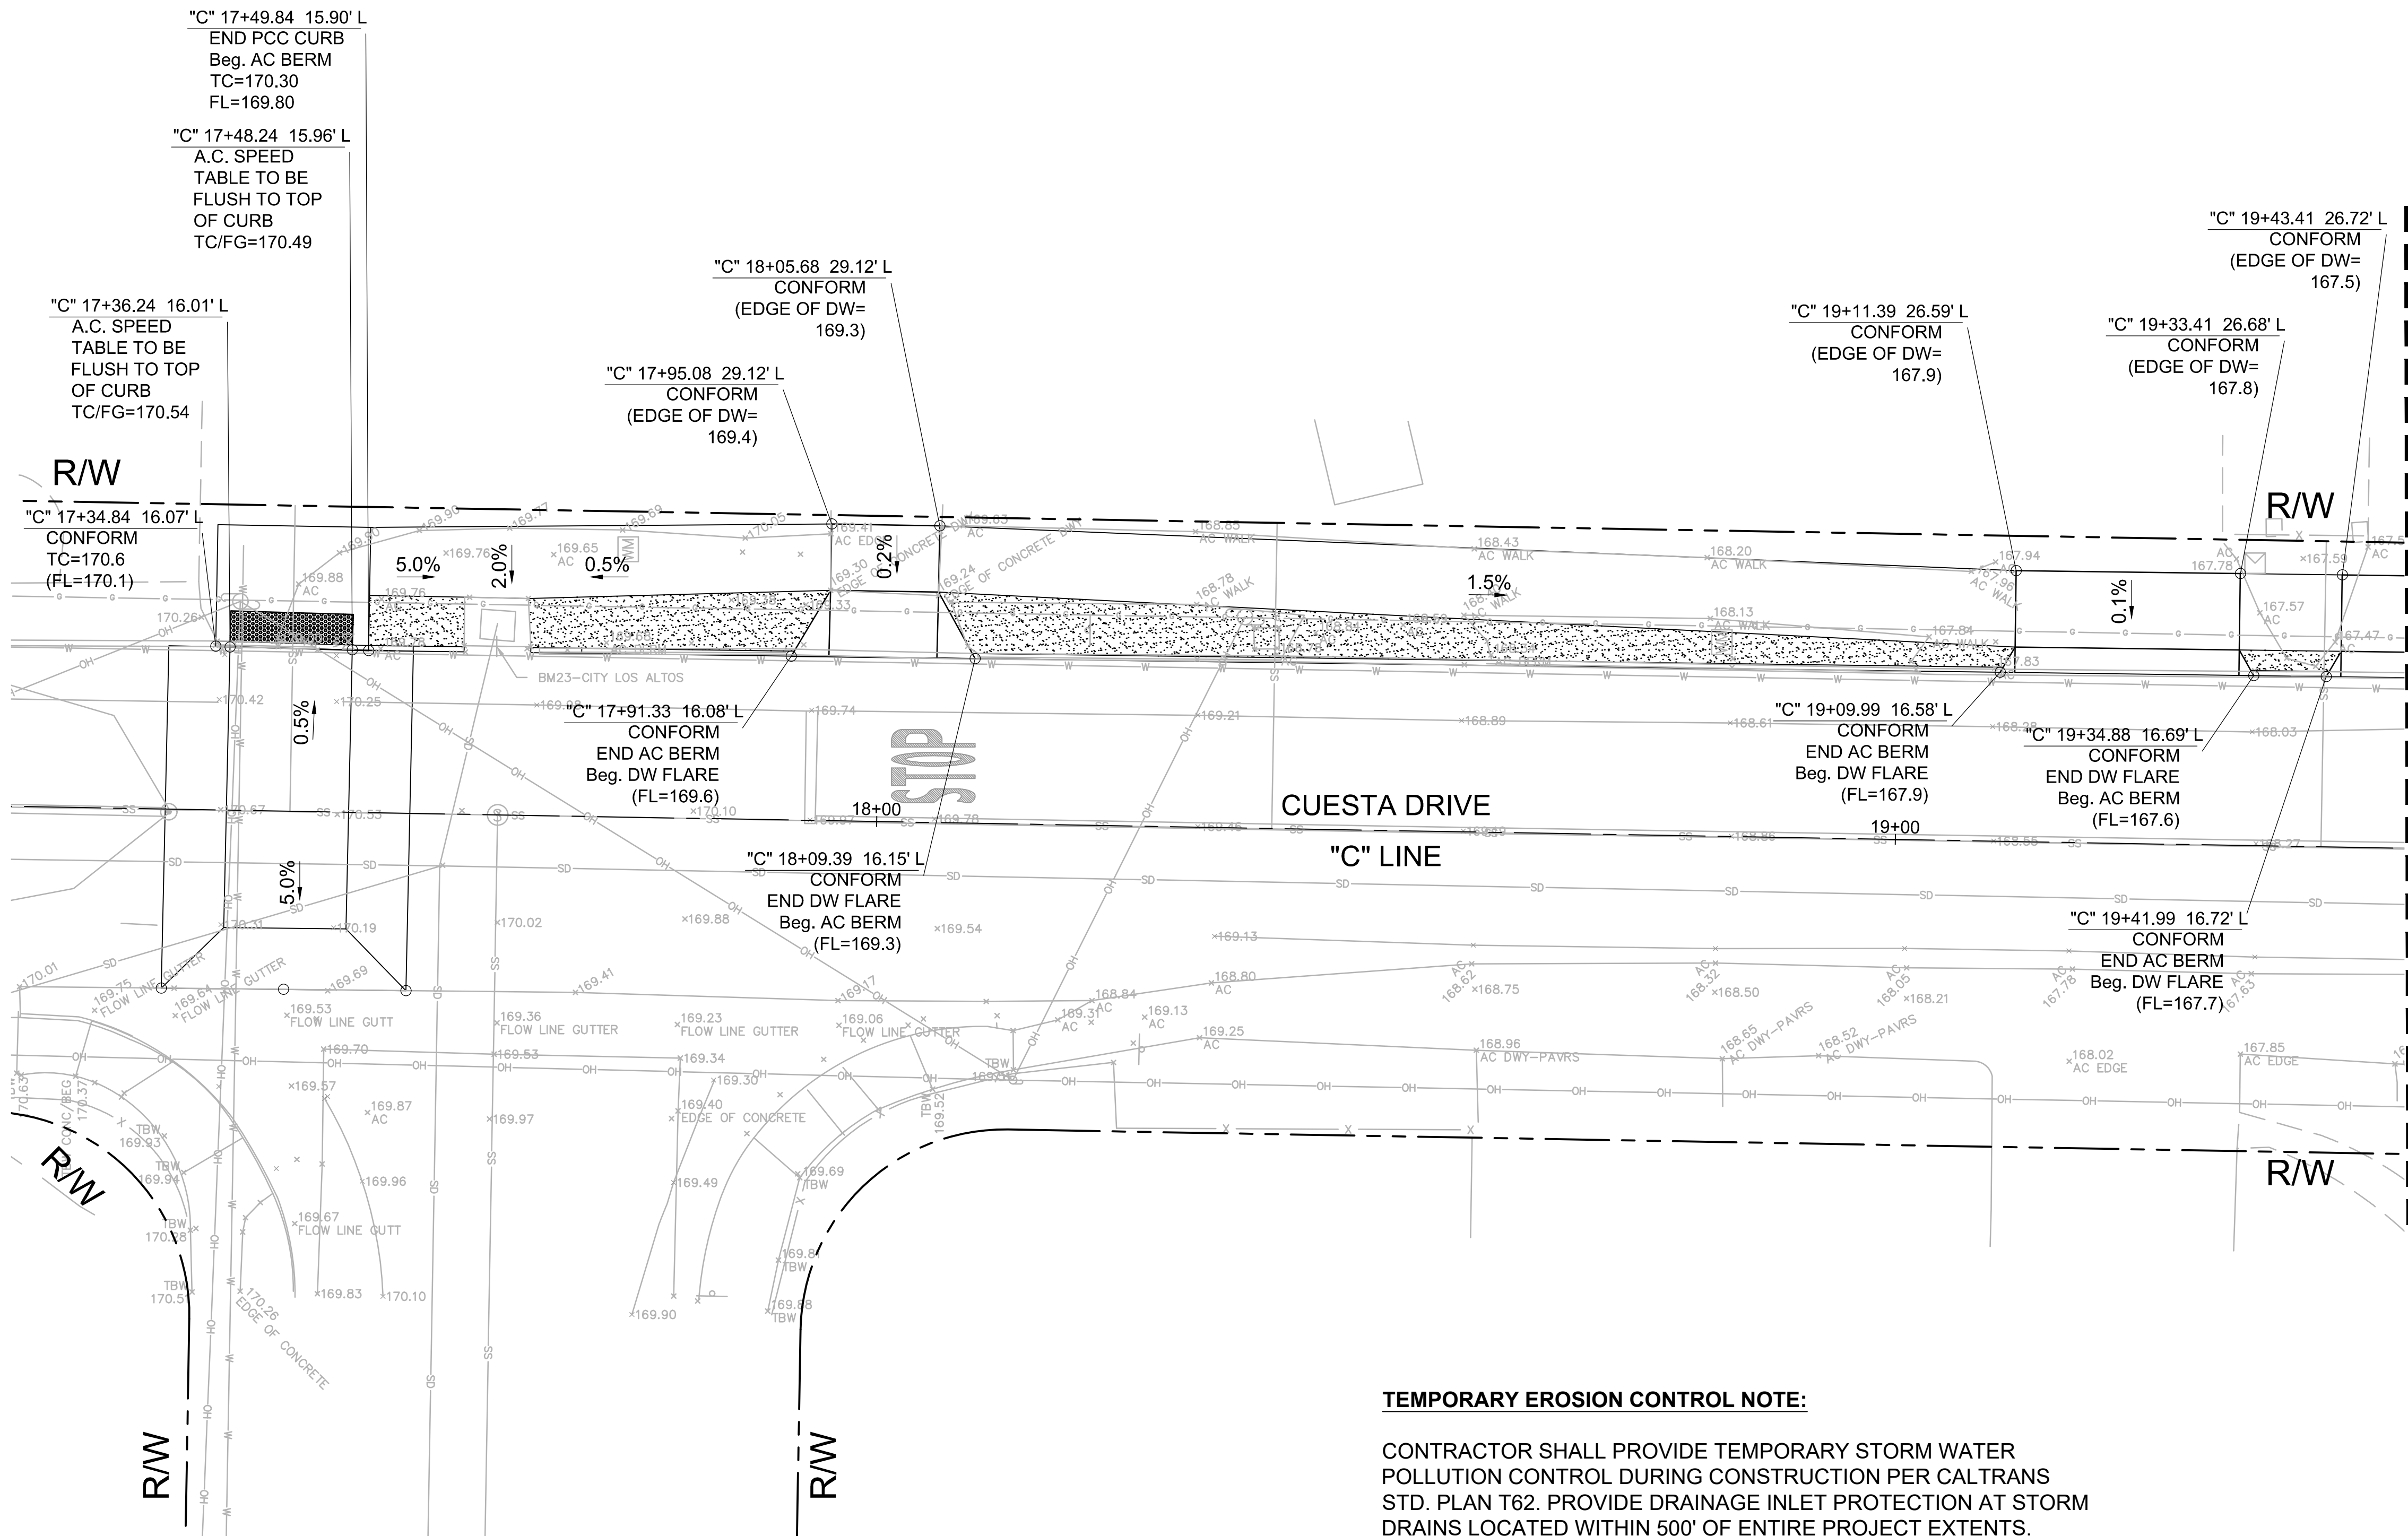


PRELIMINARY
NOT FOR CONSTRUCTION

CUESTA DRIVE TRAFFIC CALMING
Los Altos, California

NOTES:

- FOR NOTES, LEGEND AND ABBREVIATIONS SEE SHEET GN-1.
- FOR DEMOLITION & LAYOUT DRAWING NUMBERS AT THIS LOCATION, SEE SHEET T-1, KEY MAP.
- FOR ALIGNMENT CURVE AND LINE DATA, SEE SHEET GN-02.

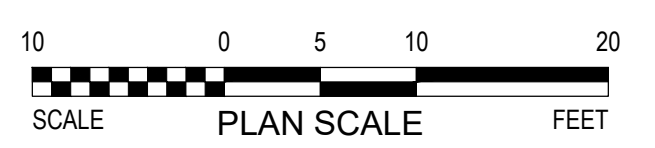
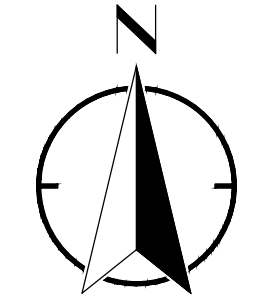


MATCH LINE - STA "C" 19+50
SEE SHEET G-02

LEGEND:
 D.G. SECTION

TEMPORARY EROSION CONTROL NOTE:

CONTRACTOR SHALL PROVIDE TEMPORARY STORM WATER POLLUTION CONTROL DURING CONSTRUCTION PER CALTRANS STD. PLAN T62. PROVIDE DRAINAGE INLET PROTECTION AT STORM DRAINS LOCATED WITHIN 500' OF ENTIRE PROJECT EXTENTS. CONTRACTOR TO VERIFY ALL STORM WATER DRAIN INLET LOCATIONS.



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DRAWN: JP	
2018-248 8/22/19	
PROJECT NO. 18-248-Grading & Drainage Plans	
1"=20' SCALE	FILE



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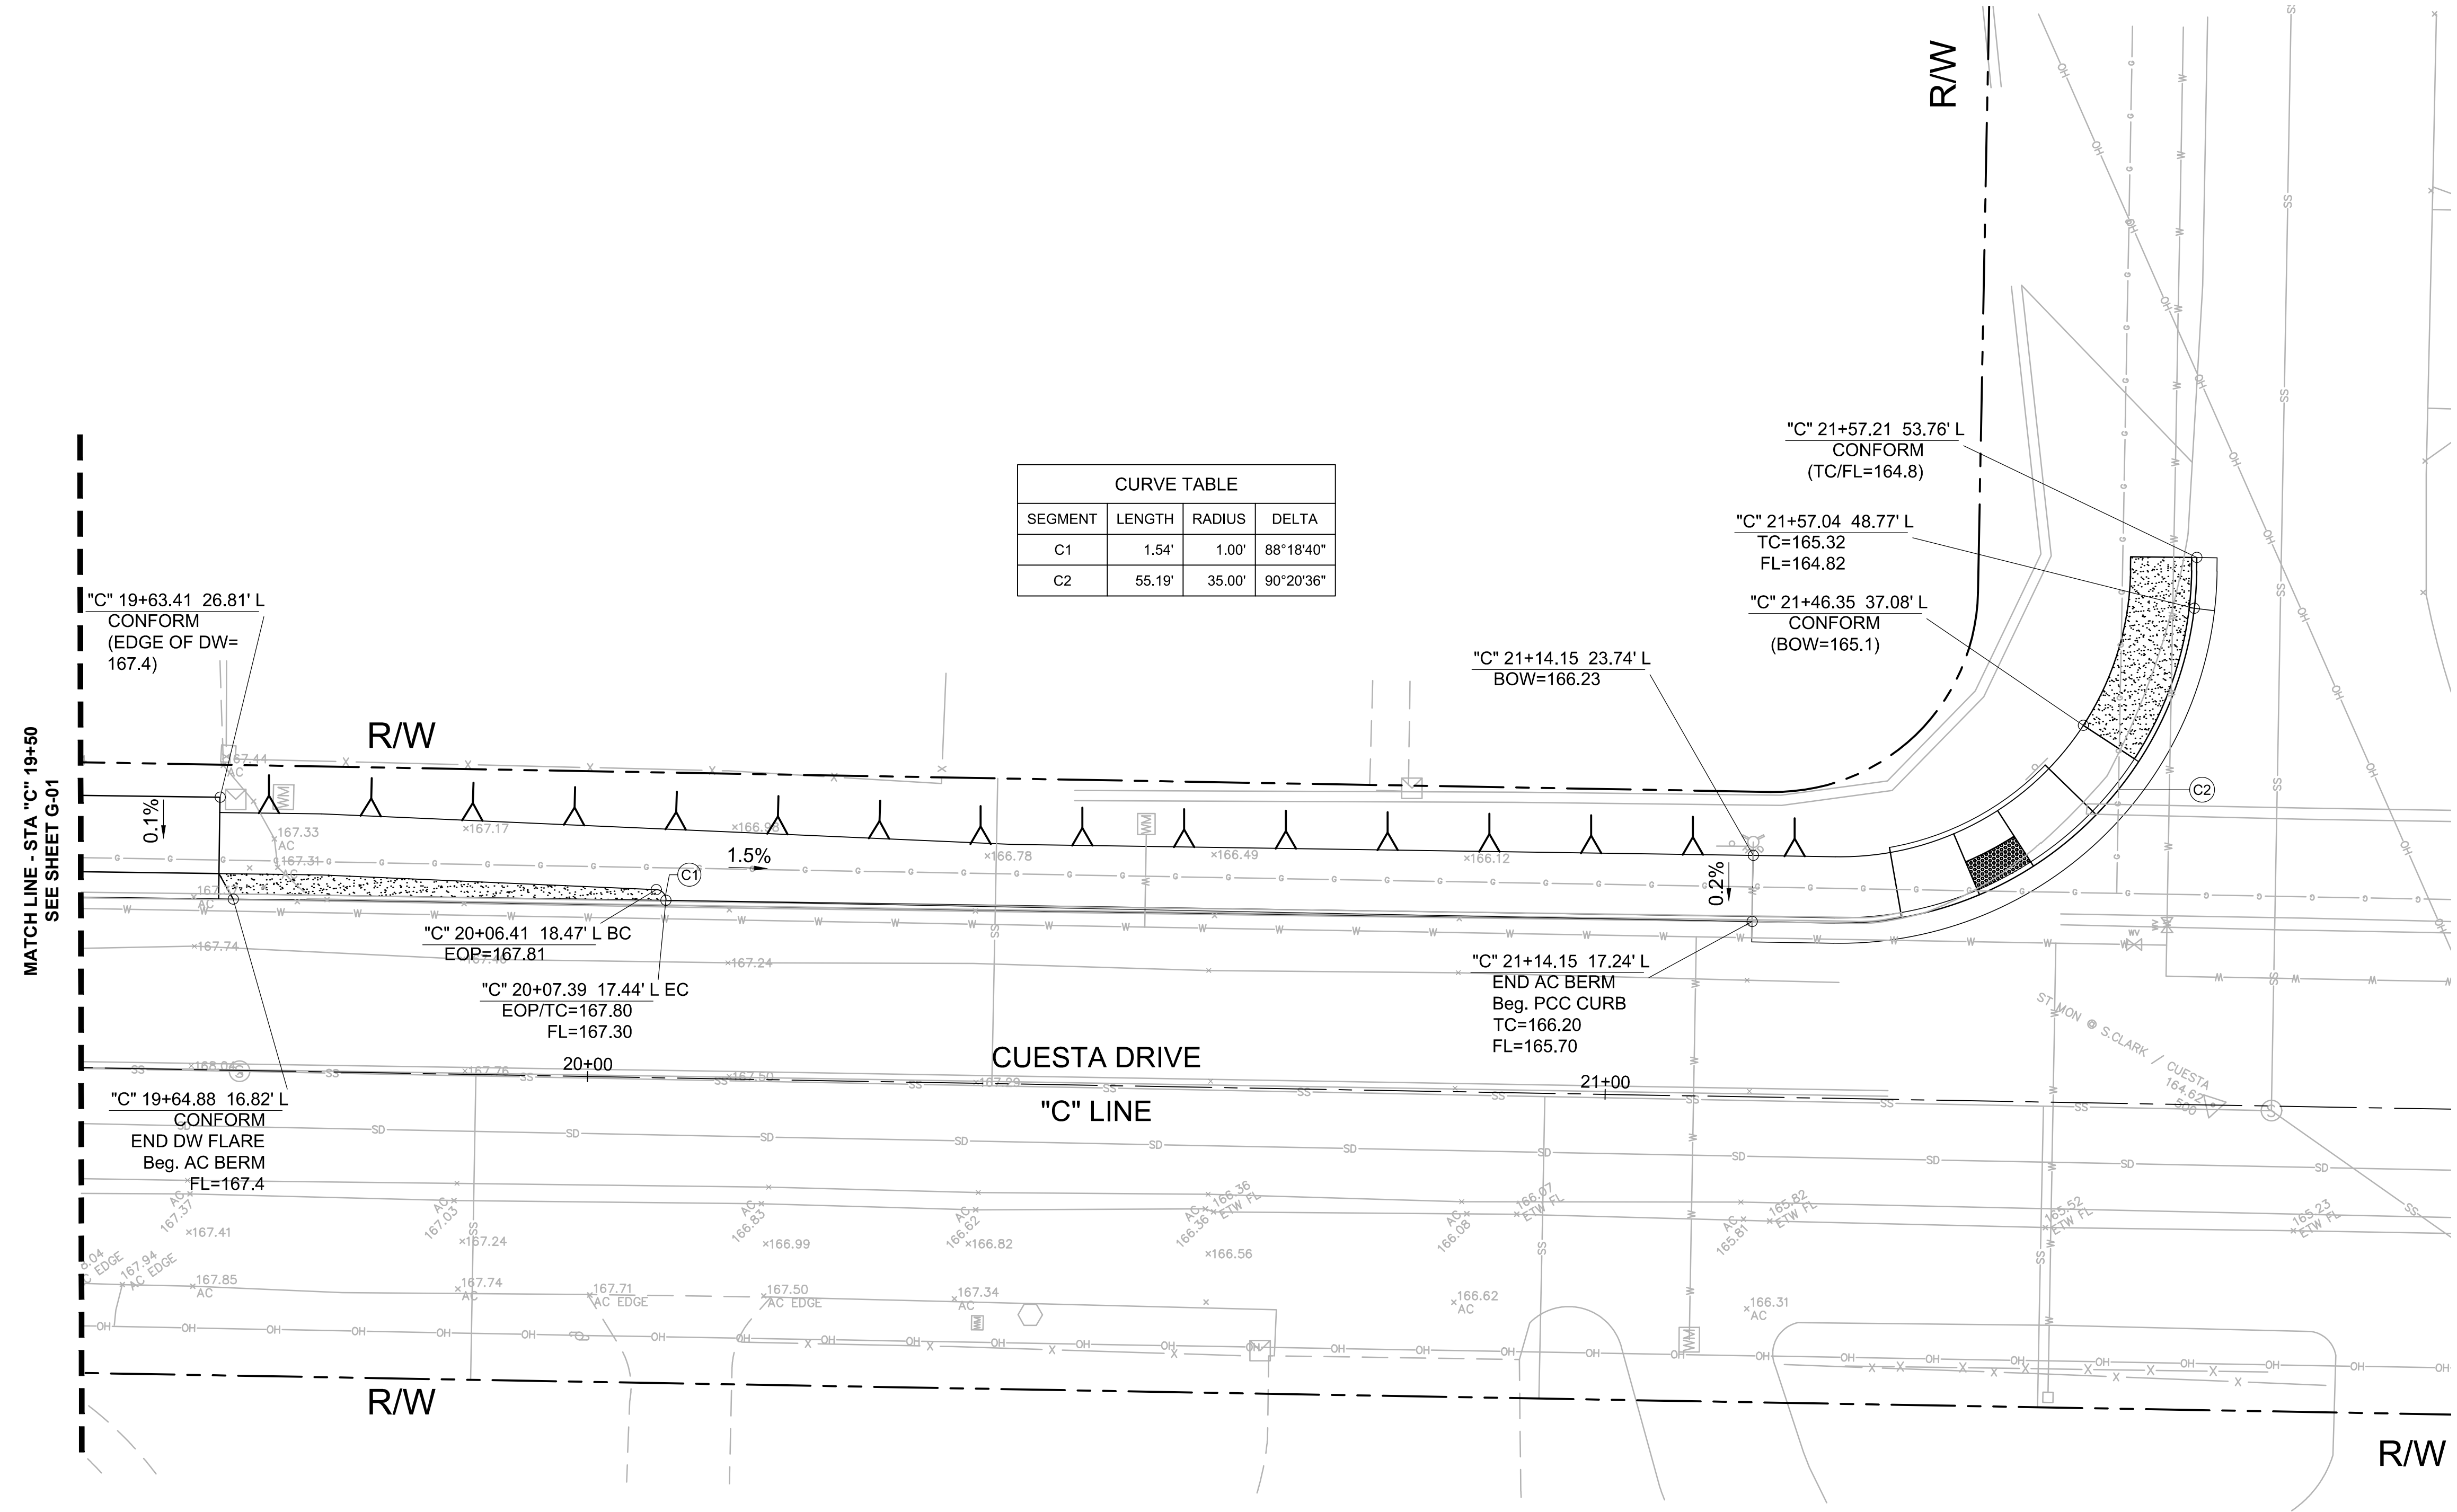
**CUESTA DRIVE
TRAFFIC CALMING**
Los Altos, California

GRADING AND
DRAINAGE PLANS

SHEET NO.
G-01
22 OF 30

- NOTES:**
- FOR NOTES, LEGEND AND ABBREVIATIONS SEE SHEET GN-1.
 - FOR DEMOLITION & LAYOUT DRAWING NUMBERS AT THIS LOCATION, SEE SHEET T-1, KEY MAP.
 - FOR ALIGNMENT CURVE AND LINE DATA, SEE SHEET GN-02.

CURVE TABLE			
SEGMENT	LENGTH	RADIUS	DELTA
C1	1.54'	1.00'	88°18'40"
C2	55.19'	35.00'	90°20'36"

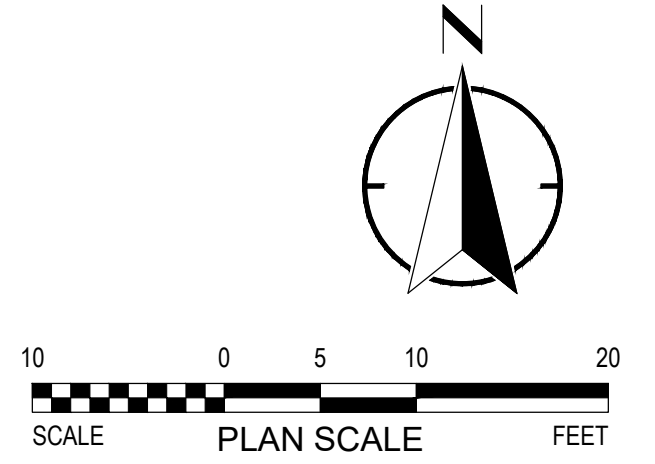


TEMPORARY EROSION CONTROL NOTE:

CONTRACTOR SHALL PROVIDE TEMPORARY STORM WATER POLLUTION CONTROL DURING CONSTRUCTION PER CALTRANS STD. PLAN T62. PROVIDE DRAINAGE INLET PROTECTION AT STORM DRAINS LOCATED WITHIN 500' OF ENTIRE PROJECT EXTENTS. CONTRACTOR TO VERIFY ALL STORM WATER DRAIN INLET LOCATIONS.

LEGEND:

D.G. SECTION



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DRAWN: JP	
2018-248 8/22/19	
PROJECT NO. 18-248-Grading & Drainage Plans	
1"=20' SCALE FILE	



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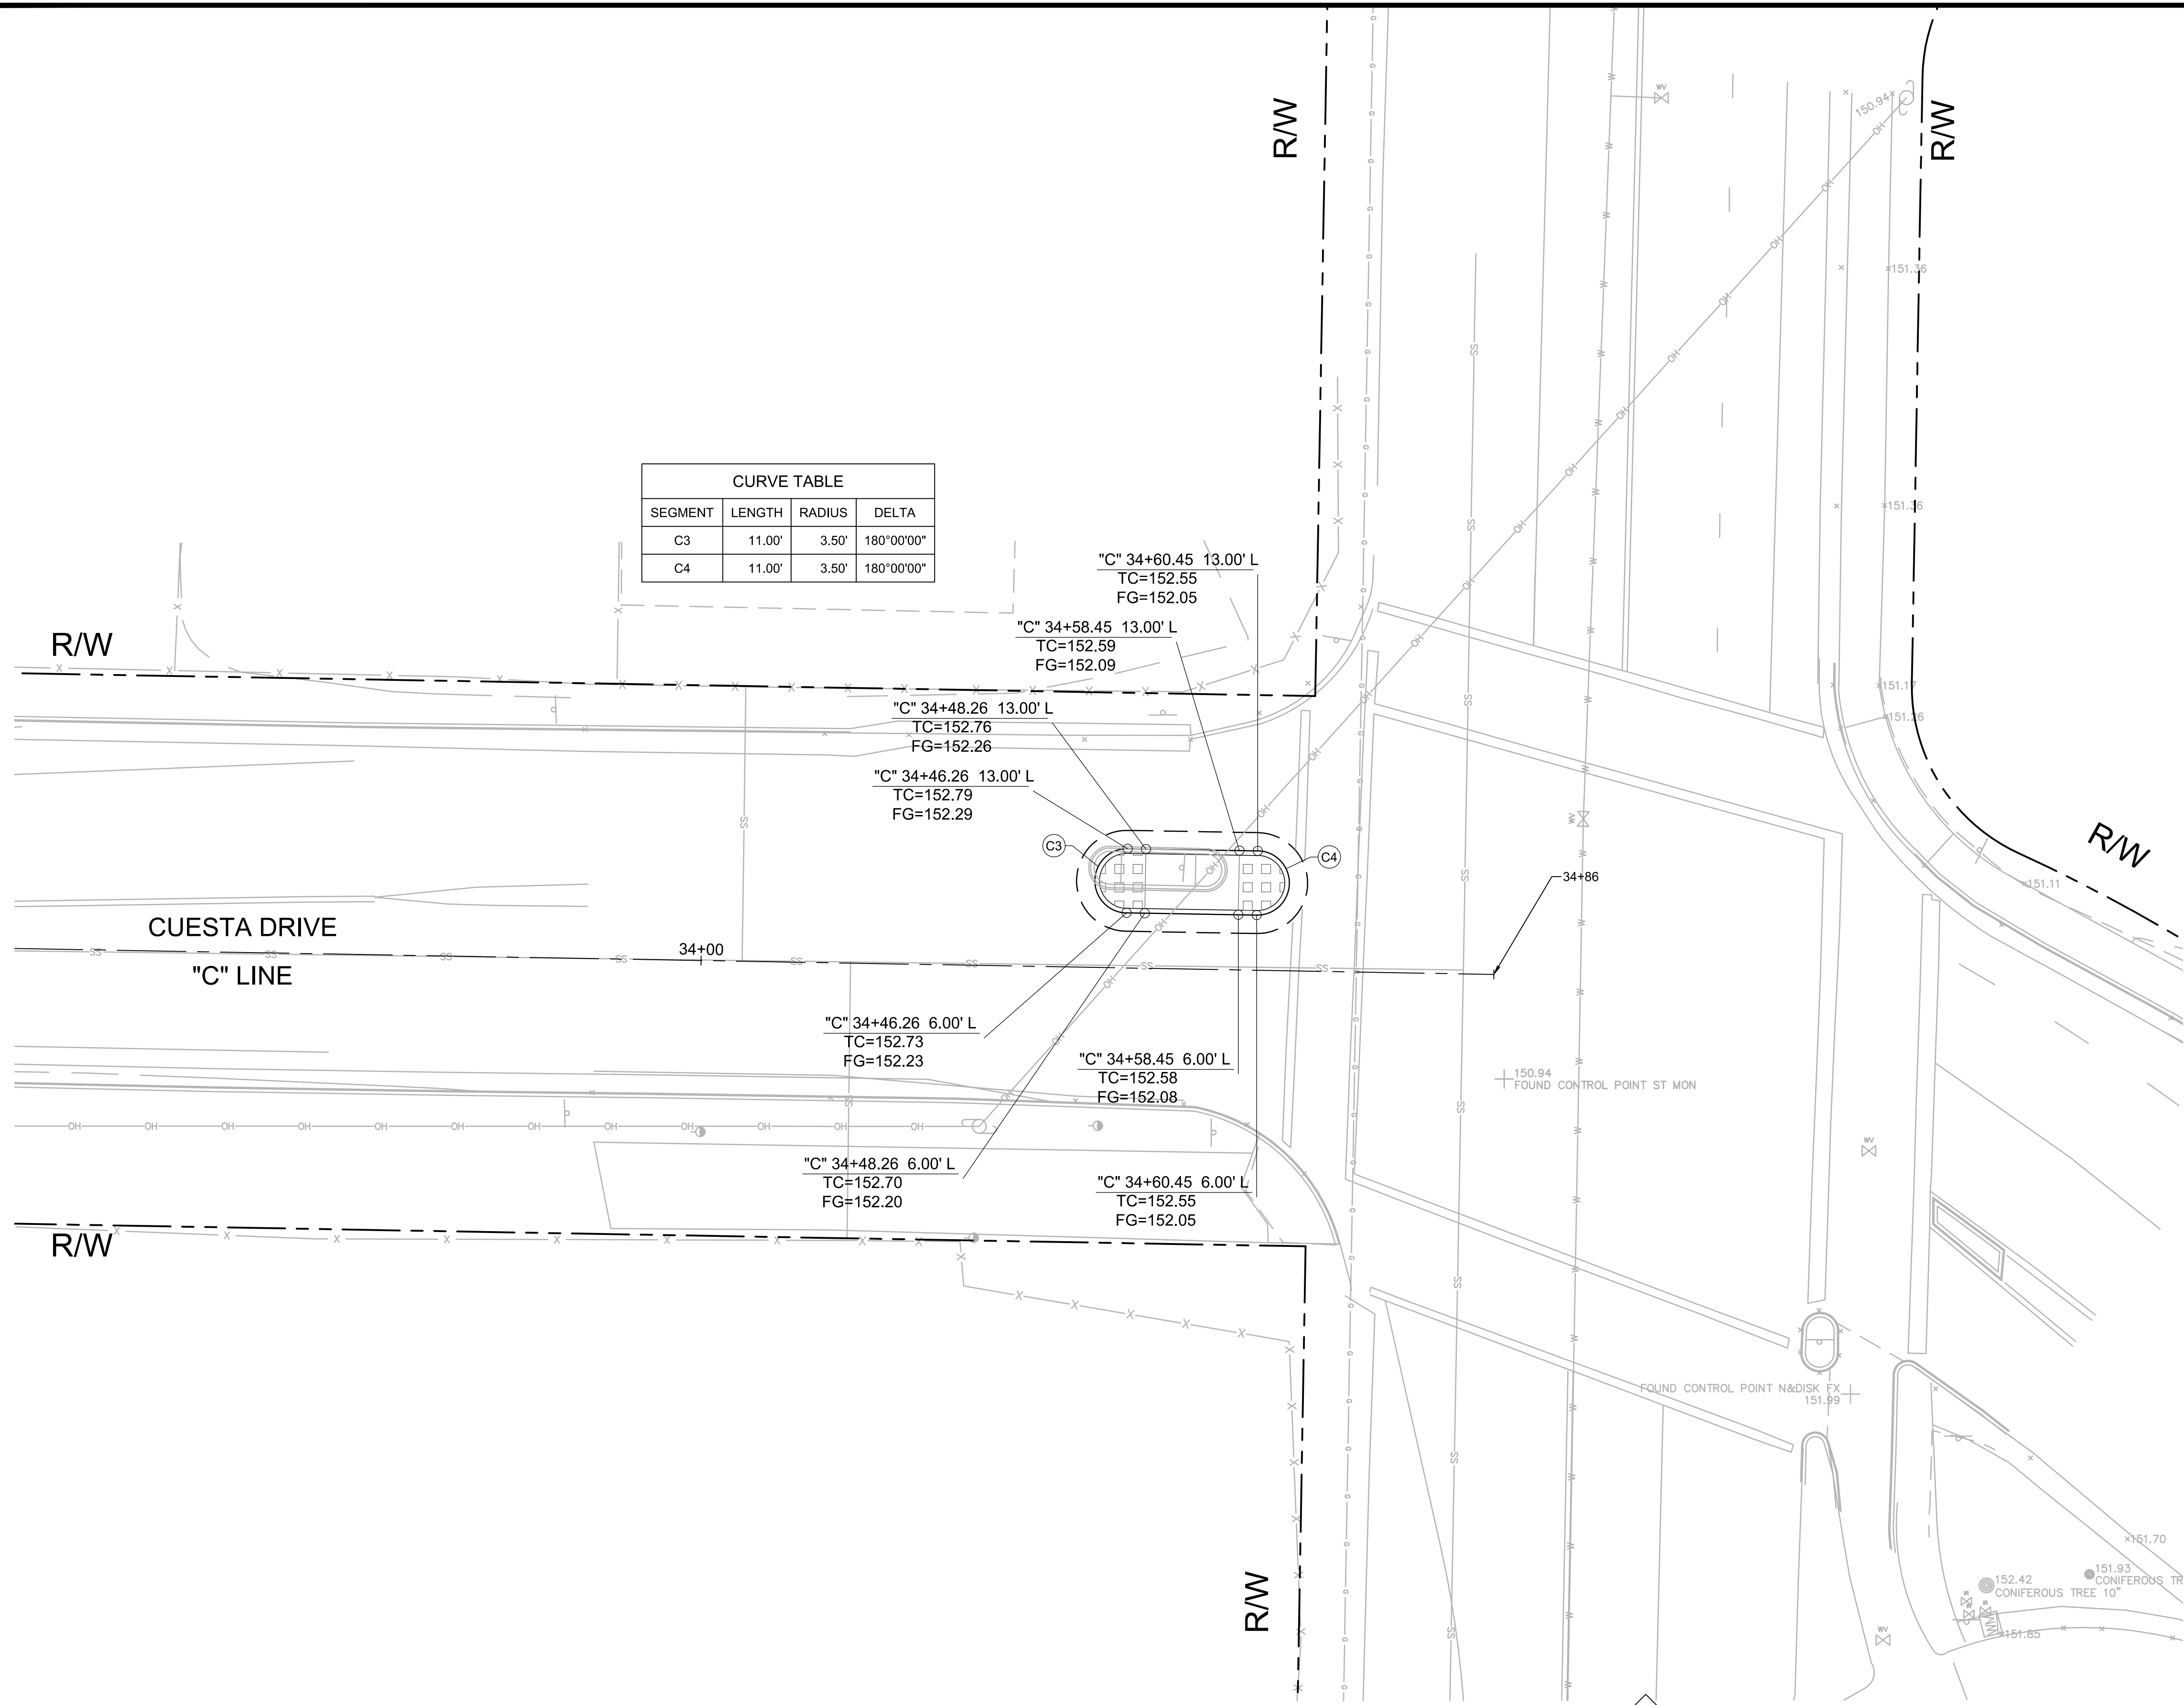
**CUESTA DRIVE
TRAFFIC CALMING**
Los Altos, California

GRADING AND
DRAINAGE PLANS

SHEET NO.
G-02
23 OF 30


- NOTES:**
- FOR NOTES, LEGEND AND ABBREVIATIONS SEE SHEET GN-1.
 - FOR DEMOLITION & LAYOUT DRAWING NUMBERS AT THIS LOCATION, SEE SHEET T-1, KEY MAP.
 - FOR ALIGNMENT CURVE AND LINE DATA, SEE SHEET GN-02.

CURVE TABLE			
SEGMENT	LENGTH	RADIUS	DELTA
C3	11.00'	3.50'	180°00'00"
C4	11.00'	3.50'	180°00'00"



TEMPORARY EROSION CONTROL NOTE:

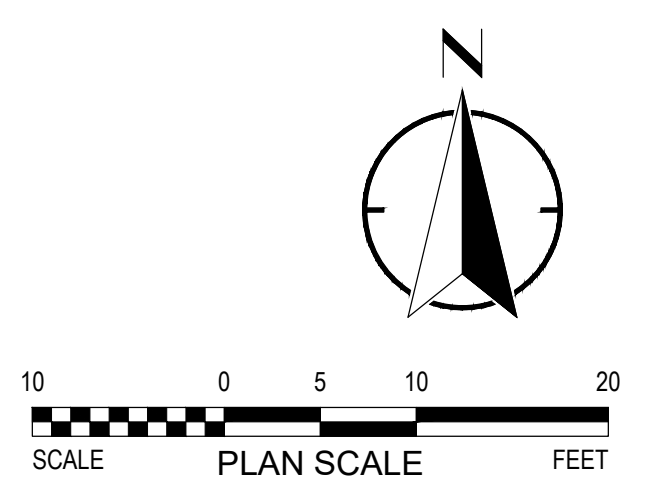CONTRACTOR SHALL PROVIDE TEMPORARY STORM WATER POLLUTION CONTROL DURING CONSTRUCTION PER CALTRANS STD. PLAN T62. PROVIDE DRAINAGE INLET PROTECTION AT STORM DRAINS LOCATED WITHIN 500' OF ENTIRE PROJECT EXTENTS. CONTRACTOR TO VERIFY ALL STORM WATER DRAIN INLET LOCATIONS.



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DRAWN: JP	
2018-248 8/22/19	
PROJECT NO. DATE	
18-248-Grading & Drainage Plans	
1"=20' SCALE	FILE



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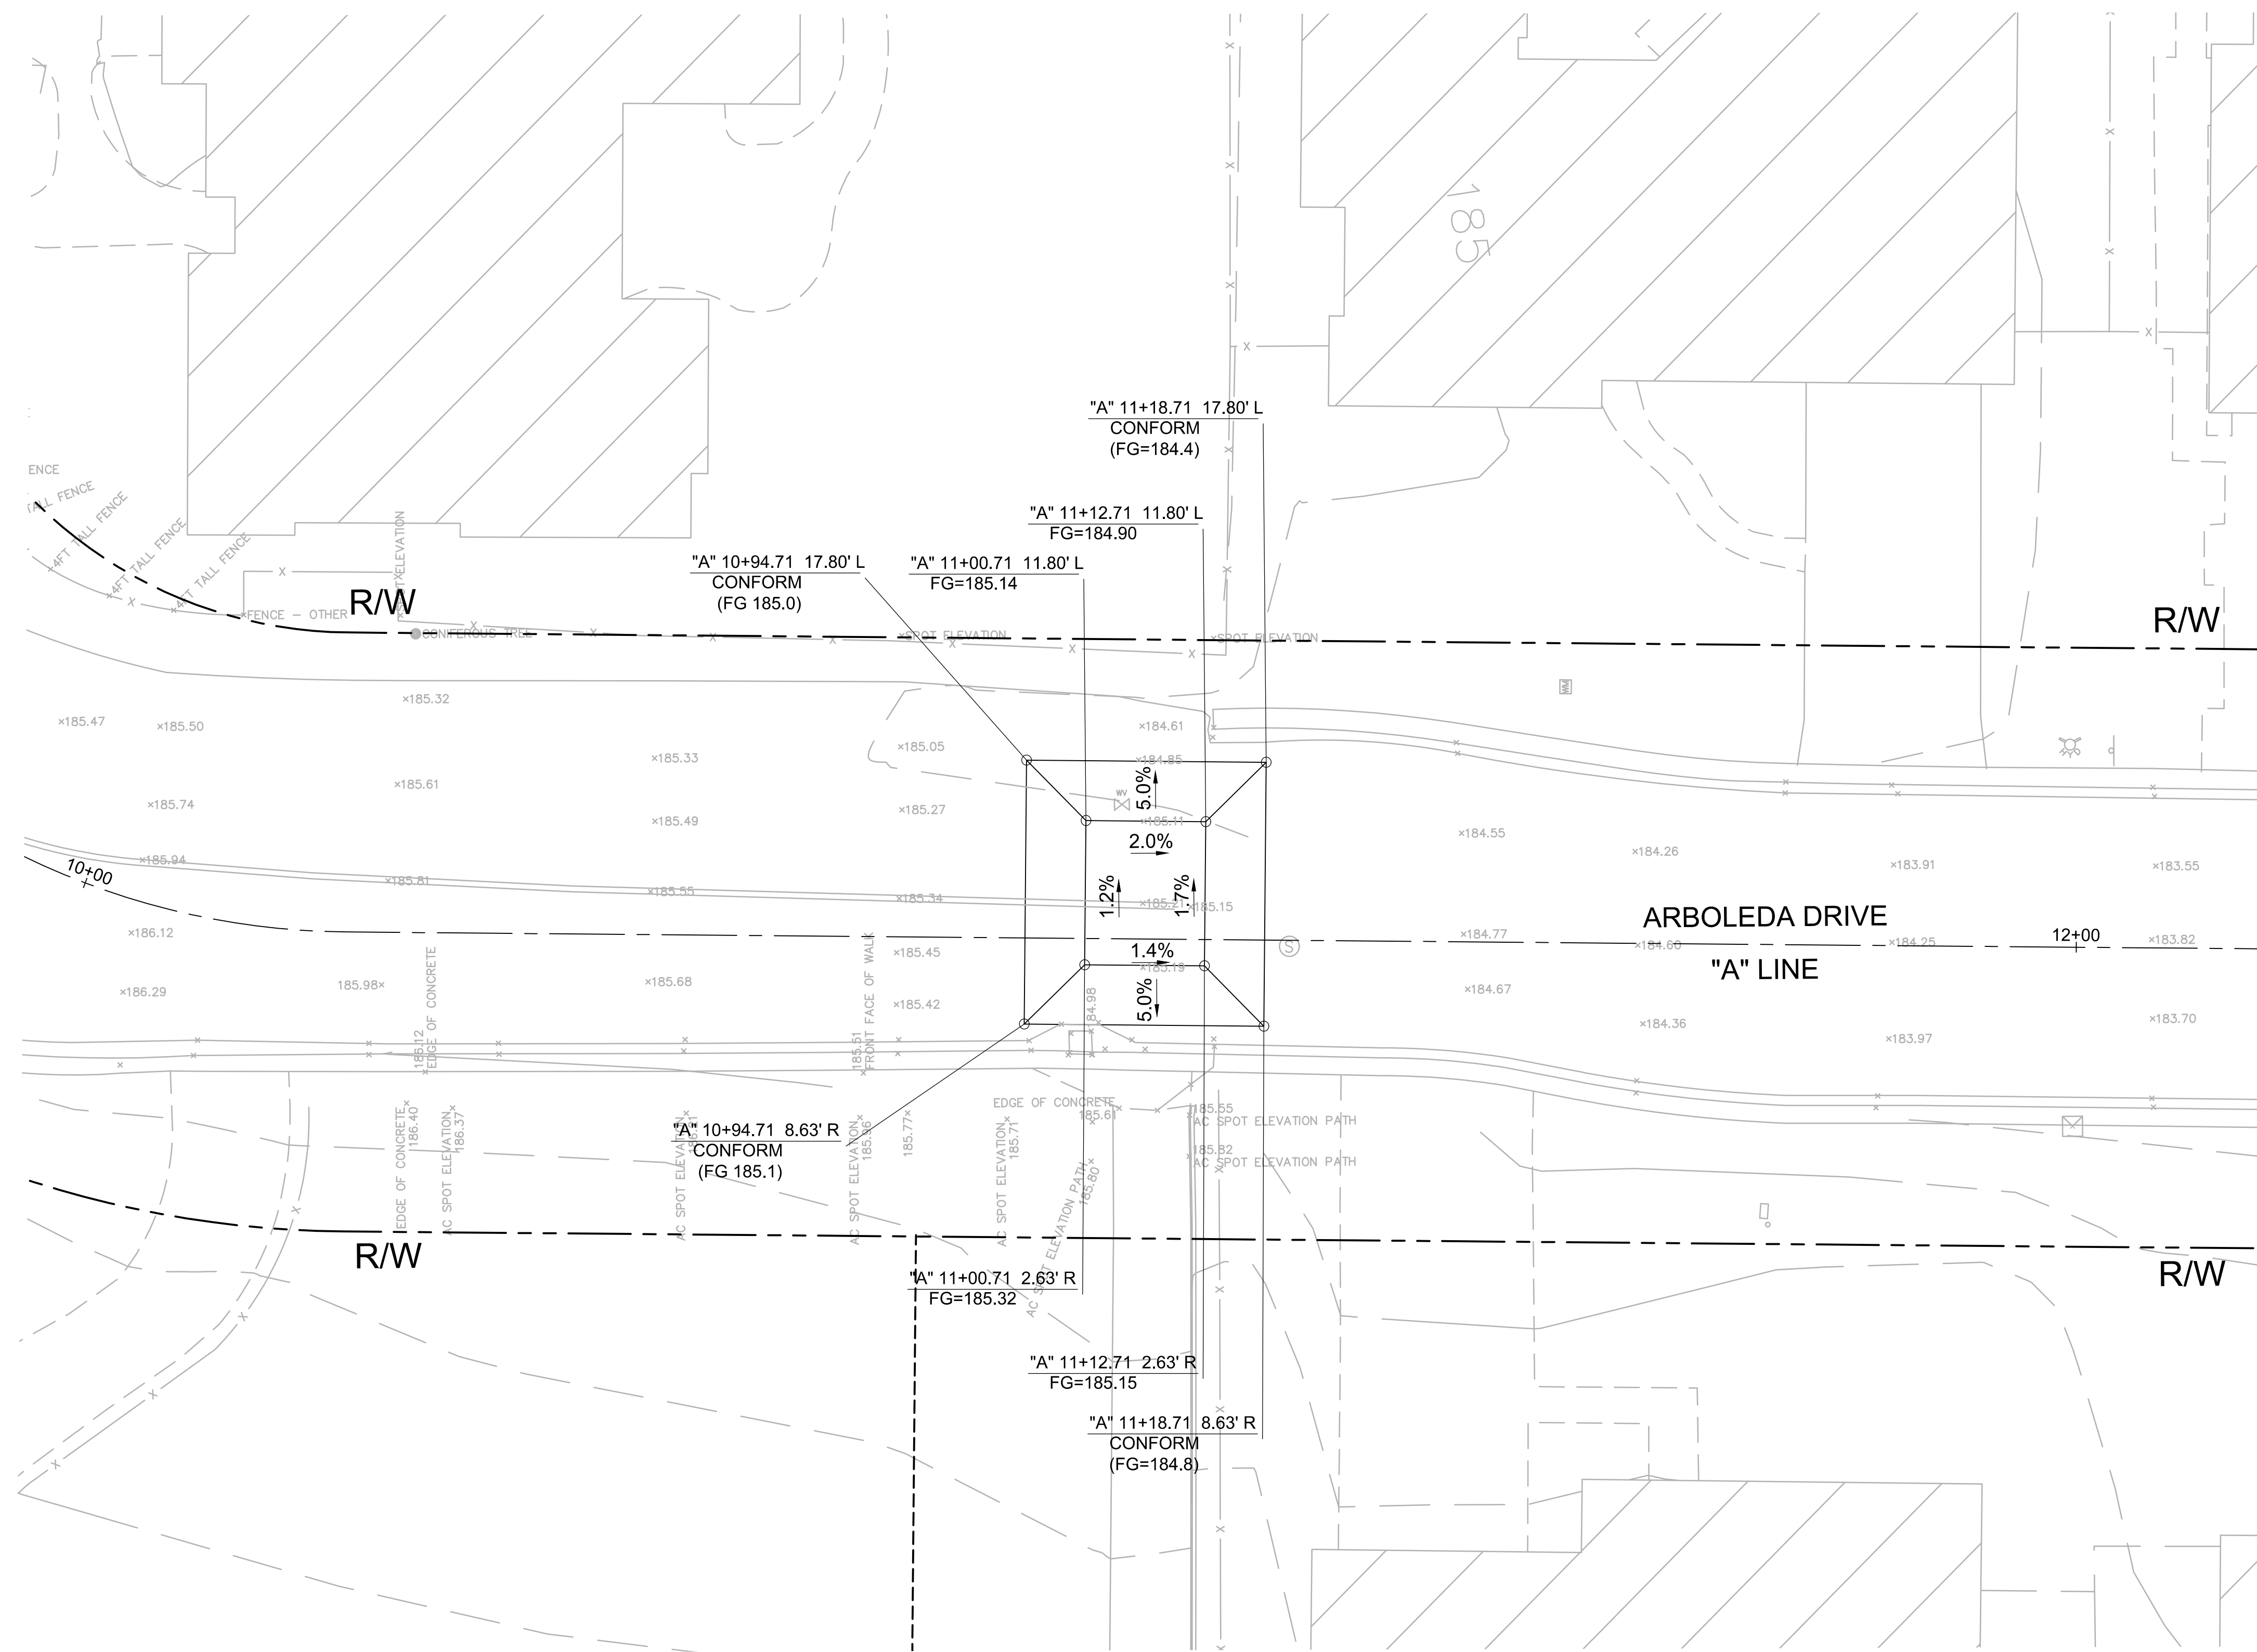
PRELIMINARY
NOT FOR CONSTRUCTION

**CUESTA DRIVE
TRAFFIC CALMING**
Los Altos, California

GRADING AND
DRAINAGE PLANS

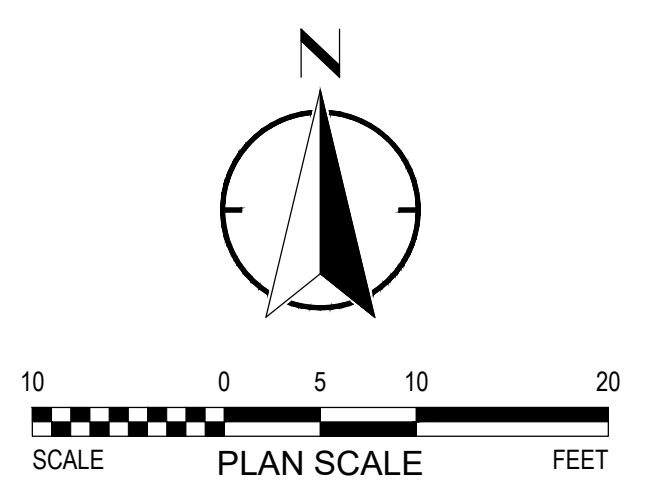
SHEET NO.
G-03
24 OF 30

- NOTES:**
- FOR NOTES, LEGEND AND ABBREVIATIONS SEE SHEET GN-1.
 - FOR DEMOLITION & LAYOUT DRAWING NUMBERS AT THIS LOCATION, SEE SHEET T-1, KEY MAP.
 - FOR ALIGNMENT CURVE AND LINE DATA, SEE SHEET GN-02.




TEMPORARY EROSION CONTROL NOTE:

CONTRACTOR SHALL PROVIDE TEMPORARY STORM WATER POLLUTION CONTROL DURING CONSTRUCTION PER CALTRANS STD. PLAN T62. PROVIDE DRAINAGE INLET PROTECTION AT STORM DRAINS LOCATED WITHIN 500' OF ENTIRE PROJECT EXTENTS. CONTRACTOR TO VERIFY ALL STORM WATER DRAIN INLET LOCATIONS.



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REVIEWED: SF	NO DATE ITEM
DRAWN: JP	
2018-248 8/22/19	
PROJECT NO. 18-248-Grading & Drainage Plans	
1"=20' SCALE	FILE

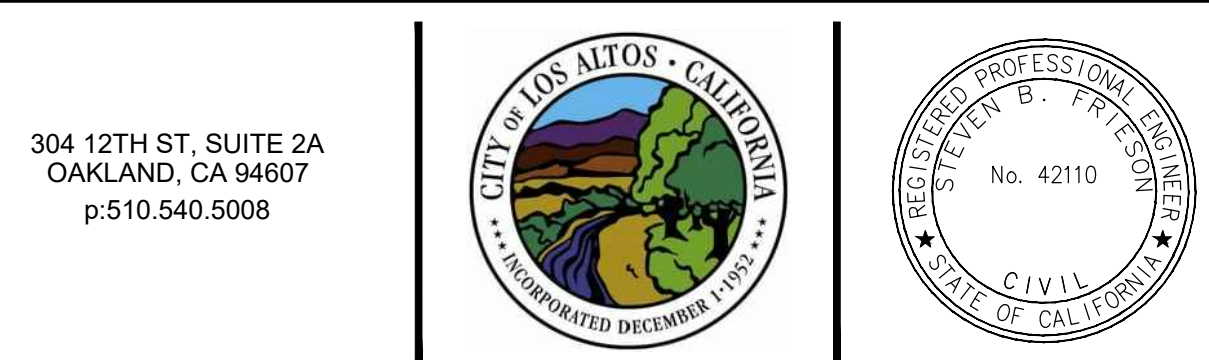


PRELIMINARY
NOT FOR CONSTRUCTION


**CUESTA DRIVE
TRAFFIC CALMING**
Los Altos, California

GRADING &
DRAINAGE PLANS

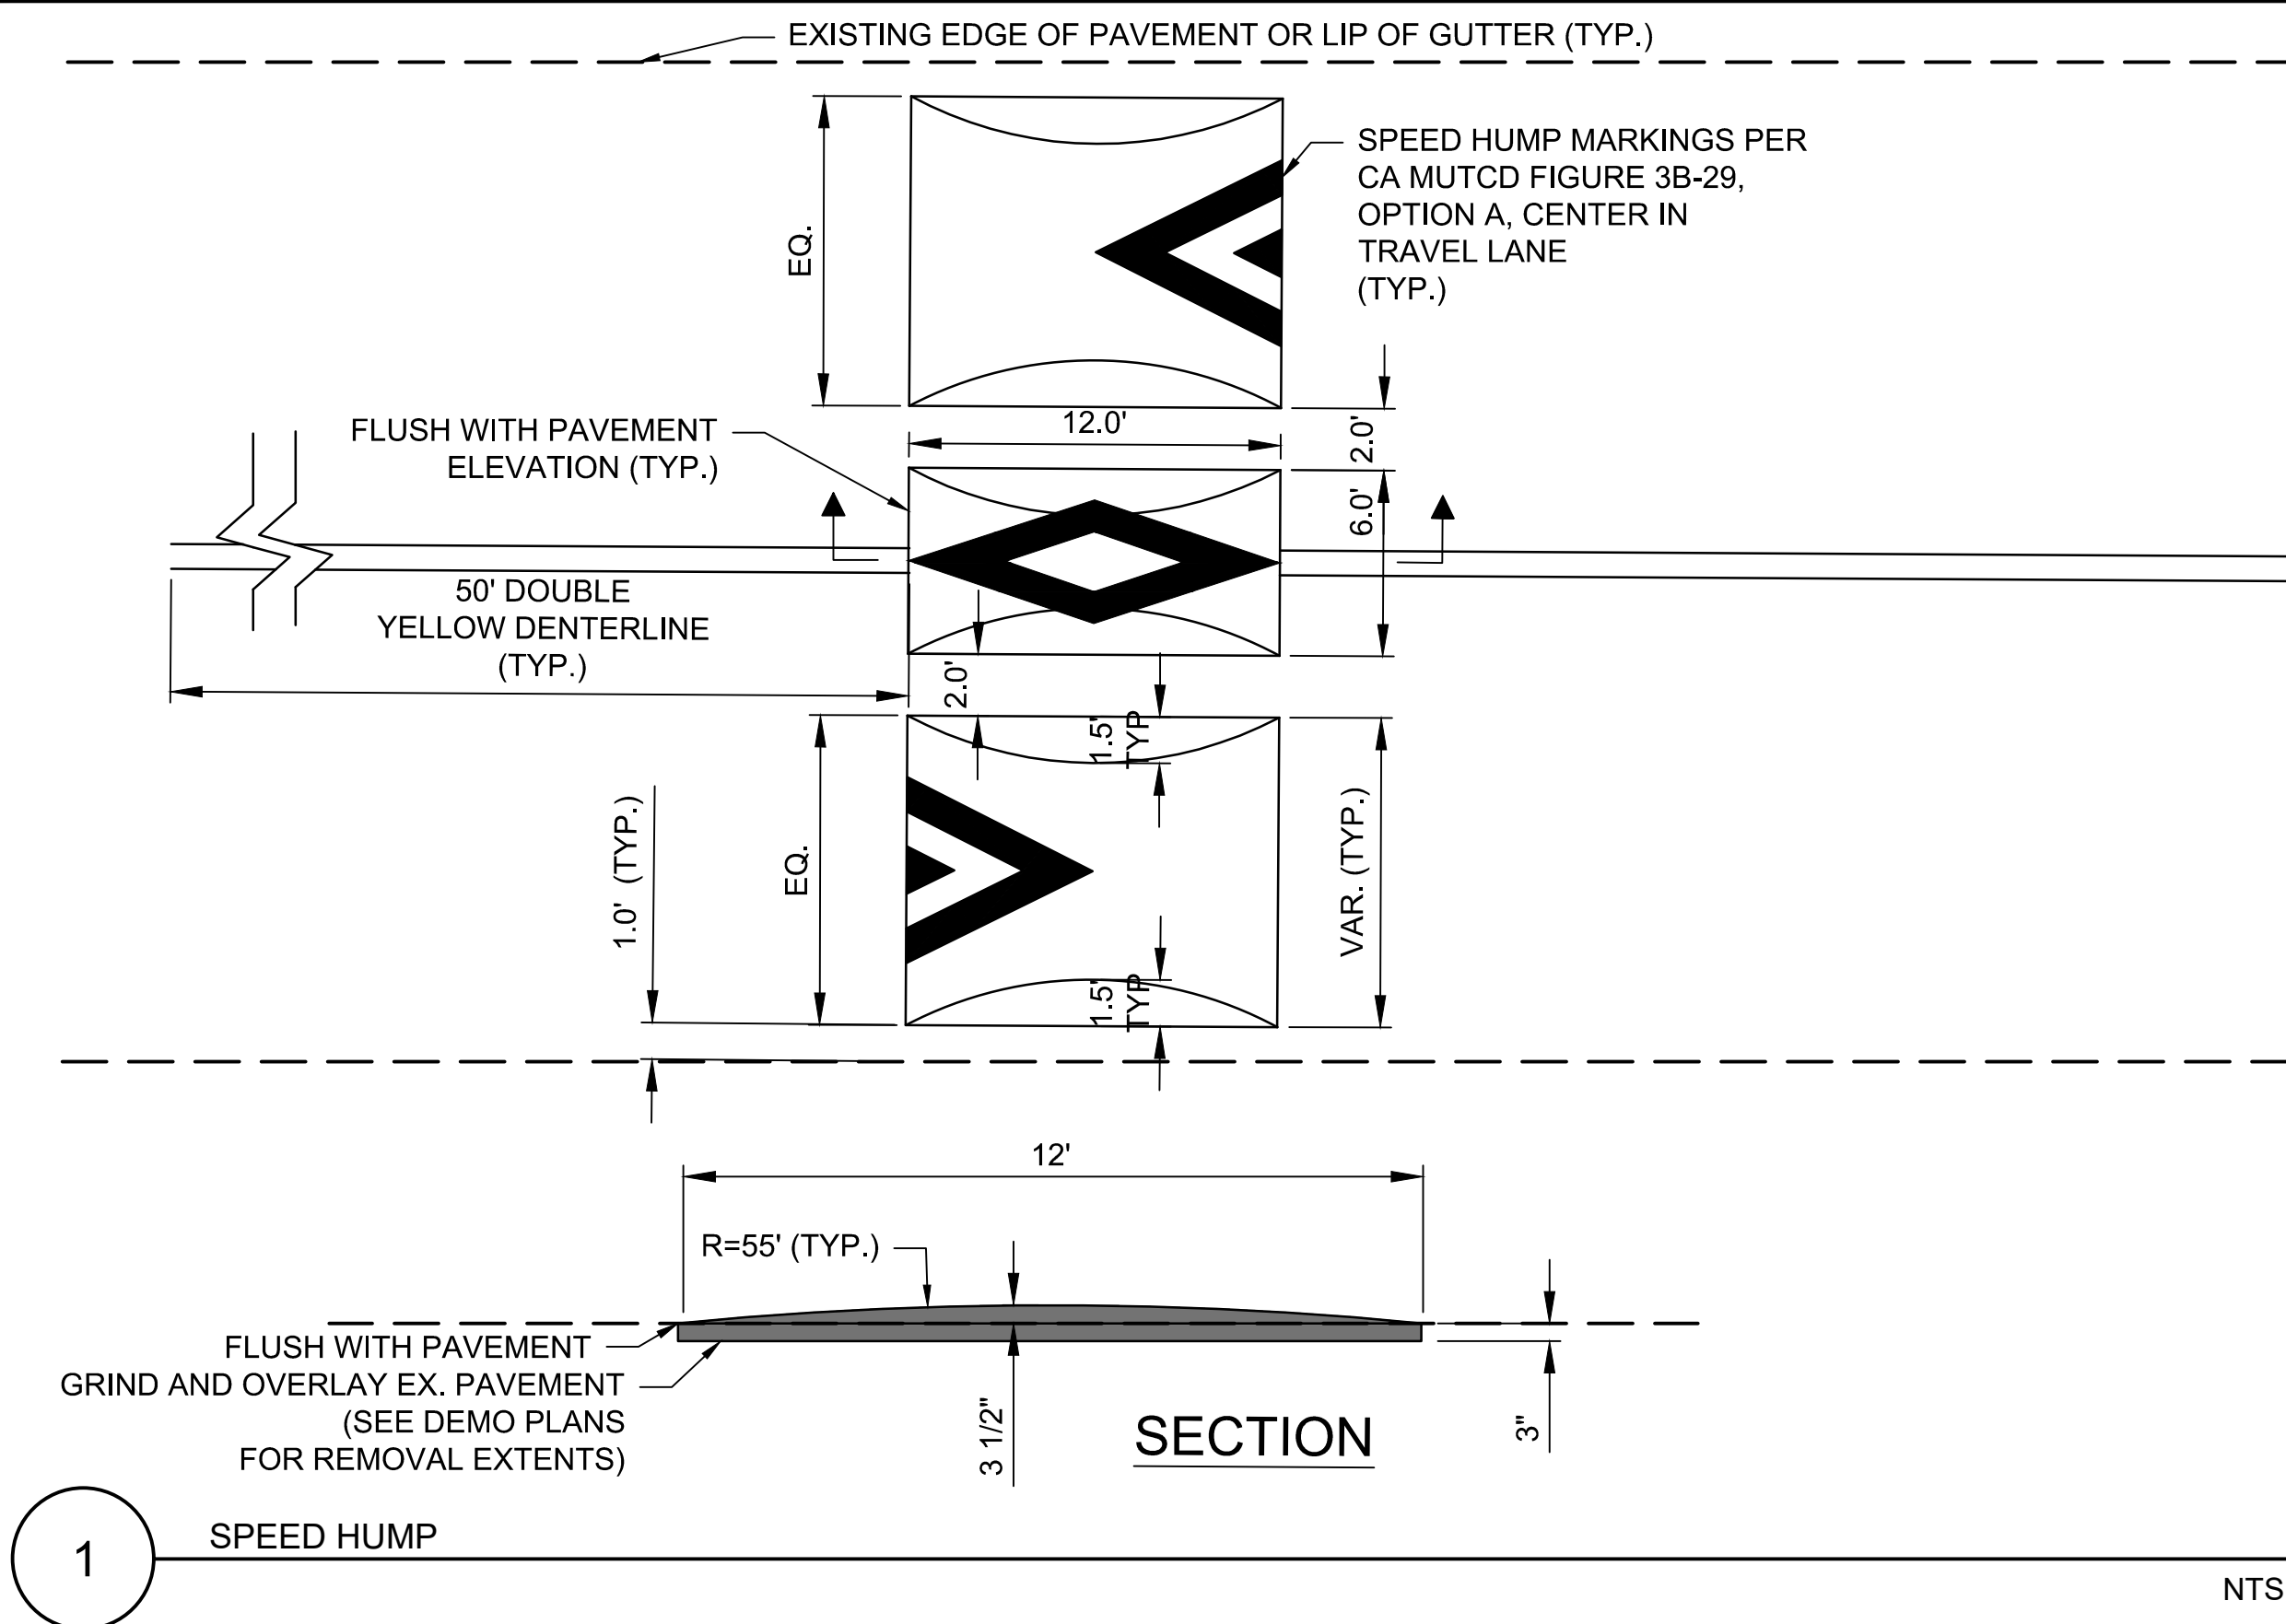
SHEET NO.
G-04
25 OF **30**




1 SPEED HUMP NTS

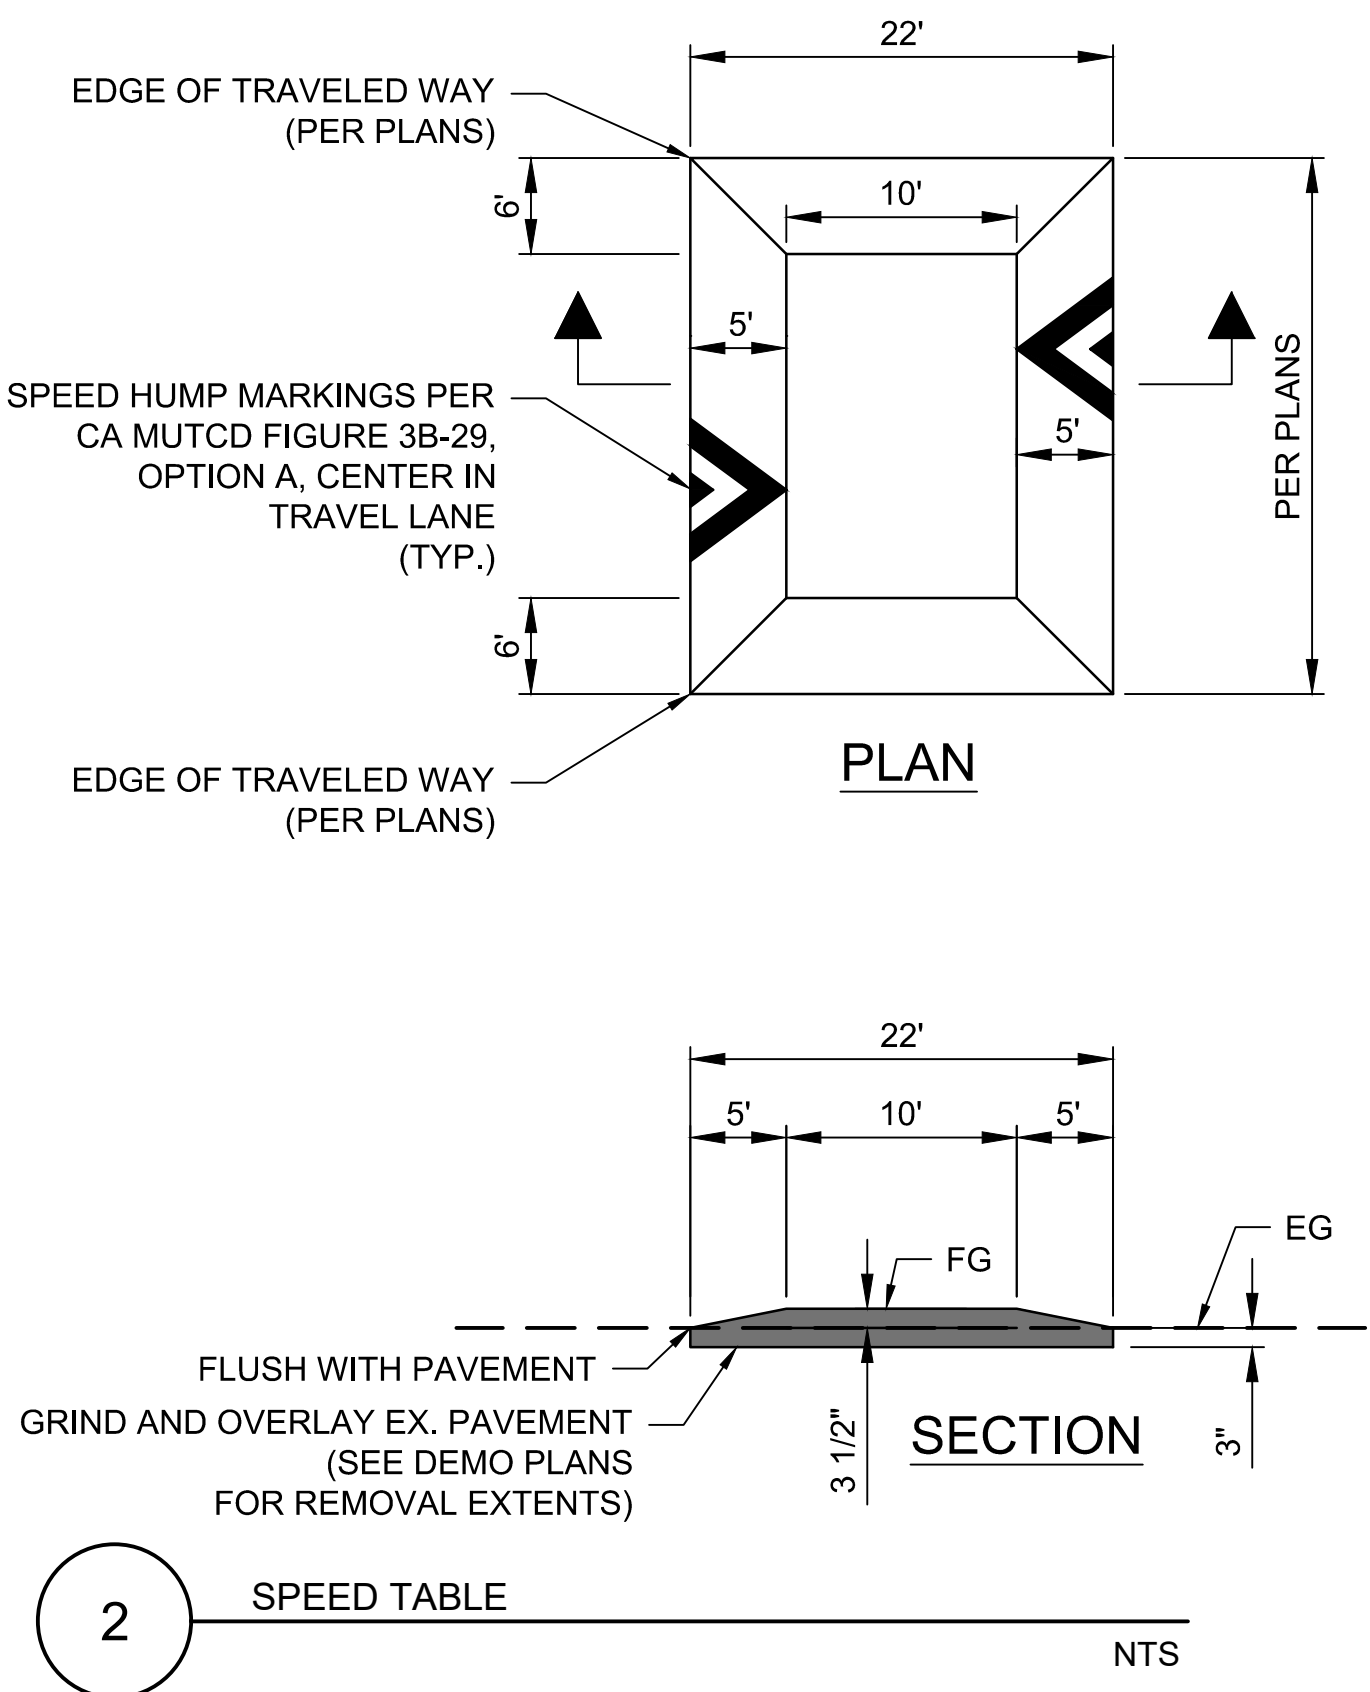

2 SPEED TABLE NTS

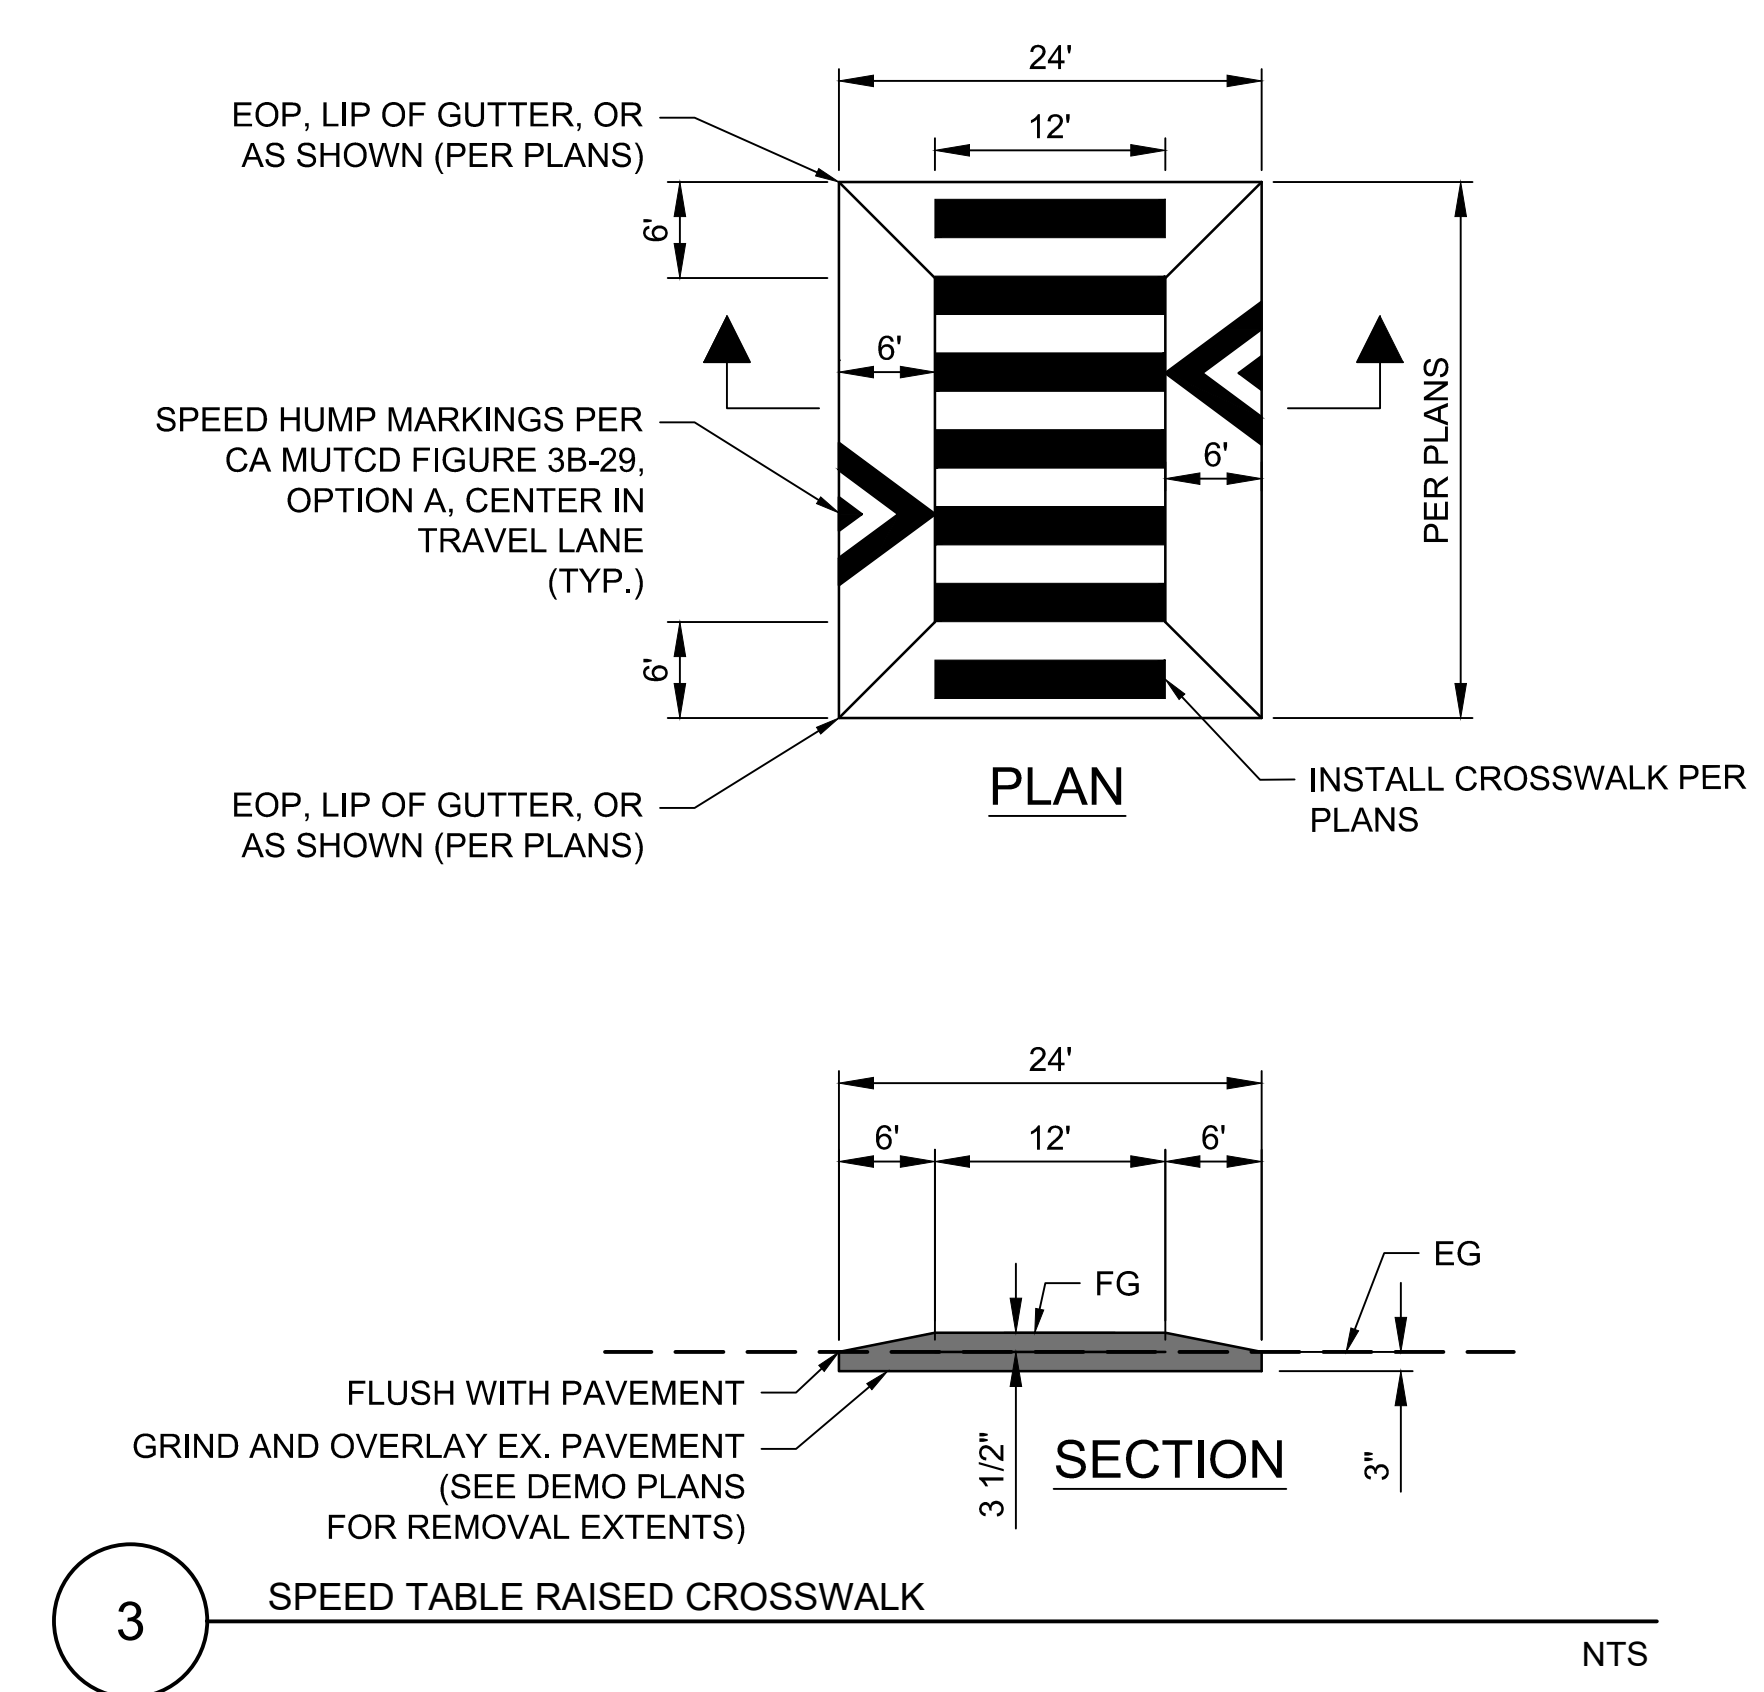


3 SPEED TABLE RAISED CROSSWALK NTS

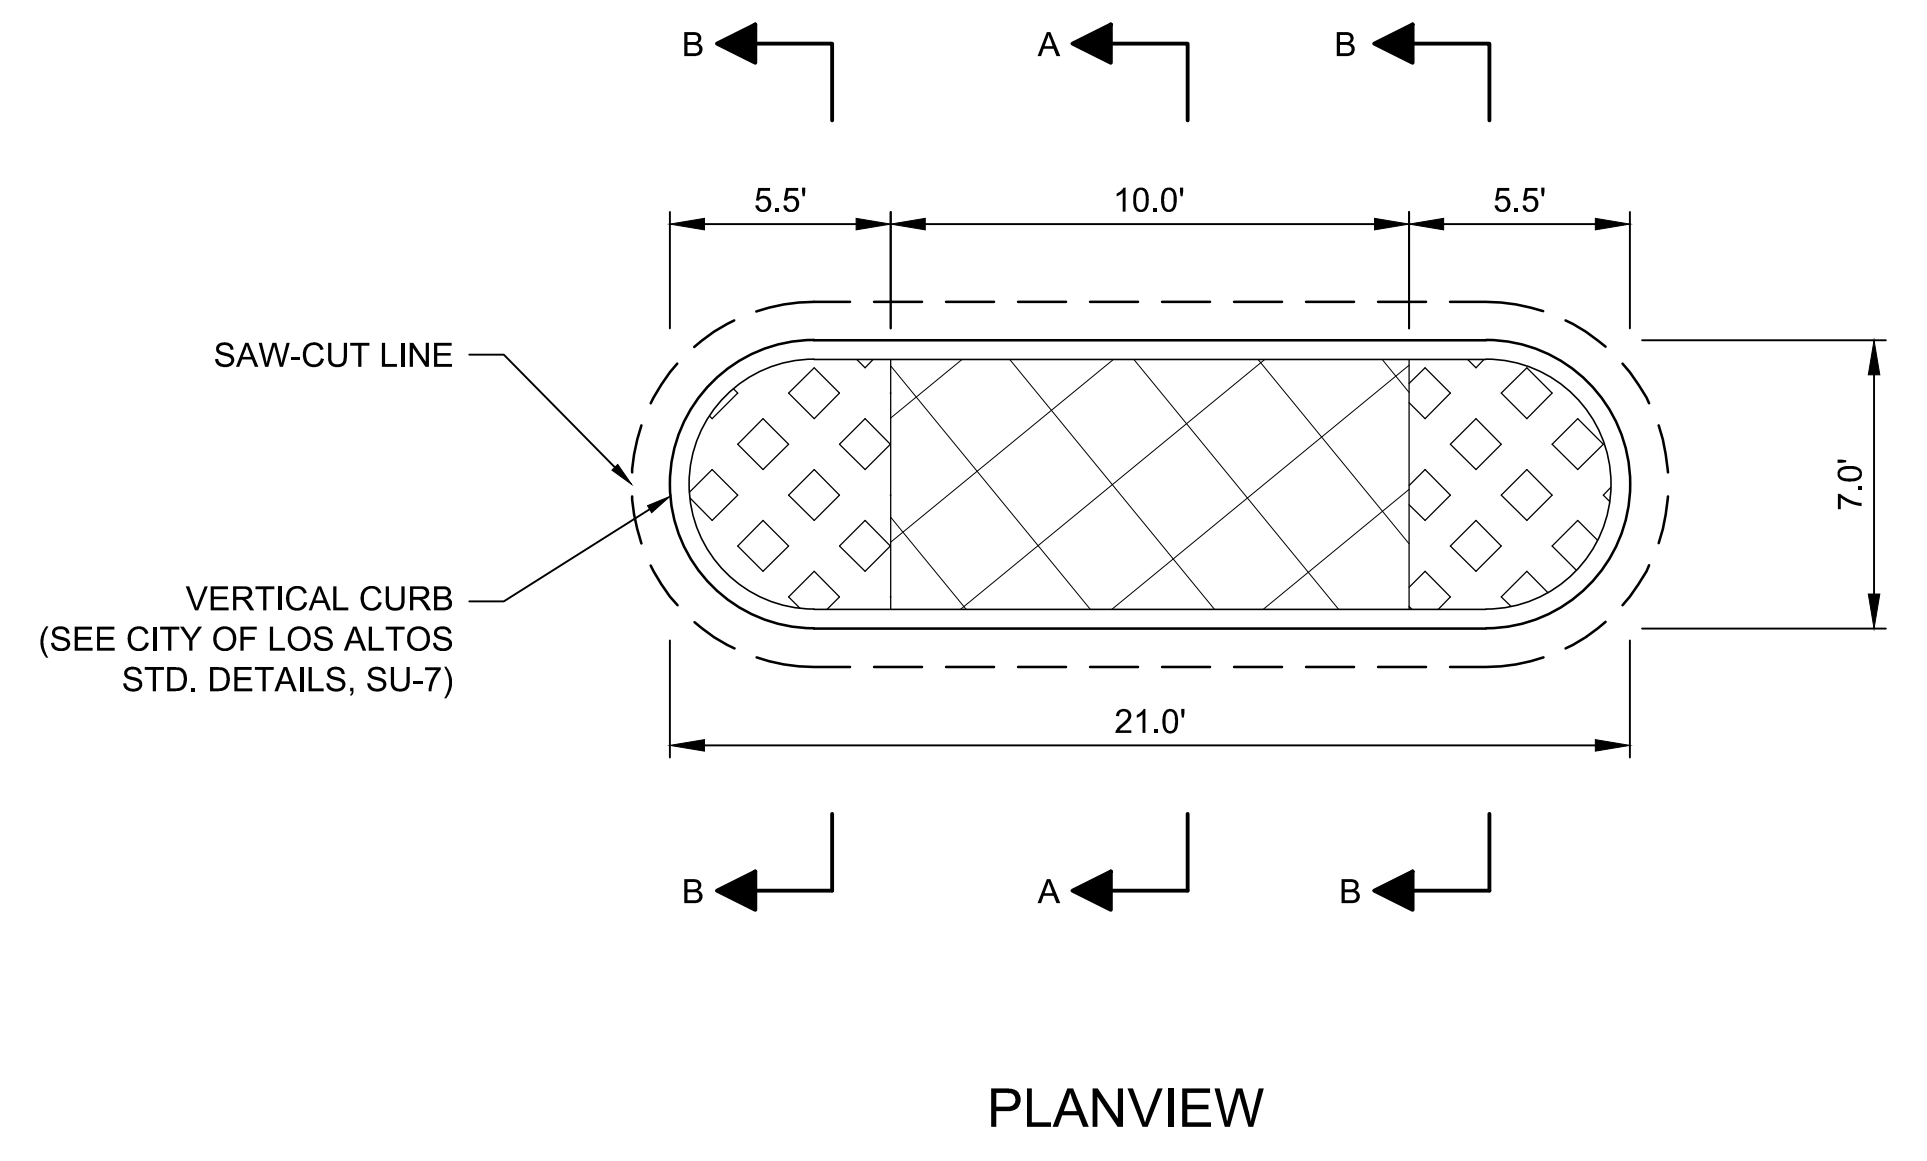


NOTES:
 • SEE SHEET DM-04 FOR DEMOLITION EXTENTS OF EXISTING MEDIAN AND PAVEMENT.
 • EXISTING SIGNAGE ON EXISTING MEDIAN TO BE RECONSTRUCTED SHALL BE REMOVED AND RETURNED TO THE CITY SALVAGE YARD.

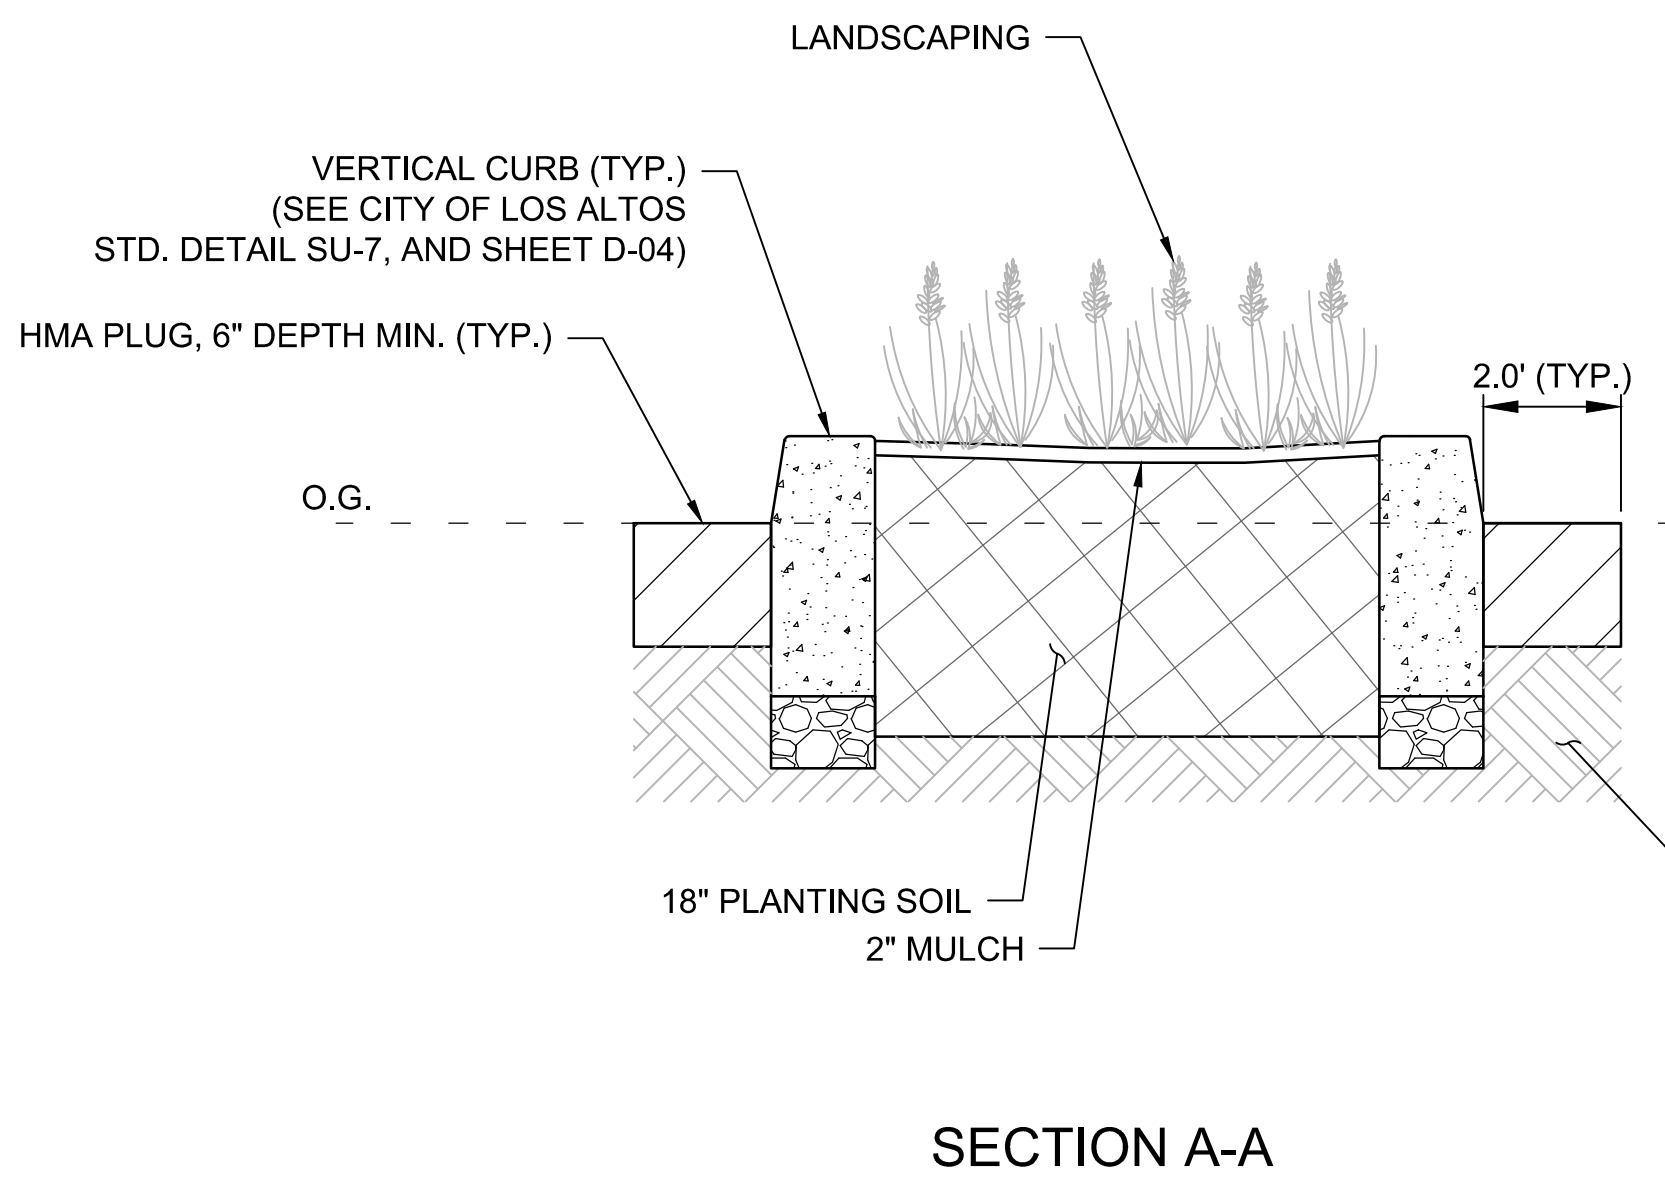4 RECONSTRUCTED MEDIAN ISLAND NTS



SECTION A-A

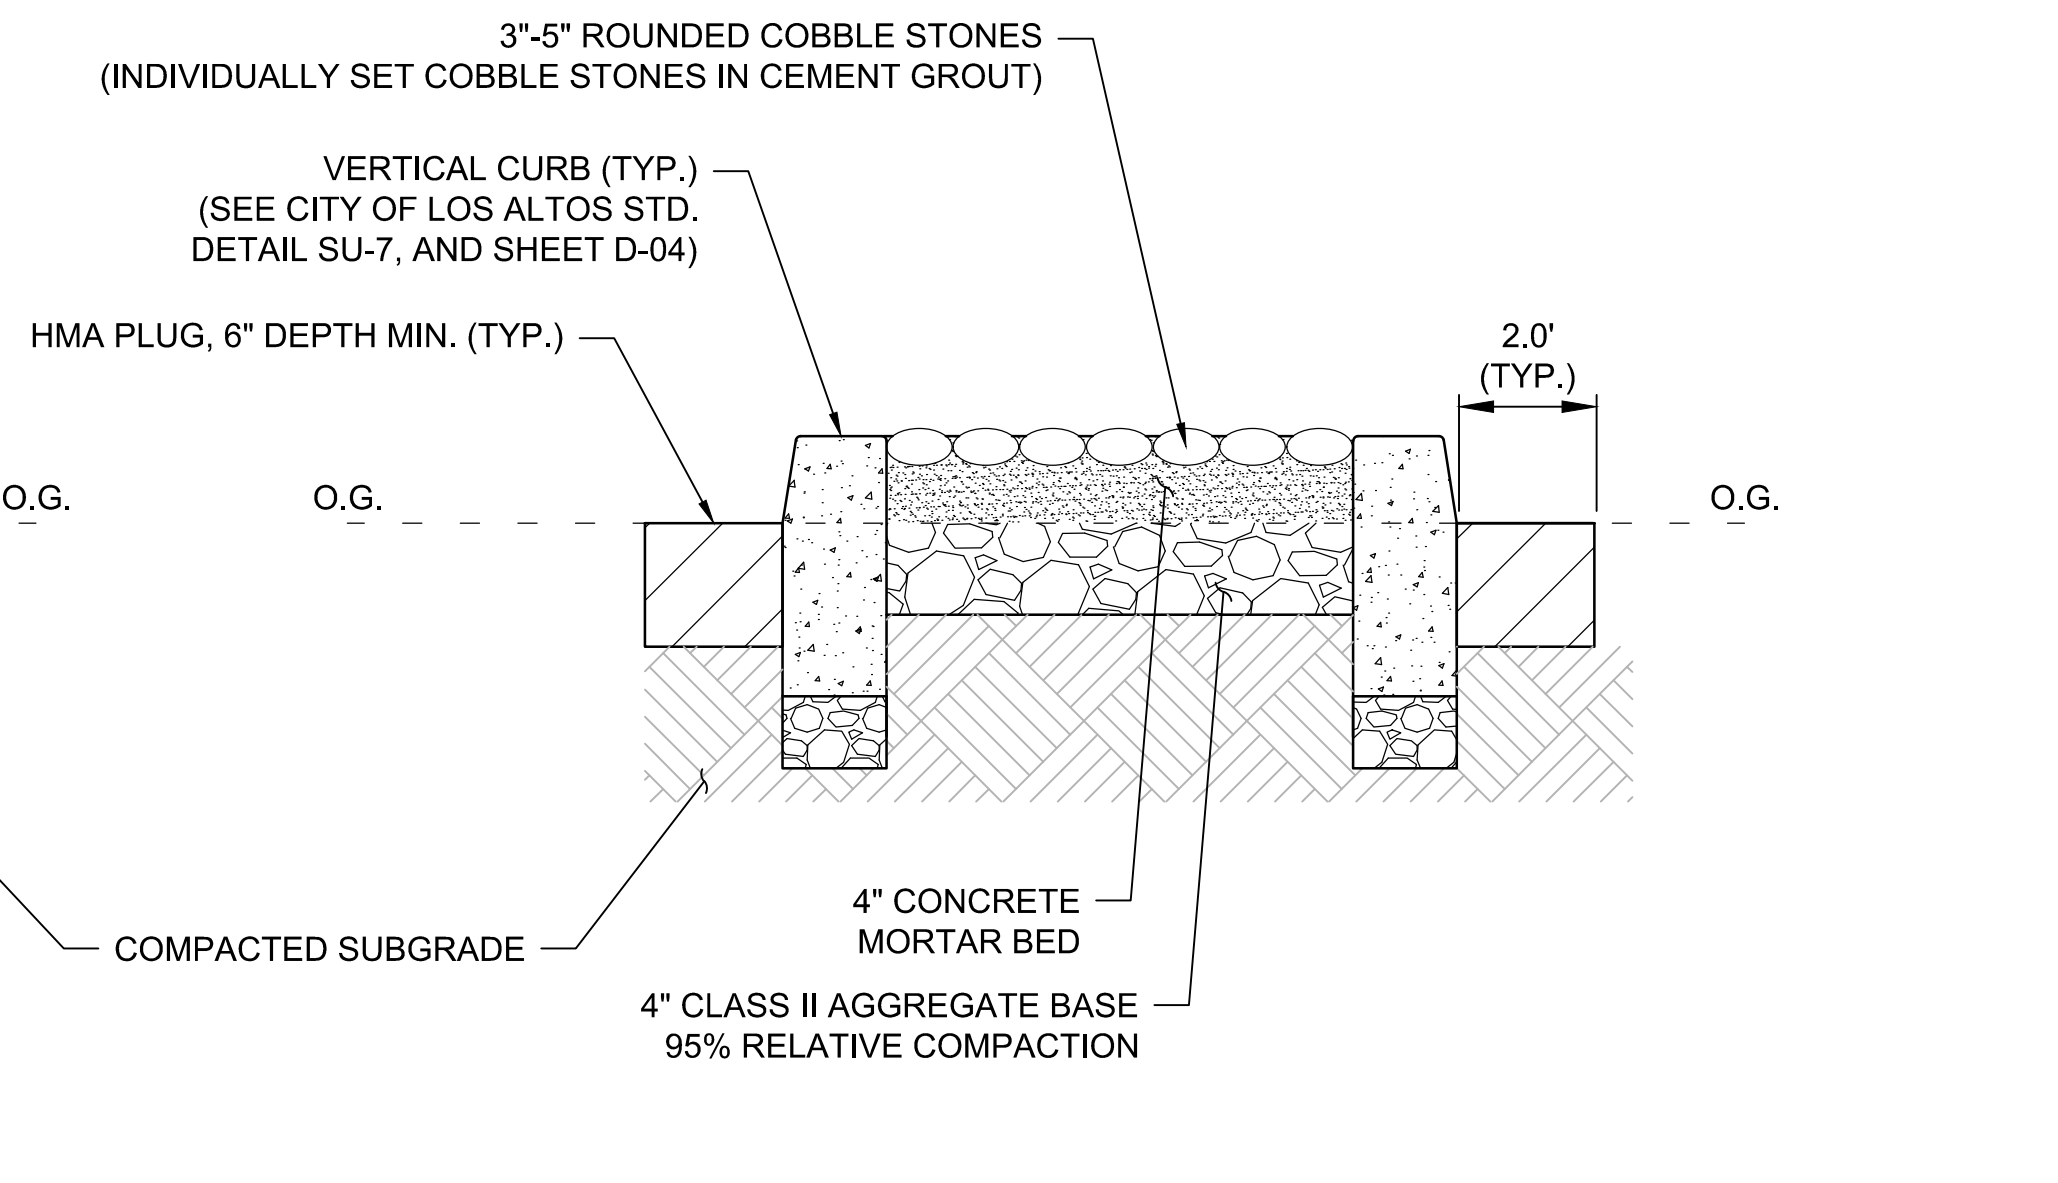

SECTION B-B

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2018-248 PROJECT NO.	8/22/19 DATE
NTS SCALE	18-248-Details FILE



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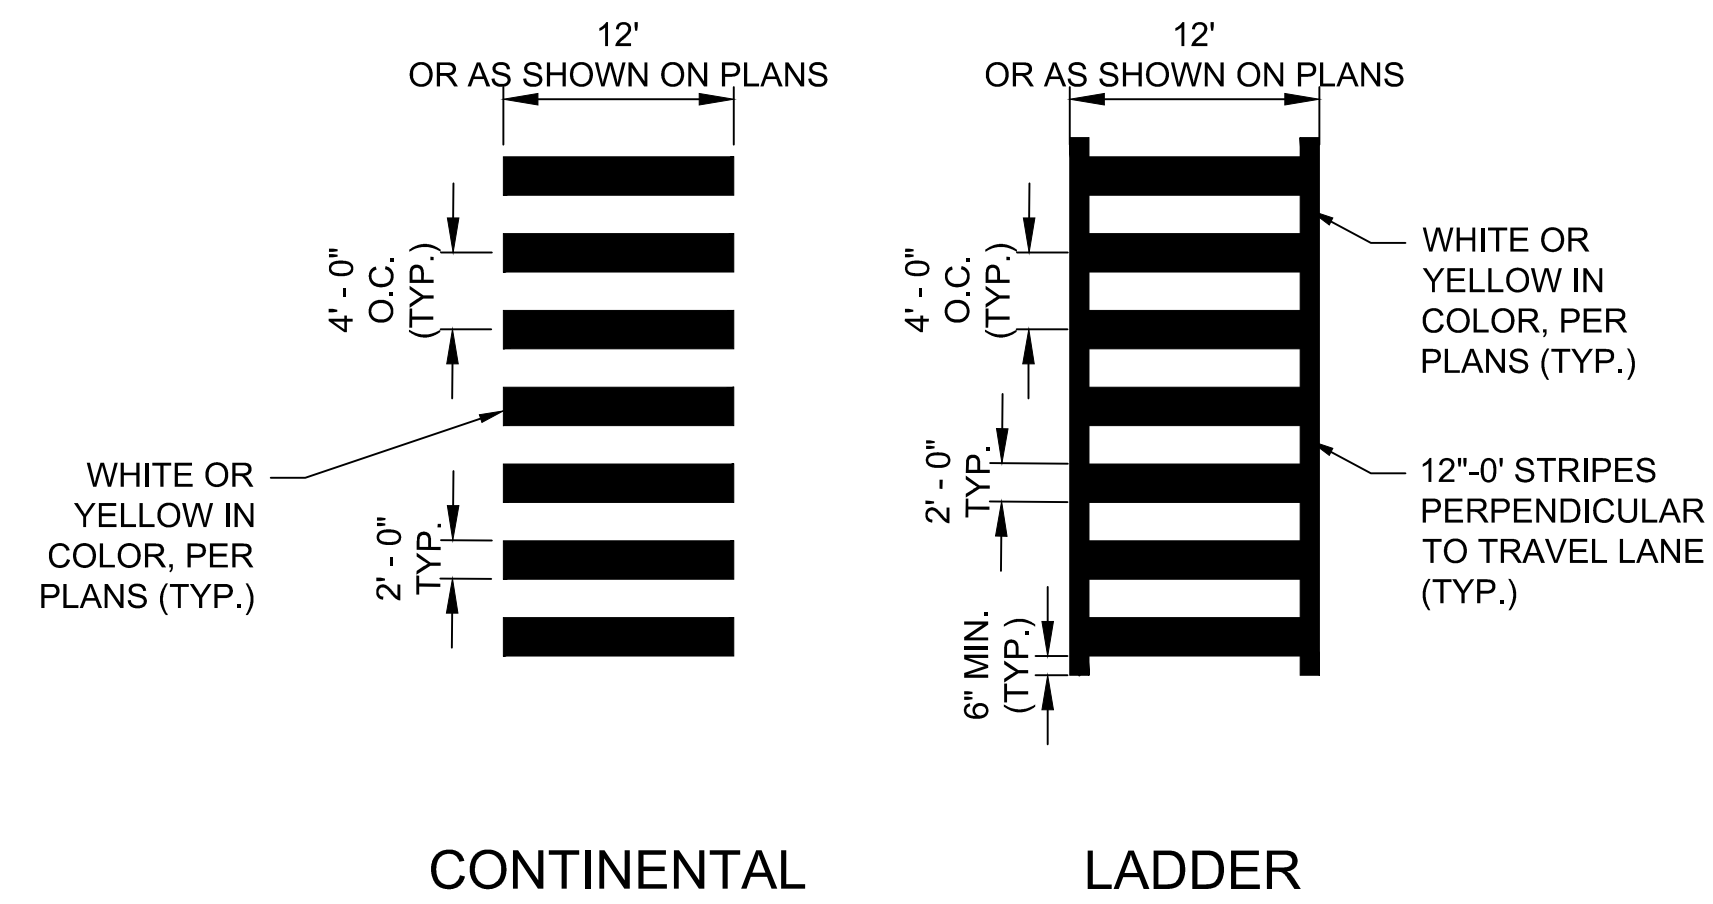


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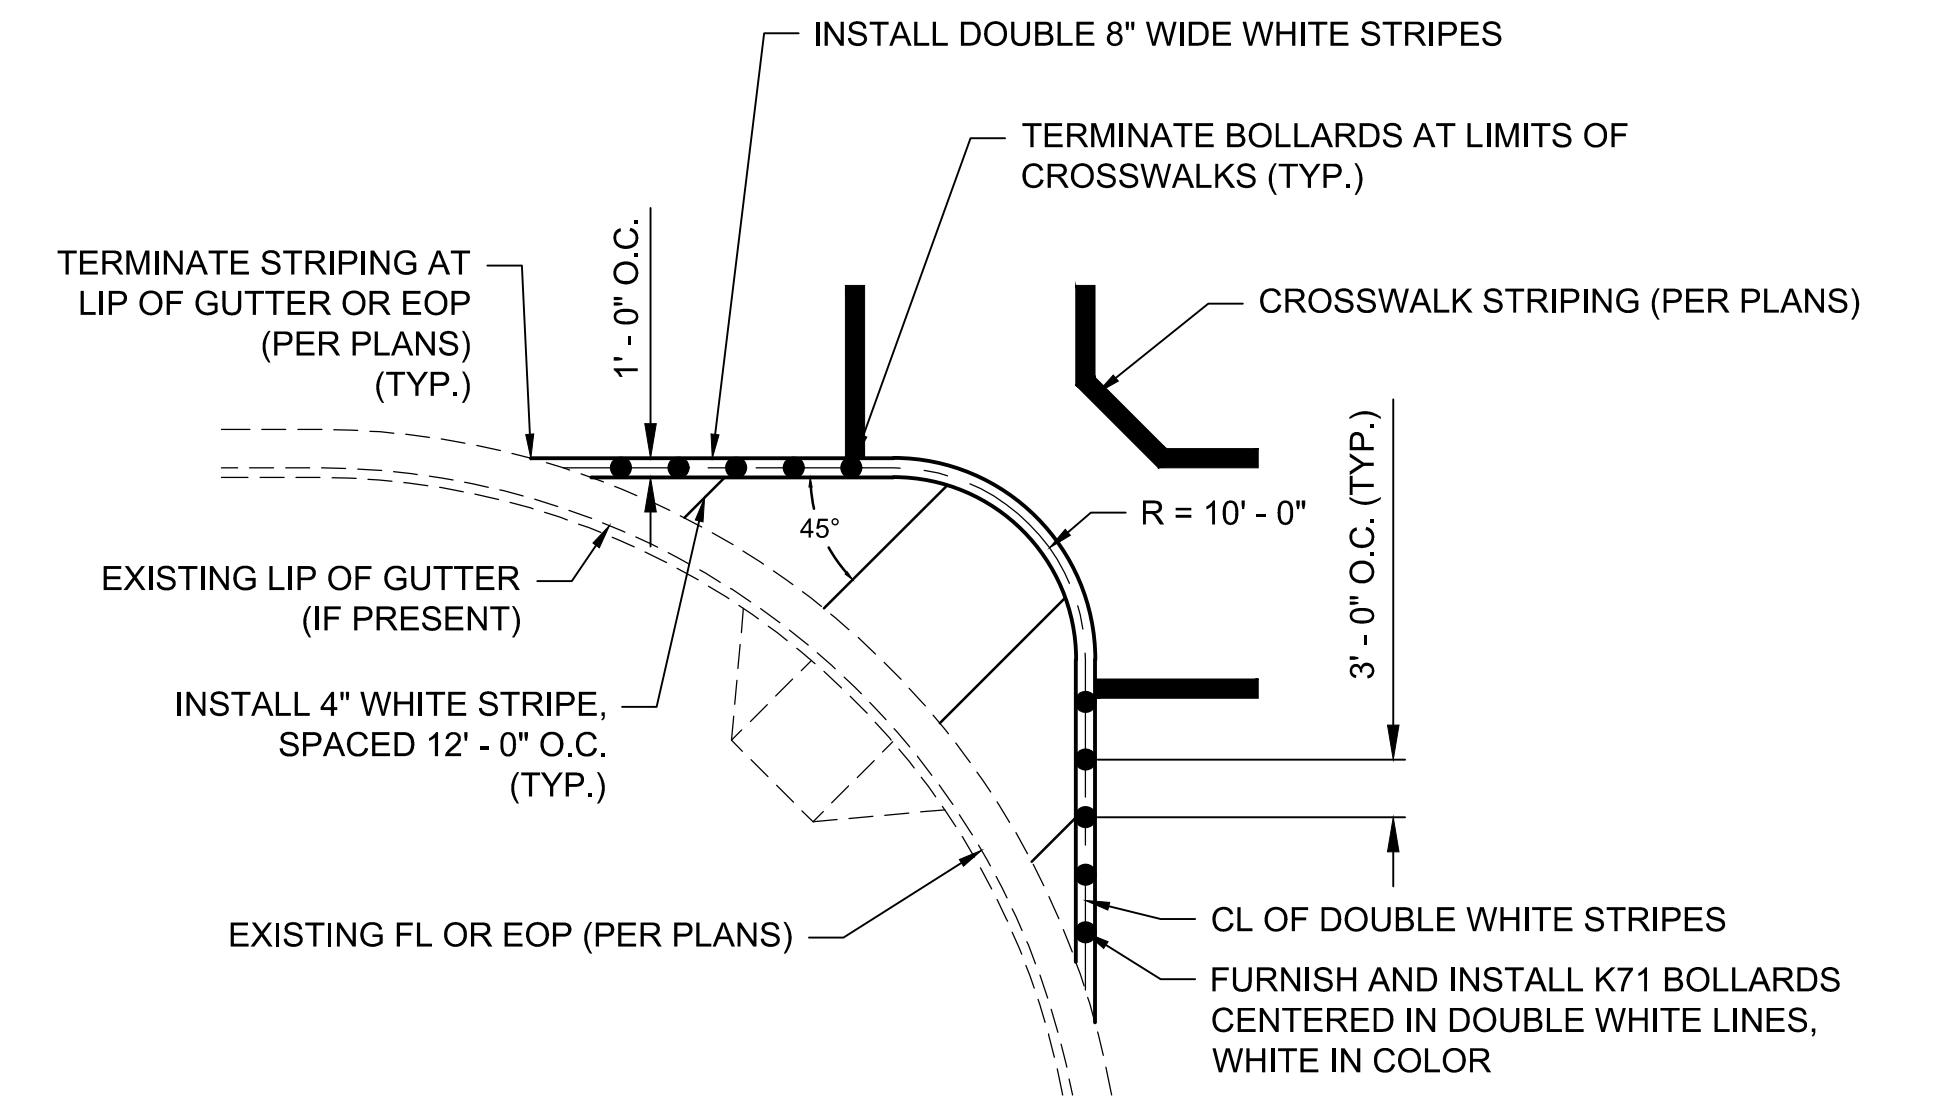
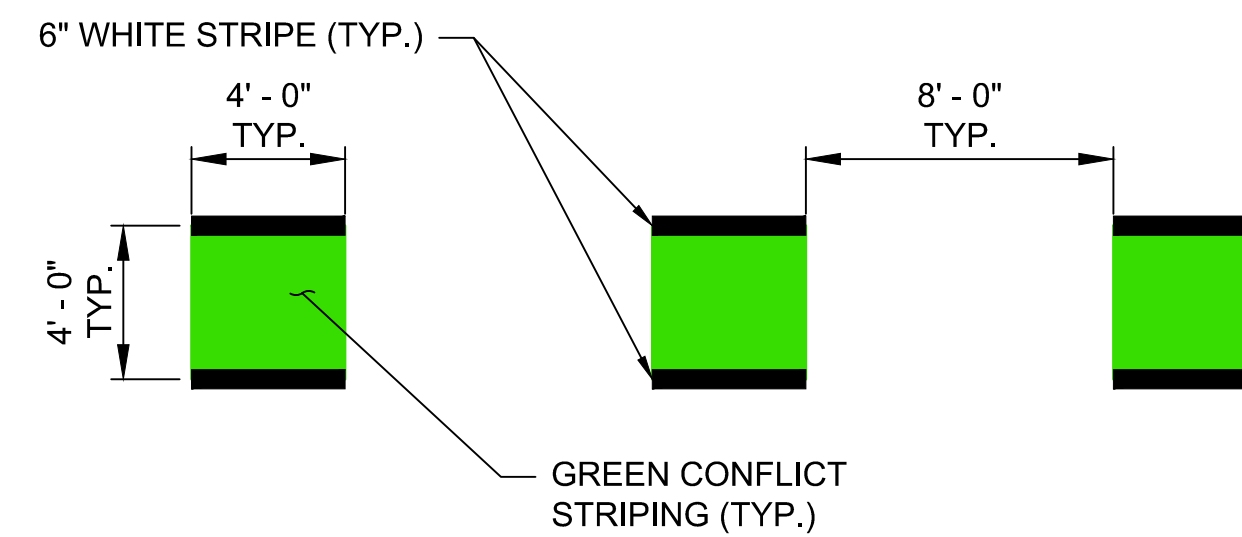
**CUESTA DRIVE
 TRAFFIC CALMING**
 Los Altos, California

CONSTRUCTION
 DETAILS

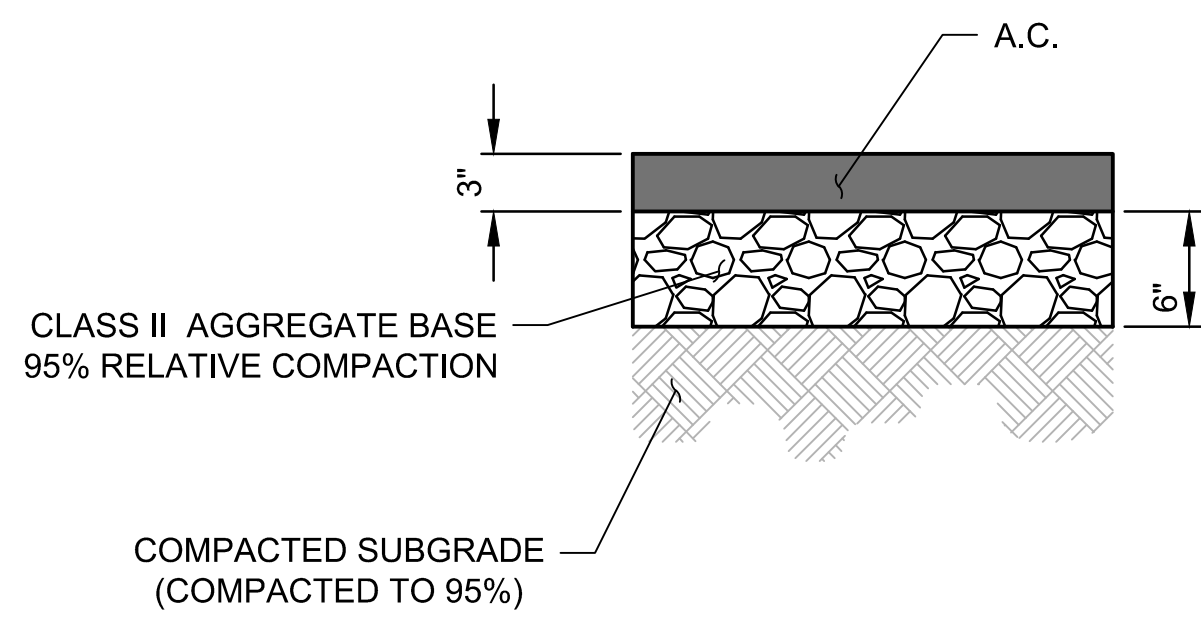
SHEET NO.
D-01
 26 OF 30




- NOTES:
- CROSSWALK STRIPING TO BE WHITE OR YELLOW IN COLOR (PER PLANS)
 - SEE CALTRANS STD PLAN A88A FOR CROSSWALK STRIPING ALIGNMENT WITH CURB RAMP
 - STRIPING SHALL CONFORM TO CALTRANS STD PLAN A88A DETAILS



1 HIGH VISIBILITY CROSSWALKS NTS 2 BICYCLE CONFLICT MARKINGS NTS 3 PROTECTED STRIPED CURB EXTENSION NTS




ASPHALT CONCRETE SECTION

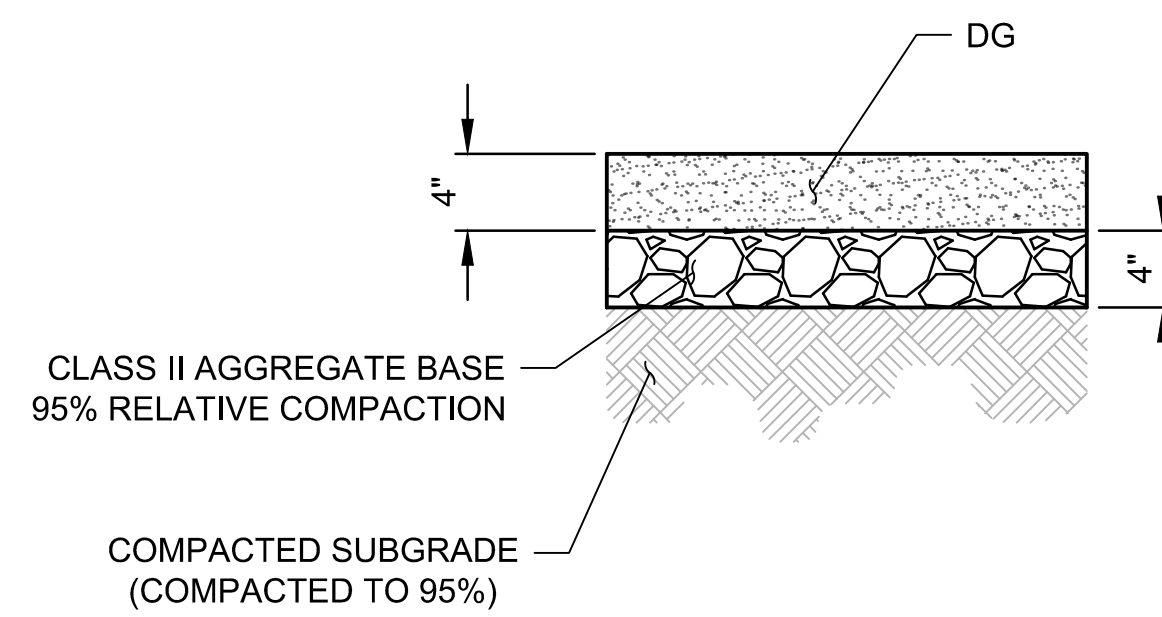

DG SECTION

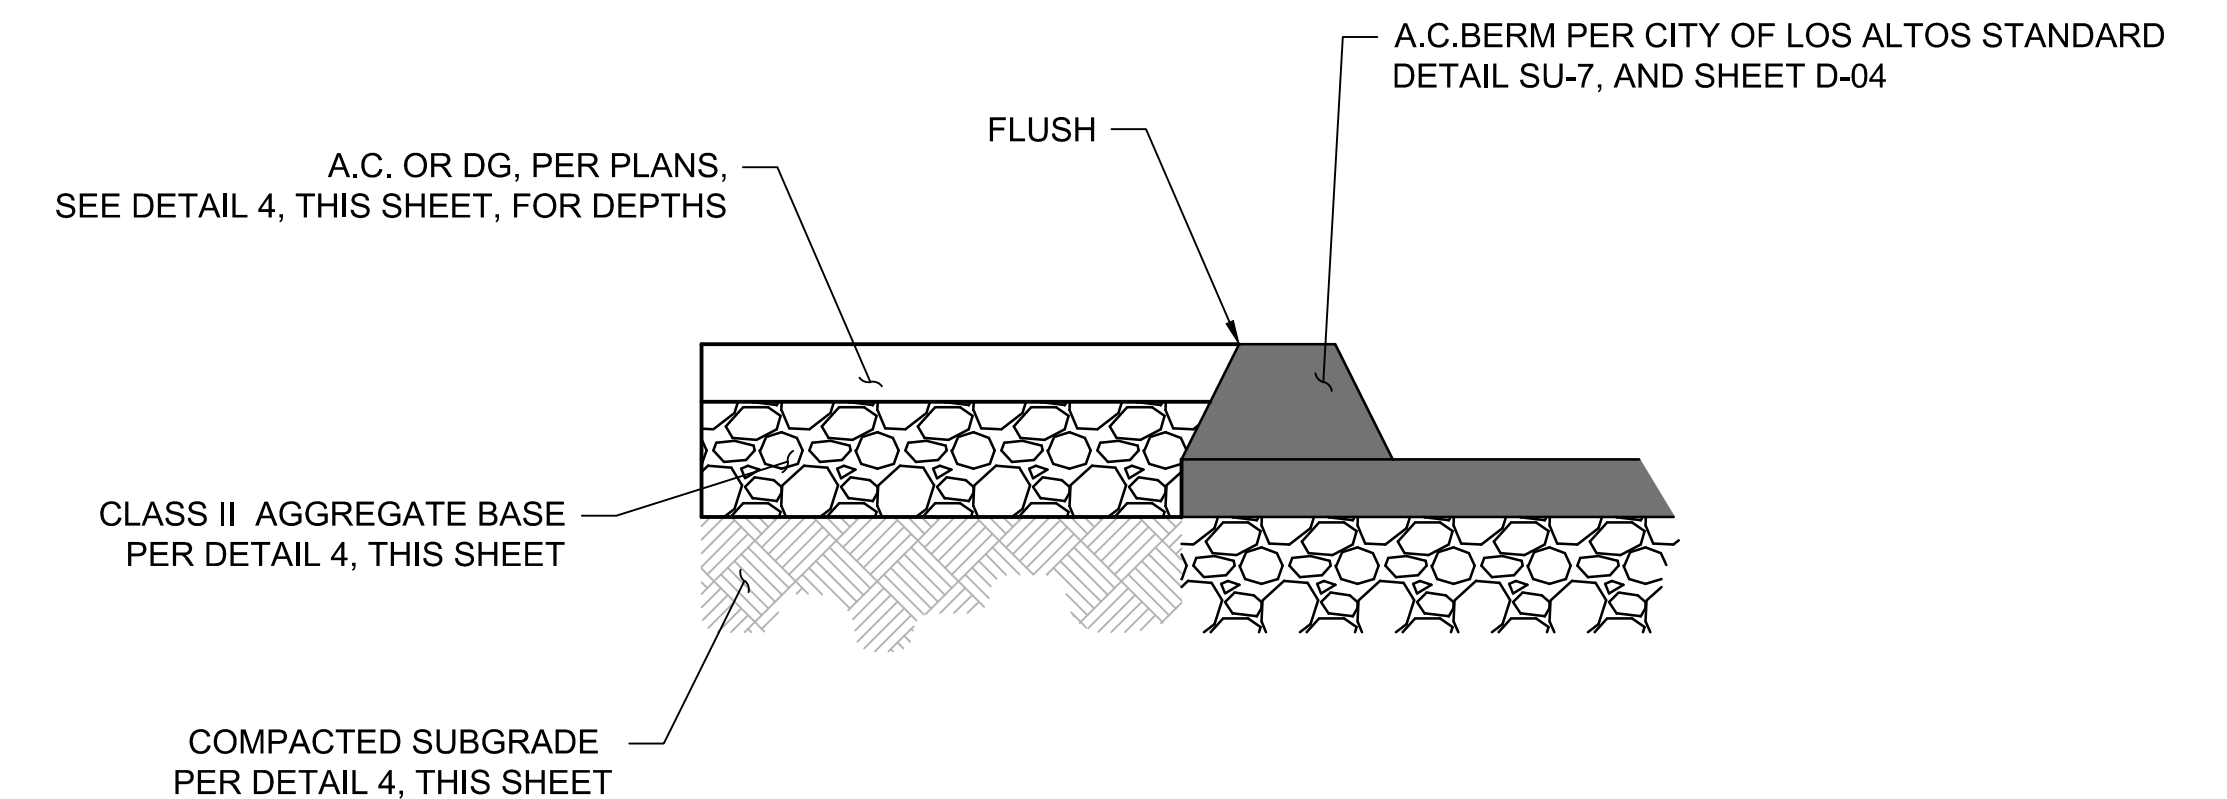- NOTE:
- FOR SECTIONS OF A.C. PEDESTRIAN PATHWAY ABUTTING A.C. BERM, SEE DETAIL 5, THIS SHEET



4 PAVEMENT SECTIONS NTS 5 PATHWAY BERM EDGE NTS

DESIGNED: CV	REVISIONS
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2018-248 8/22/19	
PROJECT NO. DATE	
NTS 18-248-Details	
SCALE FILE	



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

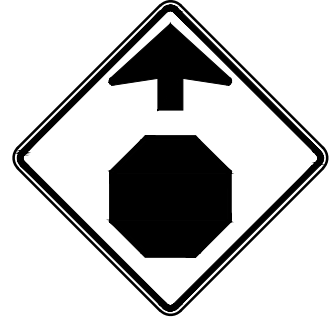

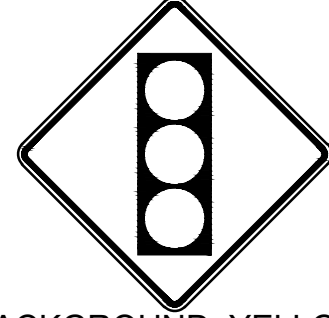



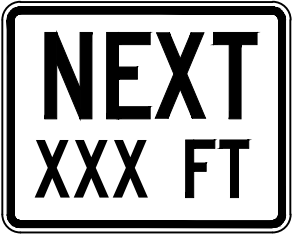


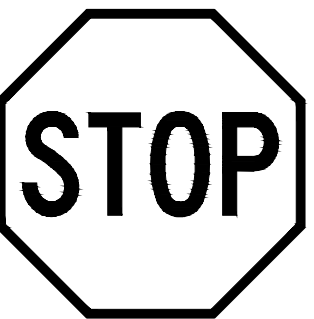

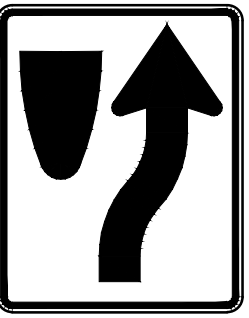
PRELIMINARY
NOT FOR CONSTRUCTION


**CUESTA DRIVE
TRAFFIC CALMING**
Los Altos, California

CONSTRUCTION
DETAILS

SHEET NO.
D-02
27 OF 30

WARNING SIGN SCHEDULE					
KEY	SIZE	SIGN & COLOR			
S1-1	30" X 30"	 BACKGROUND: YELLOW BORDER: BLACK LEGEND: BLACK	W16-7P	24" X 12"	 BACKGROUND: YELLOW BORDER: BLACK LEGEND: BLACK
W3-1	30" X 30"	 BACKGROUND: YELLOW BORDER: BLACK LEGEND: RED & BLACK	W16-9P	24" X 12"	 BACKGROUND: YELLOW BORDER: BLACK LETTERING: BLACK
W3-3	30" X 30"	 BACKGROUND: YELLOW BORDER: BLACK LEGEND: RED, YELLOW, GREEN & BLACK	W16-15P	24" X 12"	 BACKGROUND: YELLOW BORDER: BLACK LETTERING: BLACK
W13-1P	18" X 18"	 BACKGROUND: YELLOW BORDER: BLACK LETTERING: BLACK	W17-1	30" X 30"	 BACKGROUND: YELLOW BORDER: BLACK LETTERING: BLACK
W16-7P	24" X 12"	 BACKGROUND: YELLOW BORDER: BLACK LETTERING: BLACK			

REGULATORY SIGN SCHEDULE		
KEY	SIZE	SIGN & COLOR
R1-1	30" X 30"	 BACKGROUND: RED BORDER: WHITE LETTERING: WHITE
R1-3P	36" X 24"	 BACKGROUND: RED BORDER: WHITE LETTERING: WHITE
R4-7	24" X 36"	 BACKGROUND: WHITE BORDER: BLACK LEGEND: BLACK

GUIDE SIGN SCHEDULE		
KEY	SIZE	SIGN & COLOR
D11-1	24" X 18"	 BACKGROUND: GREEN LETTERING: WHITE BORDER/LEGEND: WHITE


NOTES:

- SIGN AND POST INSTALLATION TO CONFORM TO CITY OF LOS ALTOS STANDARD DETAILS SU-15, SU-16, AND SU-17, SEE SHEET D-05.
- STREET SIGN FACES TO CONFORM TO CITY OF LOS ALTOS STANDARD DETAILS SU-15, SEE SHEET D-05.

DESIGNED: CV	REVISIONS
REVIEWED: SF	NO DATE ITEM
DRAWN: JP	
2018-248 8/22/19	
PROJECT NO. DATE	
NTS 18-248-Details	
SCALE FILE	


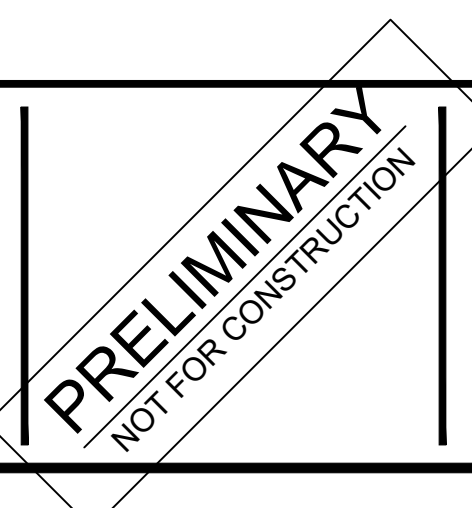
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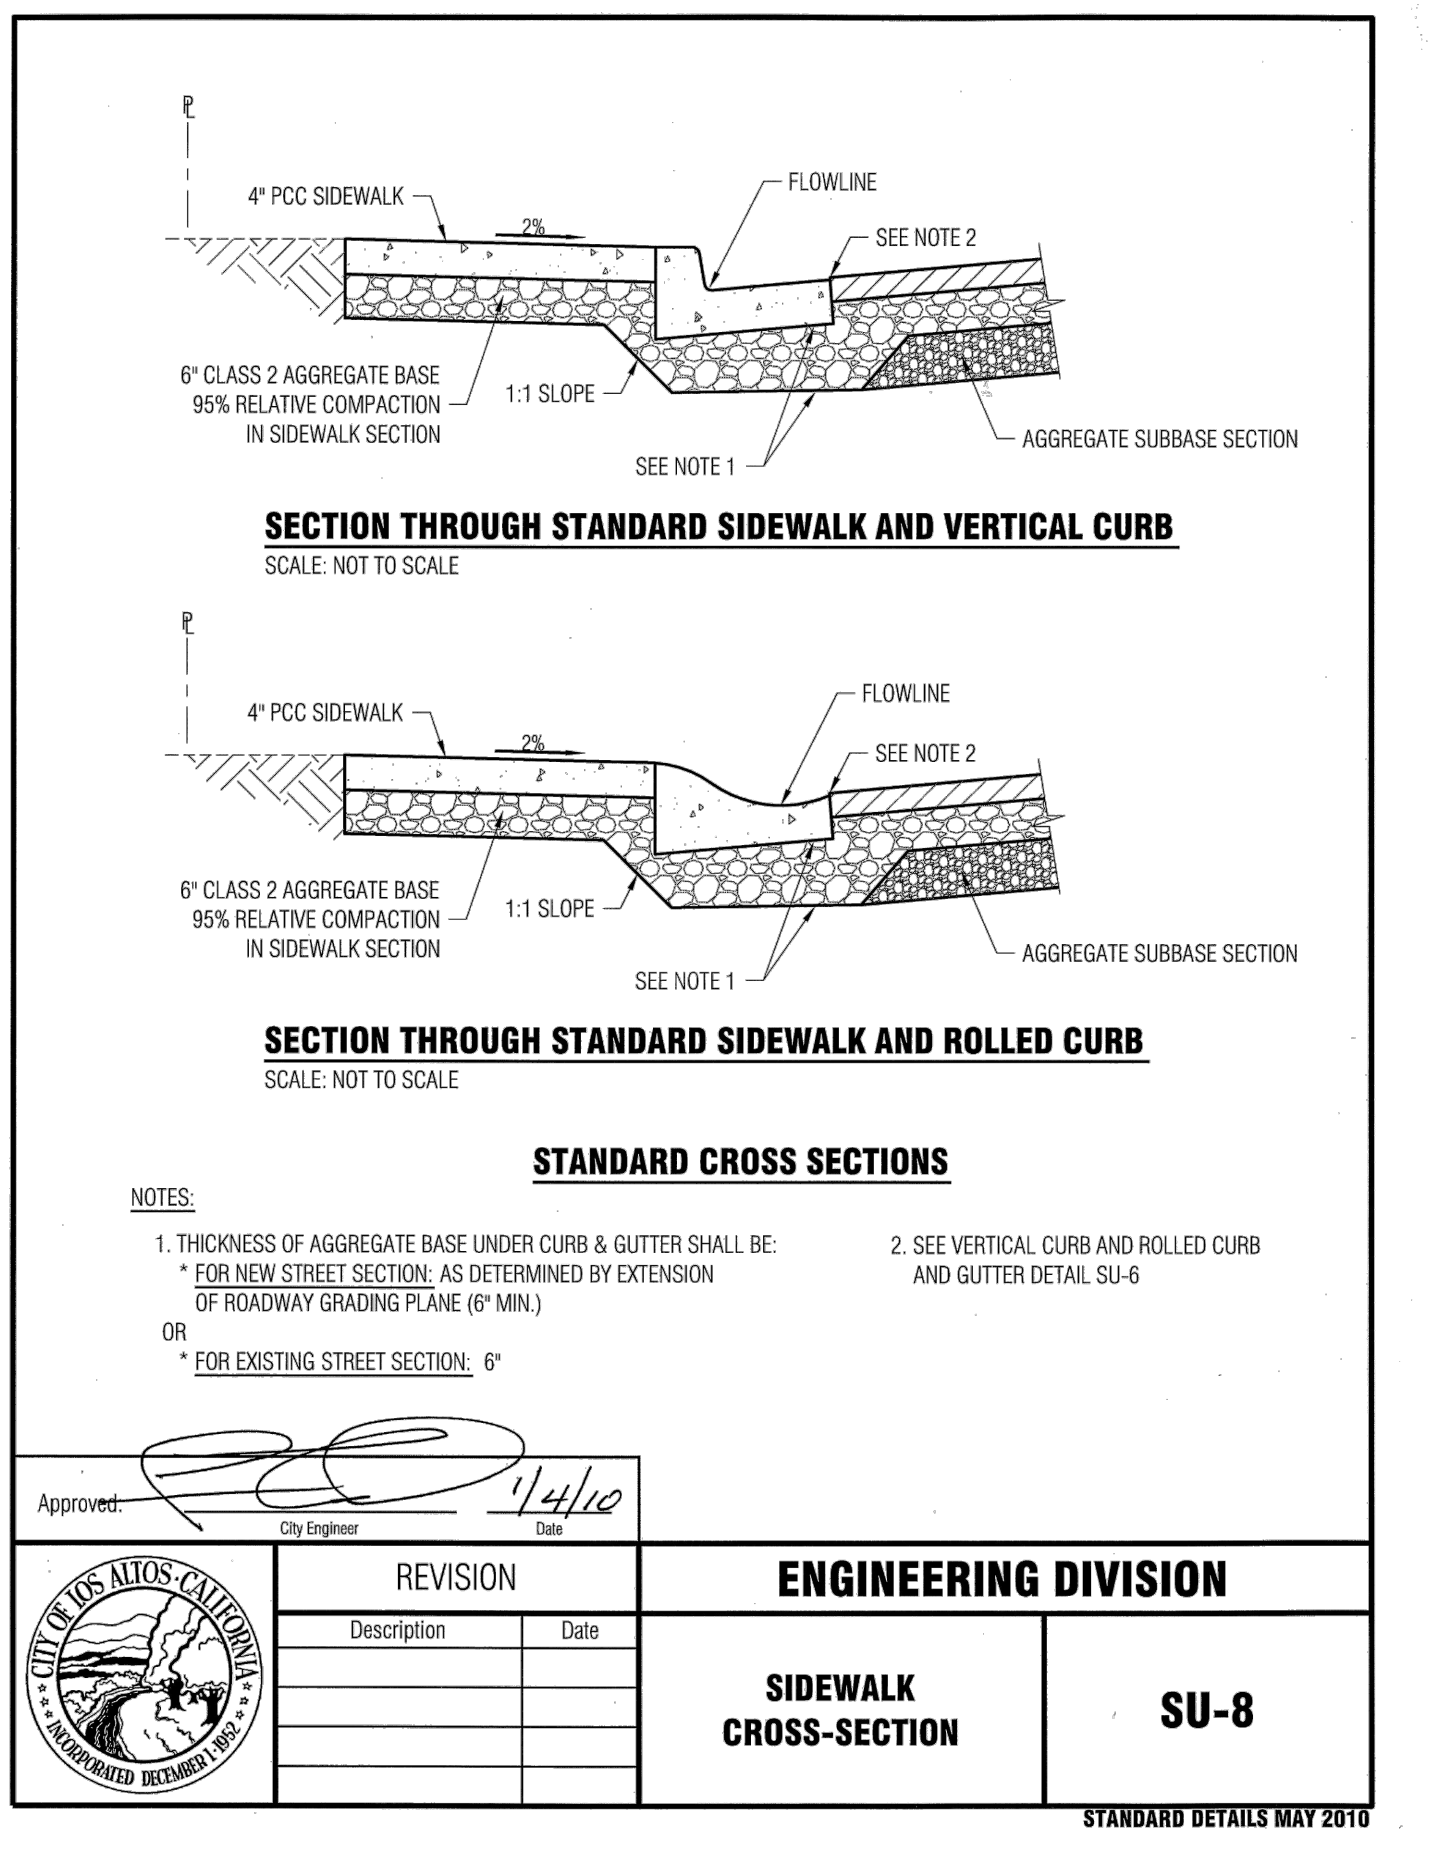
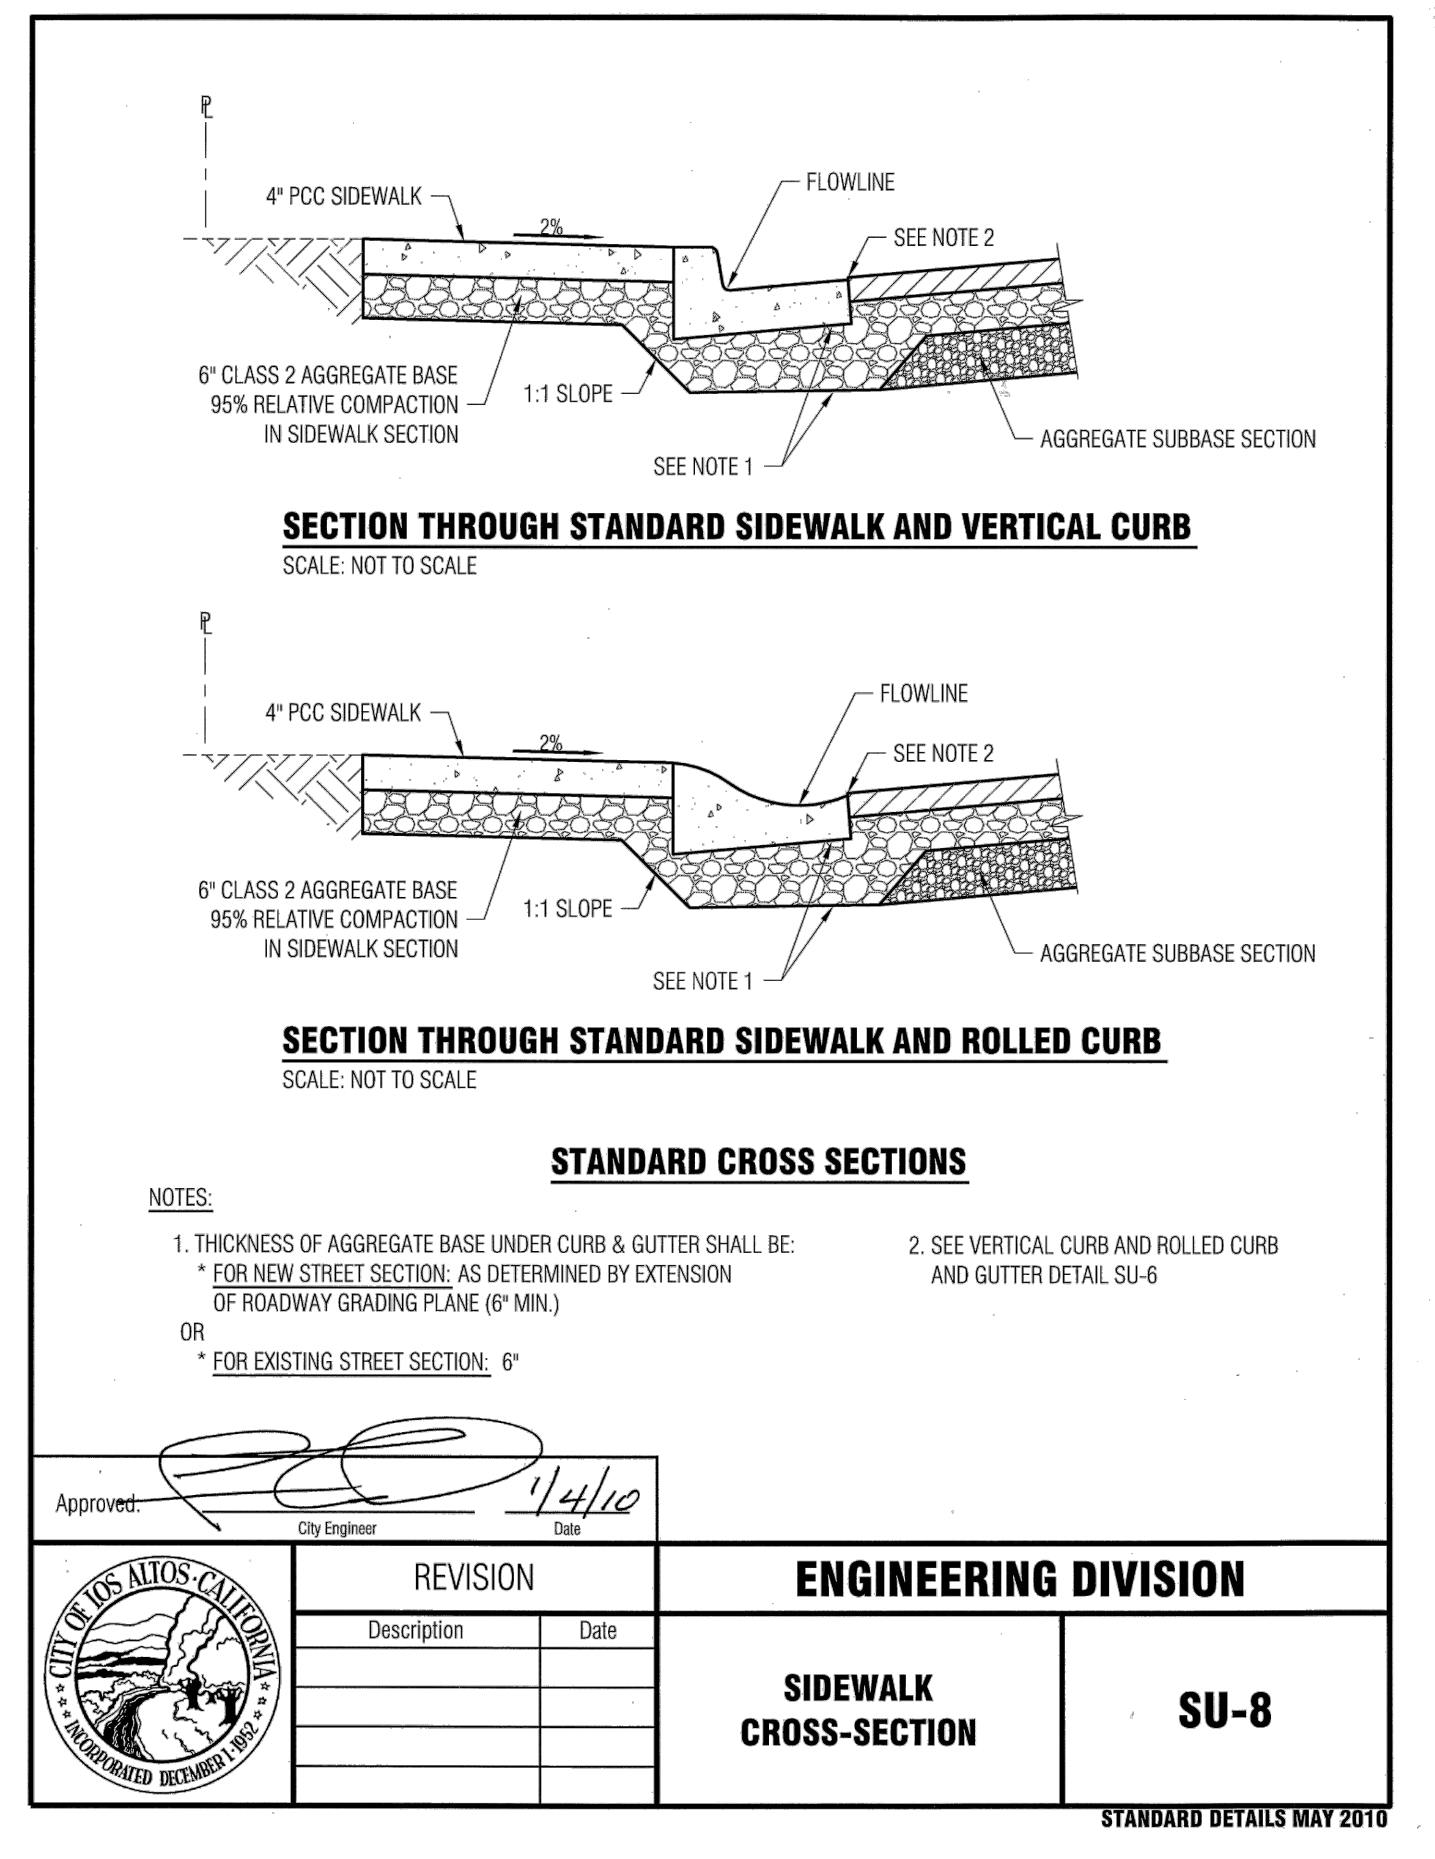
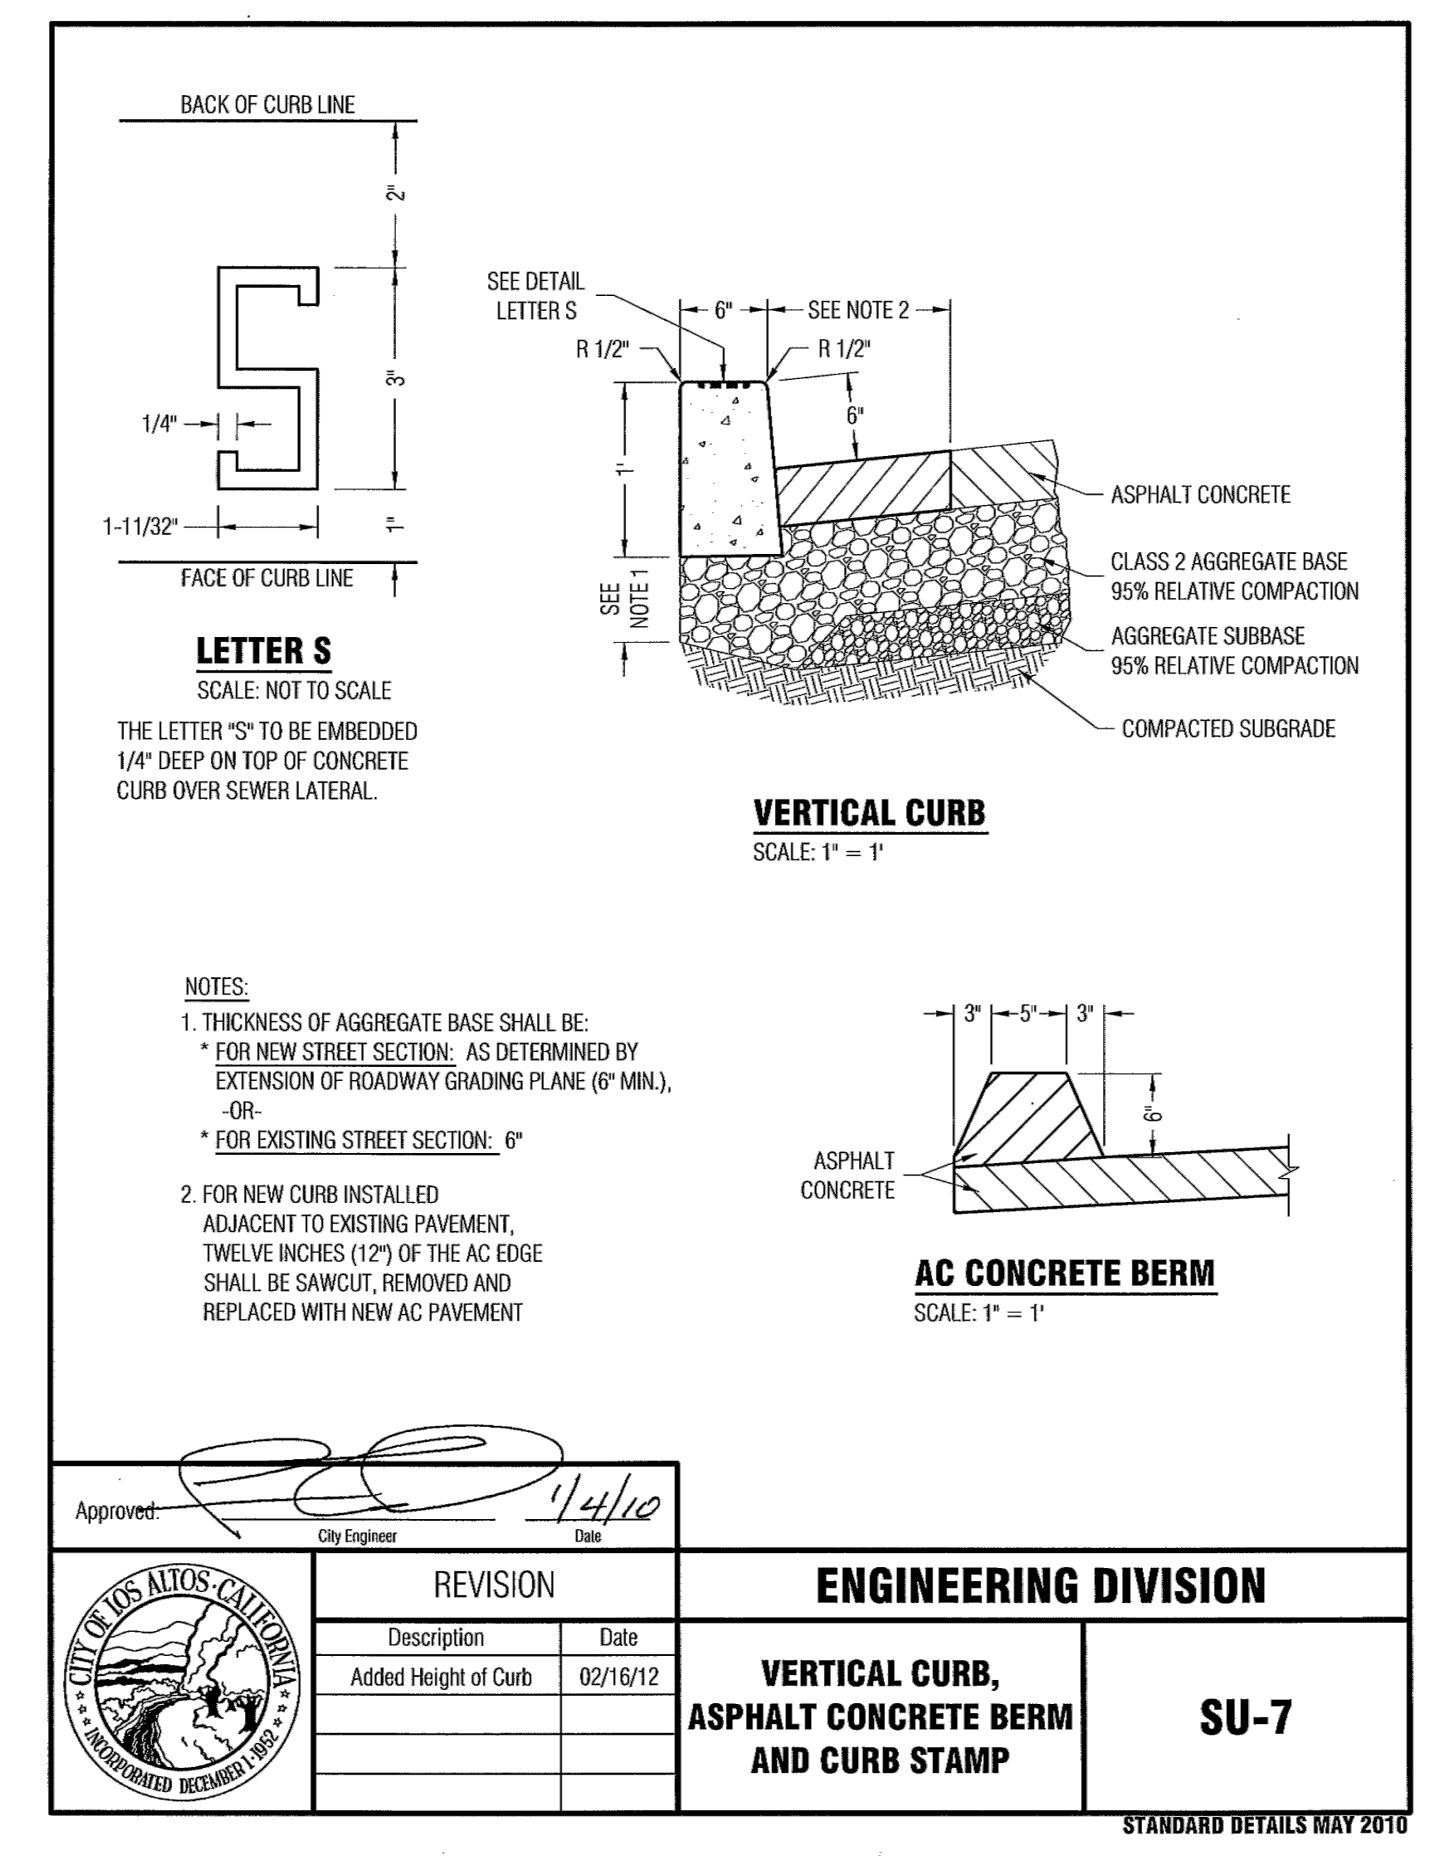
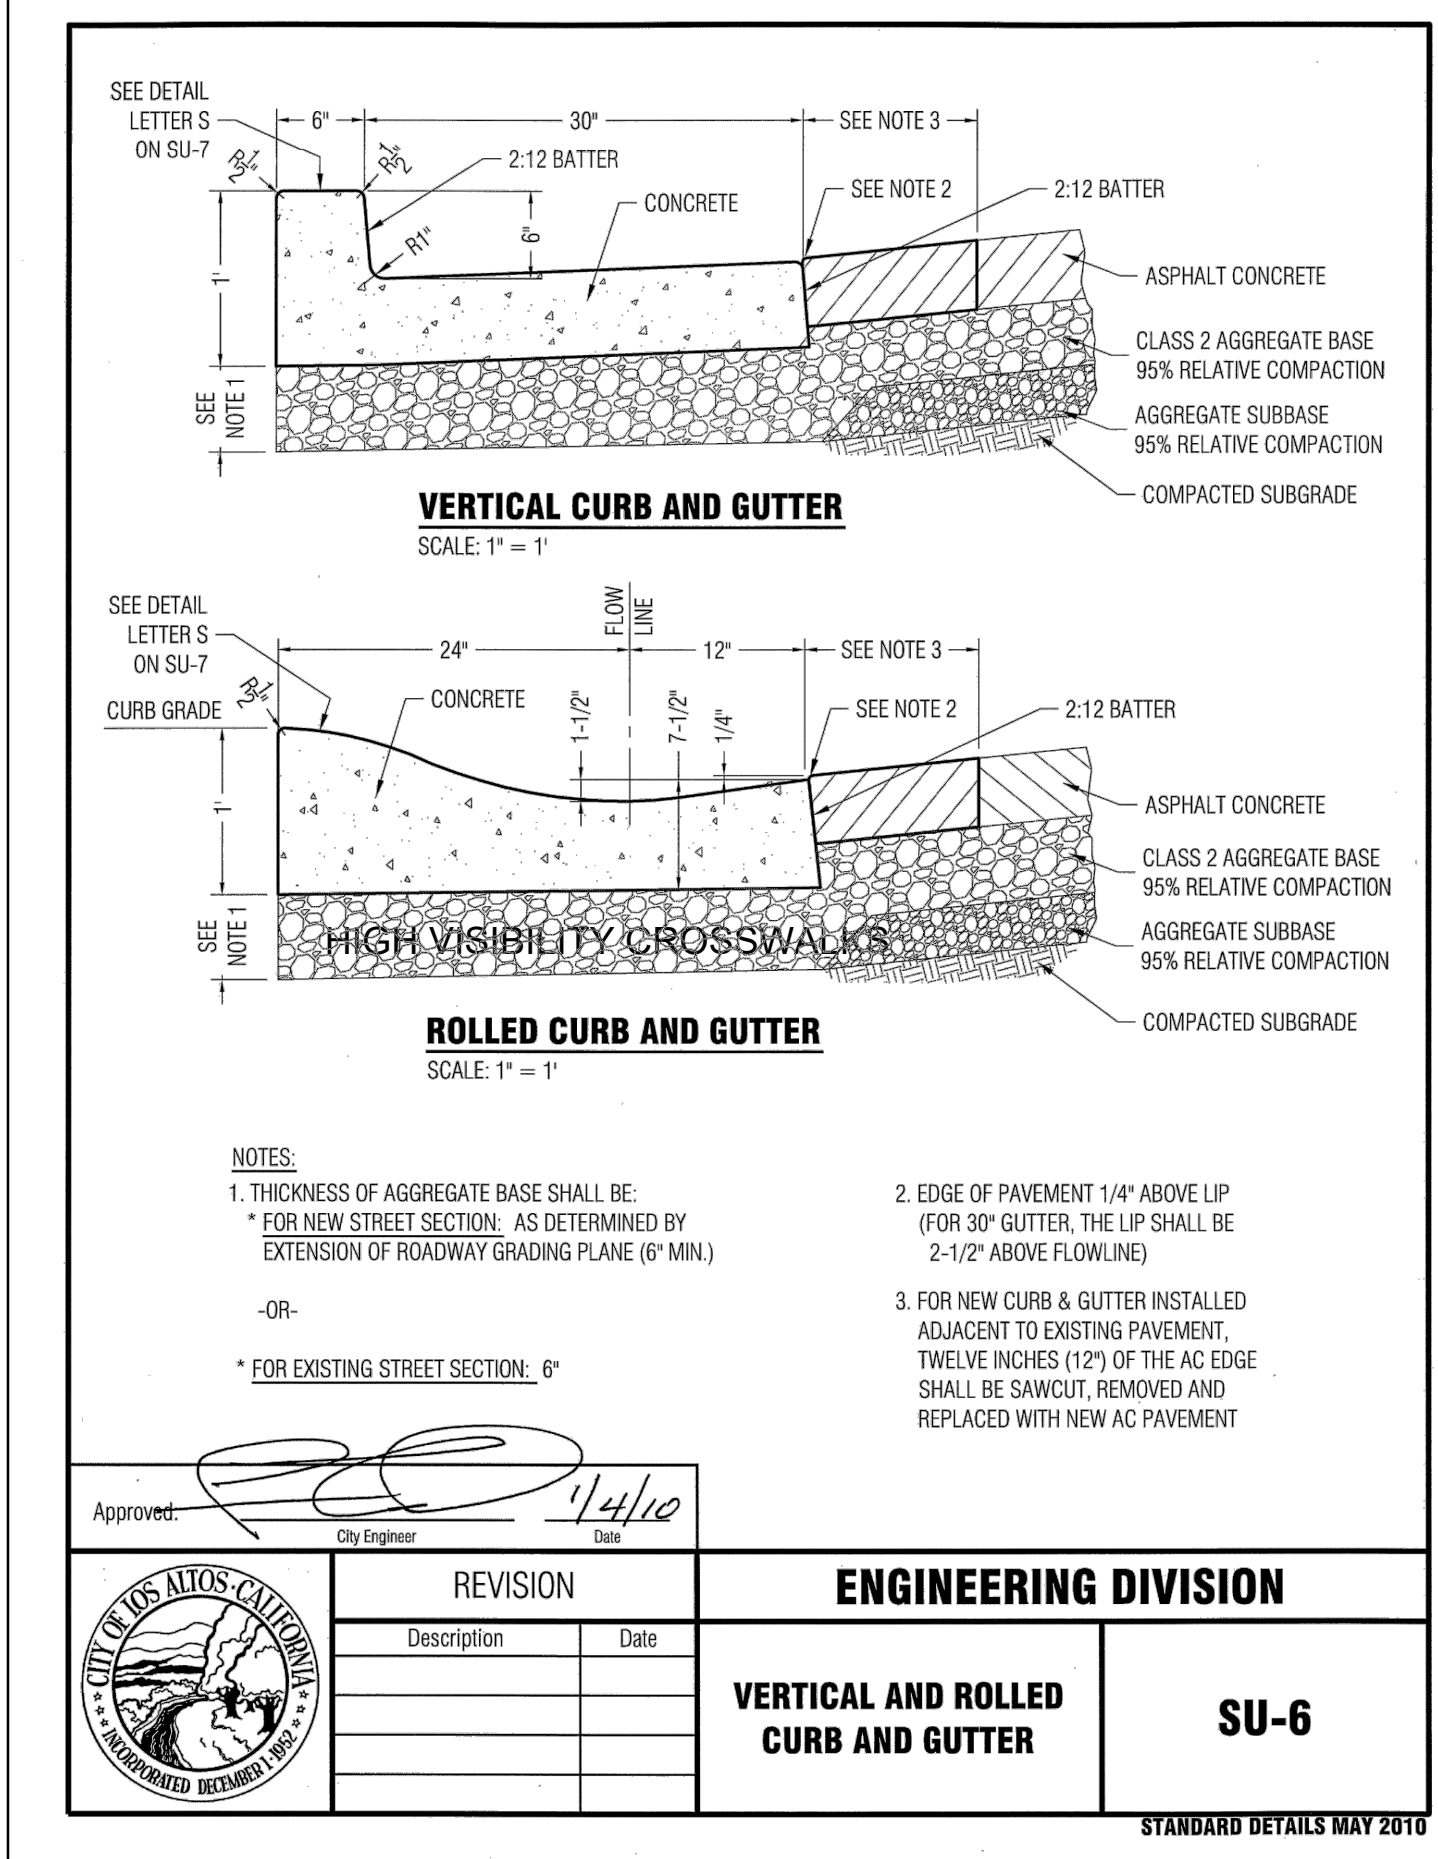


**CUESTA DRIVE
TRAFFIC CALMING**
Los Altos, California

CONSTRUCTION
DETAILS

SHEET NO.

D-03
28 OF **30**



1


RELEVANT CITY STANDARD CONSTRUCTION DETAILS FOR PROJECT WORK (SU-6, SU-7, SU-8, SU-11)

NTS

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REVIEWED: SF	NO DATE ITEM
DRAWN: JP	
2018-248 8/22/19	
PROJECT NO. DATE	
NTS 18-248-Details	
SCALE FILE	






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1 RELEVANT CITY STANDARD SIGNING DETAILS (SU15, SU-16, SU17) NTS
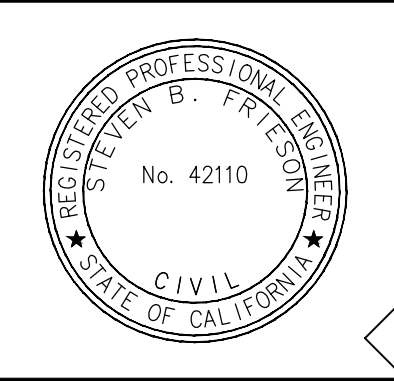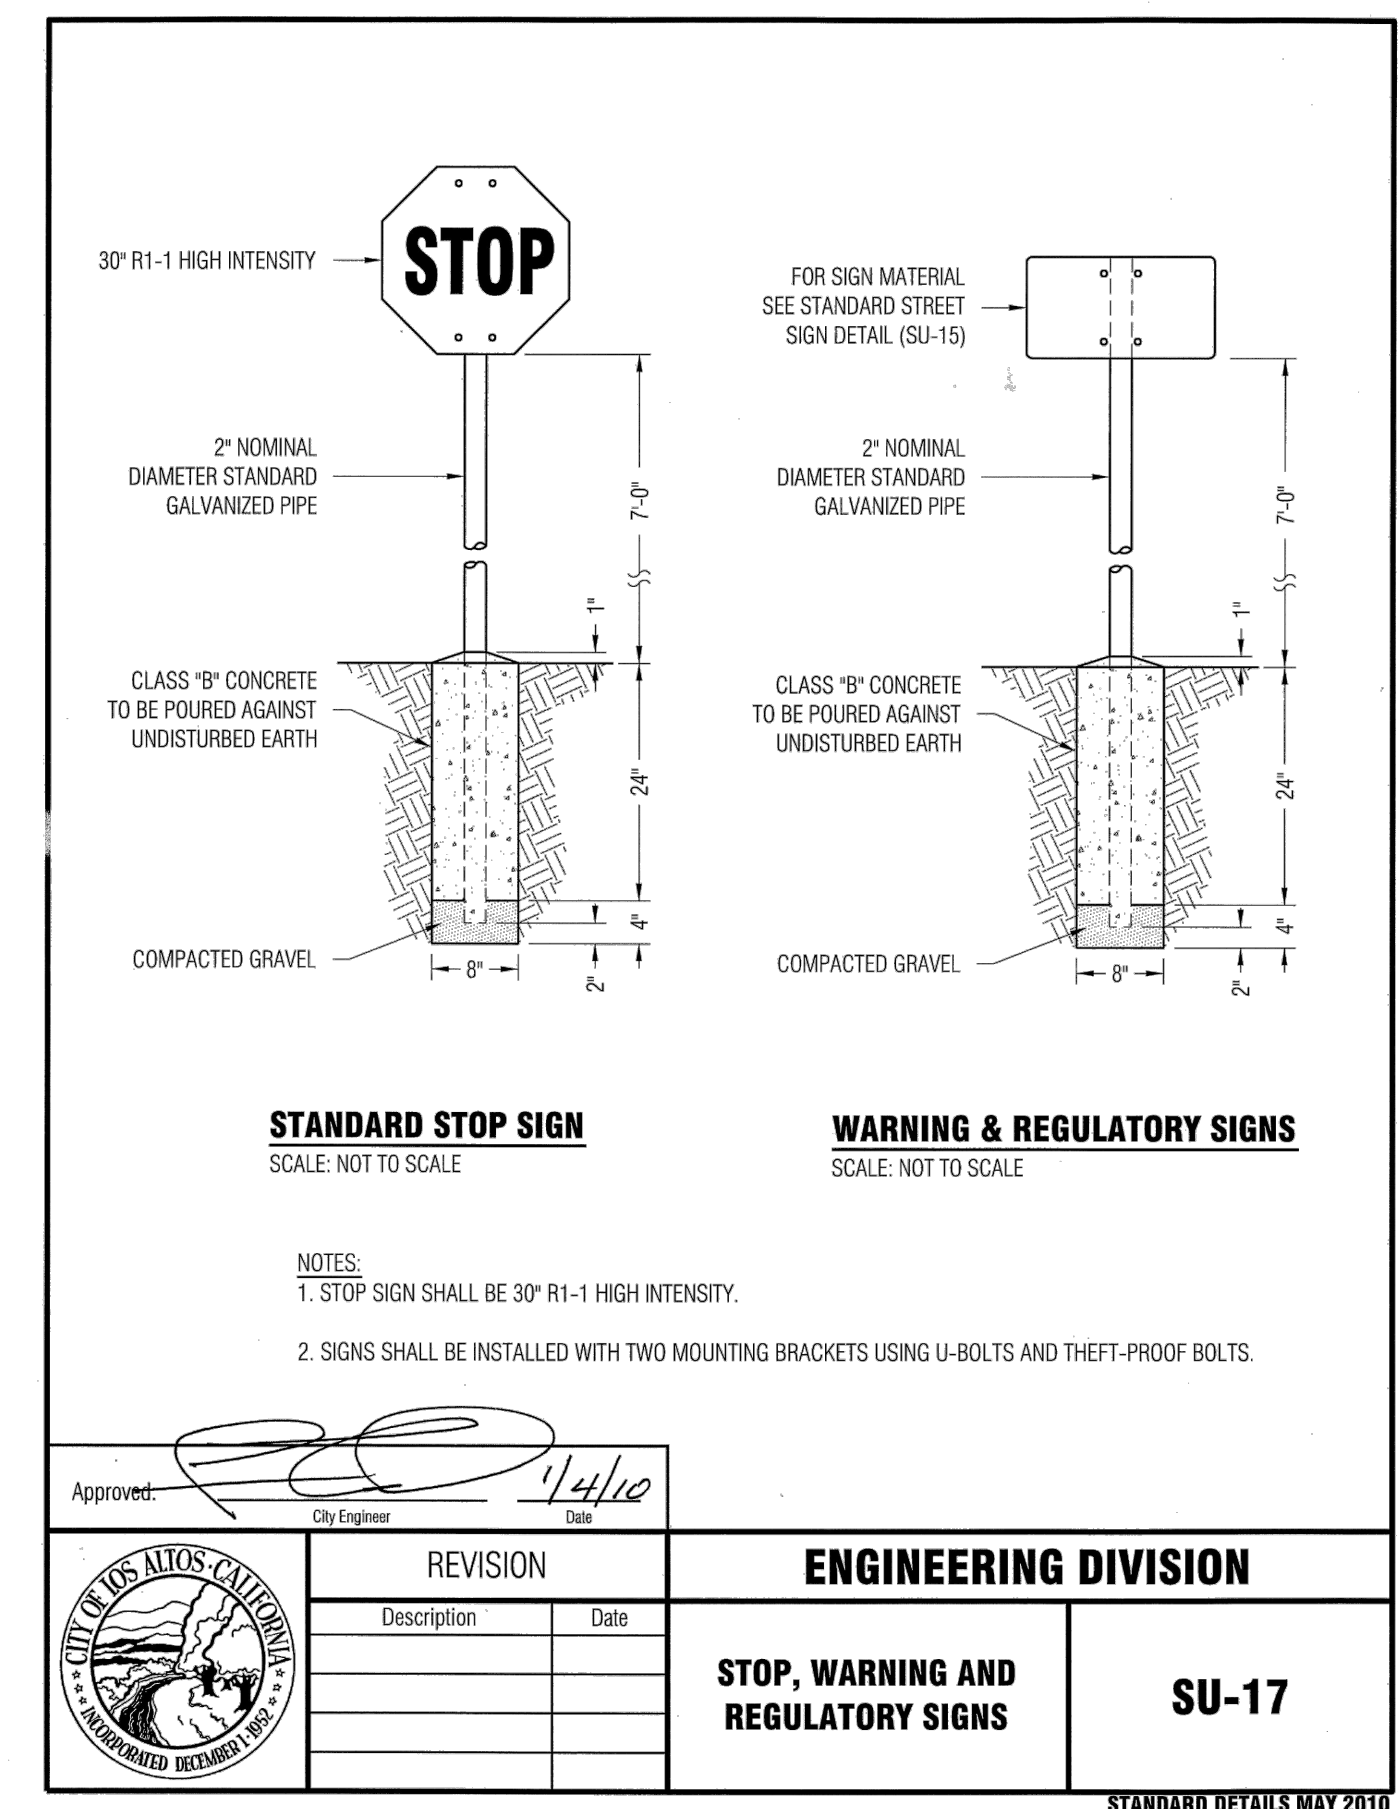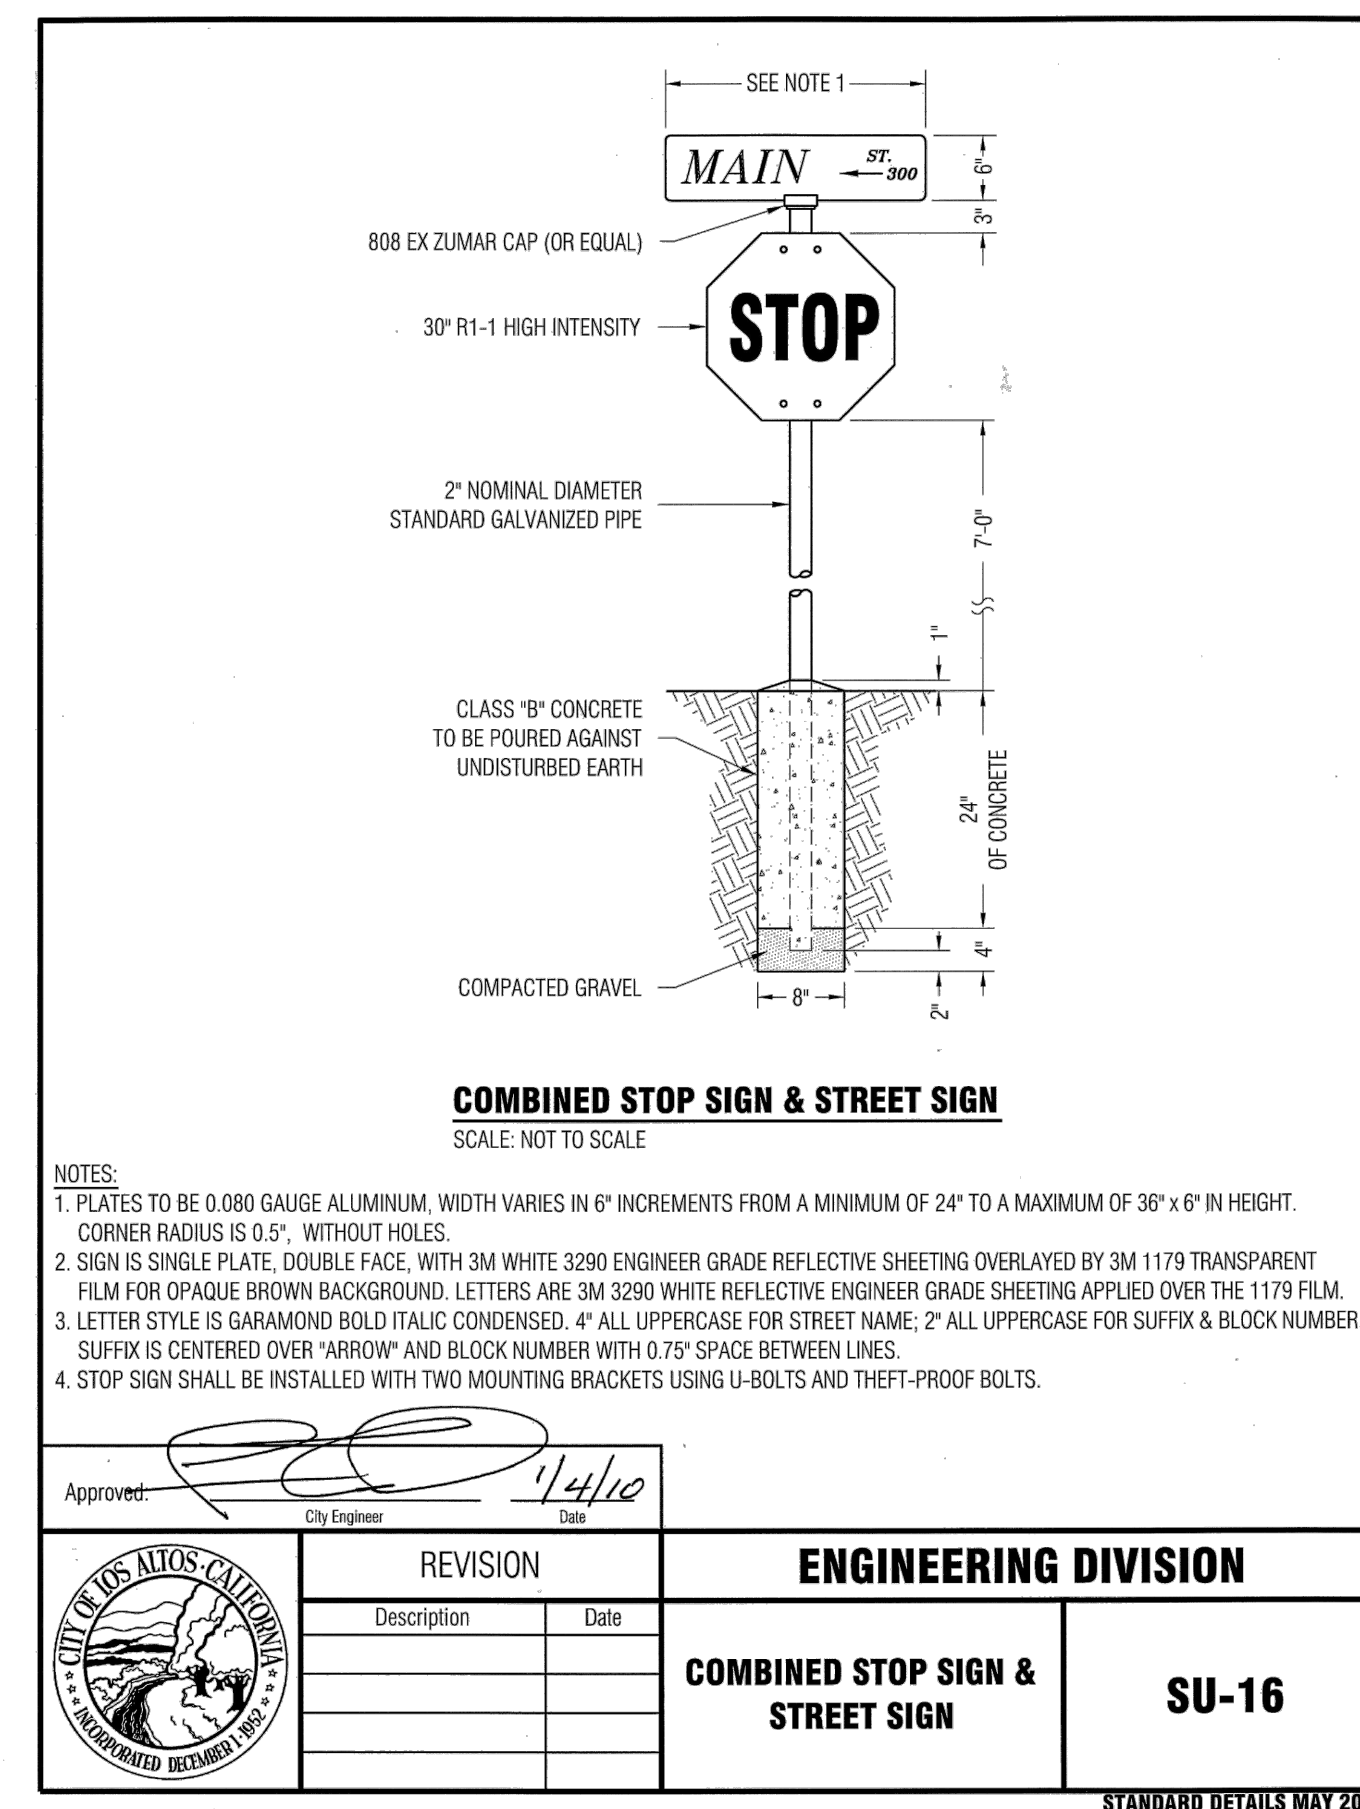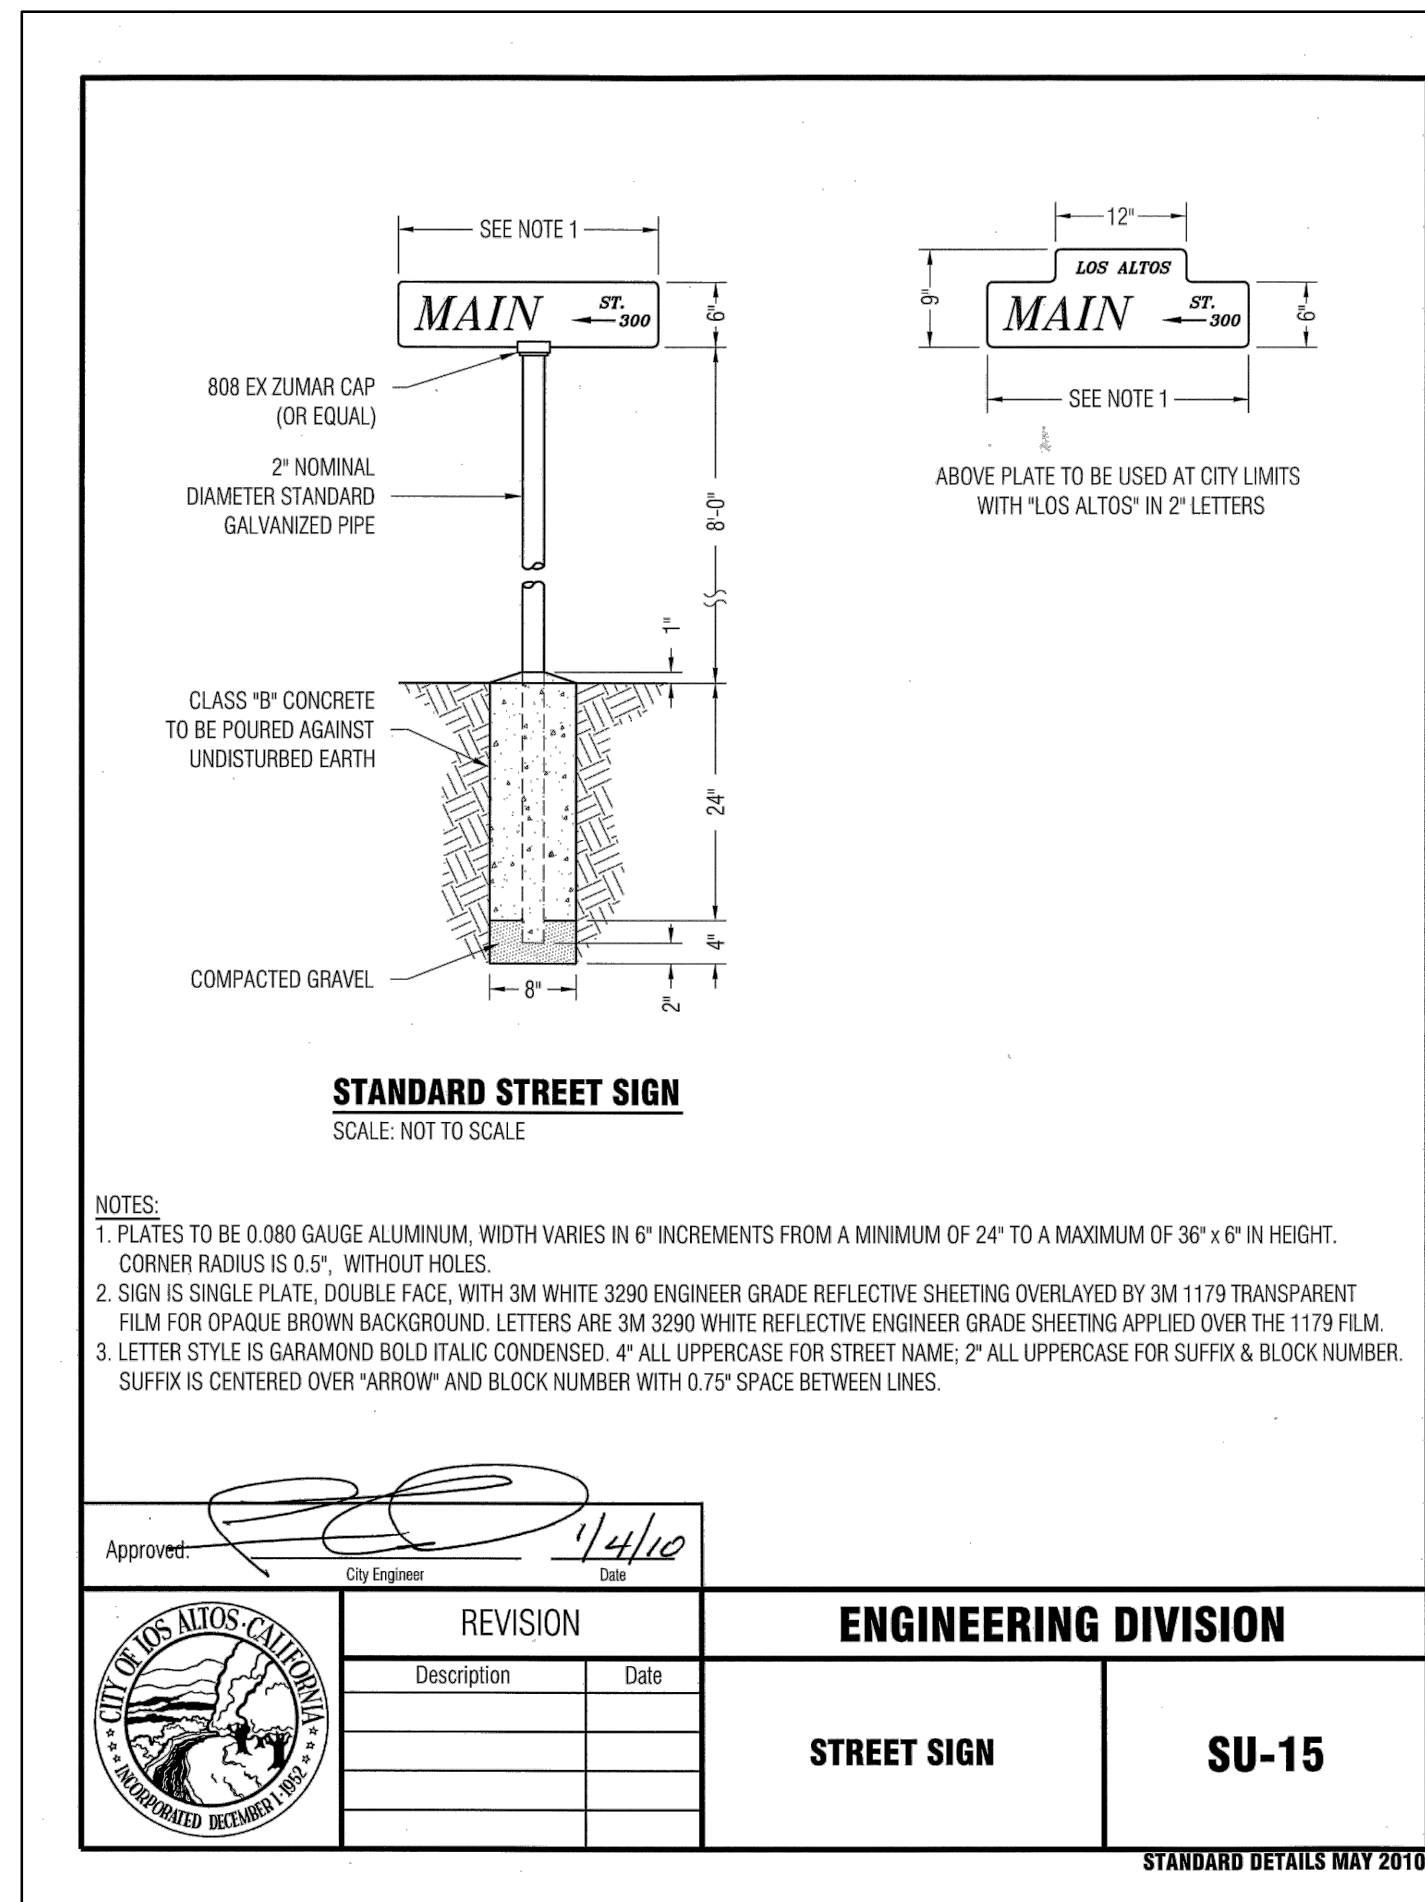
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SHEET NO.
D-05
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