



# 330 DISTEL CIRCLE



Architecture + Planning  
1814 Franklin St., Ste. 400  
Oakland, CA 94612  
510.272.2910  
ktgy.com



**330 DISTEL CIRCLE**  
LOS ALTOS # 2021-0042

**SUBMITTAL #2**  
APRIL 29, 2022

COVER SHEET

A0.0

# 330 DISTEL CIRCLE, LOS ALTOS

## PROJECT DATA

330 Distel Circle	
Site Area	0.87 Acres
Density	103.45 d.u./acre
Lot Coverage	75%

## UNIT MIX

Unit Description	TYPE III										Unit Mix		Total Unit Area (*NRSF)		
	Unit	Description	NRSF	Level 1	Level 2	Level 3	Level 4	Level 5	Studio	1Bd	2Bd	3Bd		% of Mix	Total % of Mix
P0-1	Studio / 1Bd	465	0	6	6	6	6	6	24				27%	26.7%	11,160
P1-0	1Bd / 1Ba	645	0	5	5	5	5			20			22%	22.2%	12,900
P2-0	2Bd / 2Ba	965	0	5	6	6	6				23		26%	25.6%	22,195
P3-0	3Bd / 2Ba	1175	0	4	4	4	3				15	17%		25.6%	17,625
P3-1	3Bd / 2Ba	1105	0	2	2	2	2				8	9%			8,840
<b>Total</b>			<b>0</b>	<b>22</b>	<b>23</b>	<b>23</b>	<b>22</b>		<b>24</b>	<b>20</b>	<b>23</b>	<b>23</b>	<b>100%</b>	<b>100%</b>	<b>72,720</b>

\*NRSF: To outside face of stud + 1" air gap; does not include balcony  
 \*\*100% of units are below market rate, excluding managers units (2).  
**90 Total Units\*\*** **808** AVG NRSF

Building Amenity	
Level 1: Ground Level Amenity	9,260 SF
Level 2: Amenity	870 SF
<b>Total</b>	<b>10,130 SF*</b>

\* Indicates net square footage, to inside face of stud, includes amenity, operations, laundry, bike storage and repair. Does not include circulation, cores, lobby

Gross Building Areas	Residential	Garage	
Level 1	9,730 SF	18,130 SF	
Level 2	22,340 SF	0 SF	
Level 3	22,340 SF	0 SF	
Level 4	22,340 SF	0 SF	
Level 5	21,160 SF	0 SF	
<b>Total</b>	<b>97,910 SF**</b>	<b>18,130 SF**</b>	<b>116,040 SF**</b>

\*\* Indicates gross square footage, measured to the outside surfaces of exterior walls, including halls, stairways, elevator shafts, ducts, service and mechanical equipment rooms. Does not include: porches, verandas, balconies, alcoves, or other similar elements, which are open on at least one side

## Parking Summary

Parking Required	Stalls	Parking Provided	Stalls
Standard Stalls	0	Mechanical parking lift stalls- 2 above + 1pit	69
<b>Total</b>	<b>0 TOTAL STALLS REQUIRED*</b>	Mechanical parking lift stalls- 2 above	13
	0.00 STALLS/UNIT	Unassigned (3 Accessible, 5 Standard)	8
		<b>Total</b>	<b>90 TOTAL STALLS PROVIDED</b>
			1.00 STALLS/UNIT

\* Per Density Bonus Ordinance in Los Altos Municipal Code, Chapter 14.28

Required Bike Parking	Stalls	Provided Bike Parking	Stalls
Class I (long-term secured bike parking)	30	Provided	45
Class II (short-term racks)	6	<b>Total</b>	<b>45 TOTAL STALLS PROVIDED</b>
<b>Total</b>	<b>36 TOTAL STALLS PROVIDED</b>		0.5 STALLS/UNIT
	0.4 STALLS/UNIT		

## Open Space Summary


Required Open space	SF	Provided Open space	SF
Private Open Space	4,500	Private Open Space	2,550
Common Open Space	3,200	Open Space @ Ground Level*	3,690
<b>Total</b>	<b>7,700 SF</b>	Courtyard @ Level 2	5,530
		<b>Total</b>	<b>11,770 SF</b>

\* Ground level open space includes area from building to property line. Excludes Utility area, driveway.


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	C6.0 Fire Hose Reach Plan
Waste Management	TR0.0 Site Plan
	TR0.1 Upper Floor Chute Vestibule
	TR1.0 Residential Trash Room & Chute Vestibule

## PROJECT TEAM

**Developer**  
  
 EAH HOUSING  
 A roof is just the beginning


**EAH Housing**  
 A: 22 Pelican Way,  
 San Rafael, CA 94901  
 C: Welton Jordan  
 T: 415.295.8876  
 E: welton.jordan@eahhousing.org

**Architecture**  
  
 ktgy


**KTGY Architecture + Planning**  
 A: 1814 Franklin St., Suite 400  
 Oakland, CA 94612  
 C: Jessica Musick  
 T: 510.282.2910  
 E: jmusick@ktgy.com

**Landscape**  
  
 JETT  
 LANDSCAPE ARCHITECTURE + DESIGN

**JETT Landscape Architecture + Design**  
 A: 2 Theatre Square, Suite 218  
 Orinda, CA 94563  
 C: Bruce B. Jett  
 T: 510.502.8500  
 E: brucej@jett.land


**Civil**  
  
 BKF

**BKF Engineers**  
 A: 1730 N. First Street, Suite 600  
 San Jose, CA 95112  
 C: Scott Schork, P.E.  
 T: 408.467.9126  
 E: sschork@bkf.com

**Trash**  
  
 AMERICAN TRASH MANAGEMENT

**American Trash Management**  
 A: 1900 Powell Street, Suite 220  
 Emeryville, CA, 94608  
 C: Scott Brown  
 T: 415.292.5401  
 E: sbrown@trashmanage.com

## VICINITY MAP (N.T.S.)

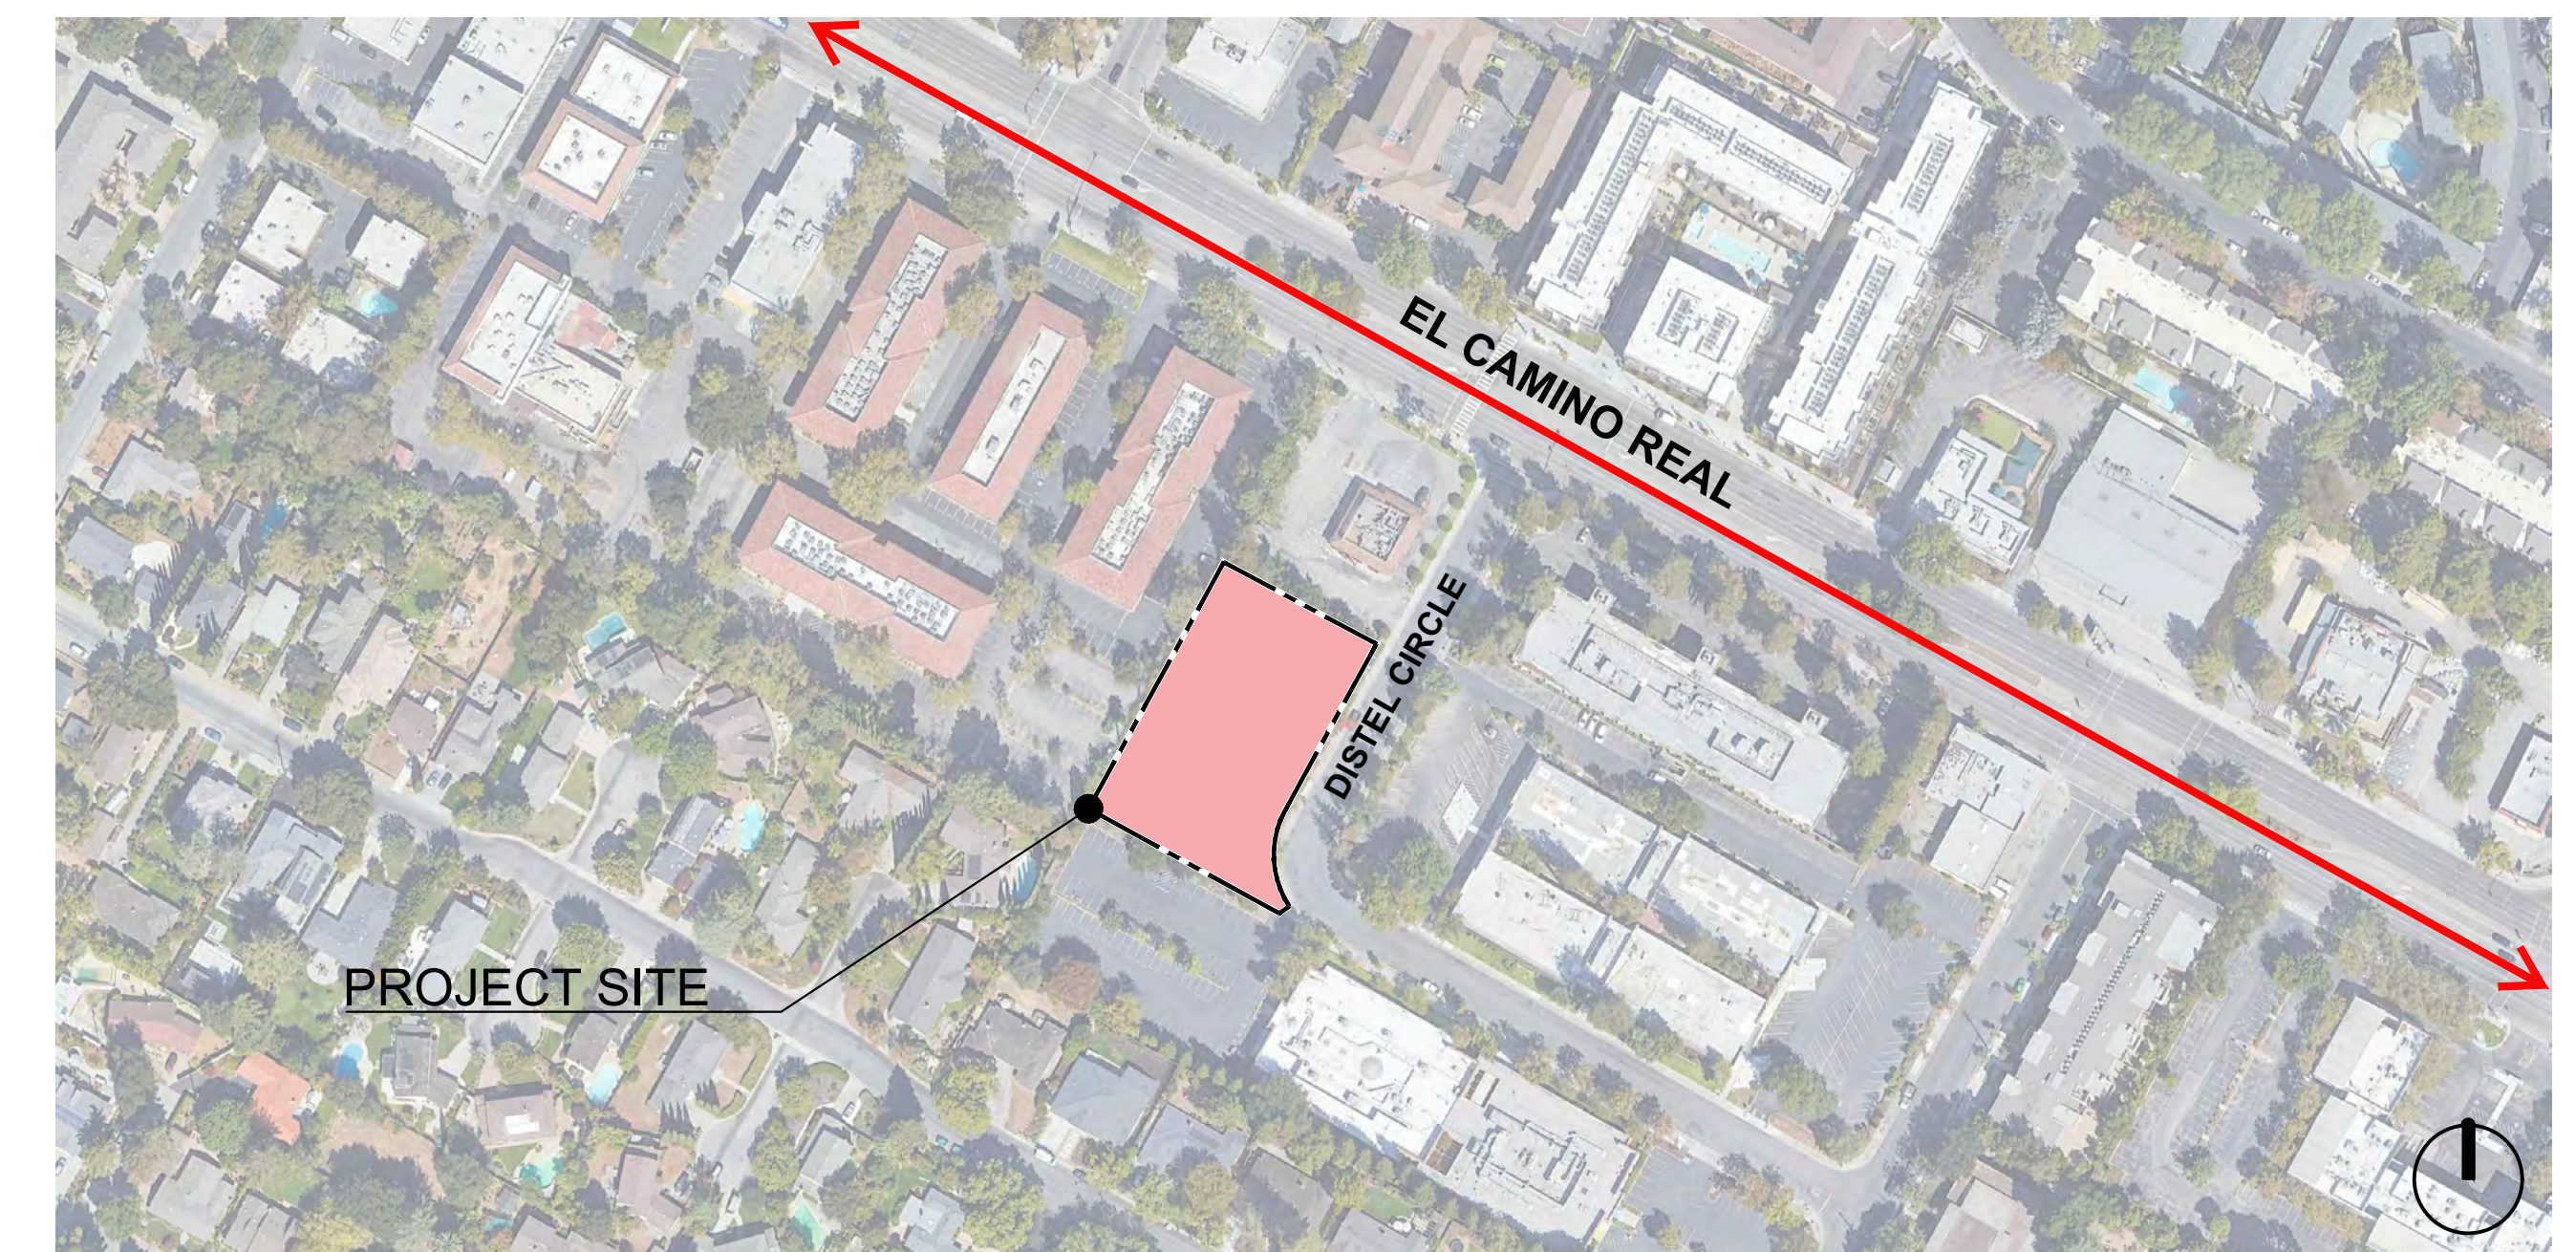



SINGLE FAMILY HOMES

LOS ALTOS CENTER LAB

SITE

LOS ALTOS OFFICE PLAZA

CARL'S JR

DISTEL CIRCLE

EL CAMINO REAL



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SITE CONTEXT

A0.2



March + September: 9 am



June: 9 am



December: 9 am



March + September: 12 pm



June: 12 pm



December: 12 pm



March + September: 3 pm



June: 3 pm



December: 3 pm




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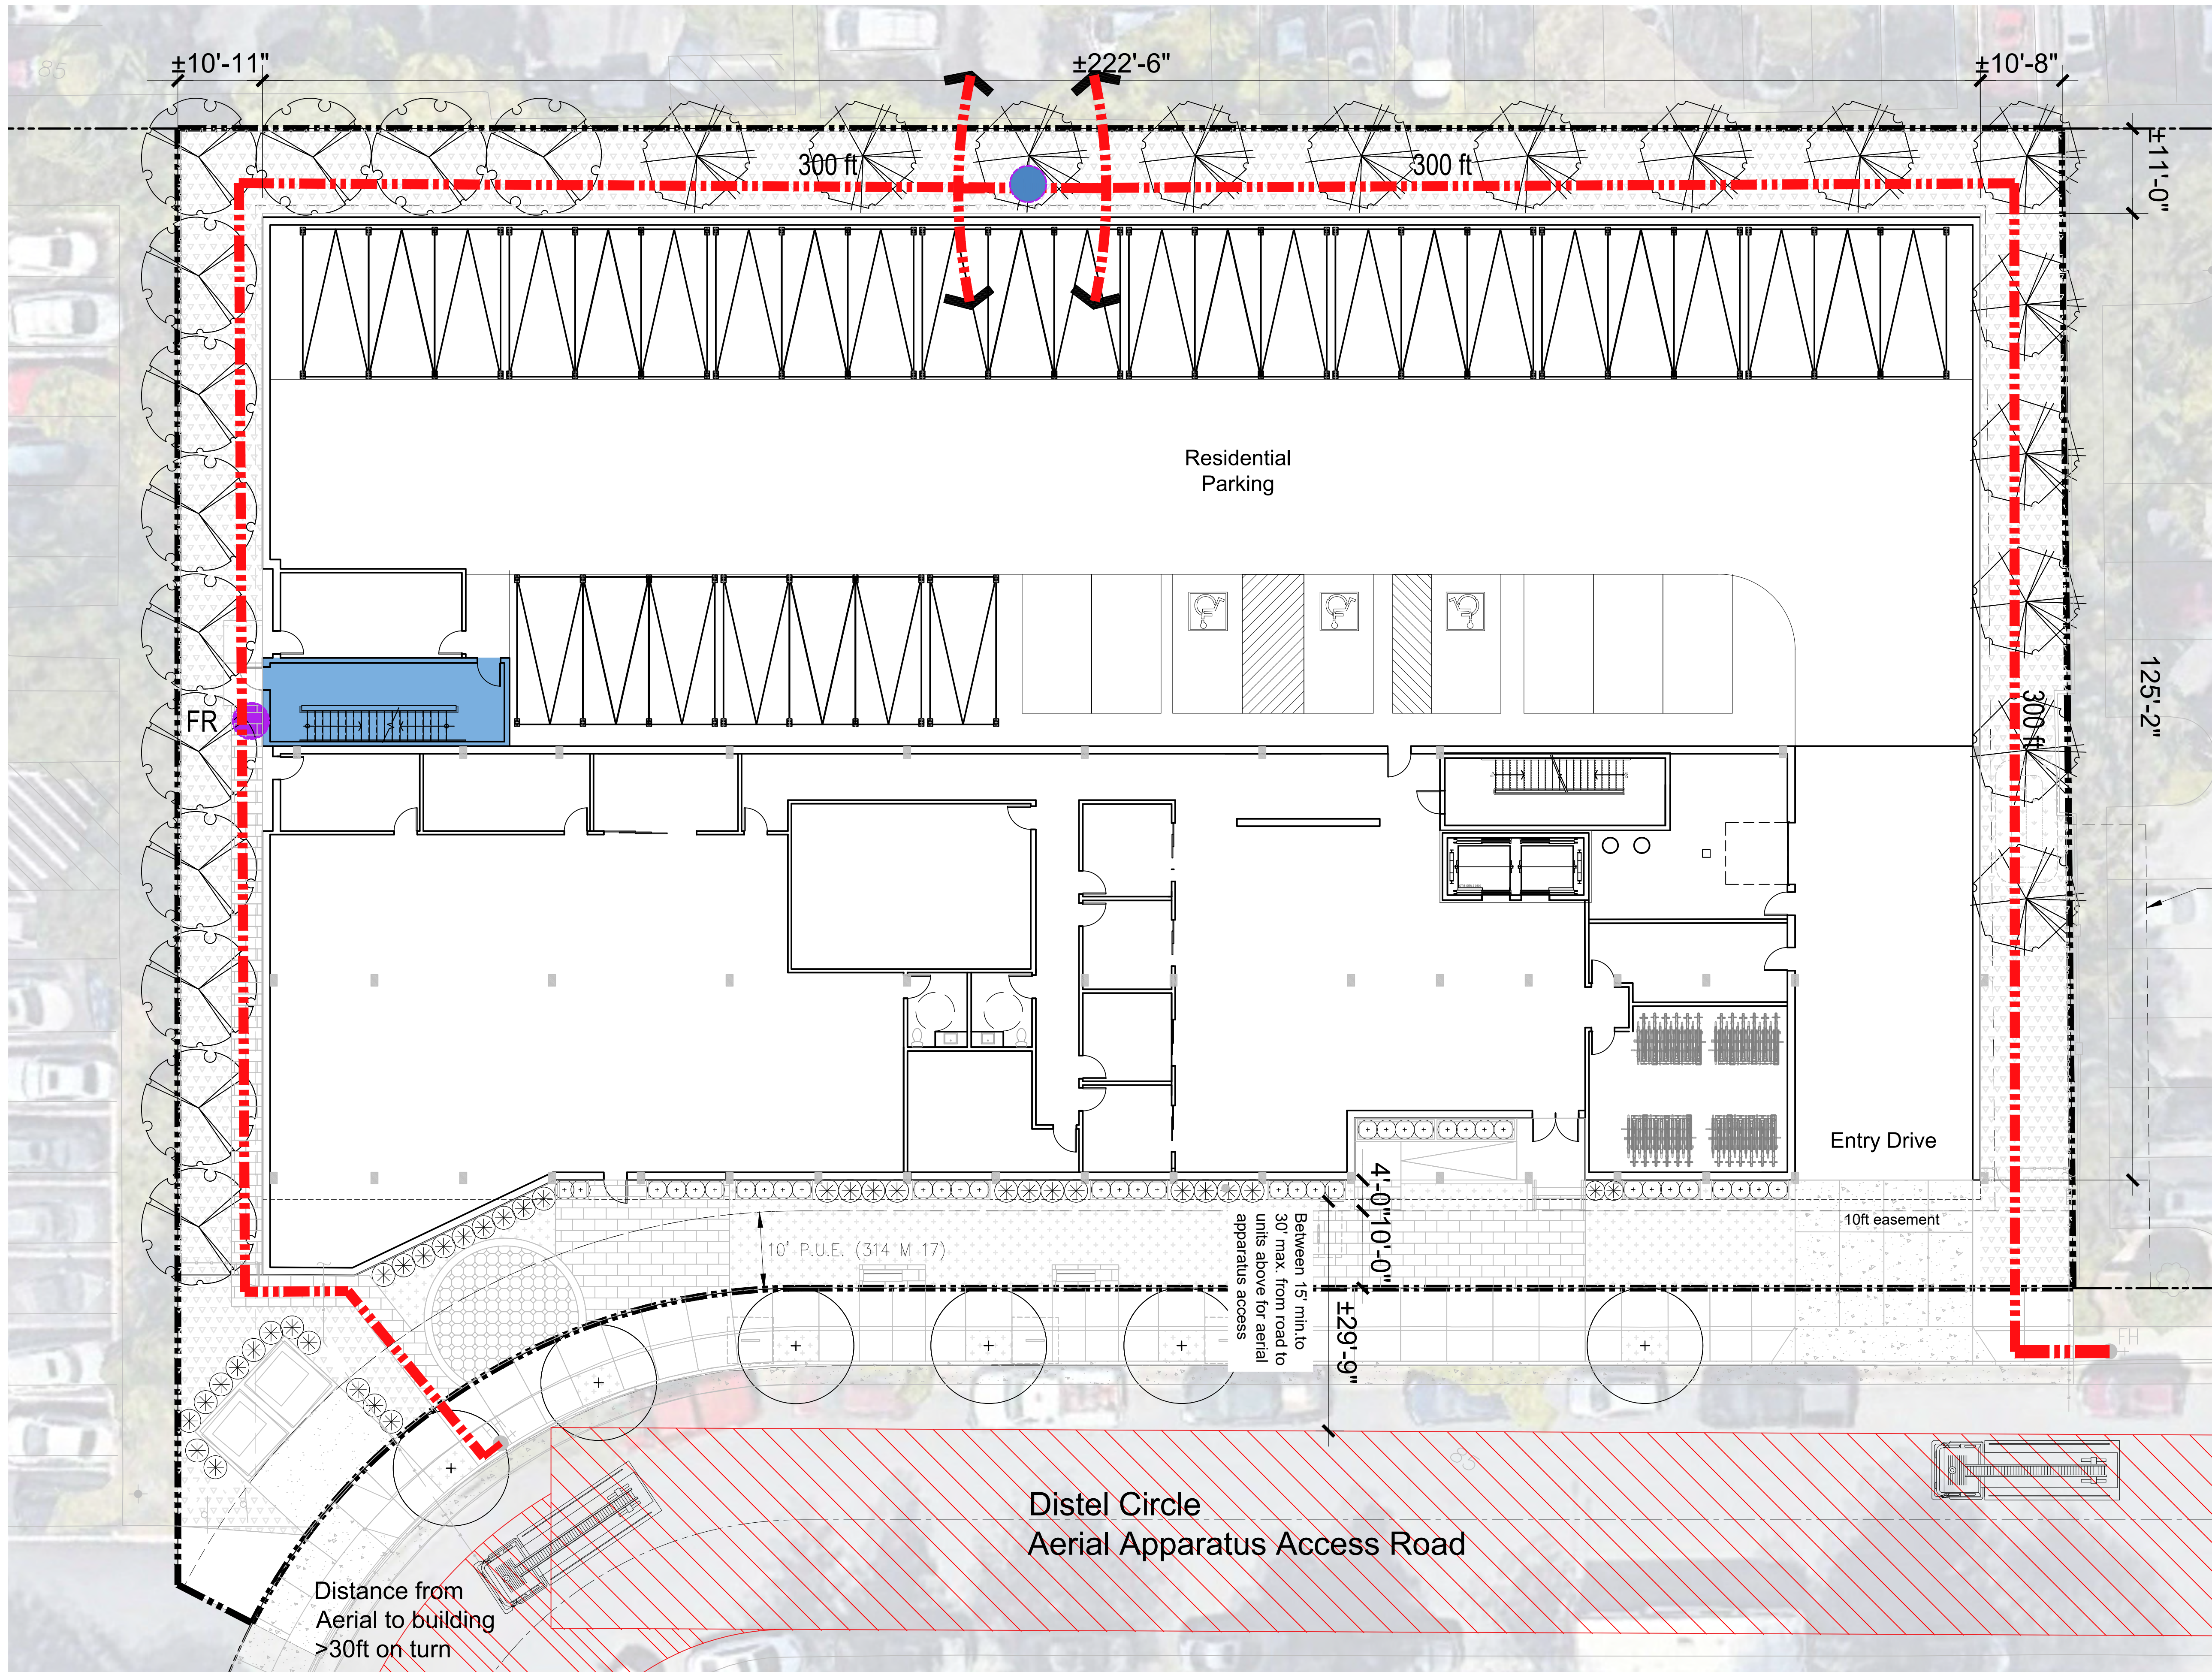
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SOLAR STUDY


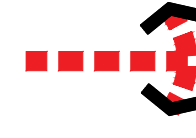



A0.3

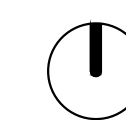

**Project Summary**

Site Area	.87 acres
Dwelling Units	90 Units
Proposed Use	Multifamily Residential
Construction Type	Type IIIA 5 stories
Parking	Surface + Mechanized Parking

**Fire Access Plan**

-  26' aerial apparatus access road
-  150' maximum. hose pull radius and travel distance as noted. 200ft acceptable as discussed with Los Altos Fire department for this scale of building.
-  Stair Fire Riser
-  Wet Standpipe
-  Stair with roof access

Project is requesting for 300ft hose reach from Distel per Exception 1 of 503.1.1 Santa Clara County code below. Alternate Methods submitted.

*503.1.1 Buildings and facilities. Approved fire apparatus access roads shall be provided for every facility, building or portion of a building hereafter constructed or moved into or within the jurisdiction. The fire apparatus access road shall comply with the requirements for this section and shall extend to within 150 feet (45720 mm) of all portions of the facility and all portions of the exterior walls of the first story of the building as measured by an approved route around the exterior of the building or facility.*

**Exceptions:**

1. In other than R-3 or U occupancies, when the building is equipped throughout with an approved automatic sprinkler system, installed in accordance with Section 903.3.1.1 the dimension may be increased to a maximum of 300 feet when approved by the fire code official.






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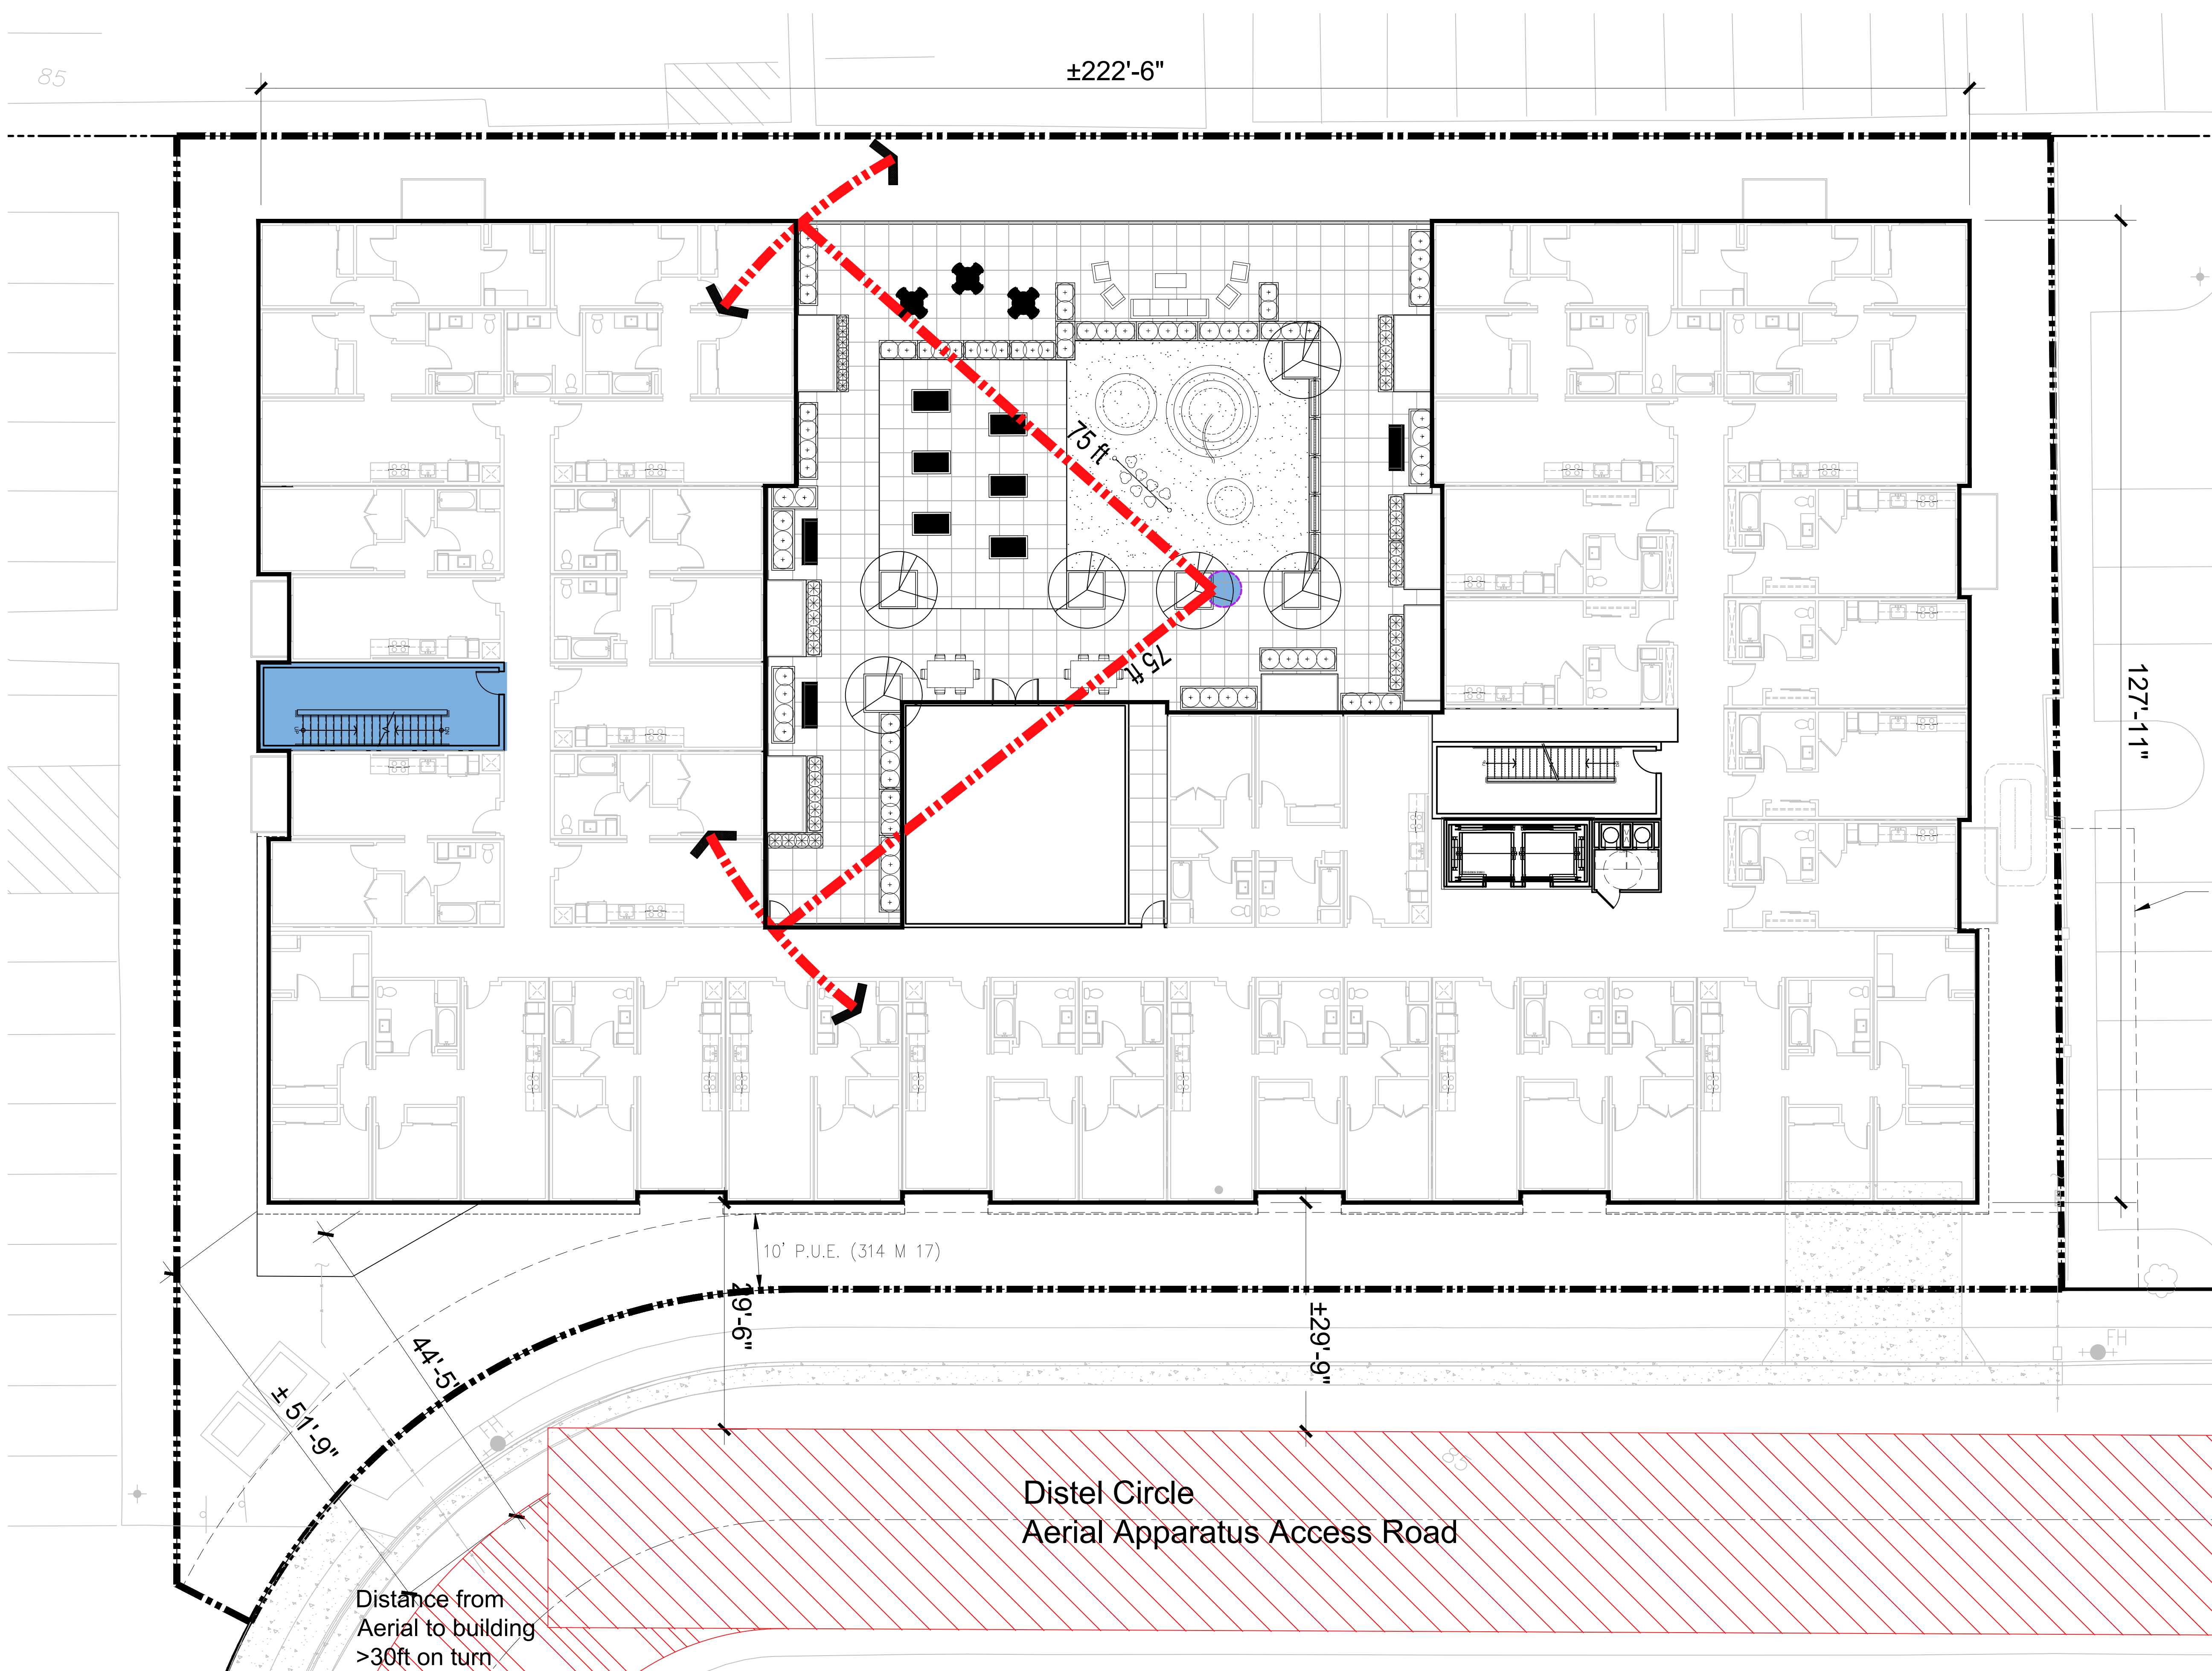
±222'-6"

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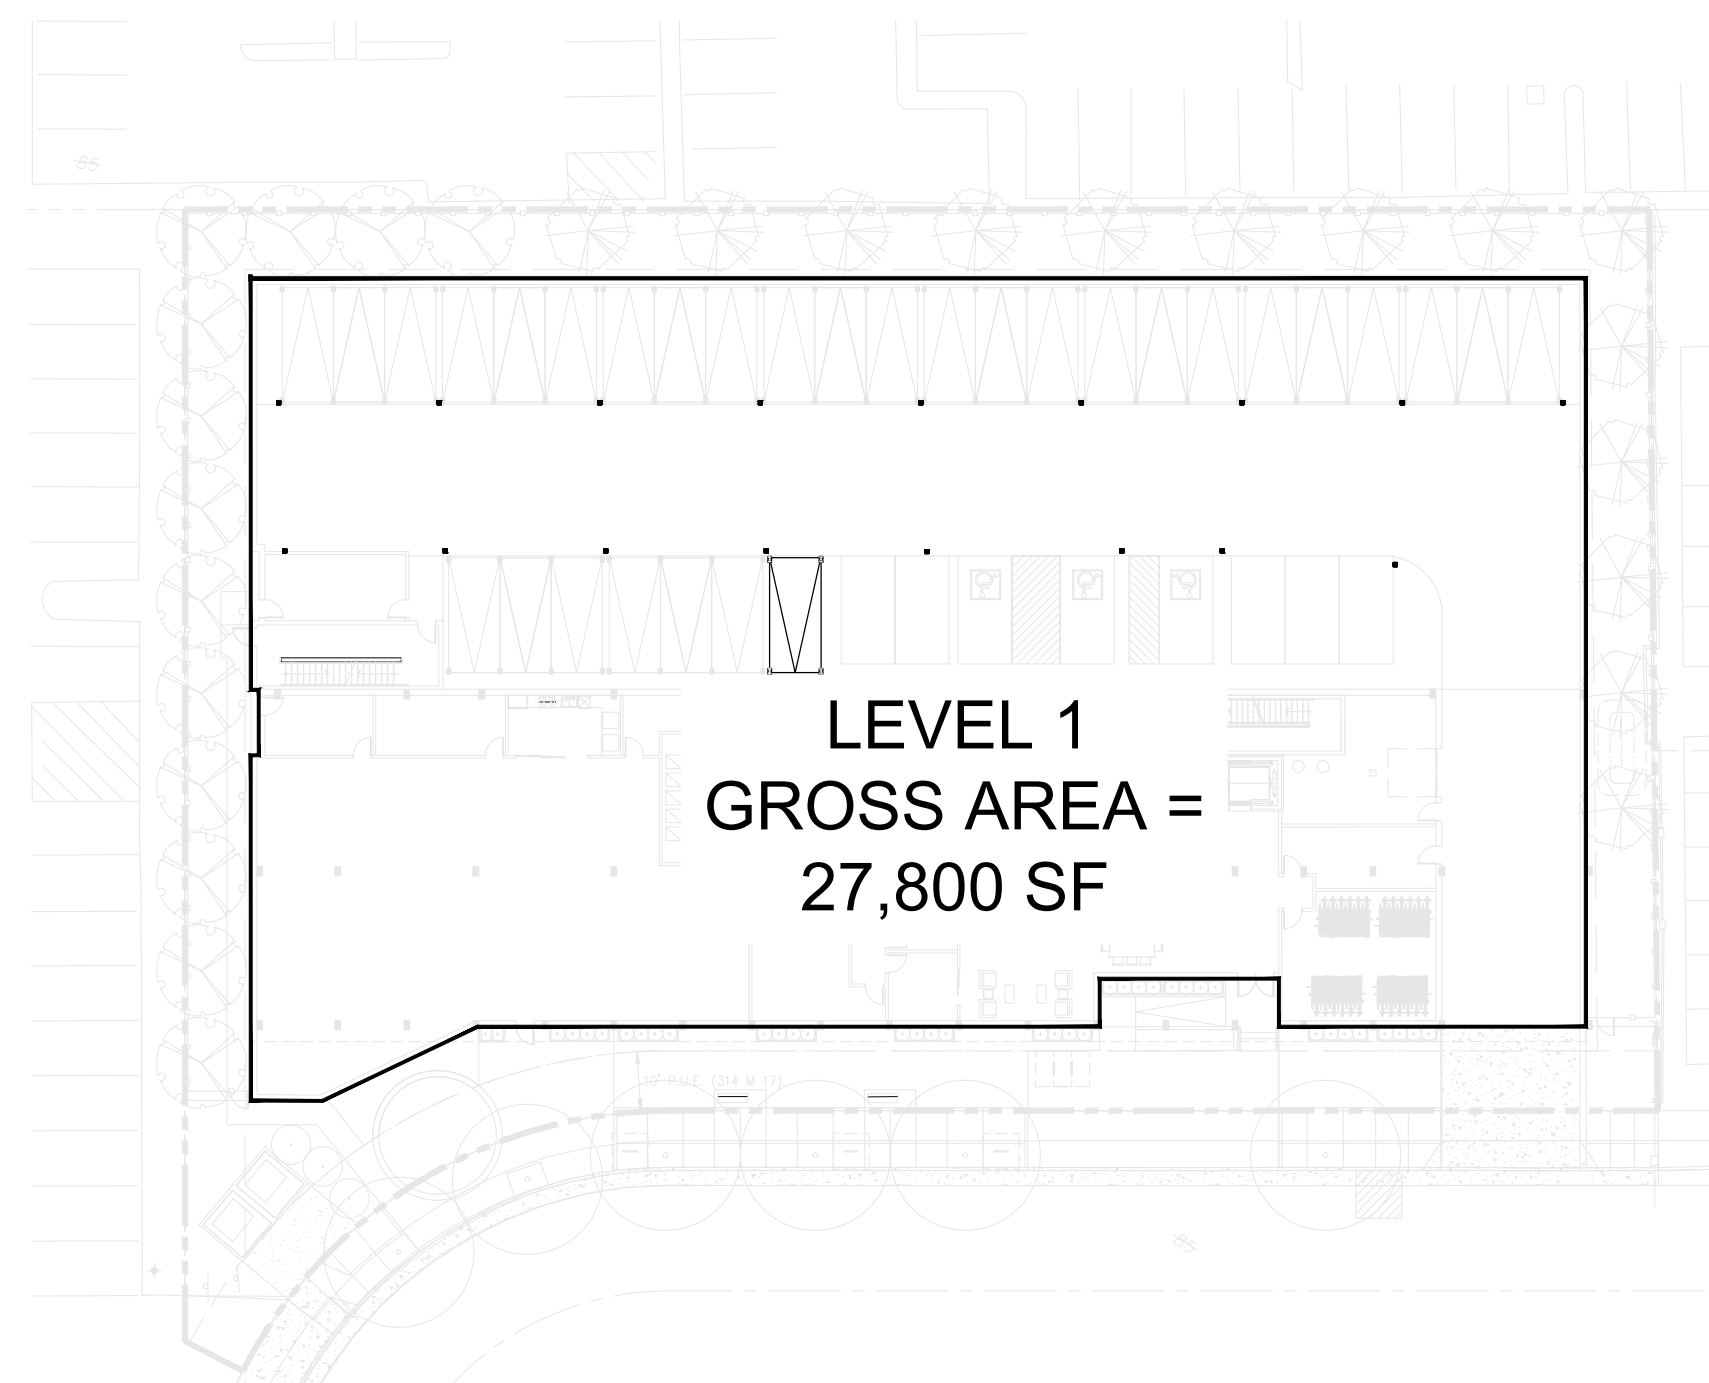
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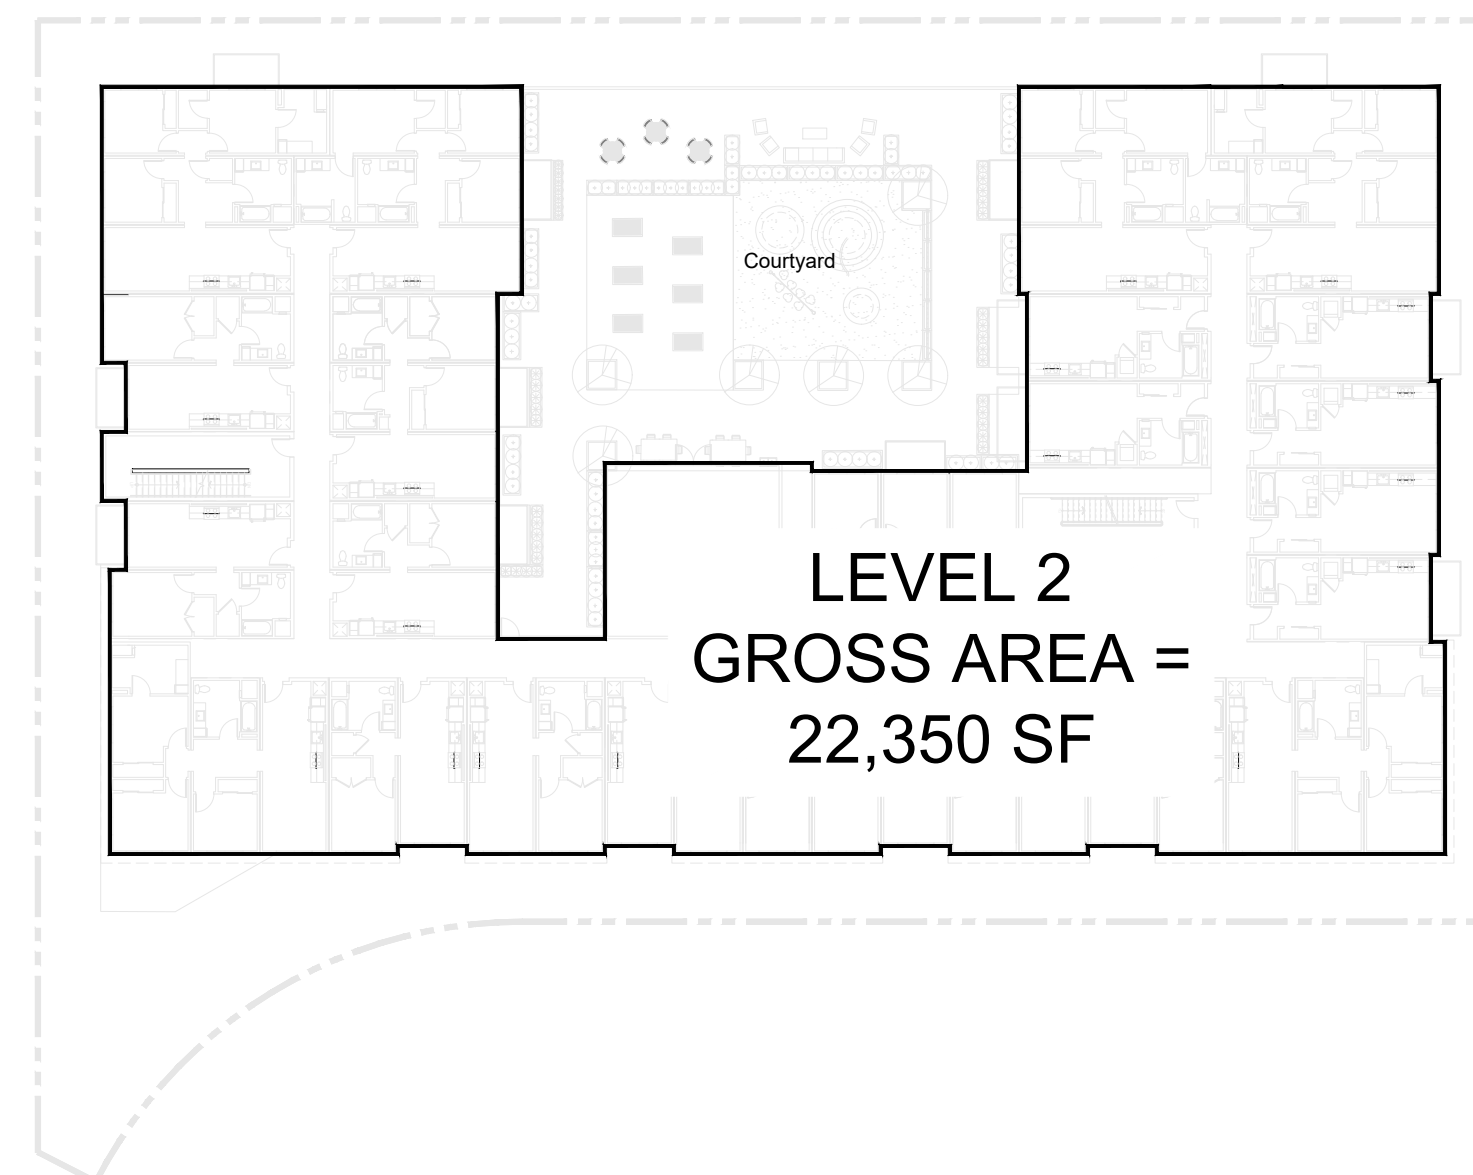


**FIRE ACCESS DIAGRAM**  
 LEVEL 2


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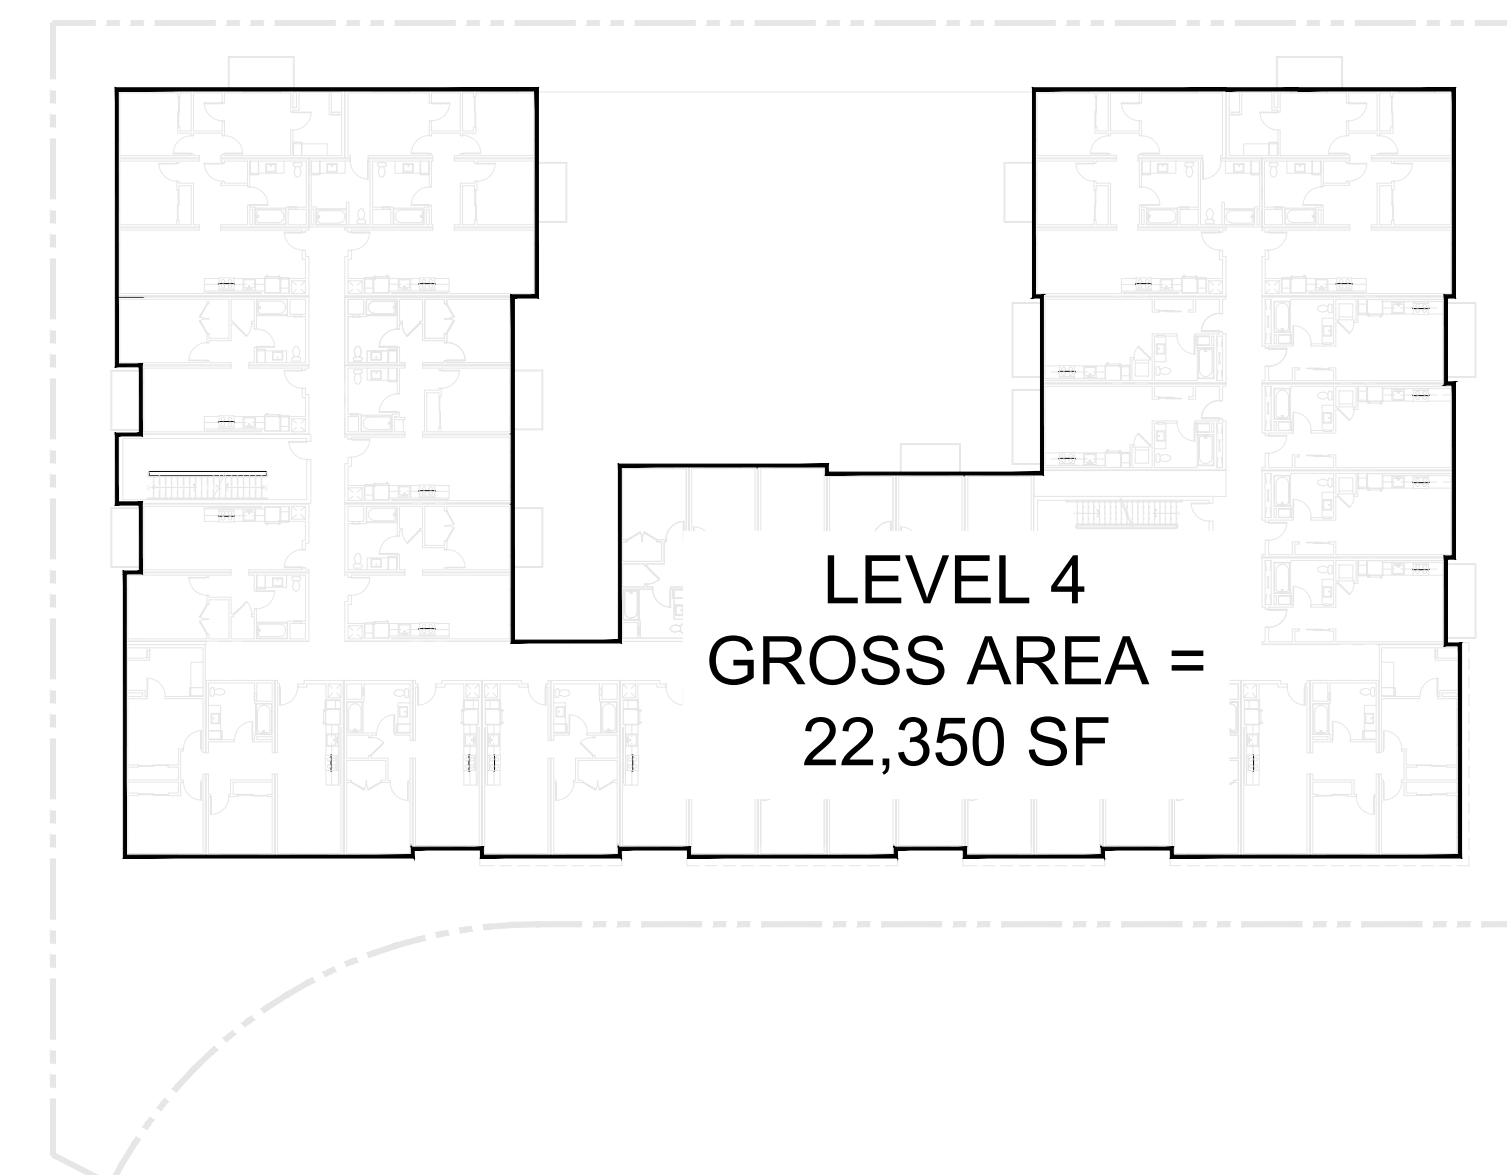
LEVEL 1

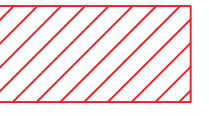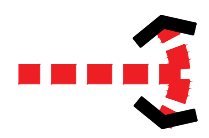


LEVEL 2



LEVEL 3

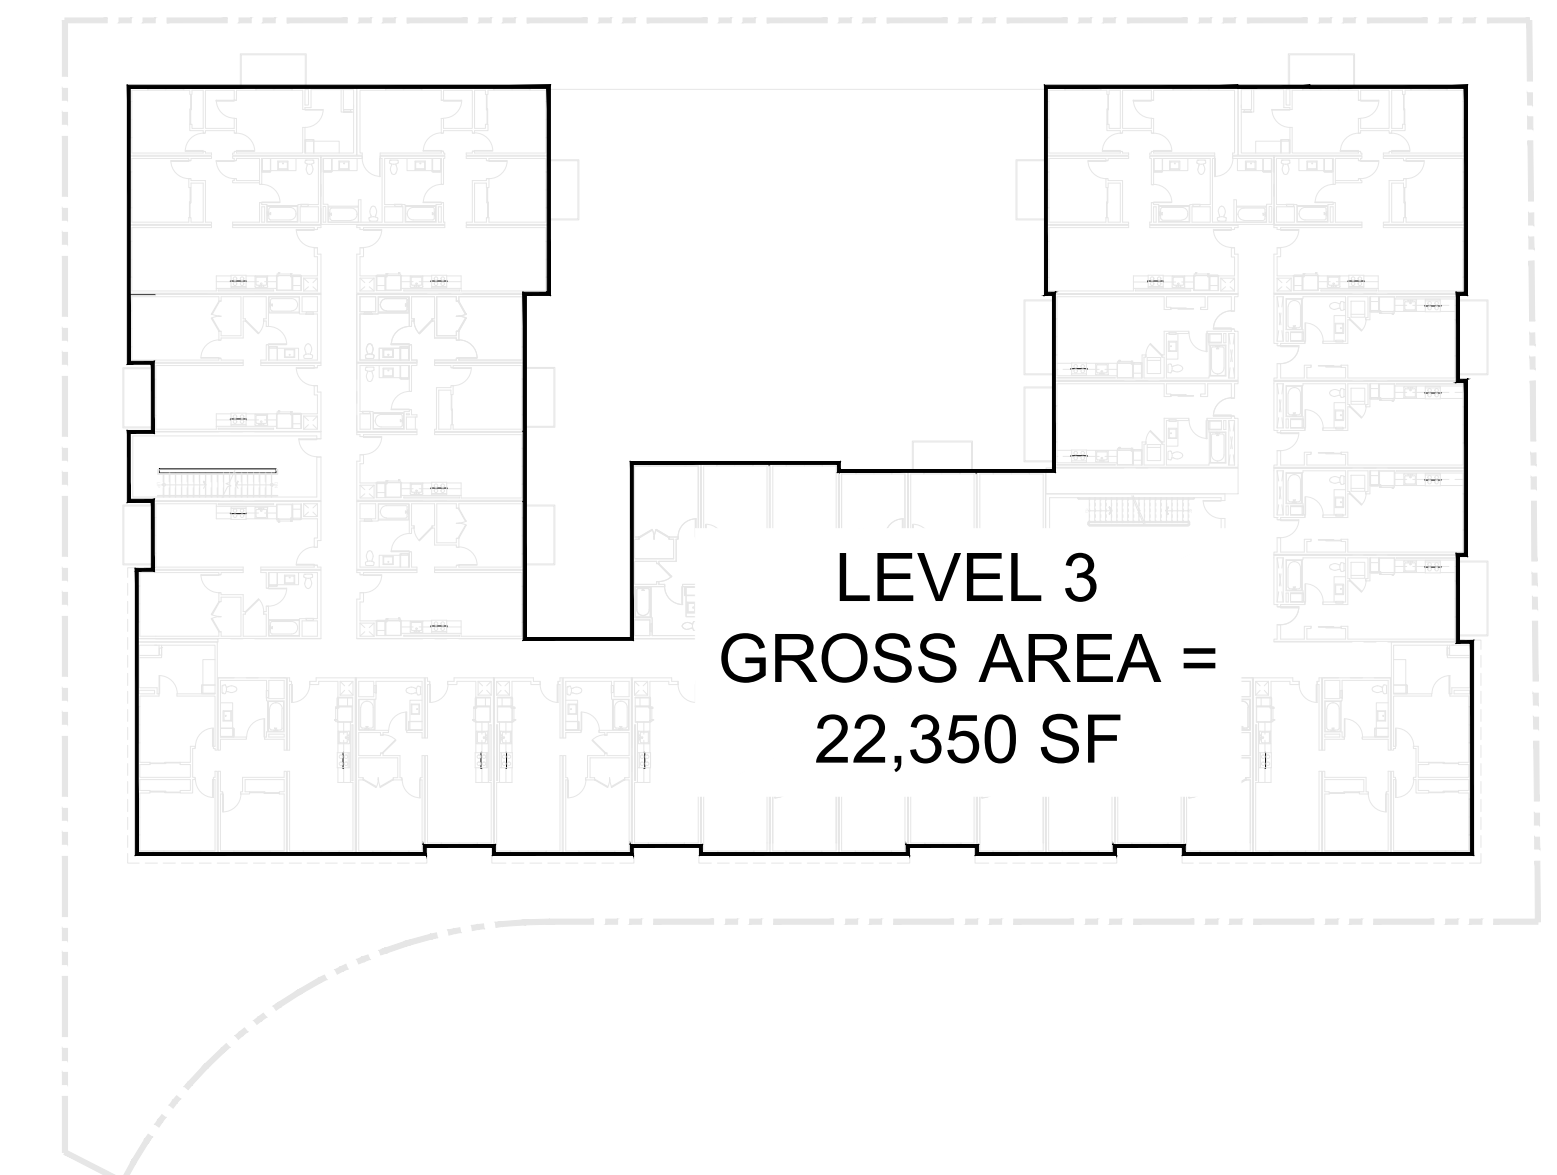

LEVEL 4

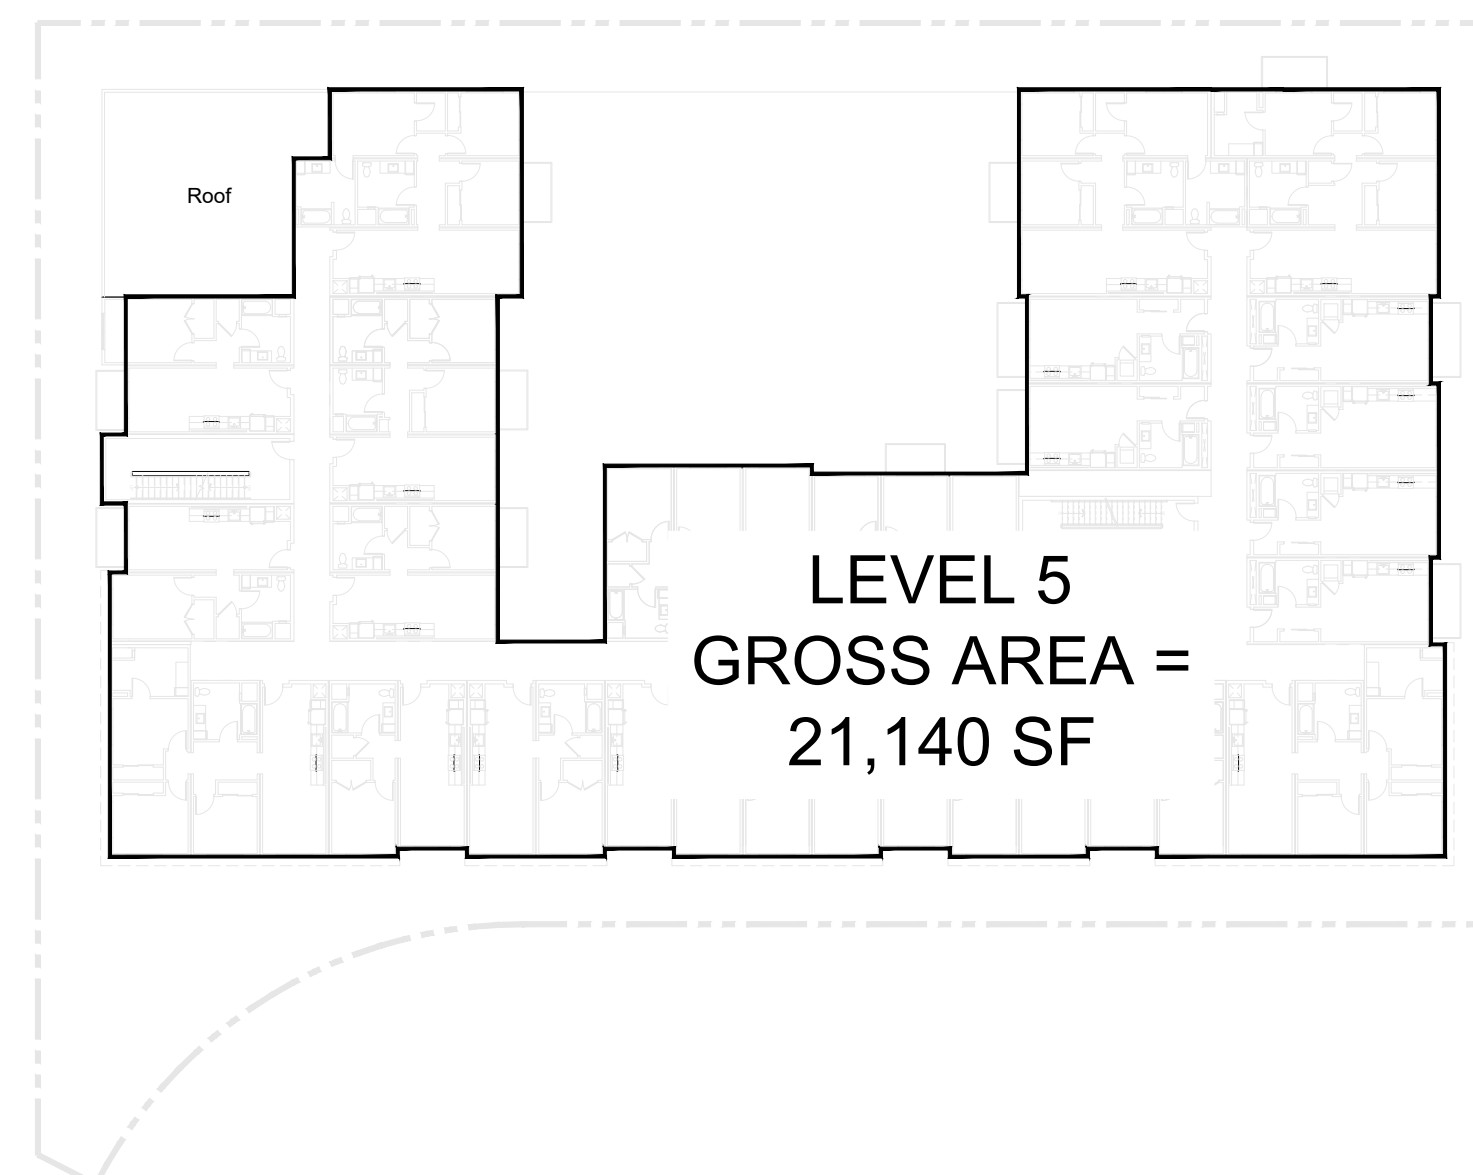

LEVEL 5

DEFINITIONS: (as per Los Altos Municipal Code Secn 14.02.070)

- **Floor Area Ratio** means the maximum ratio of *gross floor area* on a site to the *total site area*.
- **Gross Floor Area** means the total floor space under roof of all floors of a building measured to the outside surfaces of exterior walls, including halls, stairways, elevator shafts, ducts, service and mechanical equipment rooms, interior courts, garages, enclosed accessory structures, and carports.
- **Total Site Area** means the total horizontal area included within the property lines of a single site.

LEVEL 1	=	27,800 SF
LEVEL 2	=	22,350 SF
LEVEL 3	=	22,350 SF
LEVEL 4	=	22,350 SF
LEVEL 5	=	21,140 SF

TOTAL	=	115,990 SF
TOTAL SITE AREA	=	38,050 SF

FAR = 115,998 / 38,050 = 3



## 330 DISTEL CIRCLE

We propose an innovative solution to the housing and parking needs for today and the future through four design concepts while providing an inclusionary and healthy community:

1. Mechanized Parking Solution
2. Mass Timber
3. Modular Units
4. Sustainability



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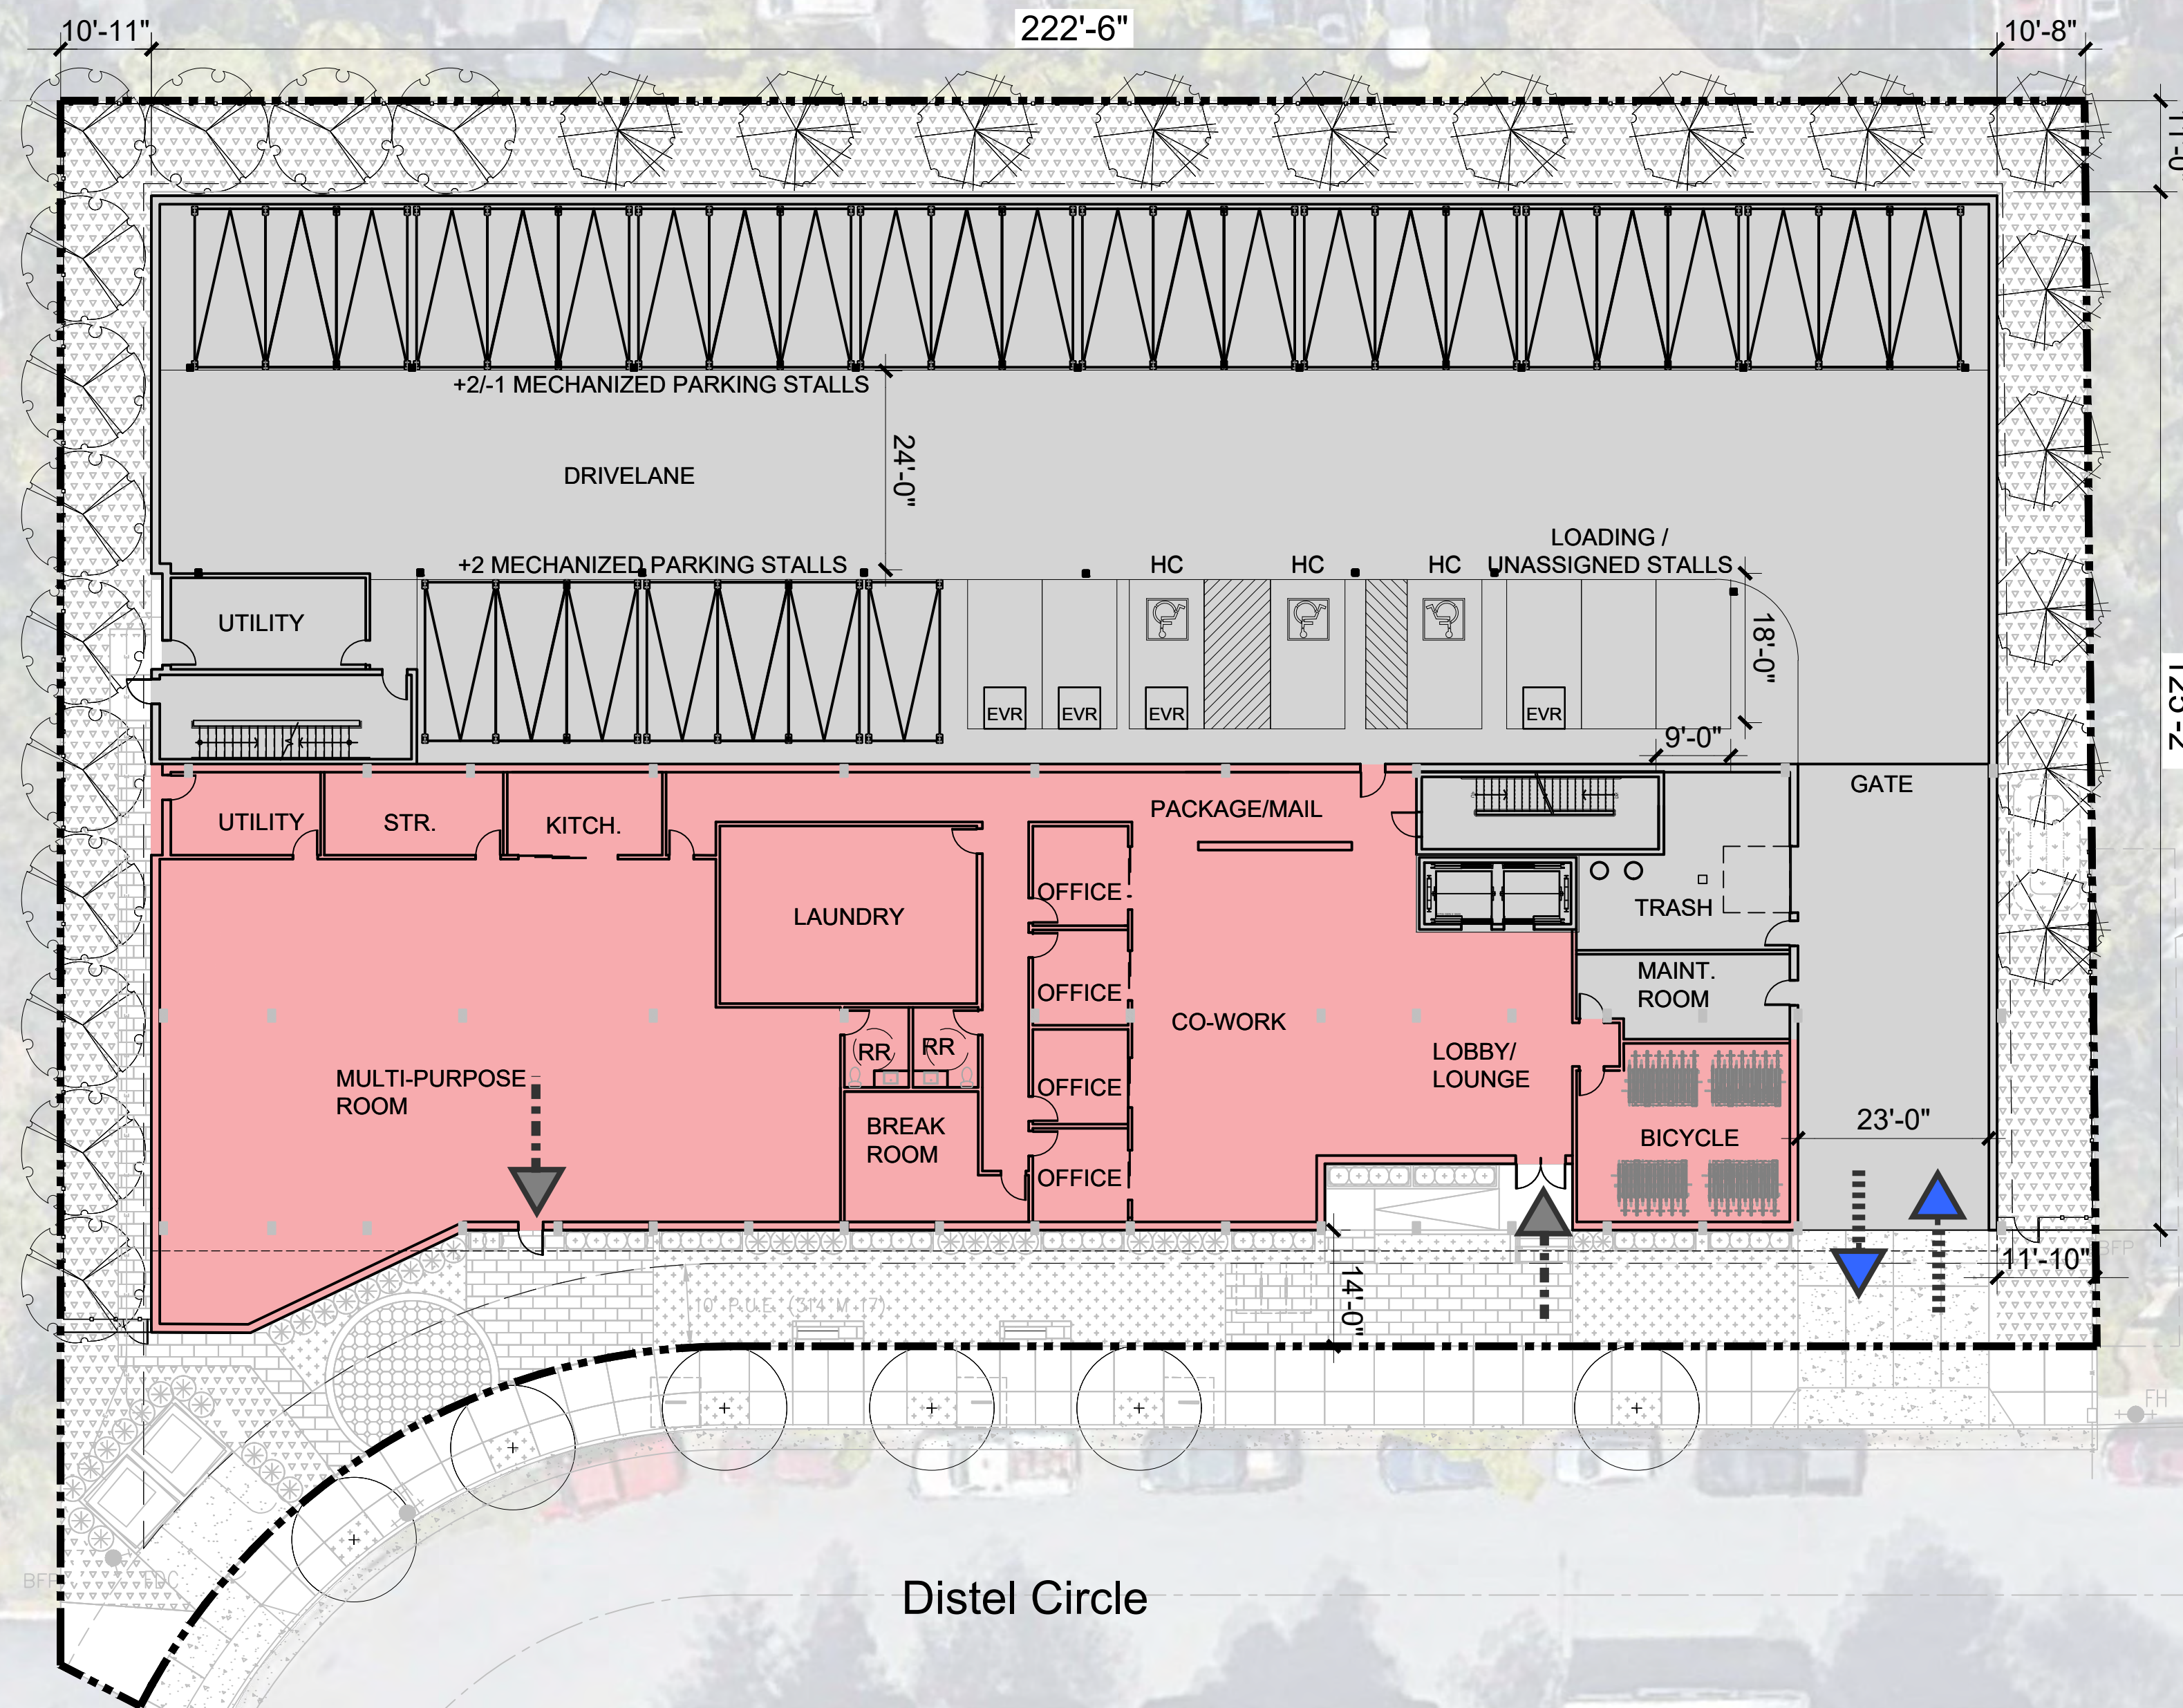
CONCEPTS

A1.0



## MECHANIZED PARKING SOLUTION

The efficient parking design and space optimization of a mechanized parking solution allows for 90 parking spaces. A long entry drive has been designed into the ground level plan to allow for a generous queuing area.



10' x 60' PG&E EASEMENT (A180 O.R. 580)

El Camino Real

Distel Circle

### LEGEND

- Vehicular flow
- Pedestrian flow
- EVR - EV Ready Stalls
- HC - Accessible Stalls

## MASS TIMBER

Our project team anticipates several key benefits from utilizing mass timber as opposed to concrete to construct the ground level of the project.

- Renewable Resource
- Reduced Carbon Footprint
- Faster Construction
- Less disruptive construction process
- Natural warm wood aesthetic



DISTEL CIRCLE BUILDING ENTRY



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**PROPOSED DESIGN**  
MASS TIMBER

**A1.2**



**MODULAR UNITS**

90 Residential units located at level 2-5 are envisioned to be built of modular manufactured units. Modular units allow for:

- Reduced construction noise and disruption
- Minimal material waste
- Faster construction

**DISTEL CIRCLE STREETSCAPE**



### SUSTAINABILITY

Environmentally healthy features include the following:

### SITE

- Stormwater control
- Resource Efficient Landscapes
- Courtyard
- Bicycle Storage

### MATERIALS

- Low VOC paints
- Environmentally preferred materials
- Wood

### ENERGY + WATER

- Solar PV
- Energy star appliances
- High efficacy lighting
- EV charging stations
- Water efficient fixtures
- High Efficiency Irrigation System

### BUILDING ENVELOPE

- Passive Solar Shading
- Construction material efficiencies
- Double glazed windows



DISTEL CIRCLE PROPOSED ELEVATION



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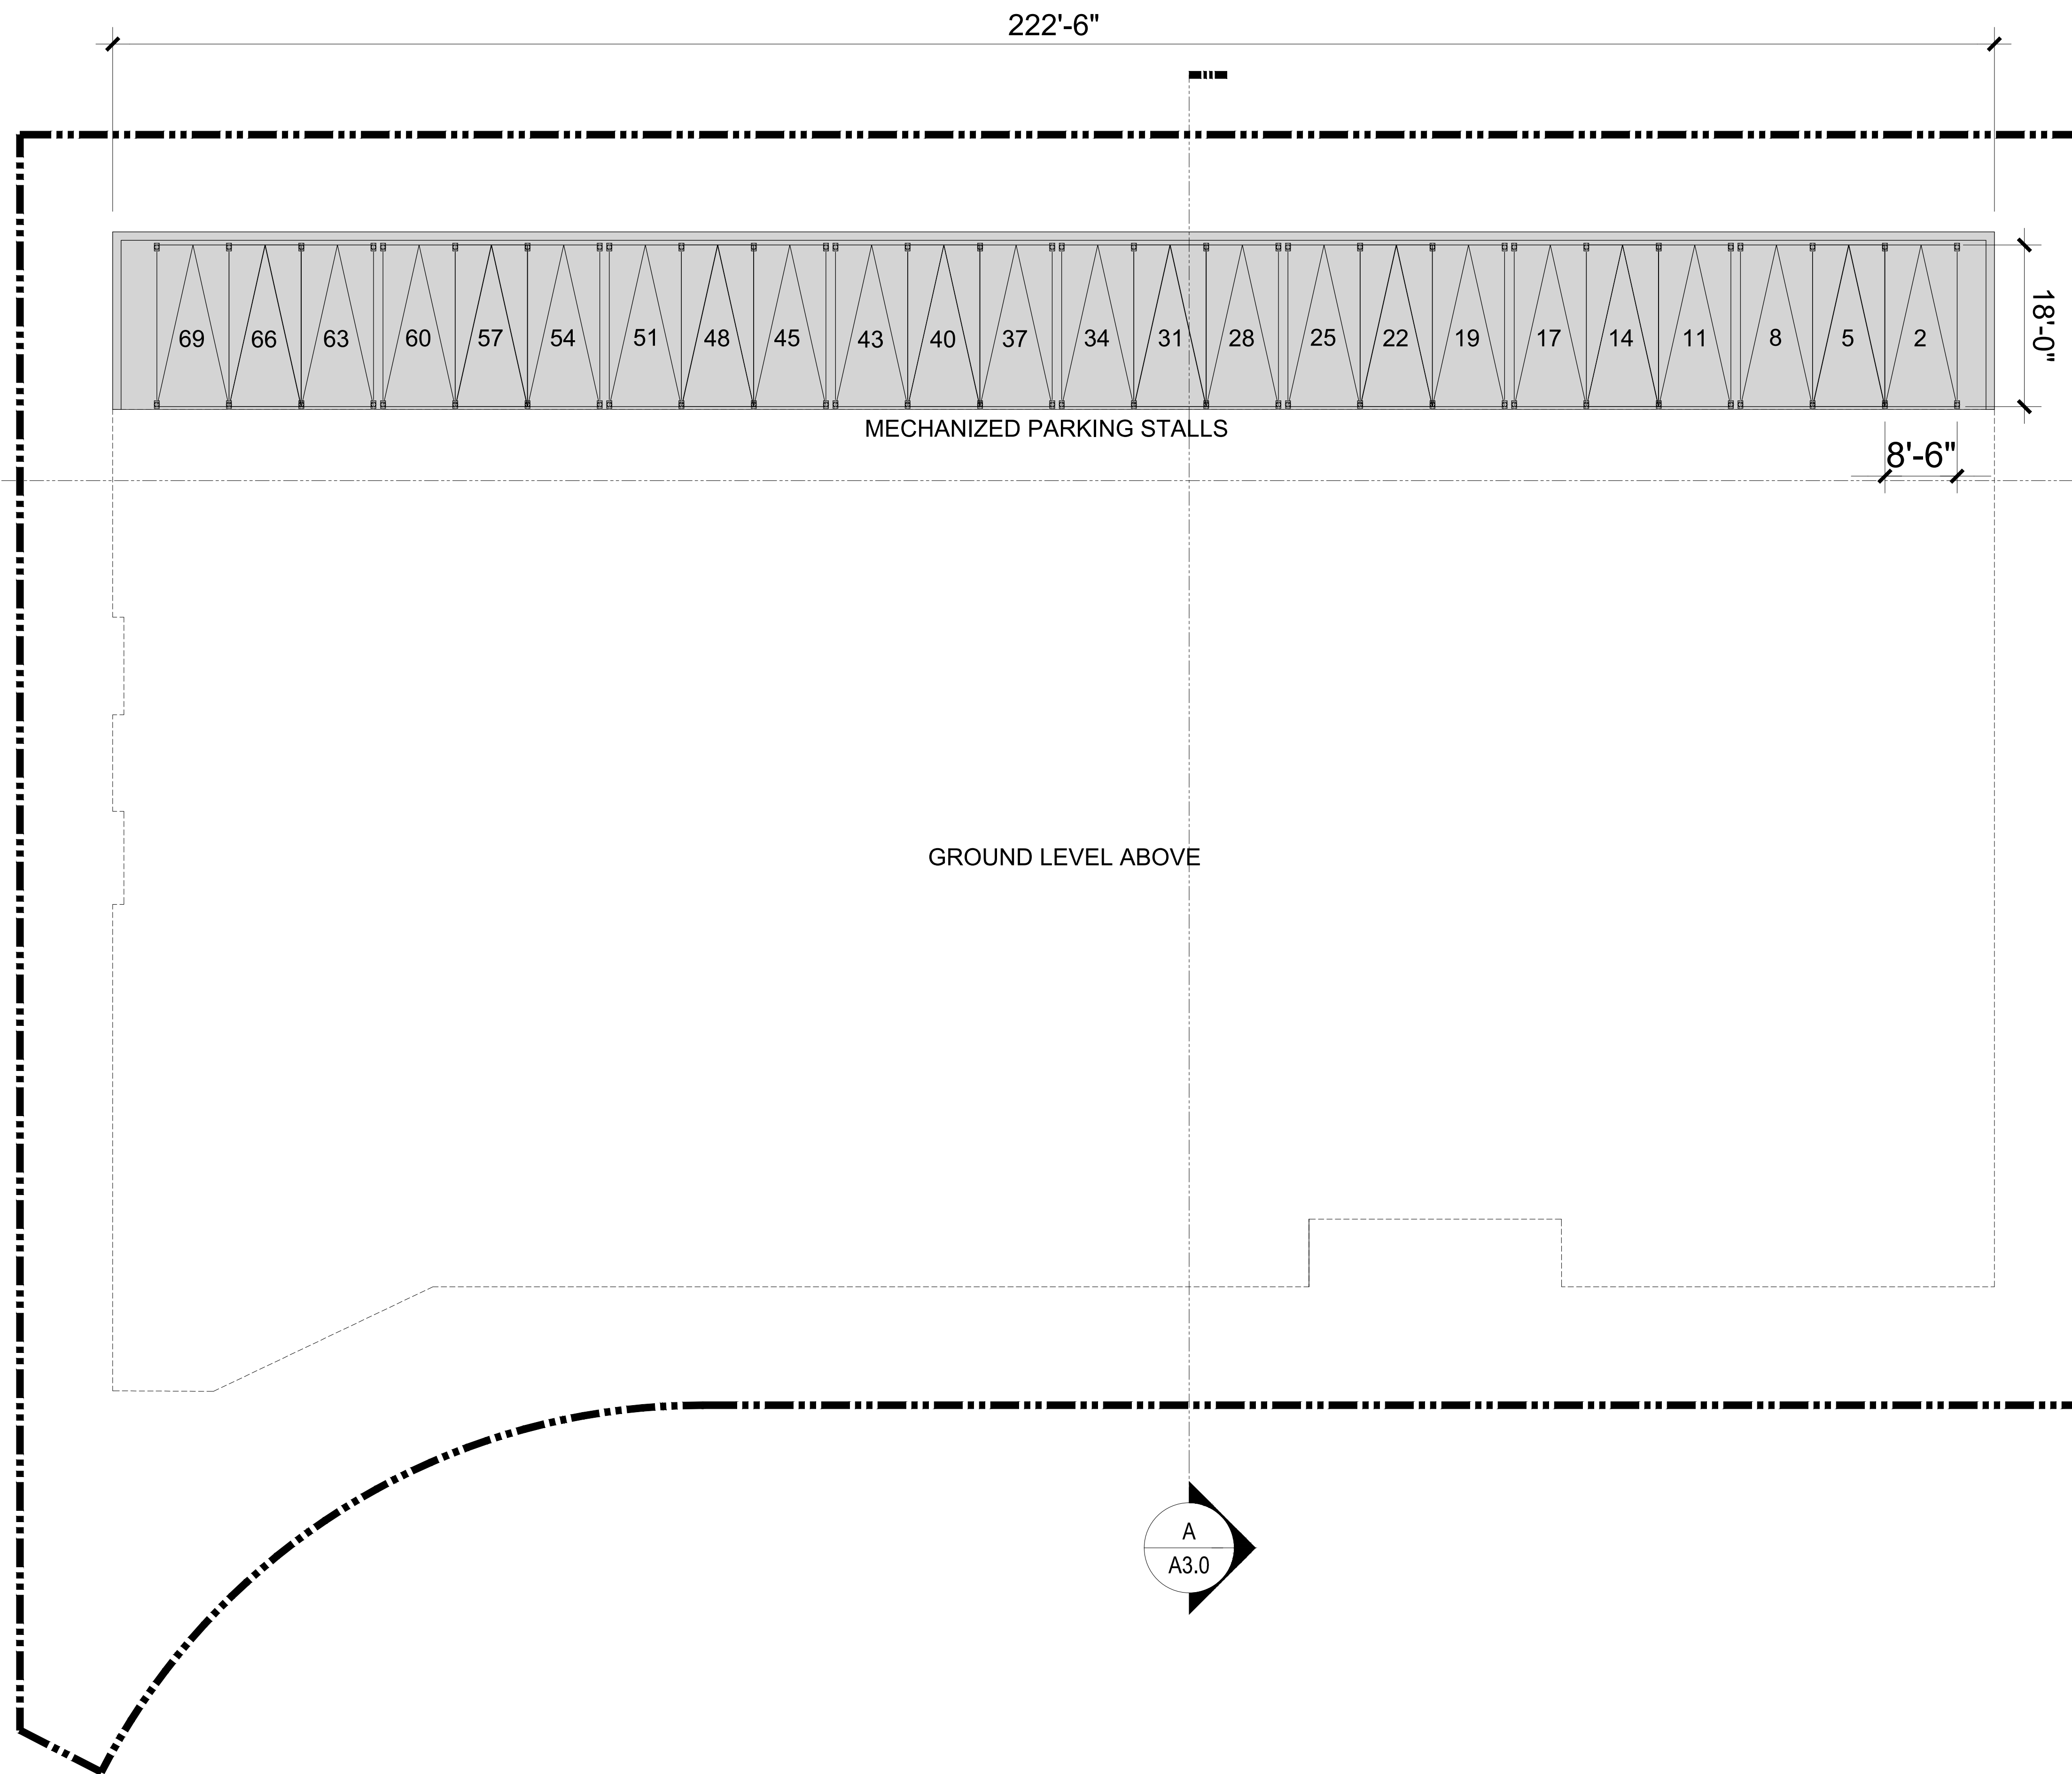


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SUSTAINABLE STRATEGIES

A1.4



B  
A3.0

A  
A3.0




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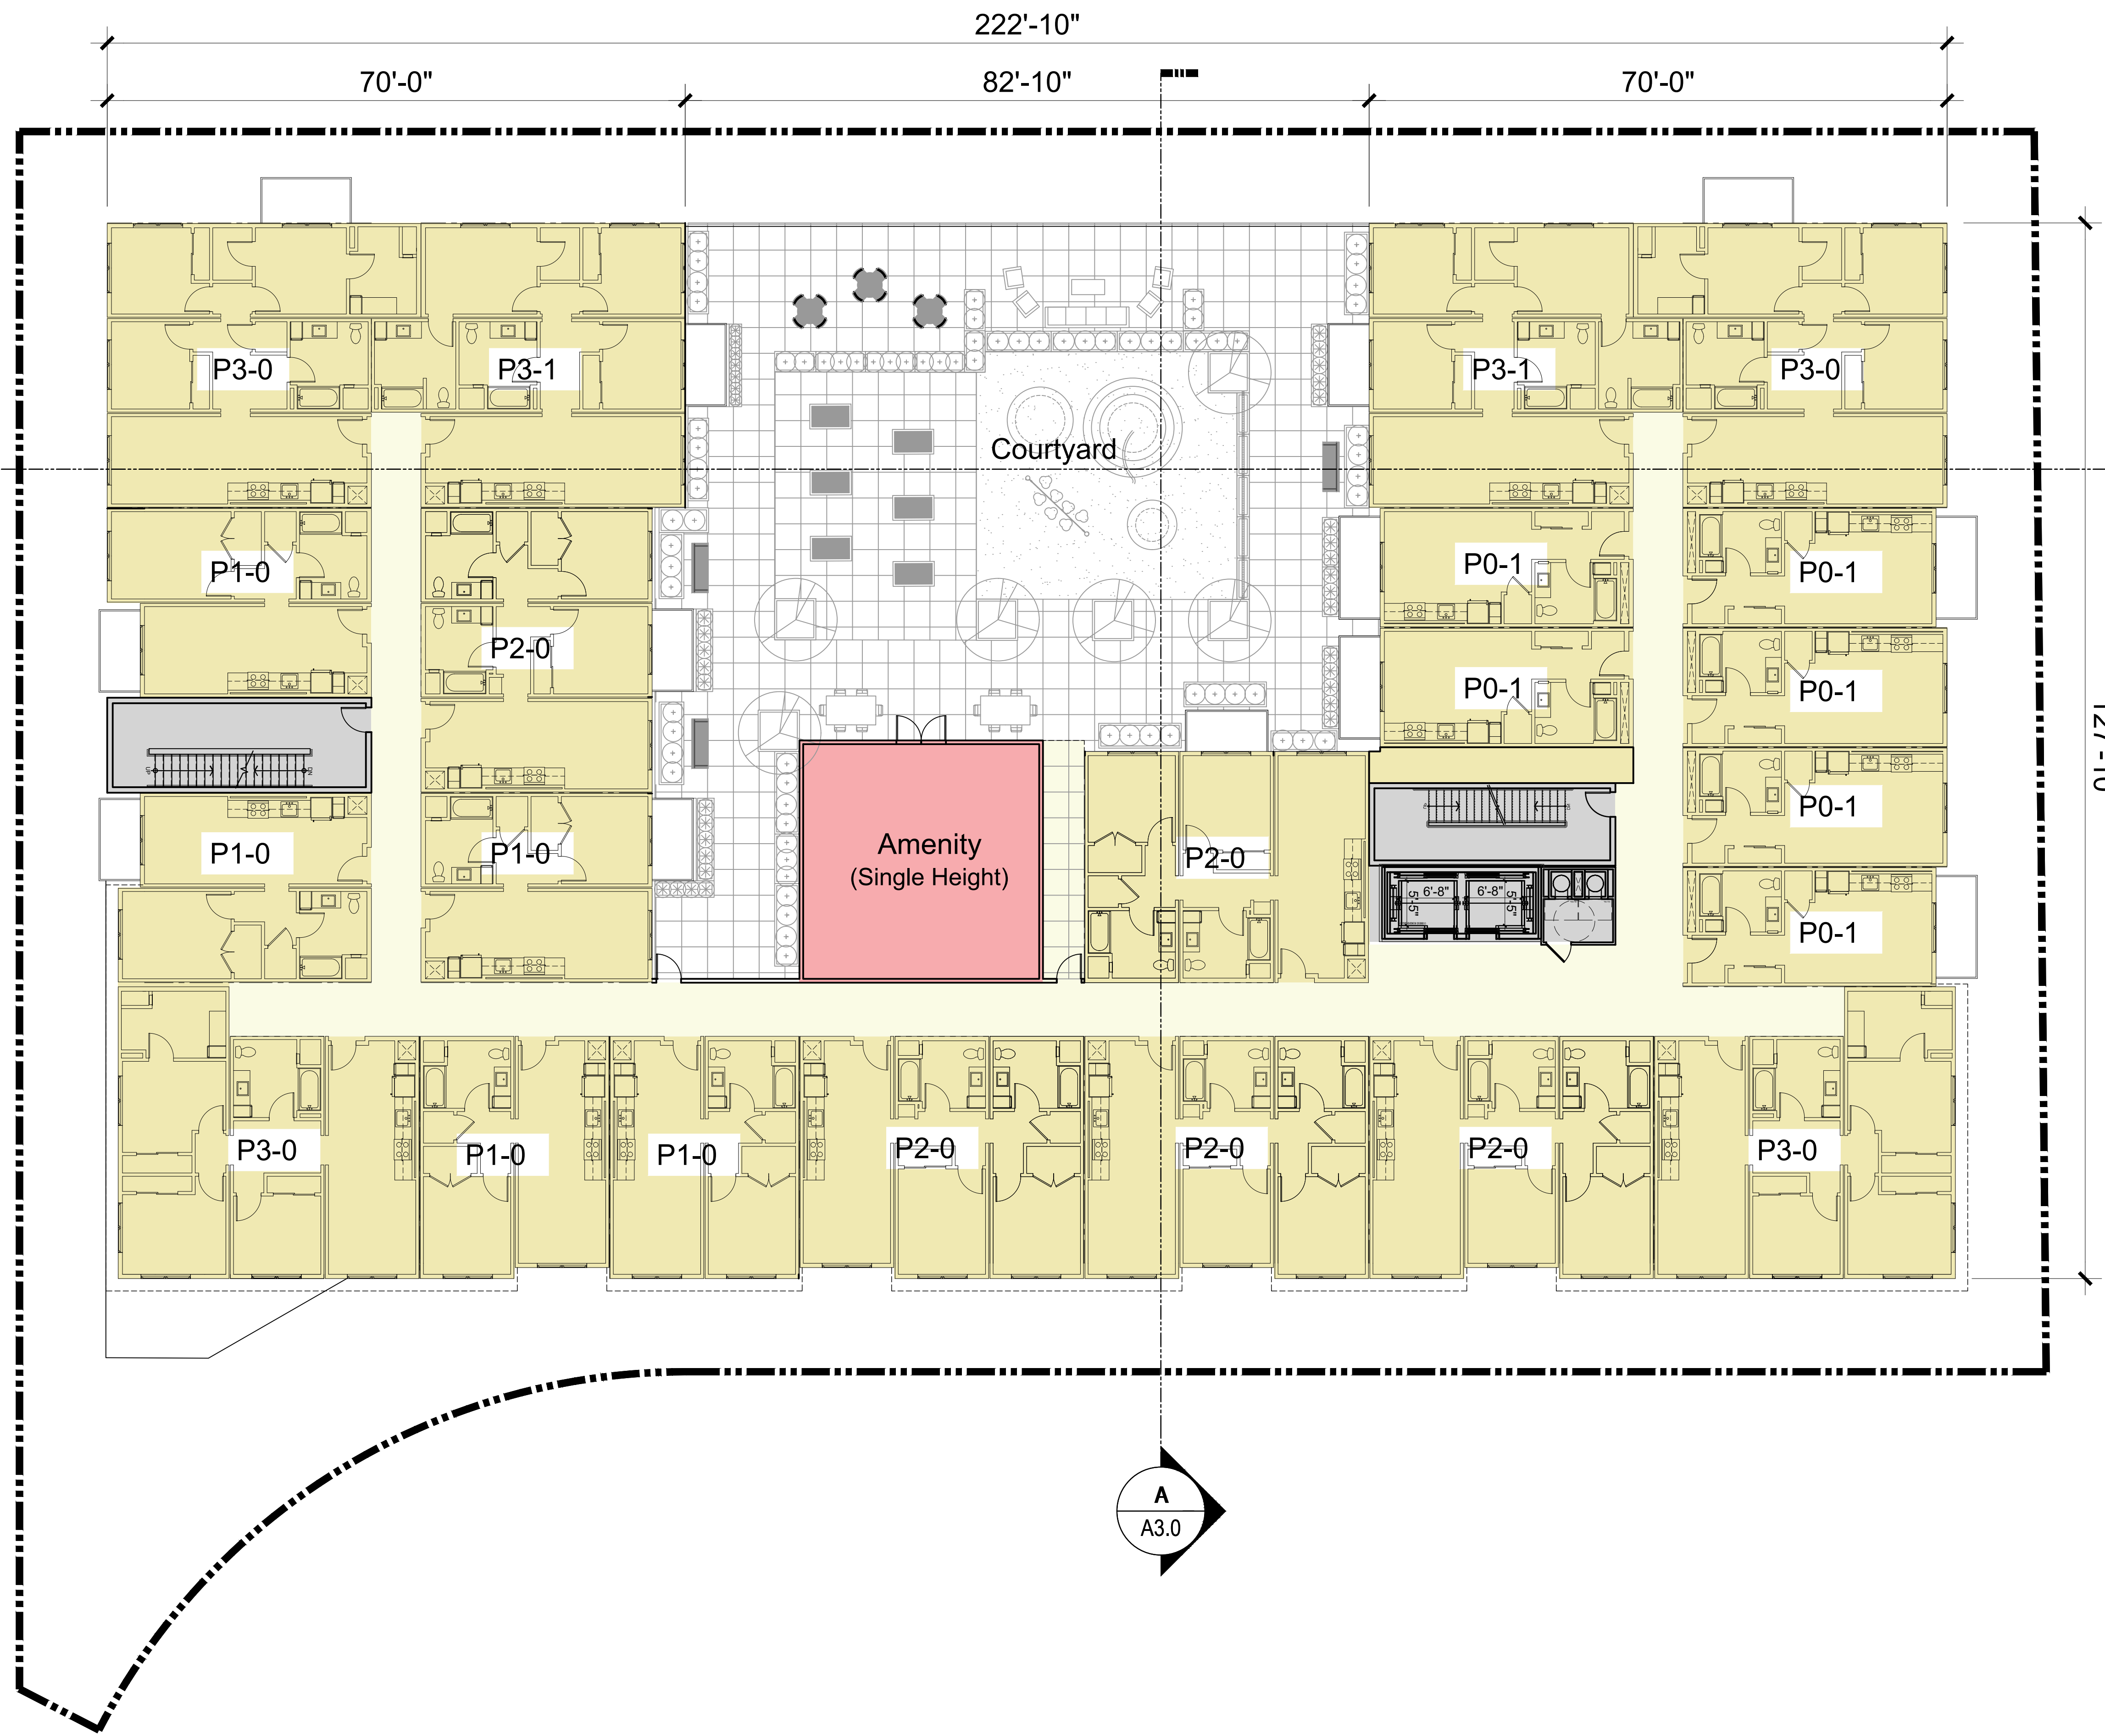


BUILDING PLAN  
SUBTERRANEAN LEVEL

A2.0

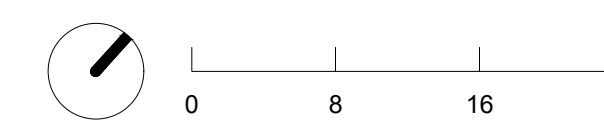

\*EVR = EV Ready Stalls  
 \*HC = Accessible Stalls




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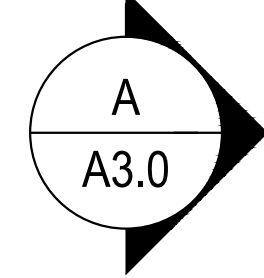
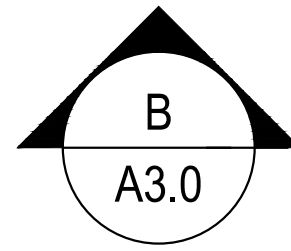
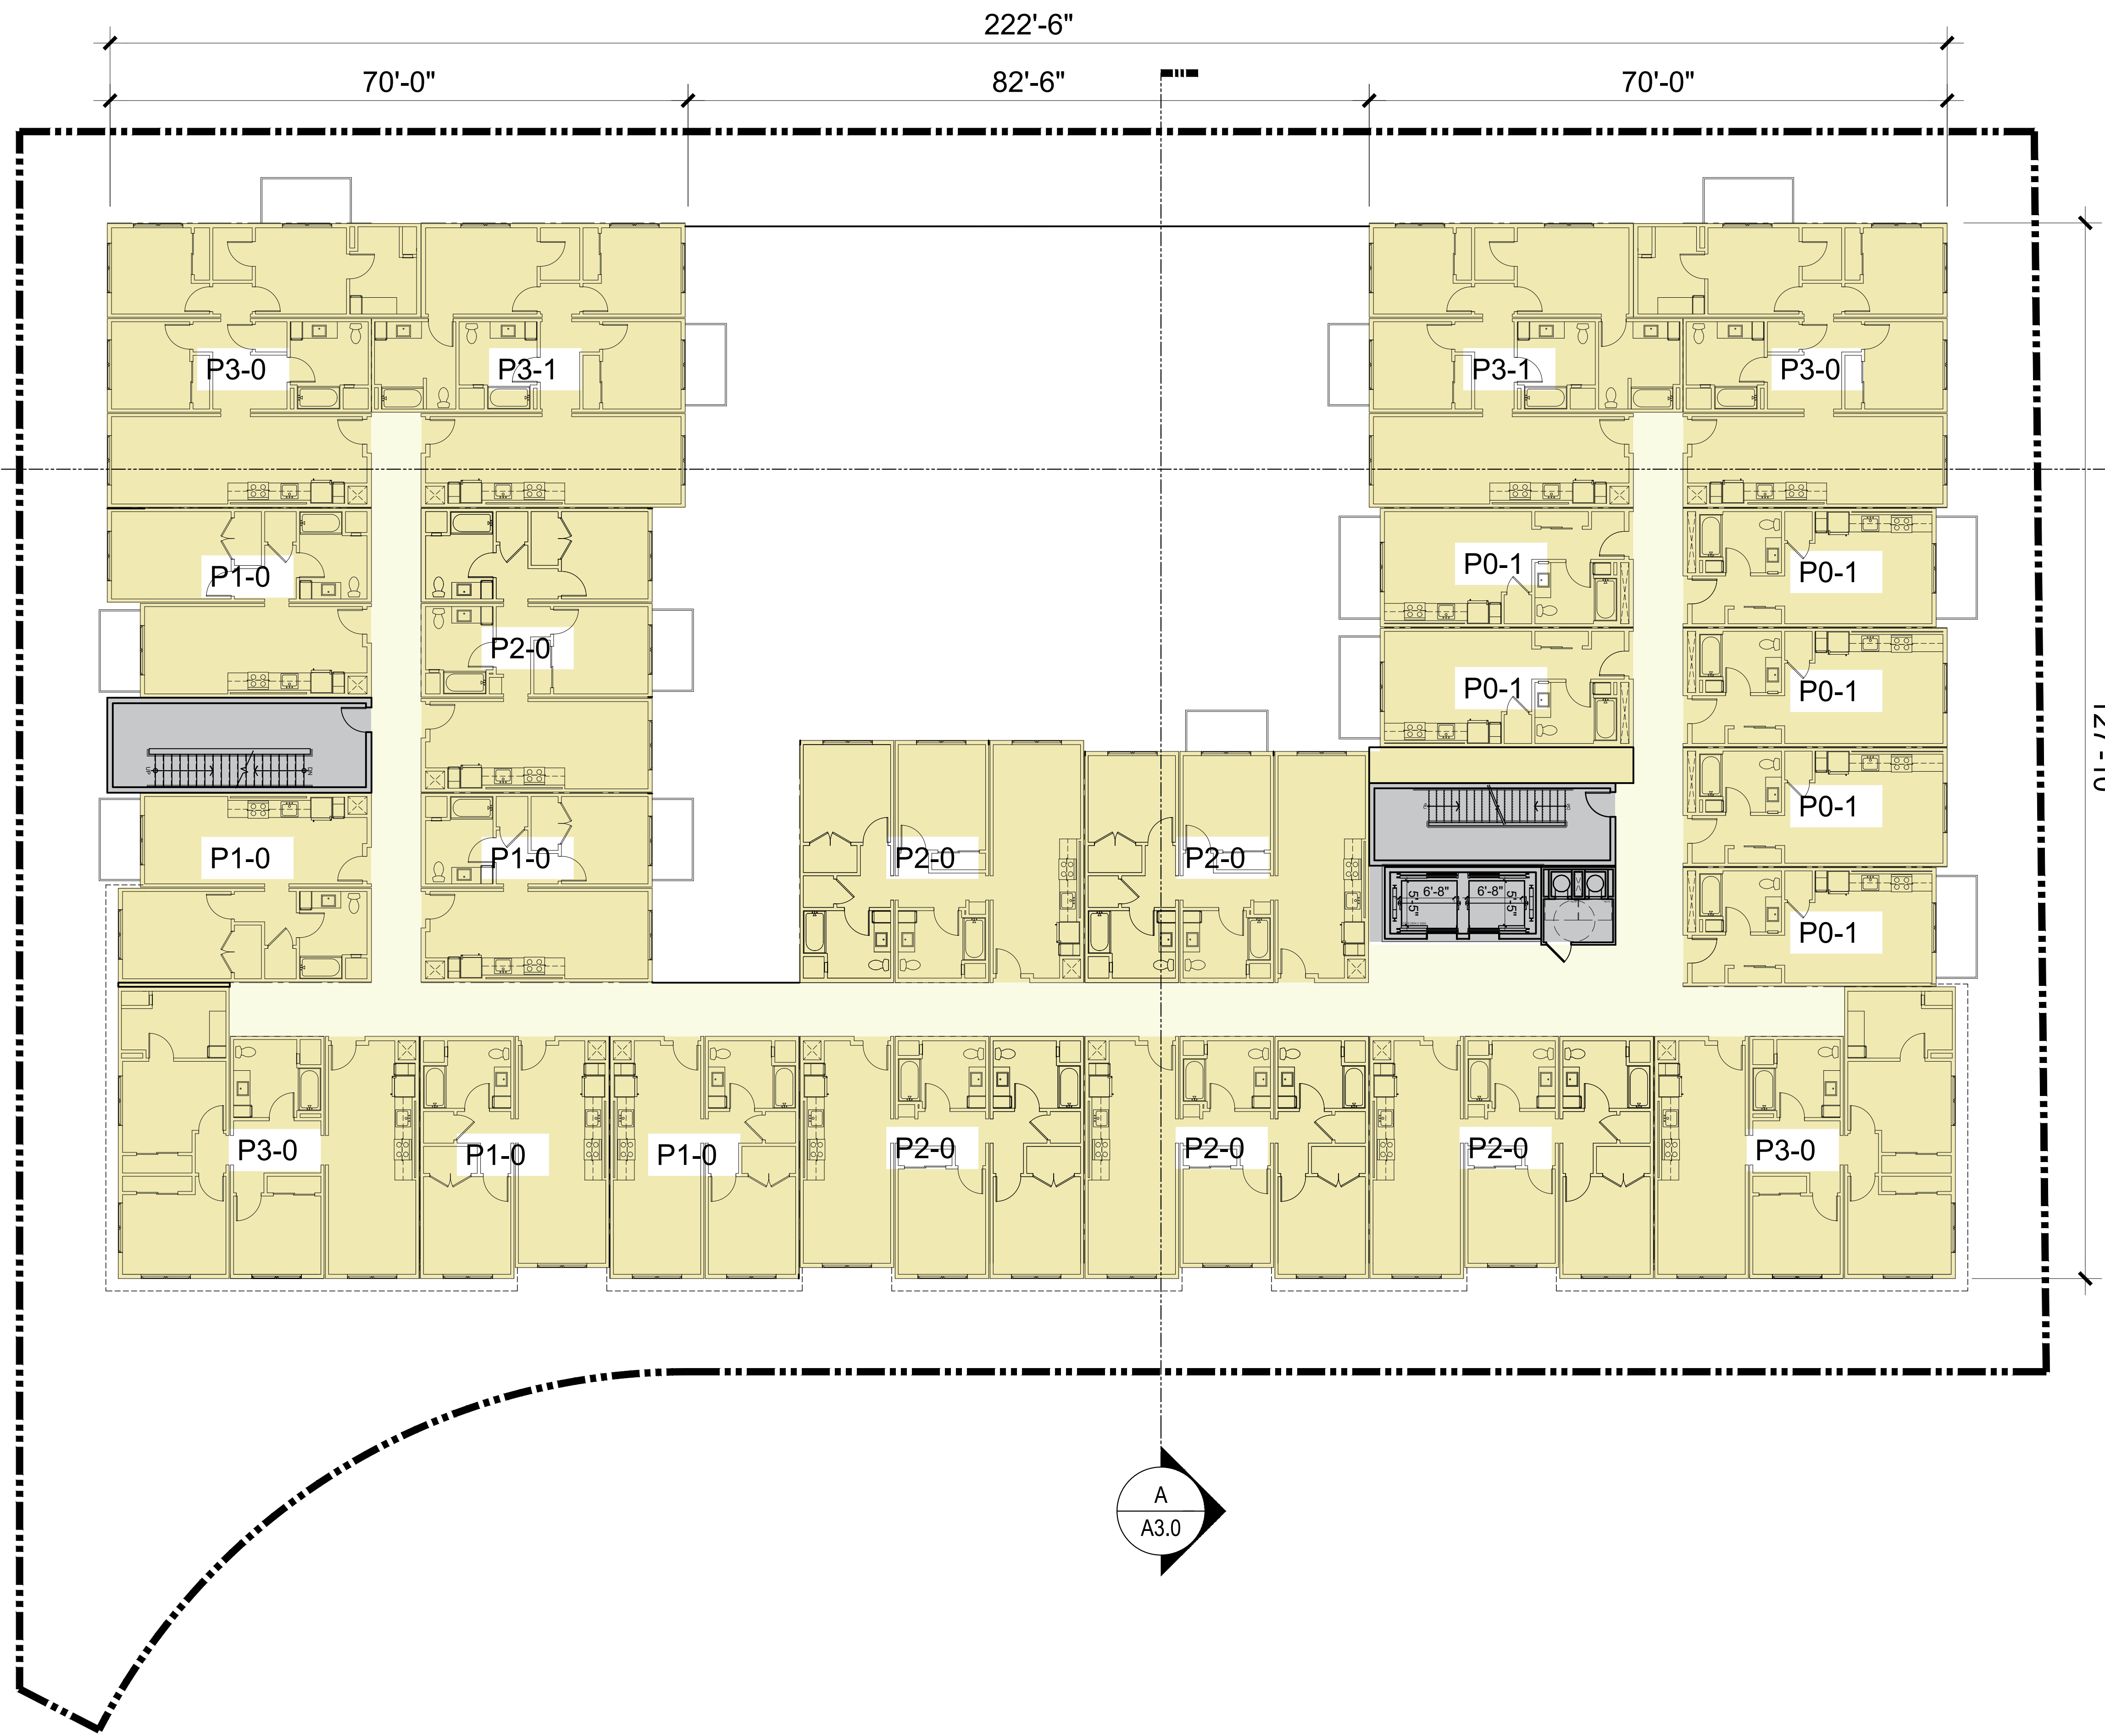
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**BUILDING PLAN**  
 LEVEL 2

**A2.2**



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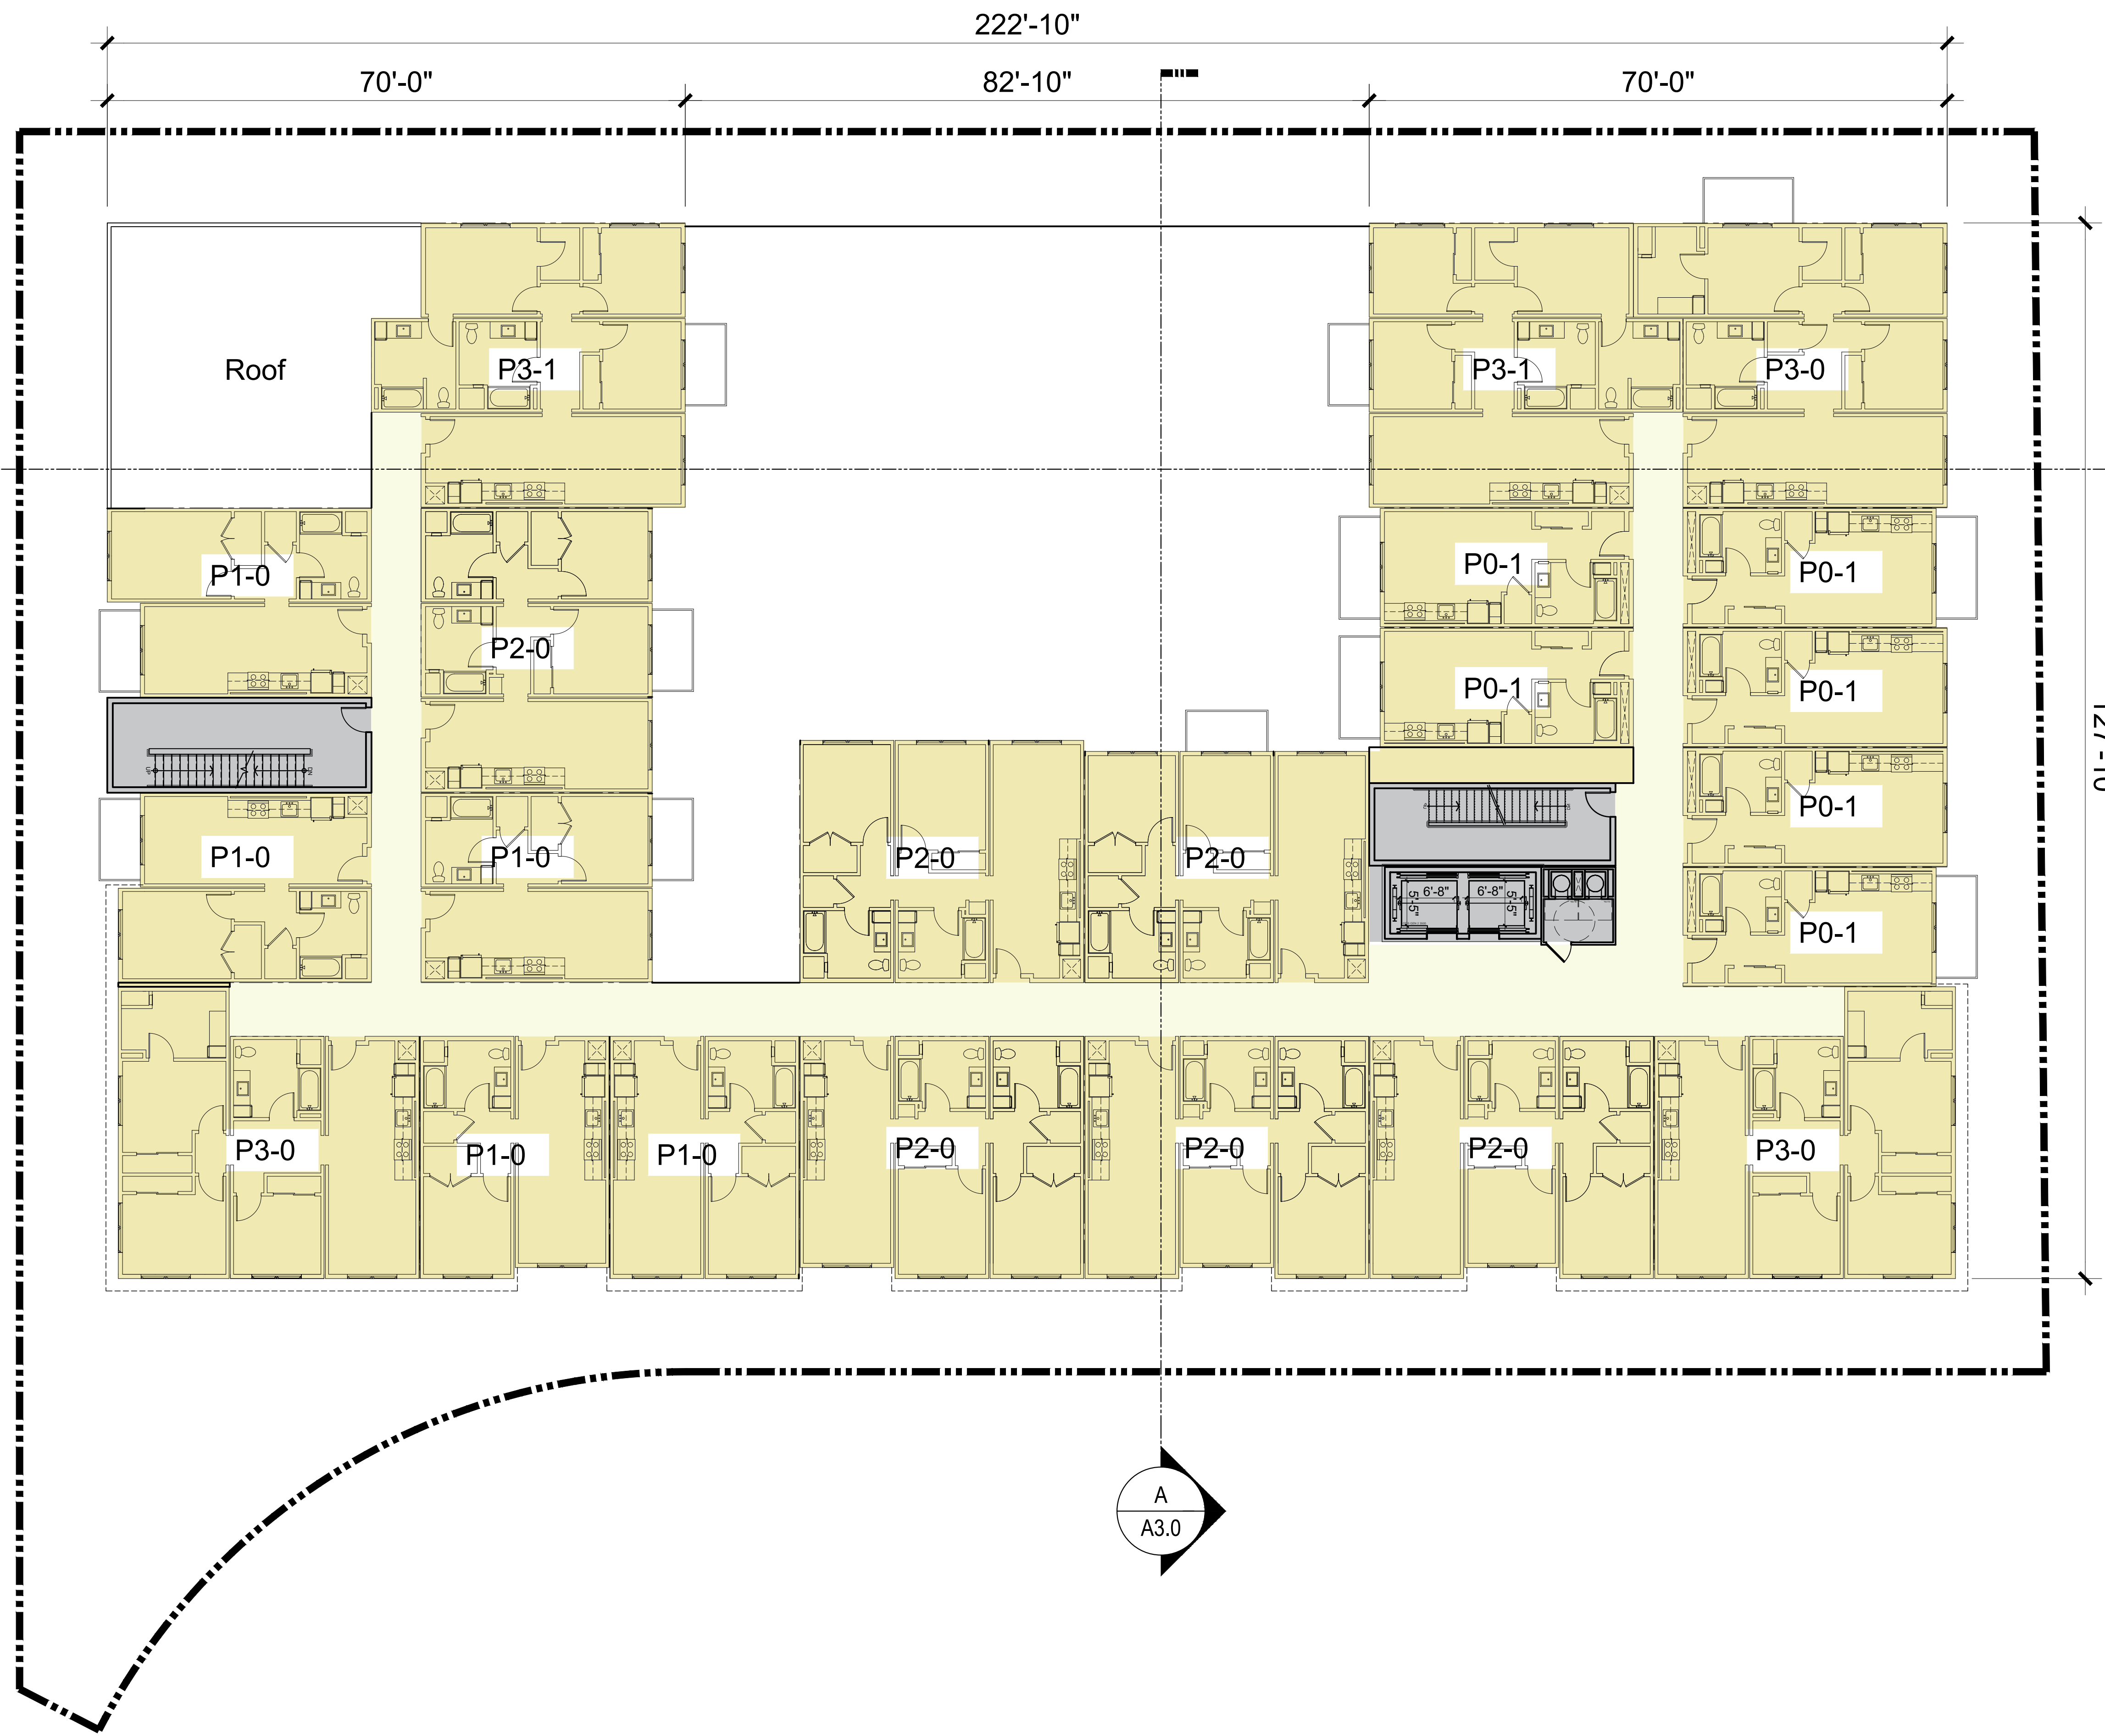
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**BUILDING PLAN**  
 LEVELS 3-4

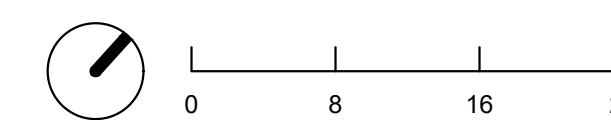**A2.3**





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**BUILDING PLAN**  
LEVEL 5




**A2.4**

222'-10"

127'-10"

**LEGEND**

- Roof Screen
- AC Condenser

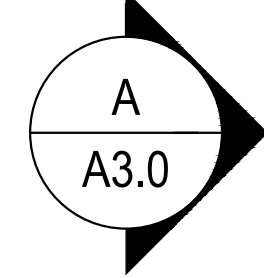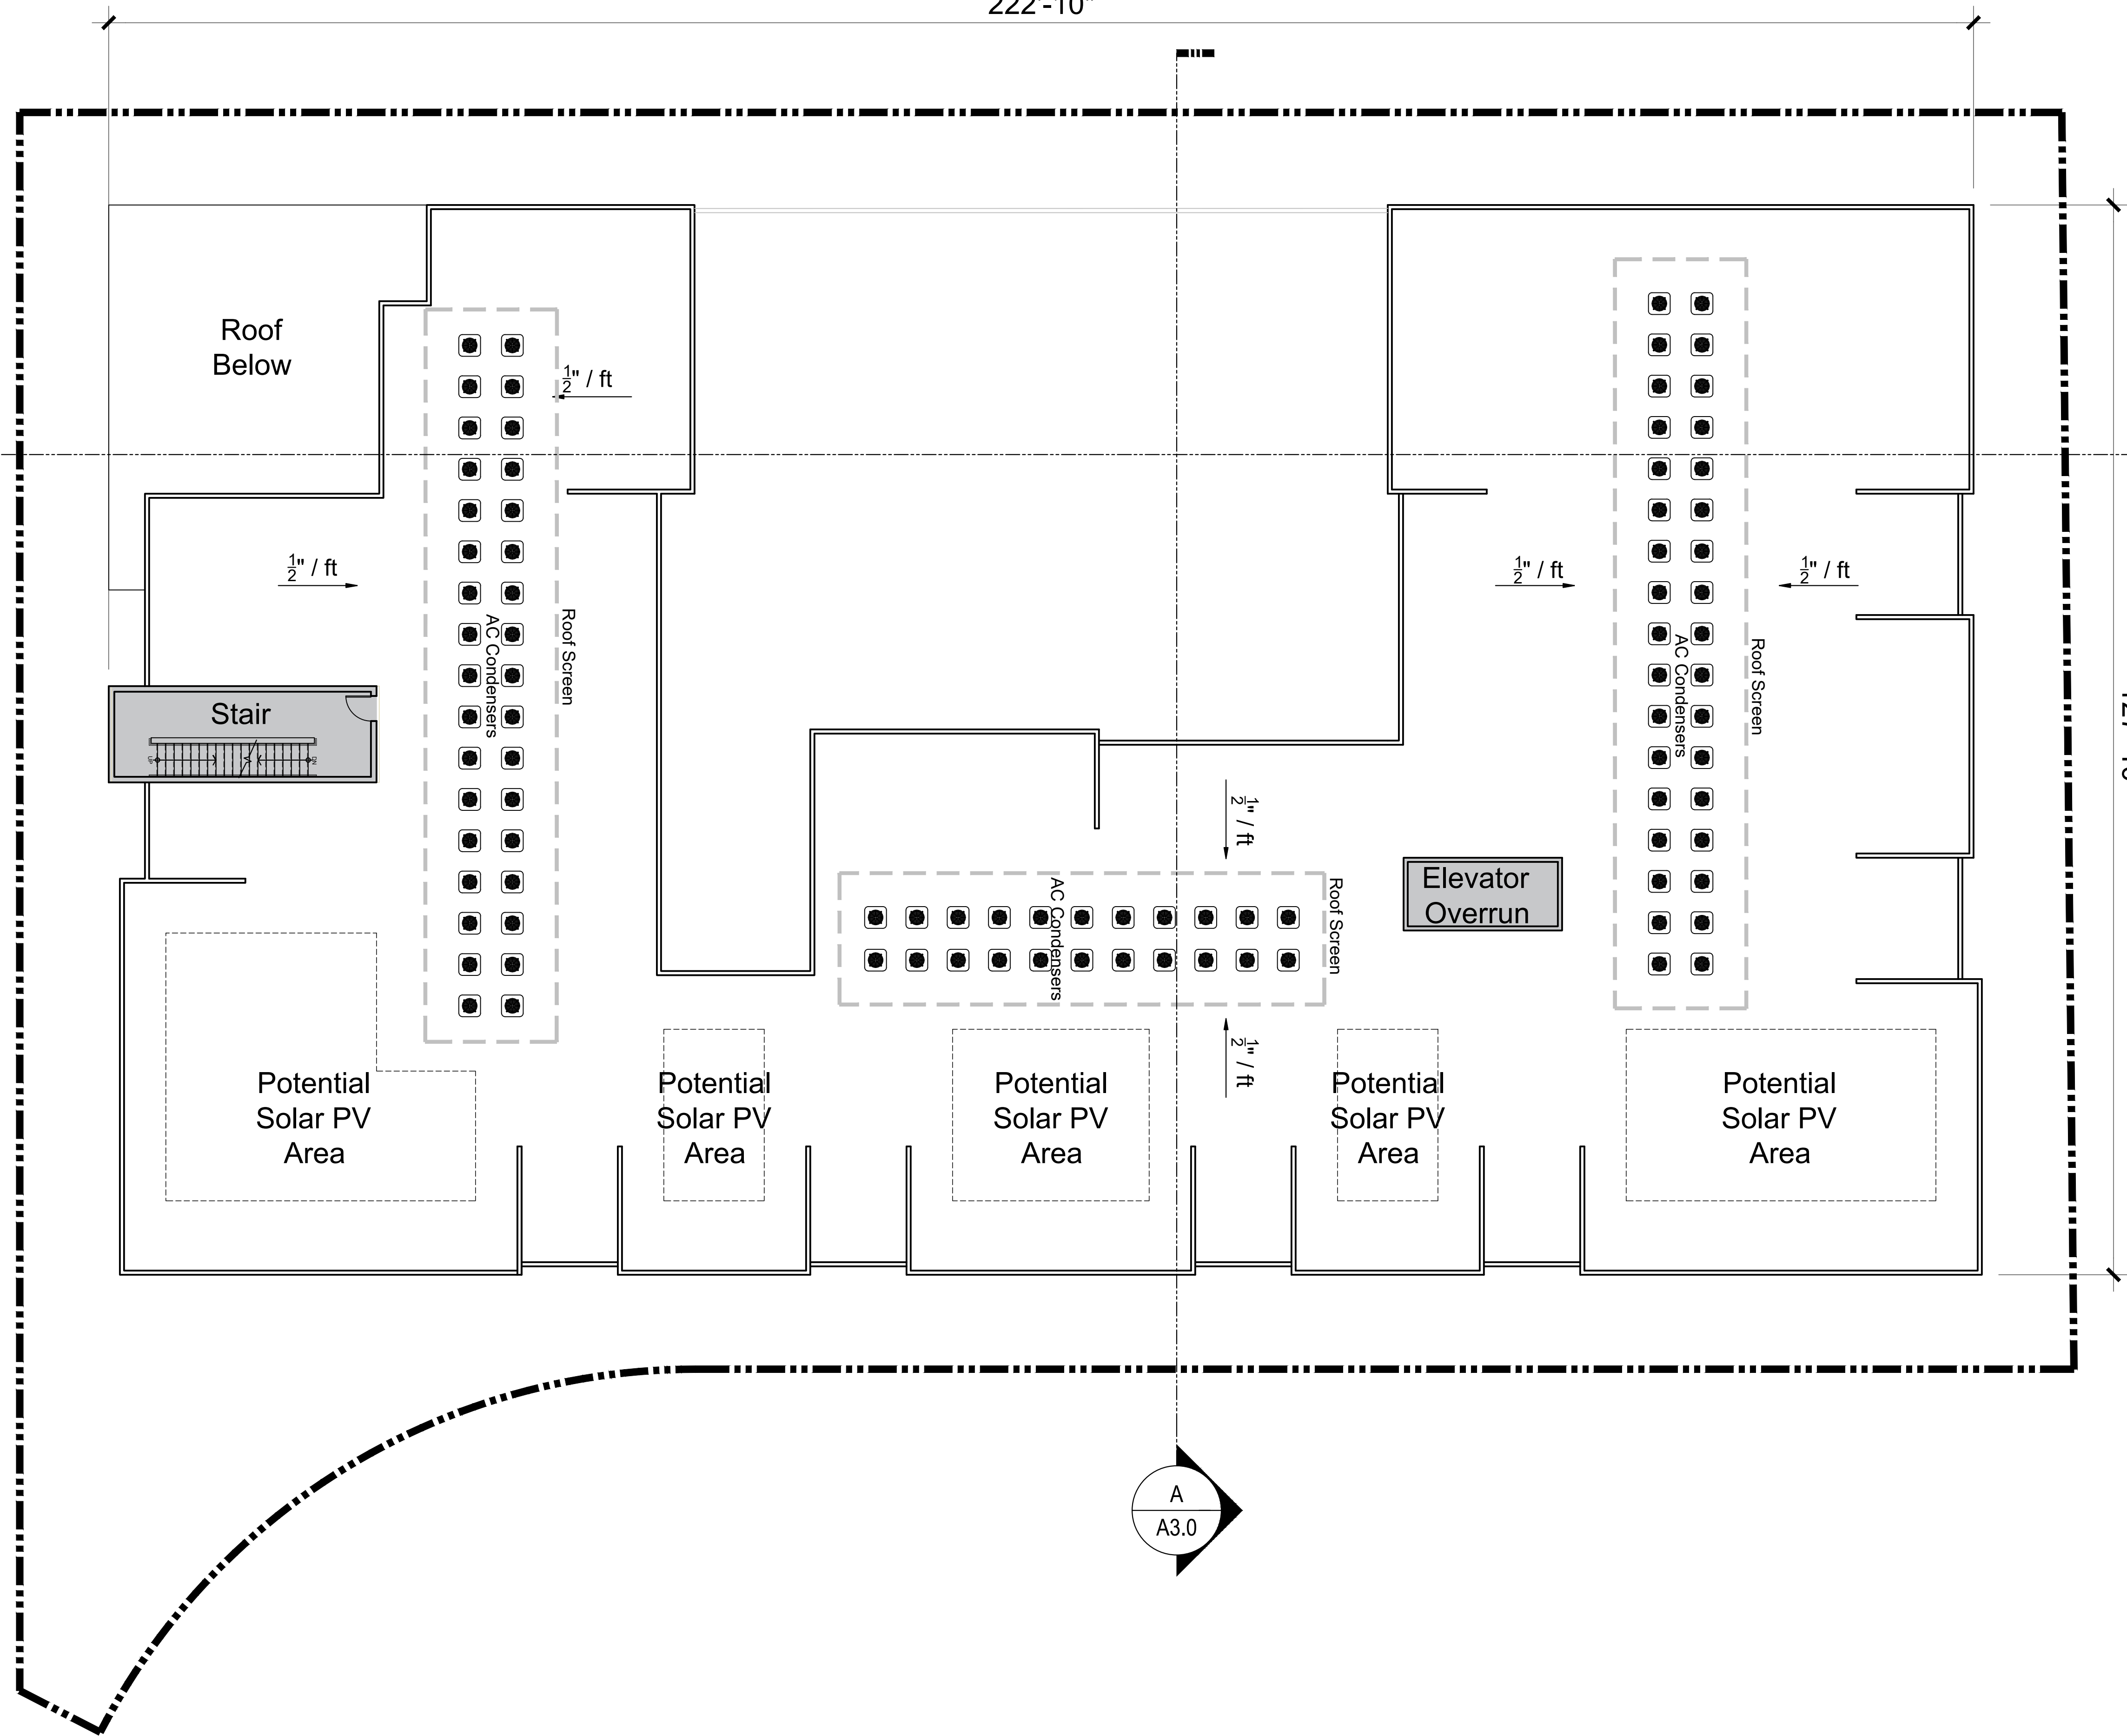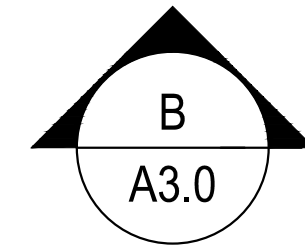

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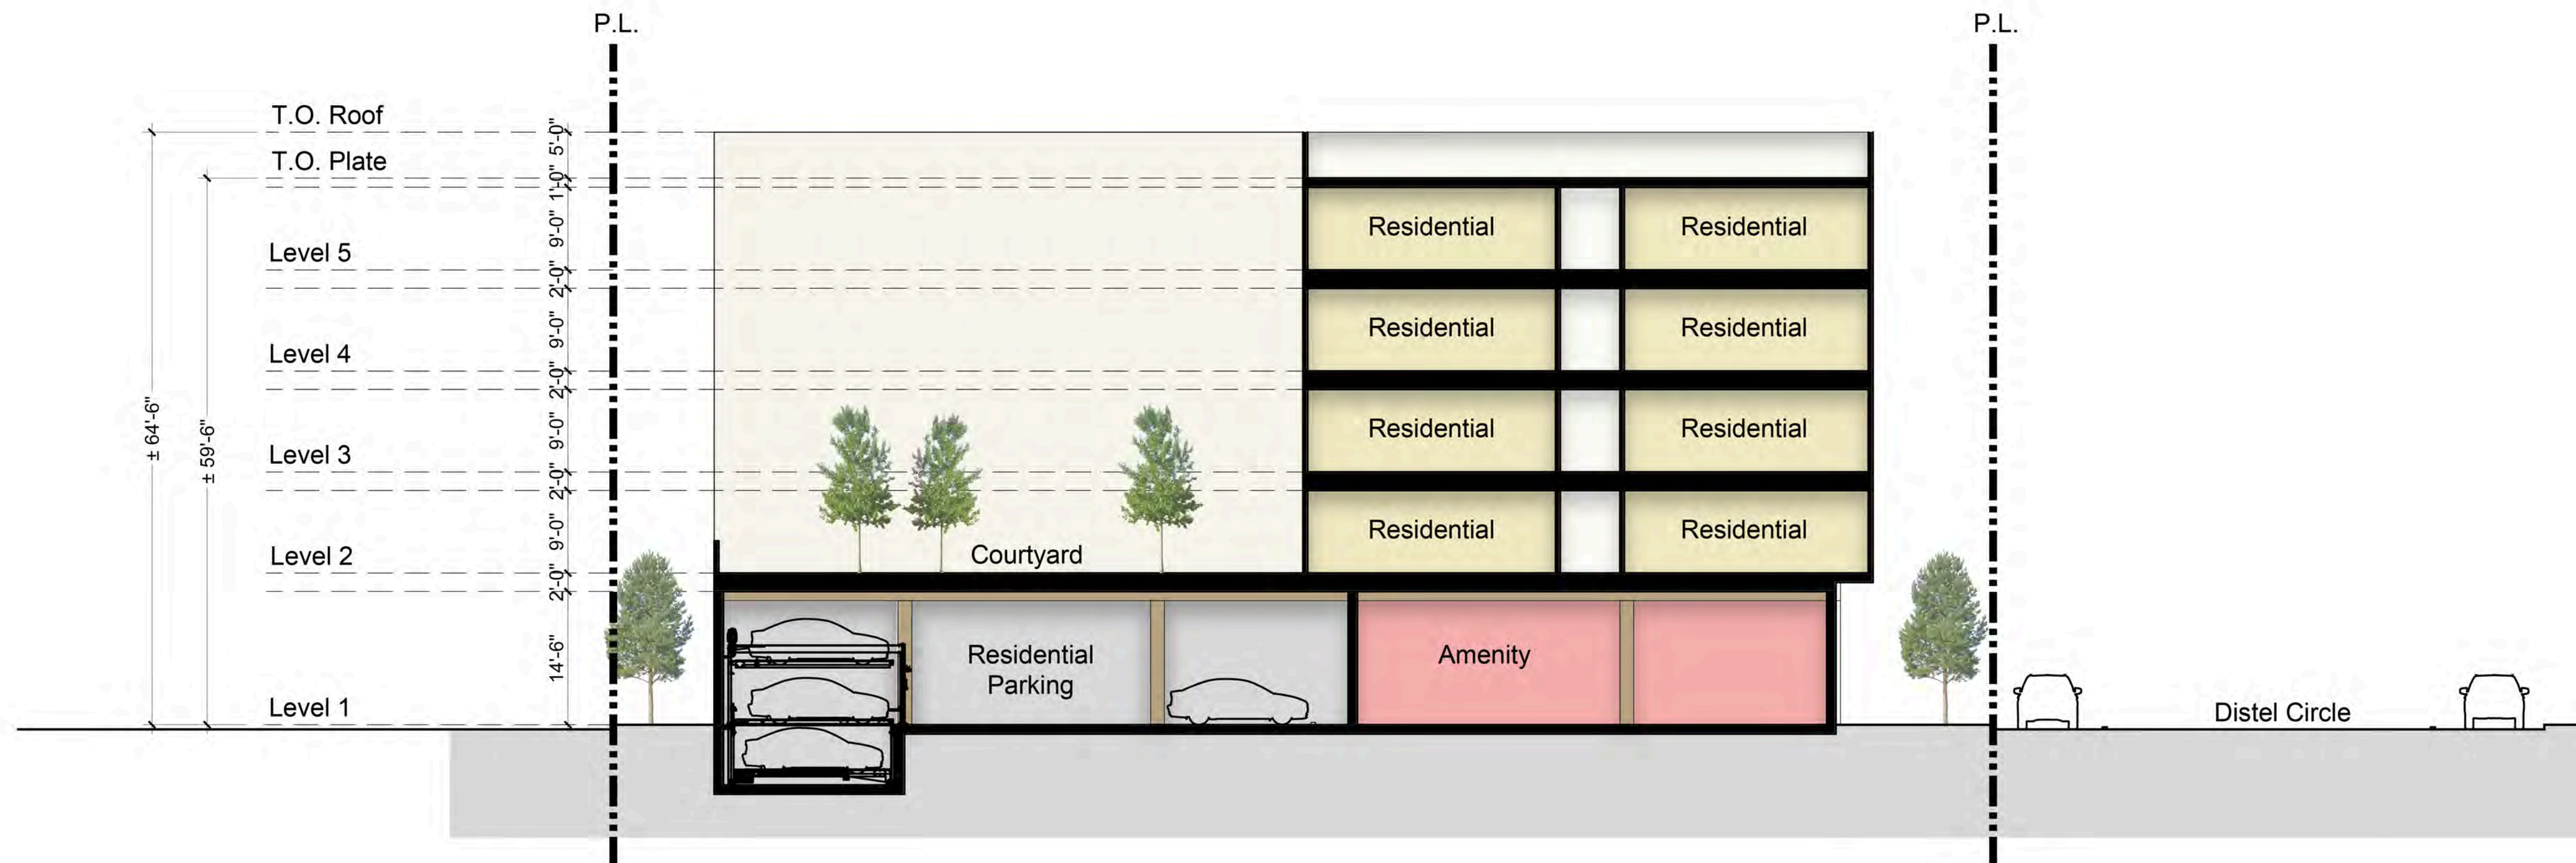
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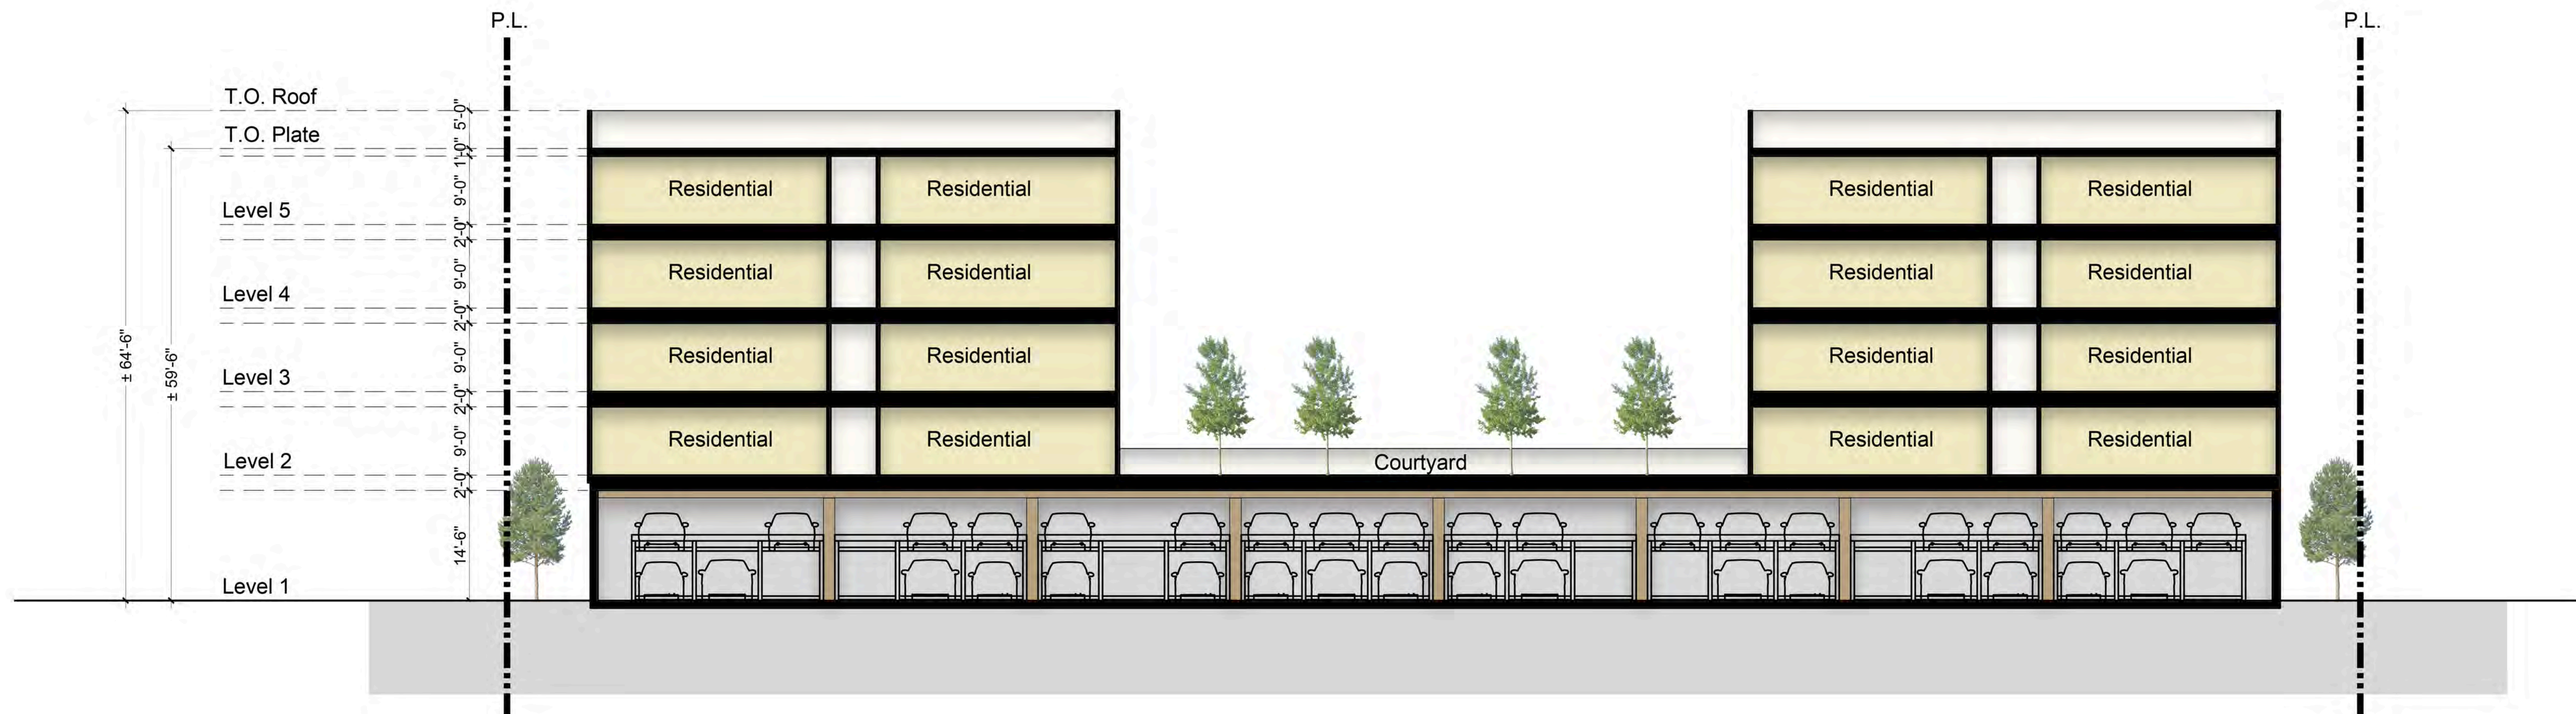
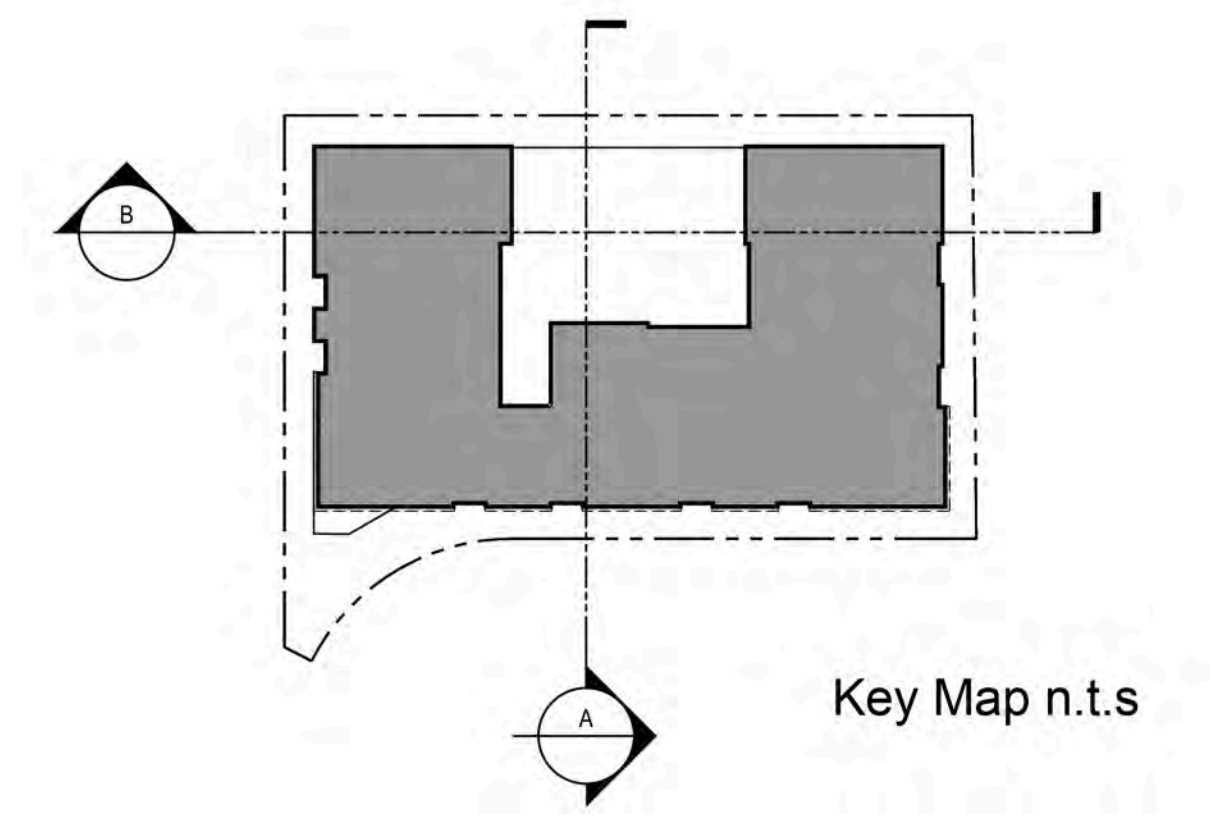


ROOF PLAN


**A2.5**



Section A



Section B

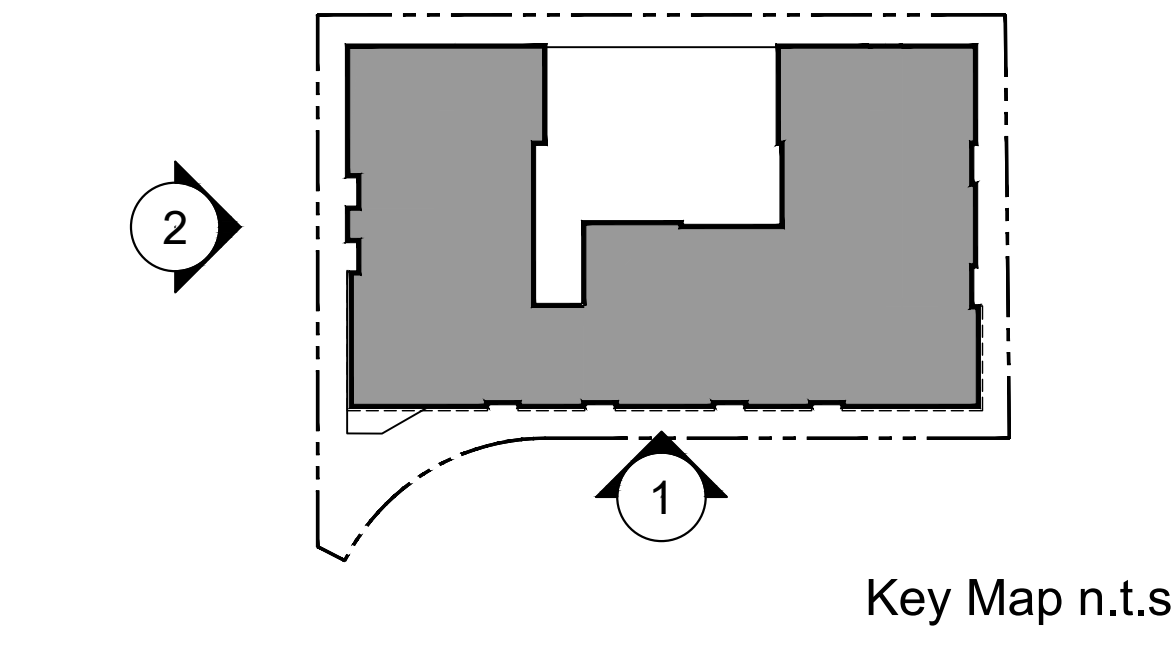


- Material Legend:**
- 1. Stucco
  - 2. Wood
  - 3. Metal Window
  - 4. Wood Composite Railing
  - 5. Metal Solar Shade
  - 6. Metal Awning
  - 7. Metal Screen
  - 8. Vinyl Window
  - 9. Wood Composite Panel

2. Side Elevation



1. Distel Drive Elevation

\*Reference landscape sheets L1.1 - L3.1 for fencing details.

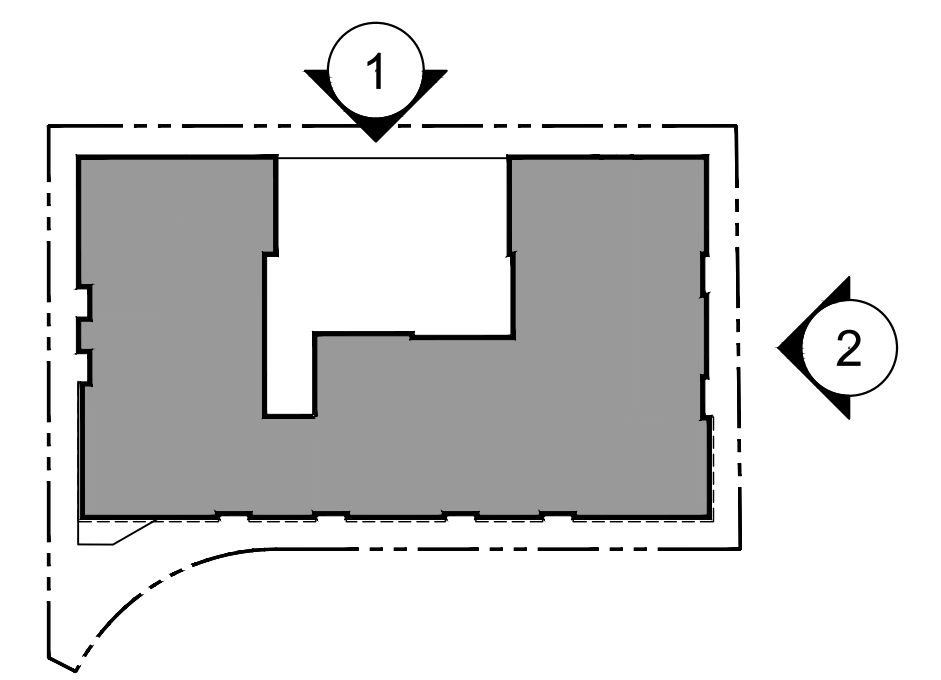

Key Map n.t.s

Material Legend:

- 1. Stucco
- 2. Wood
- 3. Metal Window
- 4. Wood Composite Railing
- 5. Metal Solar Shade
- 6. Metal Awning
- 7. Metal Screen
- 8. Vinyl Window
- 9. Wood Composite Panel

2. Side Elevation




1. Rear Elevation

\*Reference landscape sheets L1.1 - L3.1 for fencing details.



1. Stucco

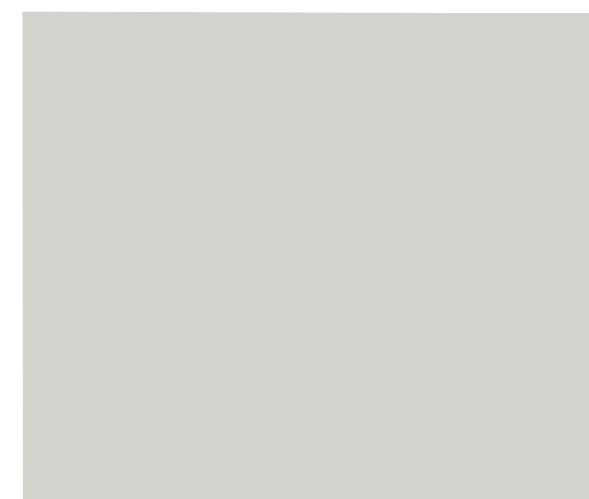

2. Stucco




3. Stucco



4. Stucco




5. Wood

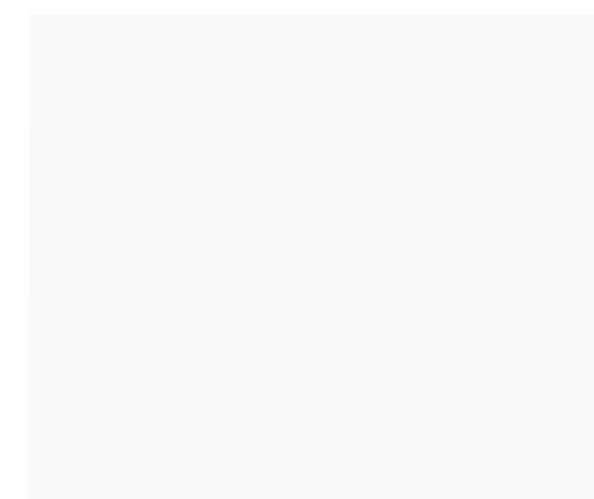


6. Metal Window - White



7. Storefront

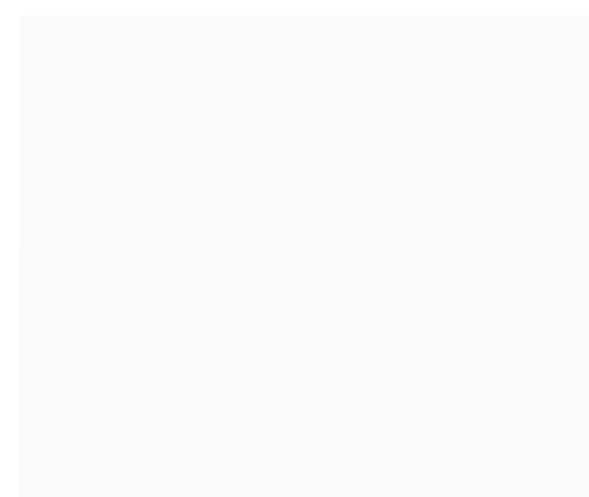

8. Vinyl Window - White

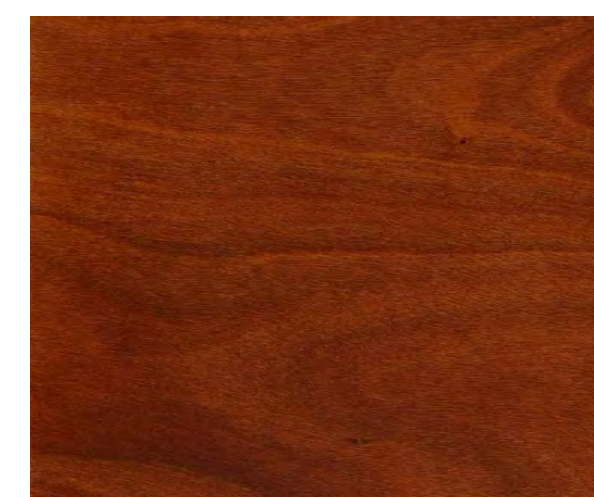


9. Wood Composite Railing / Panel



10. Metal Solar Shade



11. Metal Awning

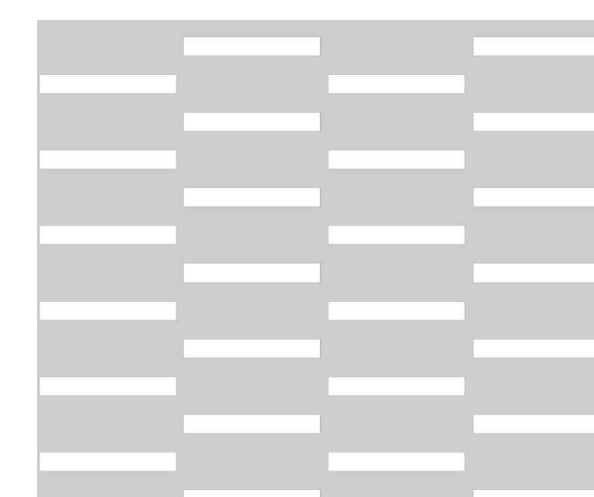


12. Metal Screen



13. Metal Screen



2. Side Elevation

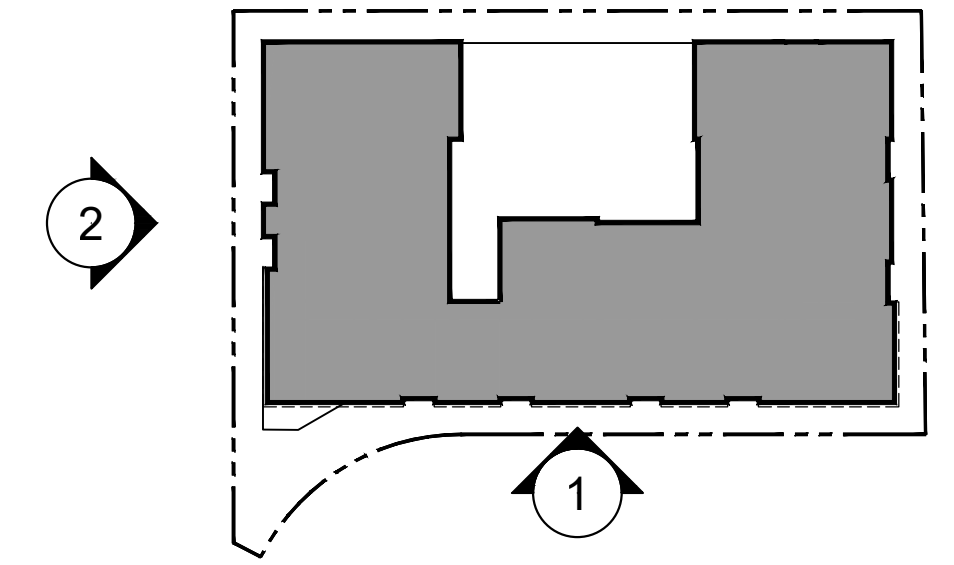

Key Map n.t.s



1. Distel Drive Elevation

\*Reference the Los Altos Objective Design Standards




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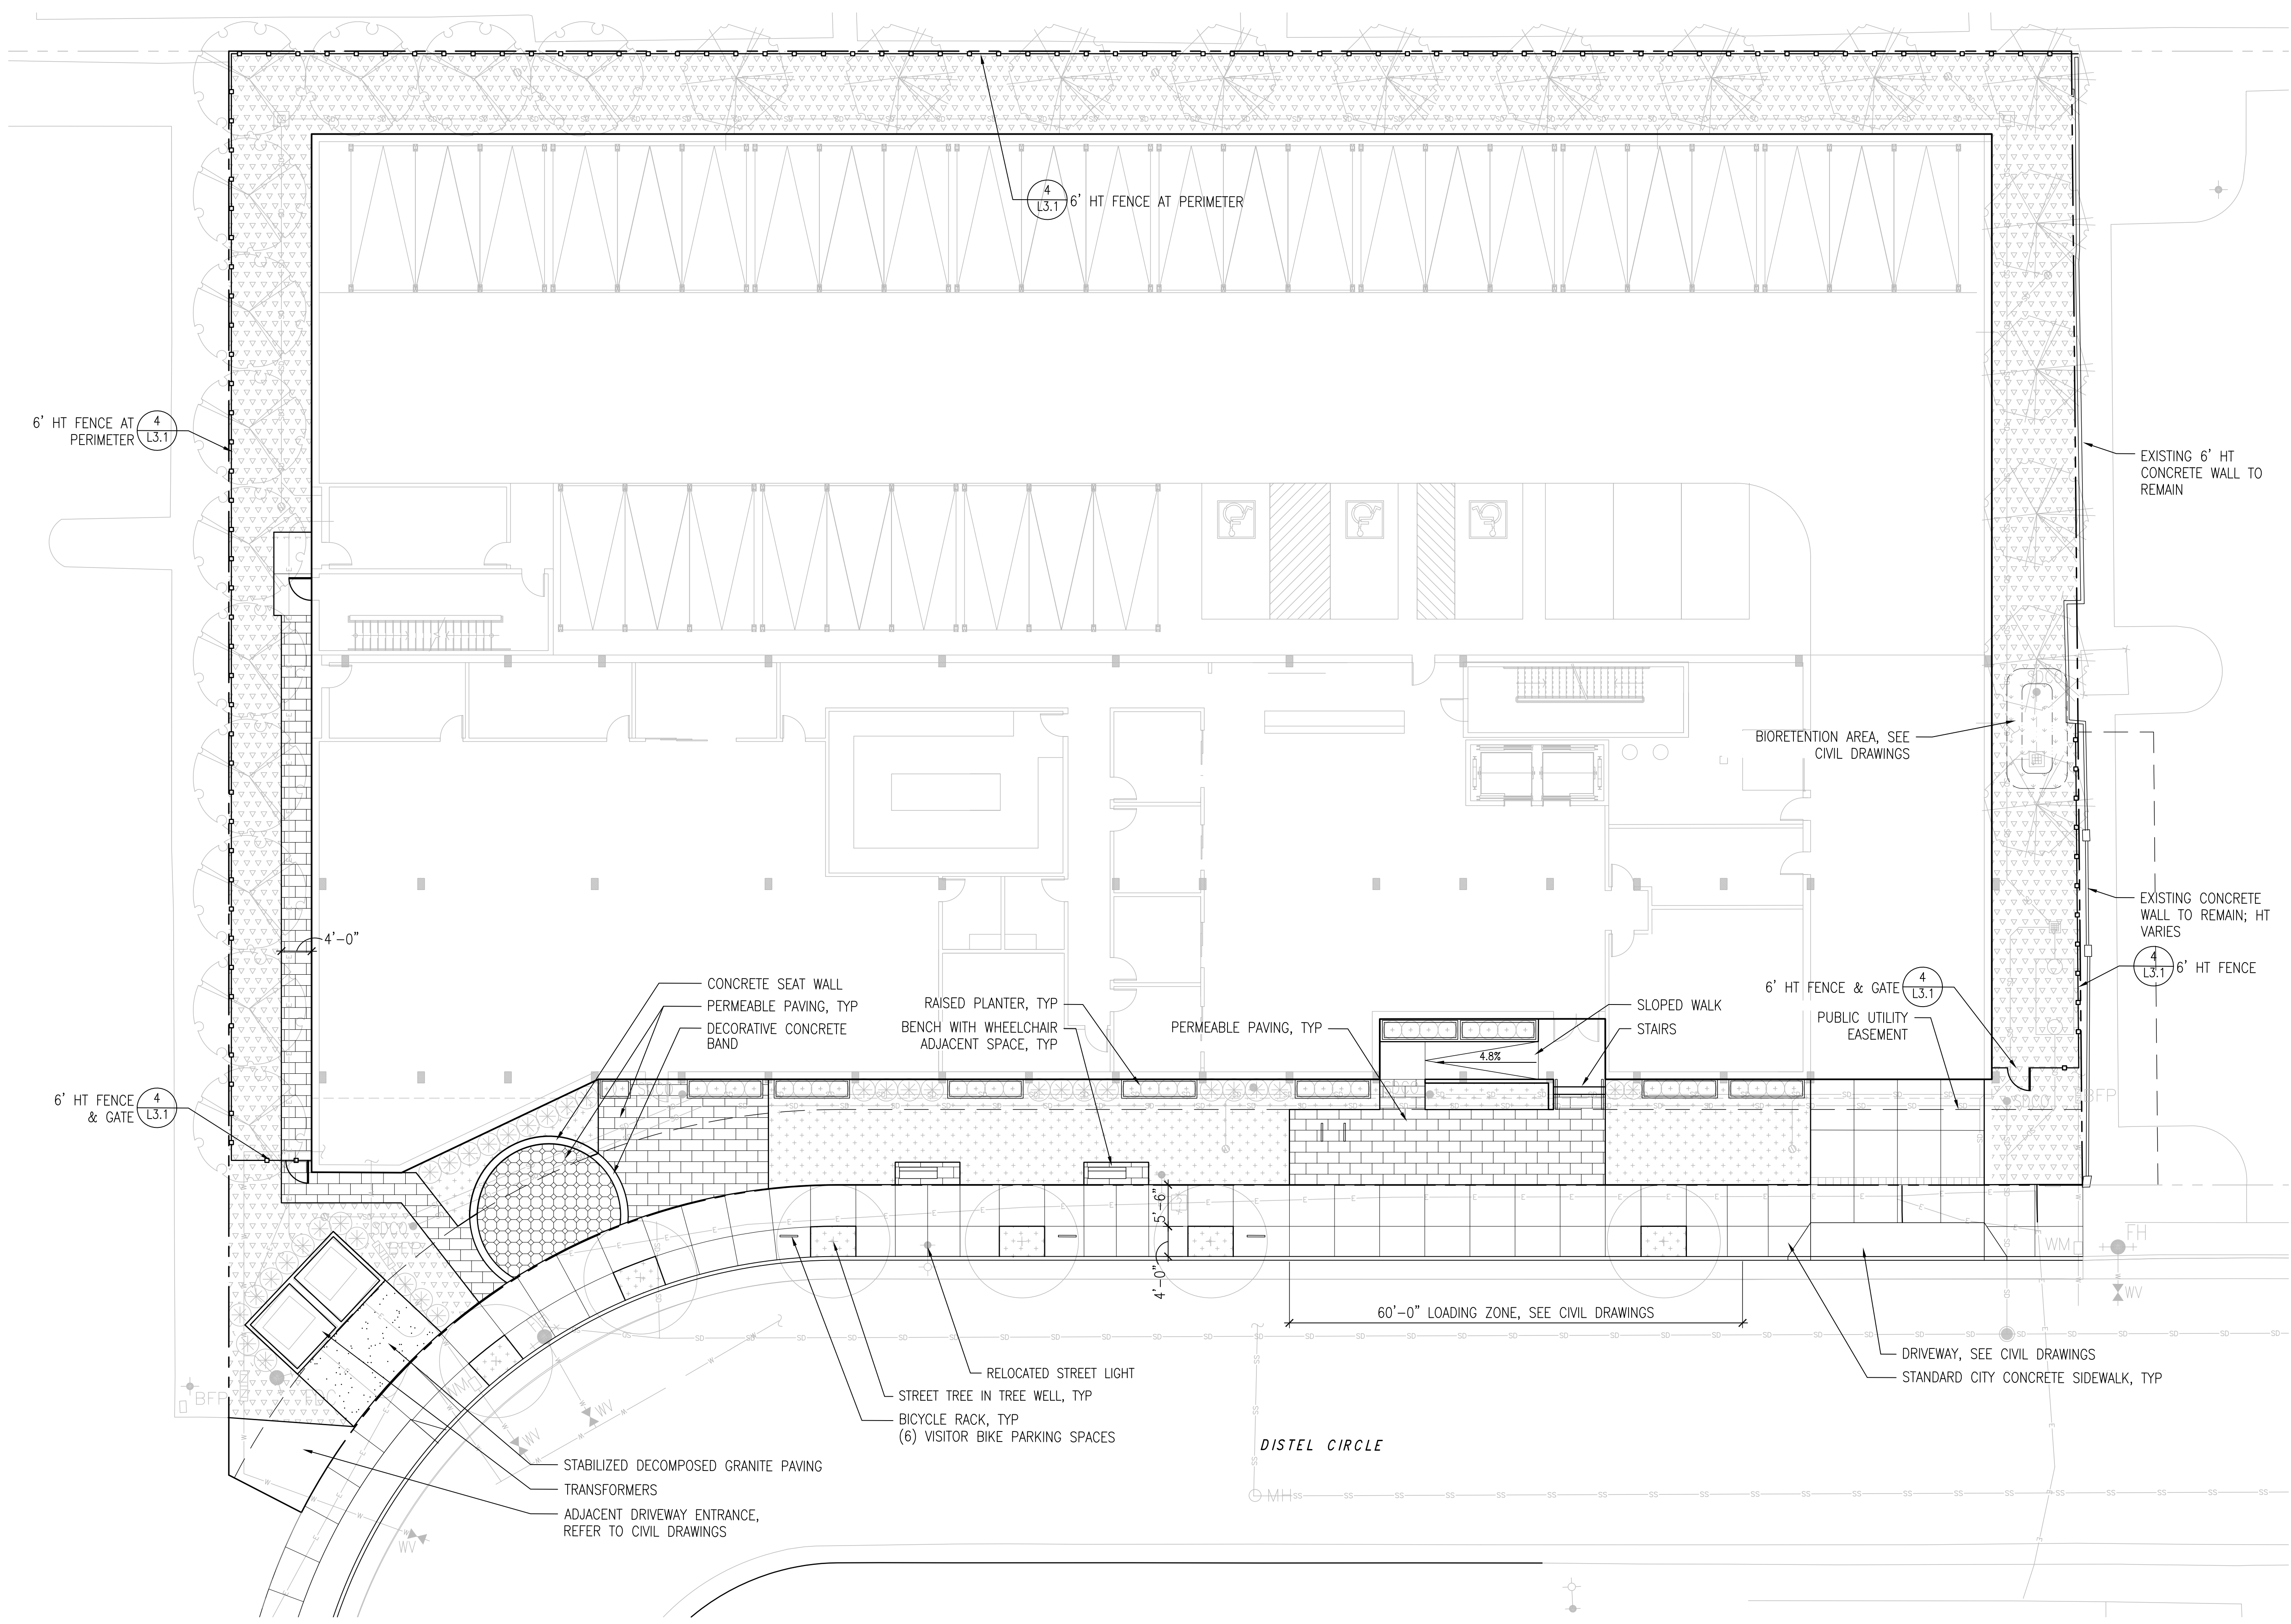
**330 DISTEL CIRCLE**  
LOS ALTOS # 2021-0042

**SUBMITTAL #2**  
APRIL 29, 2022



COLOR AND MATERIALS BOARD

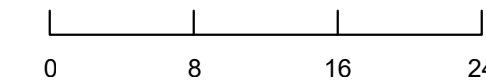**A5.0**




**HARDSCAPE/SOFTSCAPE CALCULATIONS**

SURFACE TYPE	AREA (SF)	% TOTAL SURFACE AREA
TOTAL LANDSCAPE AREA	9491 SF	-
TOTAL SOFTSCAPE	7389 SF	78%
TOTAL HARDSCAPE	2102 SF	22%
NON-PERMEABLE HARDSCAPE	436 SF	21%
PERMEABLE HARDSCAPE	1666 SF	79%

NOTE: CALCULATIONS ABOVE DO NOT INCLUDE OFF-PROPERTY SIDEWALK OR STREET TREES/STREET TREE WELLS

NOTE: A PAVED WALKWAY WILL BE INCORPORATED INTO THE NEXT SUBMITTAL SET AS NEEDED FOR FIRE DEPARTMENT ACCESS AROUND THE BUILDING.

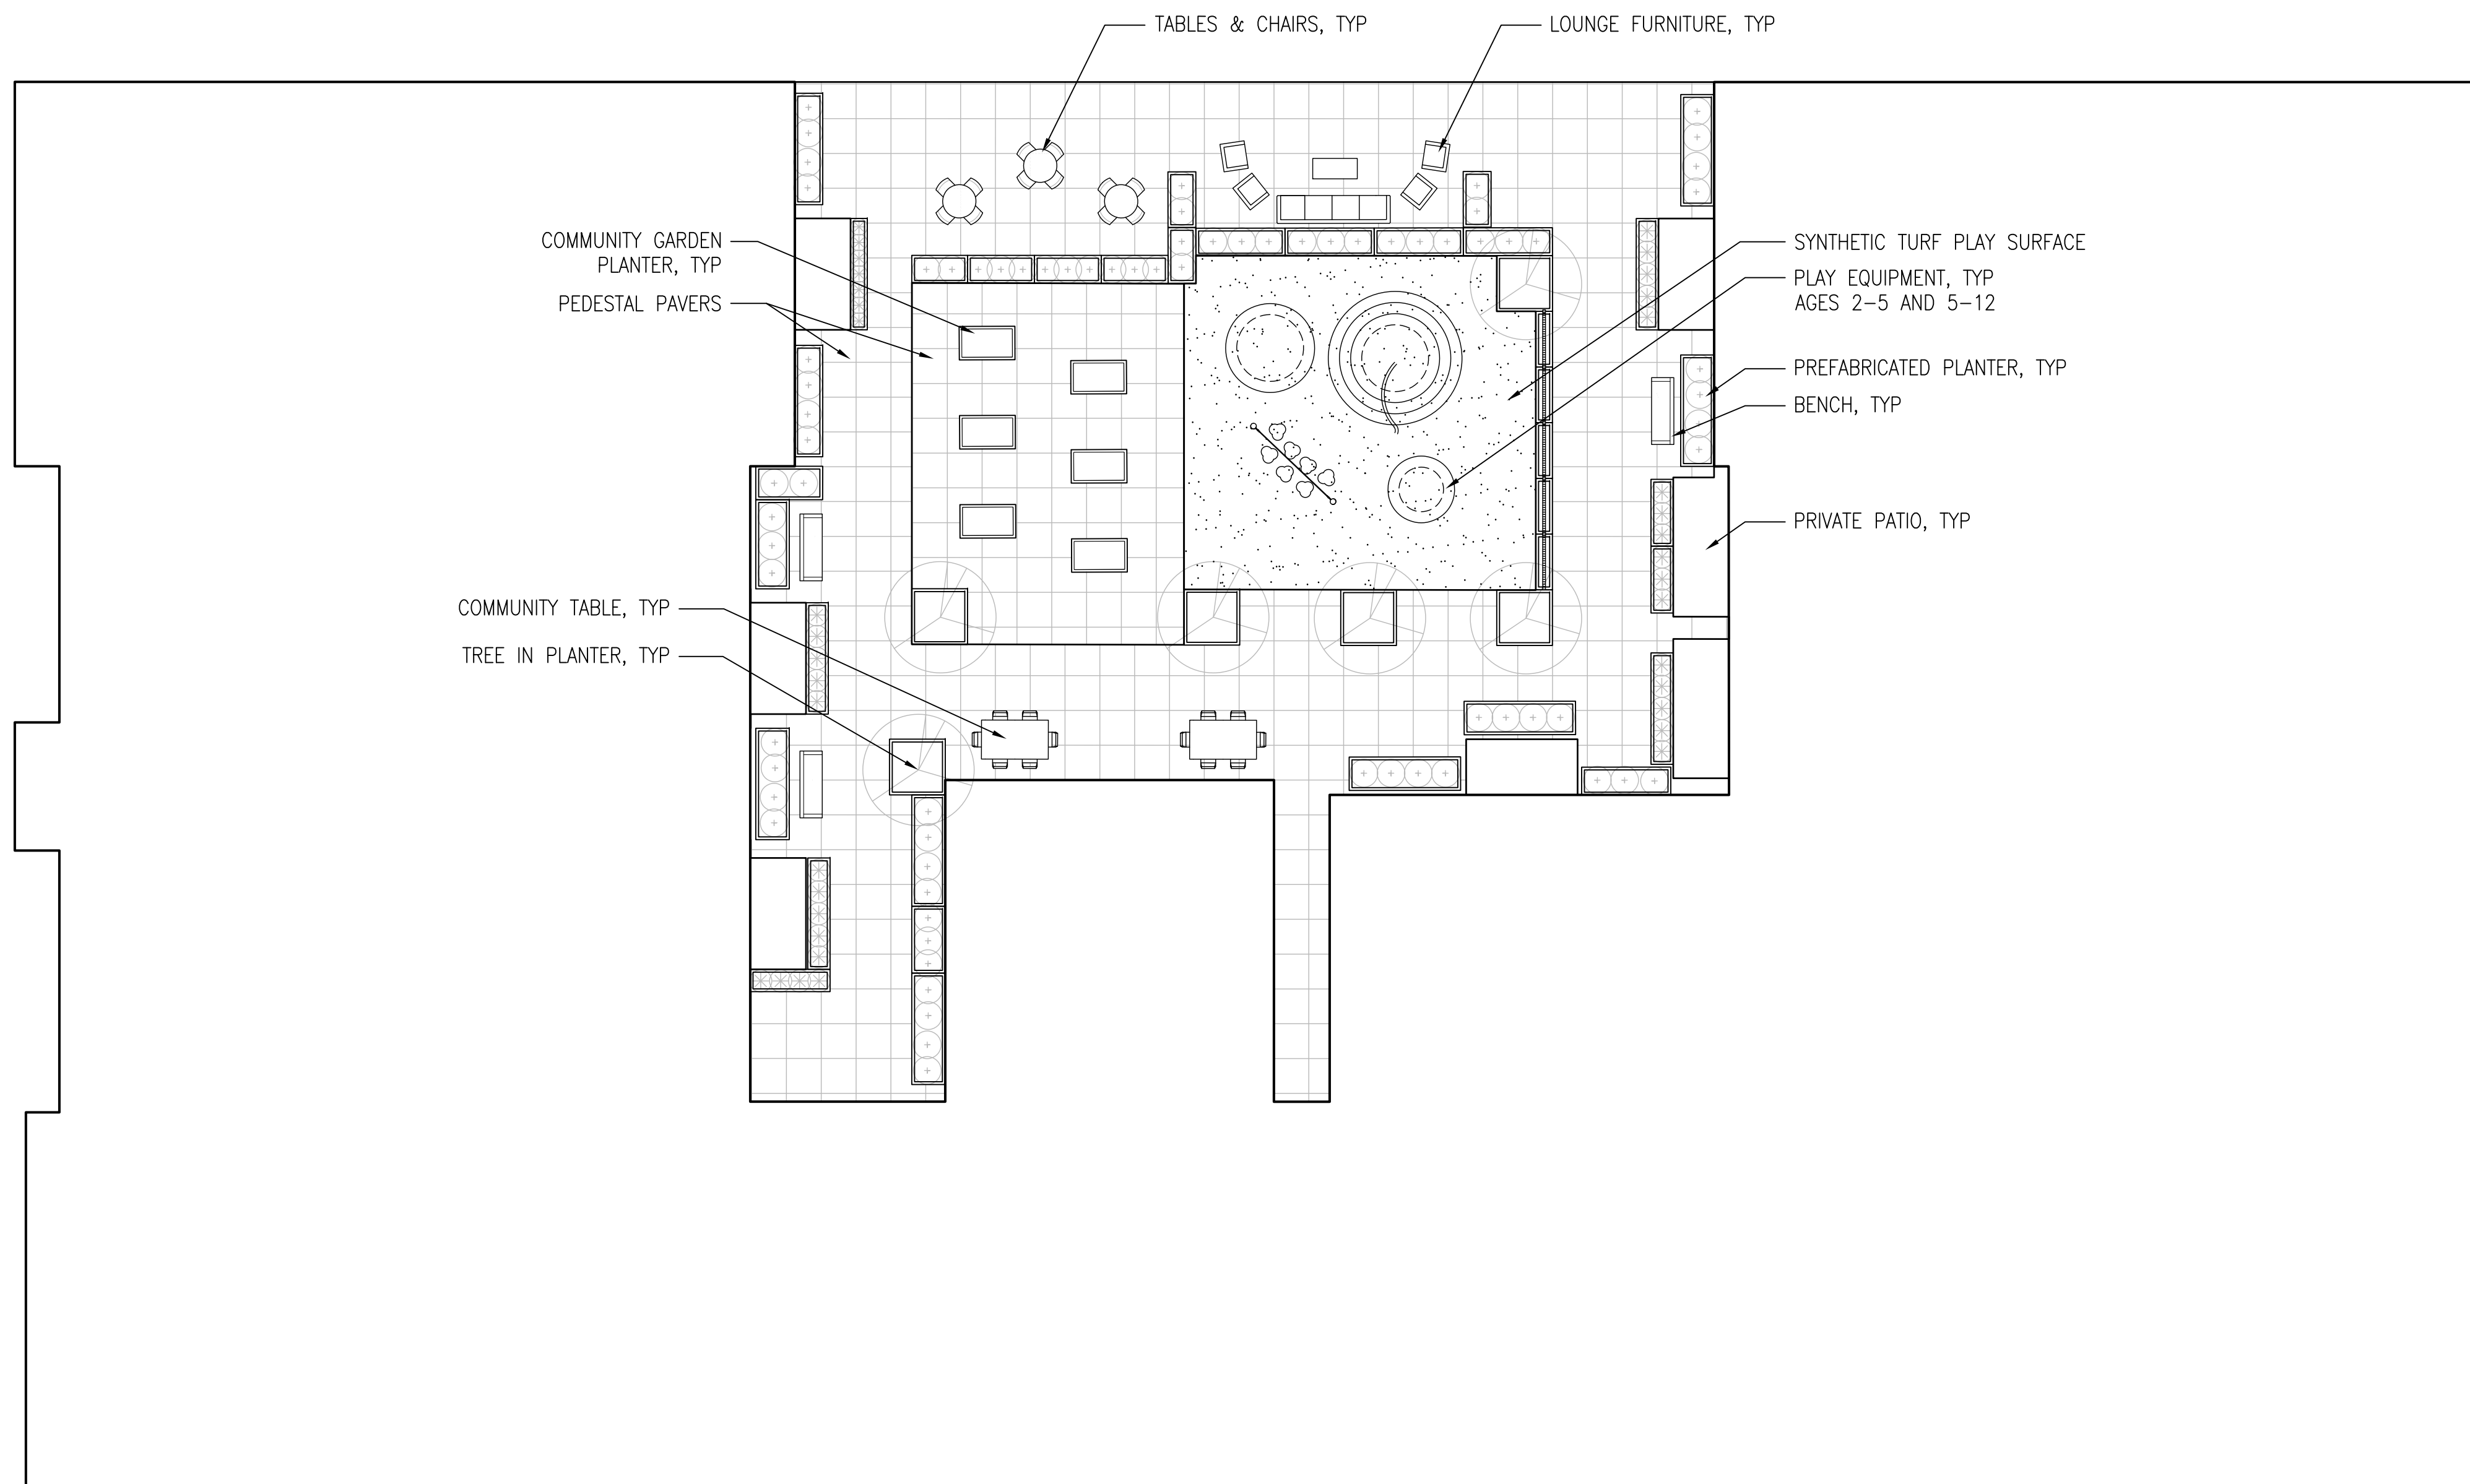

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**330 DISTEL CIRCLE**  
 LOS ALTOS # 2021-0042


**SUBMITTAL #2**  
 APRIL 29, 2022



**PODIUM LANDSCAPE PLAN**  
 2nd FLOOR

**L1.2**



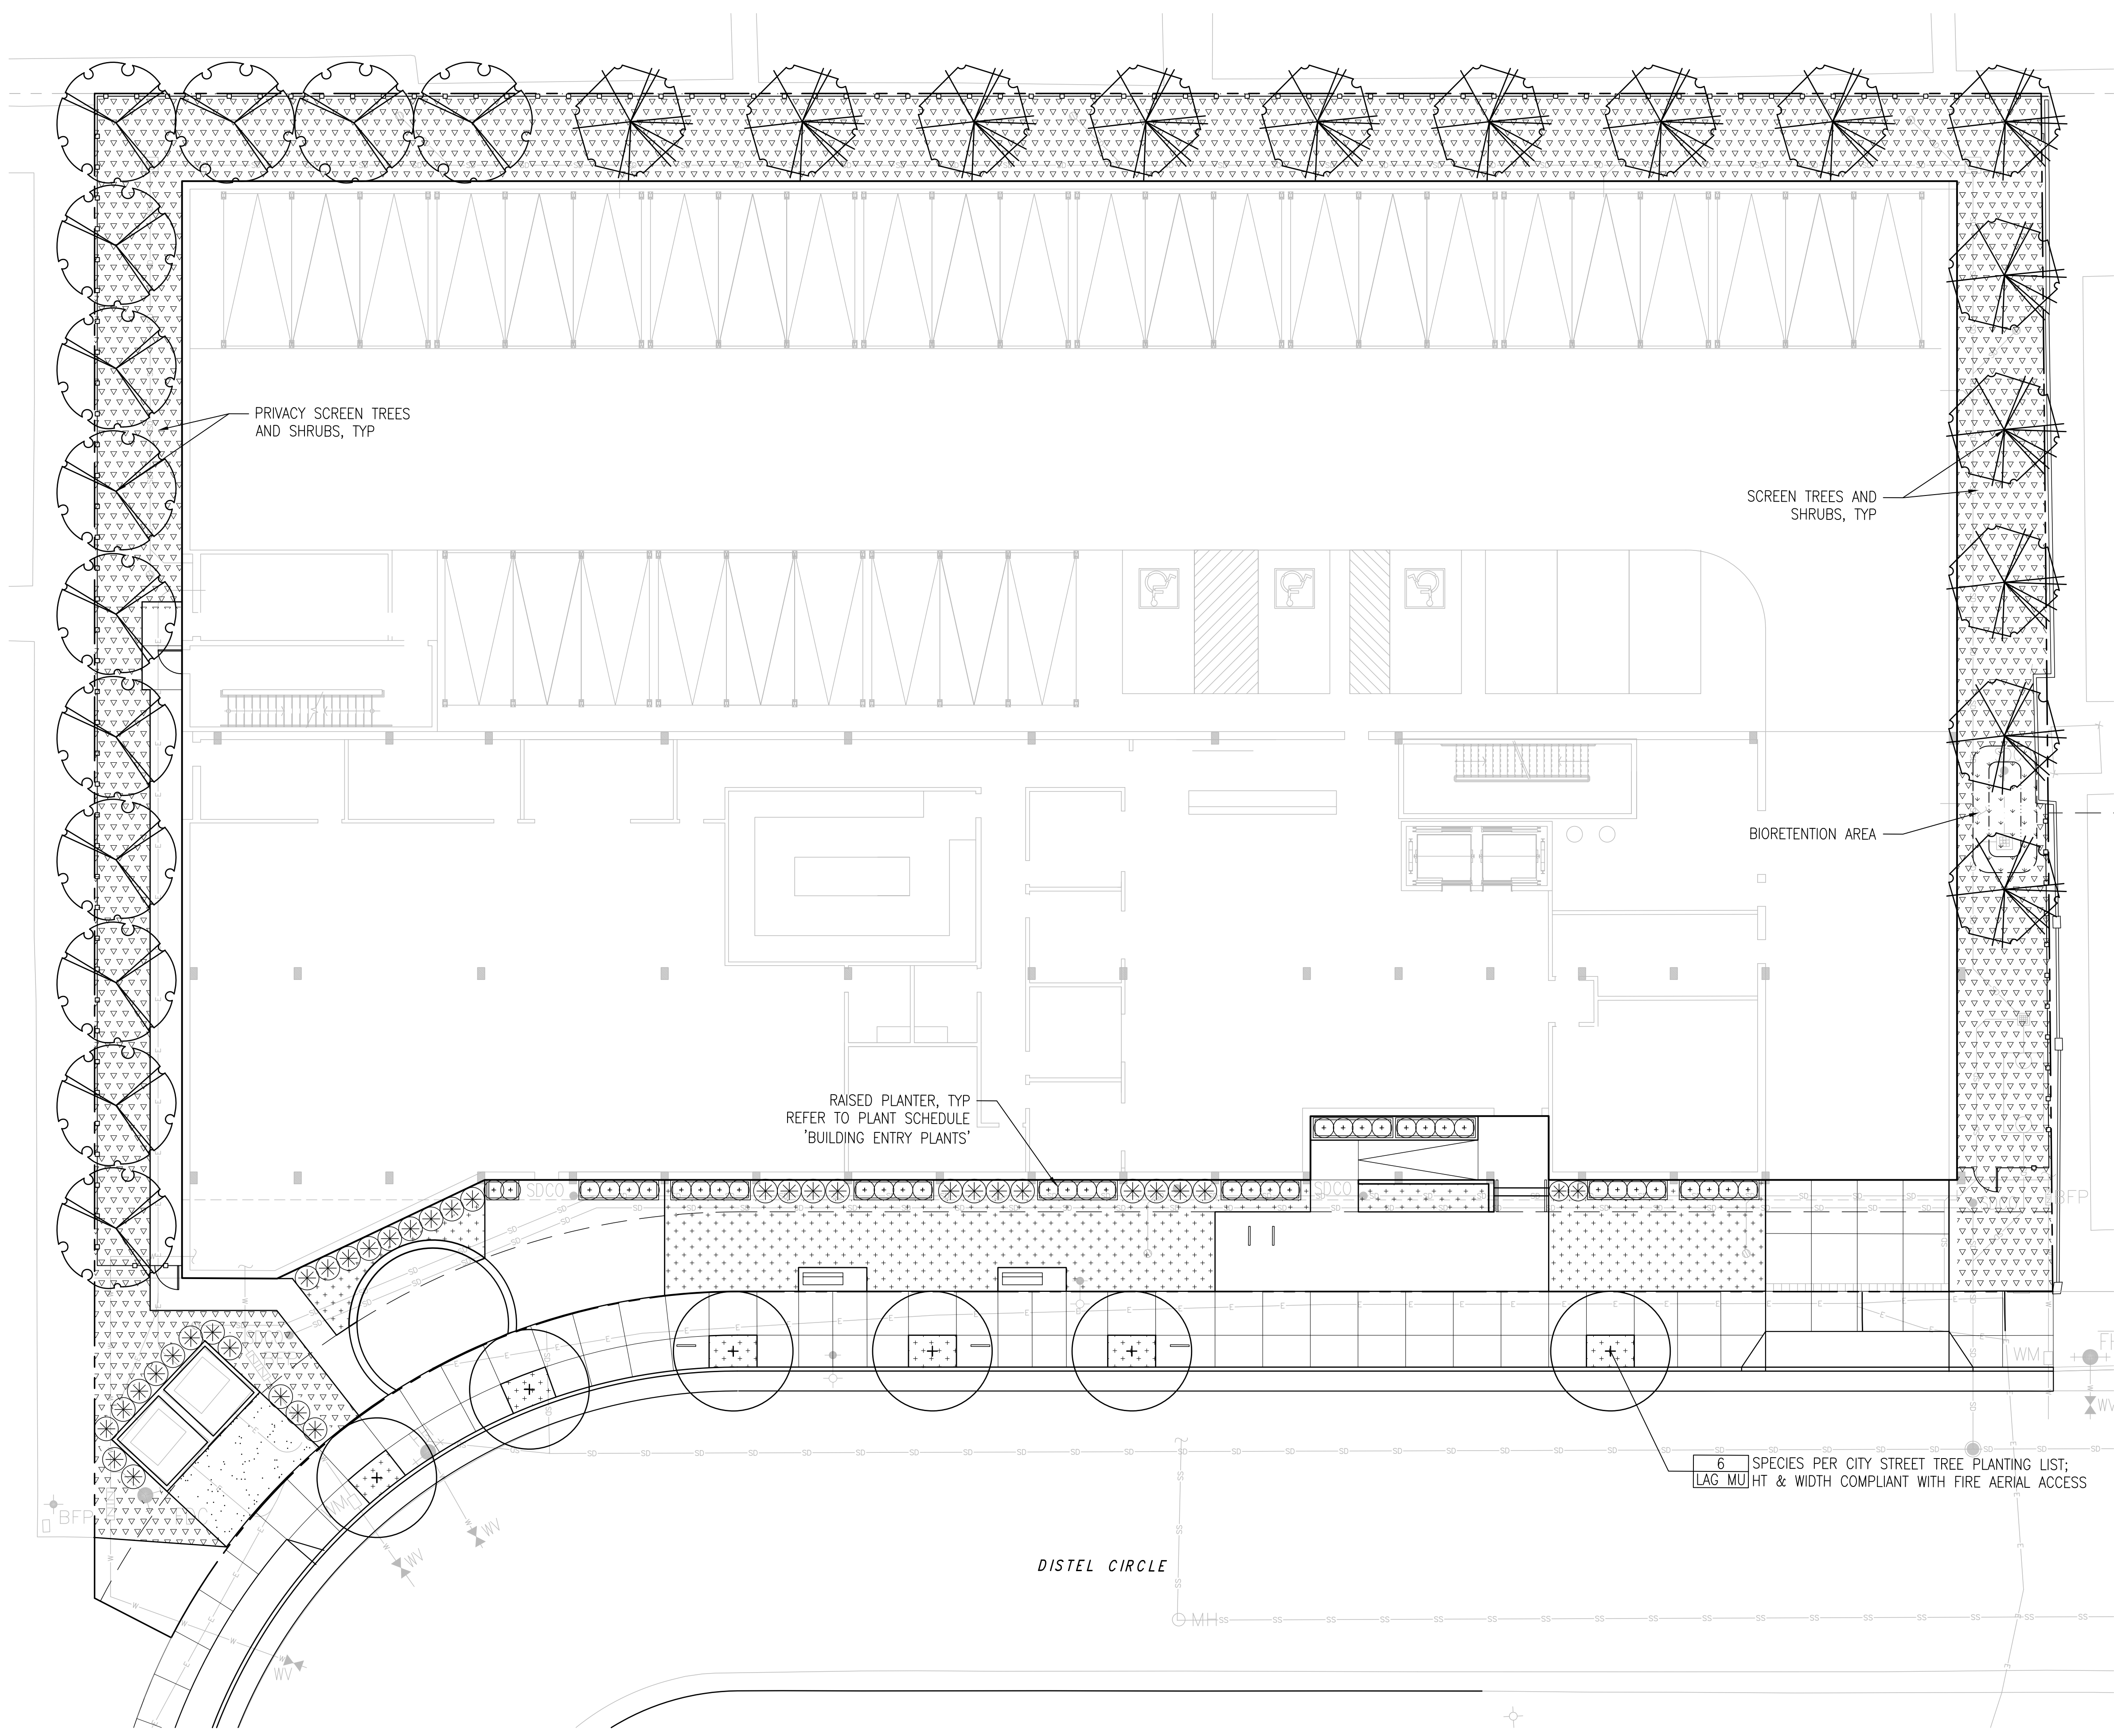

**IRRIGATION DESIGN INTENT**

1. THIS PLAN SHALL COMPLY WITH THE REQUIREMENTS OF BOTH THE STATE OF CALIFORNIA AND CITY OF LOS ALTOS WATER EFFICIENT LANDSCAPE ORDINANCES (MWEO) AS WELL AS LOCAL WATER PURVEYOR REQUIREMENTS.
2. THE IRRIGATION SYSTEM SHALL BE DESIGNED TO PROVIDE THE MINIMUM AMOUNT OF WATER NECESSARY TO SUSTAIN GOOD PLANT HEALTH.
3. THE IRRIGATION SYSTEM IS TO BE A FULLY AUTOMATIC, WEATHER-BASED SYSTEM USING RAIN SENSOR, LOW FLOW DRIP AND BUBBLER DISTRIBUTION.
4. ALL SELECTED COMPONENTS SHALL BE PERMANENT, COMMERCIAL GRADE, SELECTED FOR DURABILITY, VANDAL RESISTANCE AND MINIMUM MAINTENANCE REQUIREMENT, INSTALLED BELOW-GRADE, AND DESIGNED FOR 100% COVERAGE.
5. THE SYSTEM SHALL INCLUDE A MASTER CONTROL VALVE AND FLOW SENSING CAPABILITY WHICH WILL SHUT DOWN ALL OR PART OF THE SYSTEM IF LEAKS ARE DETECTED.
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7. POINT OF CONNECTION (P.O.C.) AFTER BACKFLOW PREVENTER FOR IRRIGATION, SCD. IRRIGATION DEMAND: 18 GPM AT 65 PSI STATIC PRESSURE AFTER BACKFLOW ASSEMBLY. CONTRACTOR TO FIELD VERIFY WATER PRESSURE & FLOW BEFORE ANY NEW WORK IS STARTED AND NOTIFY THE LANDSCAPE ARCHITECT IF THE PRESSURE IS DIFFERENT THAN NOTED.
8. RECYCLED WATER READY: ALL ONSITE PLUMBING FOR NON-DOMESTIC WATER USES (E.G. IRRIGATION, INDUSTRIAL PROCESSES, COOLING, ECT.) SHALL BE DESIGNED FOR RECYCLED WATER USE AND SHALL COMPLY WITH ALL RECYCLED WATER REGULATIONS IN SANTA CLARA MUNICIPAL CODE CHAPTER 13.15, WATER, ARTICLE IV. REGULATION OF RECYCLED WATER SERVICE AND USE.

**PLANT LIST**


SYMBOL	BOTANICAL NAME	COMMON NAME	MATURE SIZE (HxW)	SPACING
<b>STREET TREE</b>				
LAG MU	LAGERSTROEMIA INDICA 'MUSKOGEE'	LAVENDER CREPE MYRTLE	20'X15'	PER PLAN
<b>LANDSCAPE TREES</b>				
○	QUERCUS LOBATA	VALLEY OAK	60'X30'	PER PLAN
○	ARBUTUS MARINA	STRAWBERRY TREE	30'X30'	PER PLAN
○	LAURUS NOBILIS	BAY LAUREL	40'X20'	PER PLAN
○	TRISTANIOPSIS LAURINA 'ELEGANT'	WATER GUM	40'X25'	PER PLAN
○	CERCIS OCCIDENTALIS	WESTERN REDBUD	20'X25'	PER PLAN
<b>SHRUBS AND PERENNIALS</b>				
+	CHONDRPETALUM TECTORUM	CAPE RUSH	5 GAL	3'-0" OC
+	RIBES SANGUINEUM V. GLUTINOSUM	PINK CURRANT	5 GAL	5'-0" OC
+	LEUCADENDRON 'JESTER'	SUNSHINE CONEBUSH	5 GAL	4'-0" OC
⊗	ARCTOSTAPHYLOS 'HOWARD MCMINN'	H. MCMINN MANZANITA	5 GAL	5'-0" OC
⊗	GREVILLEA R. 'SCARLET SPRITE'	ROSEMARY GREVILLEA	5 GAL	4'-0" OC
⊗	RHAMNUS CALIFORNICA	COFFEEBERRY	5 GAL	5'-0" OC
<b>BUILDING ENTRY PLANTS</b>				
+	ACHILLEA M. 'SONOMA COAST'	WHITE YARROW	1 GAL	2'-0" OC
+	ANIGOZANTHOS 'BIG RED'	RED KANGAROO PAW	1 GAL	2'-0" OC
+	CISTANTHE GRANDIFLORA 'JAZZ TIME'	ROCK PURSLANE	5 GAL	2'-0" OC
+	DIETES GRANDIFLORA 'VARIEGATA'	VARIEG. FORTNIGHT LILY	5 GAL	3'-0" OC
+	ERIOGONUM GRANDE	RED BUCKWHEAT	1 GAL	2'-0" OC
+	FESTUCA CALIFORNICA	CALIFORNIA FESCUE	1 GAL	1'-0" OC
+	HEUCHERA SANGUINEA	CORAL BELLS	1 GAL	1'-6" OC
+	LANTANA CAMARA 'NEW GOLD'	YELLOW LANTANA	5 GAL	2'-0" OC
+	LOMANDRA LONGIFOLIA 'BREEZE'	DWARF MAT RUSH	5 GAL	3'-0" OC
+	SALVIA LEUCOPHYLLA	PURPLE SAGE	5 GAL	3'-0" OC
<b>PERIMETER PLANTS - BUFFER</b>				
▽	ARCTOSTAPHYLOS SPP	MANZANITA	5 GAL	5'-0" OC
▽	CLETHRA ALNIFOLIA 'HUMMINGBIRD'	SUMMERSWEET	1 GAL	3'-0" OC
▽	IRIS DOUGLASIANA, INNOMINATA	PACIFIC COAST IRIS	1 GAL	1'-0" OC
▽	LOROPETALUM CHINENSE 'BLUSH'	RED FRINGE FLOWER	5 GAL	4'-0" OC
▽	HOLIDISCUS DISCOLOR	CREAM BUSH	1 GAL	5'-0" OC
▽	PHYSOCARPUS CAPITUS	PACIFIC NINEBARK	5 GAL	5'-0" OC
▽	RIBES SANGUINEUM V. GLUTINOSUM	PINK CURRANT	5 GAL	5'-0" OC
▽	TRICHSTEMMA LANATUM	WOOLY BLUE CURLS	5 GAL	5'-0" OC
<b>BIORETENTION AREA PLANTS</b>				
▽	CAREX DIVULSA	BERKELEY SEDGE	1 GAL	2'-0" OC
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	JUNCUS PATENS	CALIFORNIA GRAY RUSH	1 GAL	2'-0" OC	



**PRELIMINARY TREE PALETTE**




*ARBUTUS MARINA*  
STRAWBERRY TREE

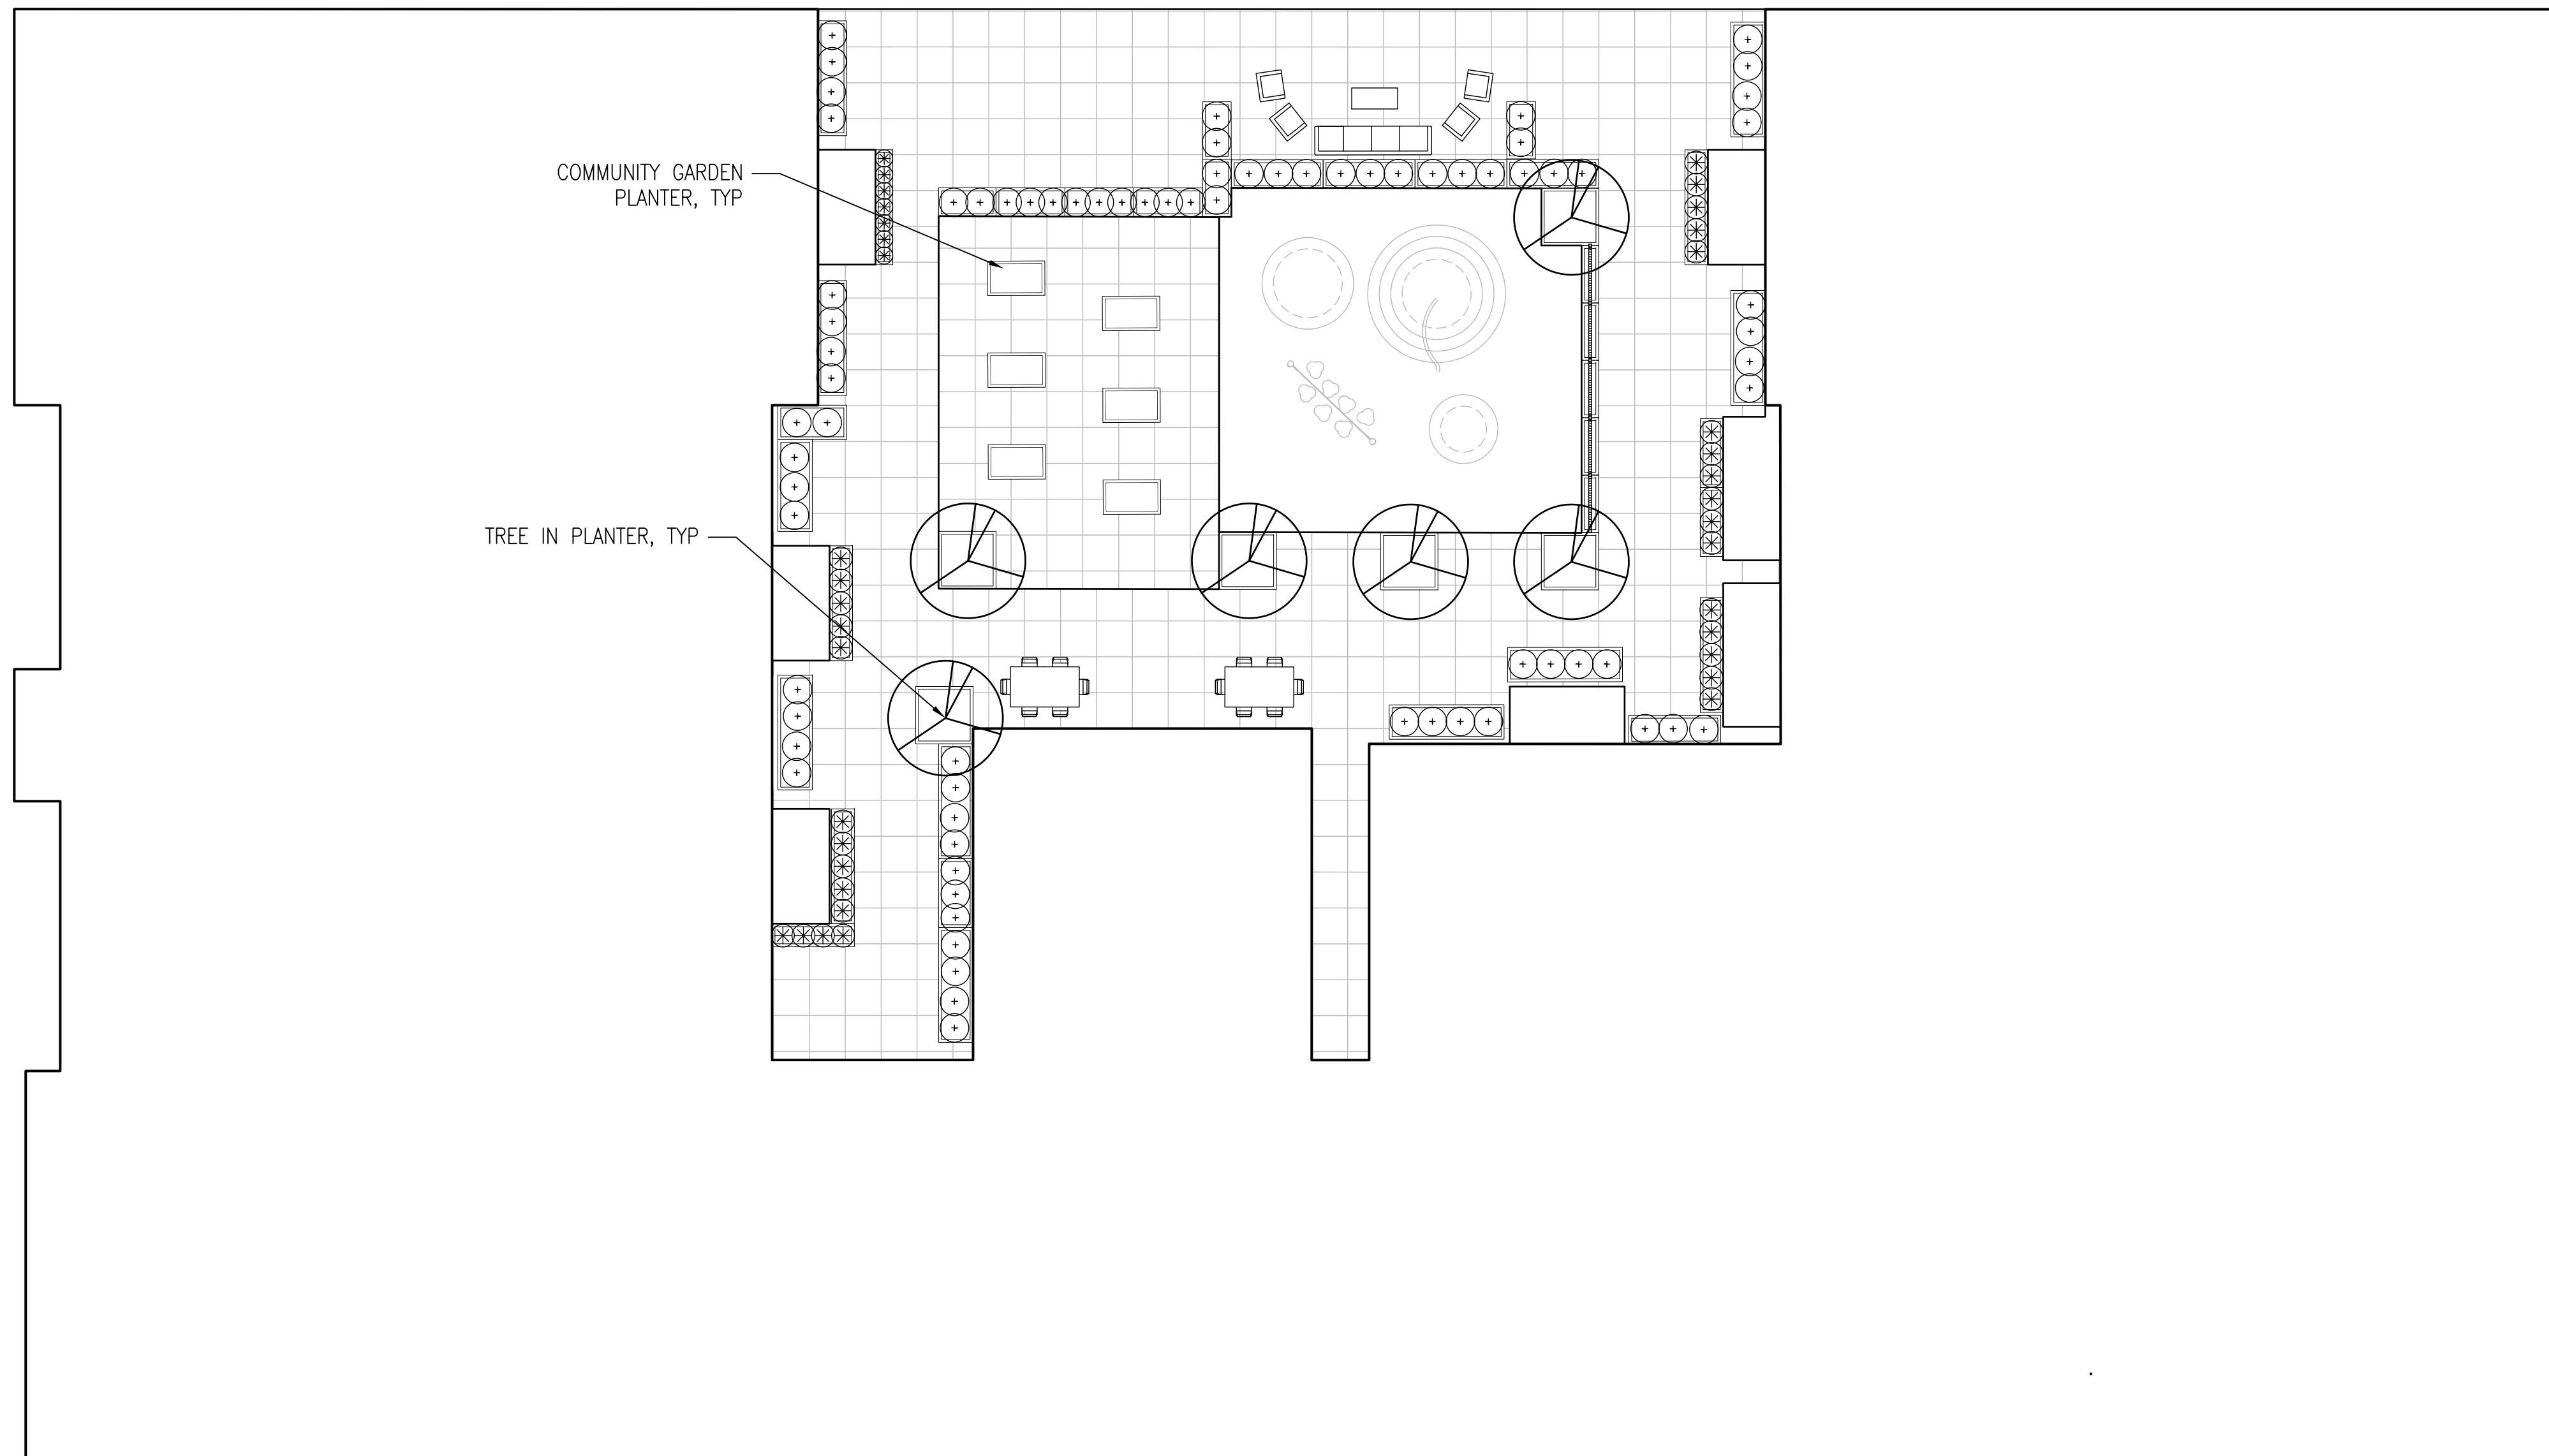

*CERCIS OCCIDENTALIS*  
WESTERN REDBUD



*LAGERSTROEMIA SPP.*  
CREPE MYRTLE

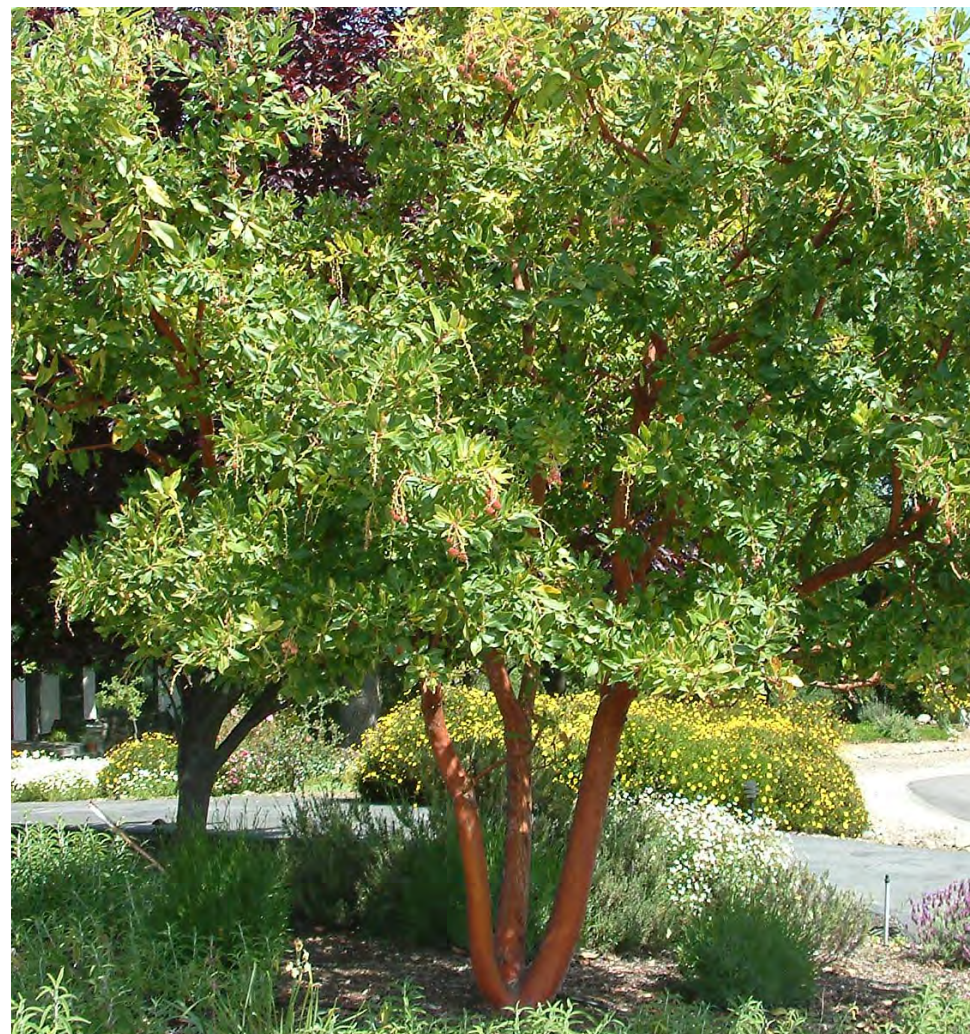

*ARBUTUS MARINA*  
STRAWBERRY TREE



*CERCIS OCCIDENTALIS*  
WESTERN REDBUD



*LAGERSTROEMIA SPP.*  
CREPE MYRTLE

**PRELIMINARY SHRUB PALETTE**




1 **BICYCLE RACK**



2 **PLAY MOUNDS OR COMPARABLE**



3 **WATERLILY BALANCE OR COMPARABLE**

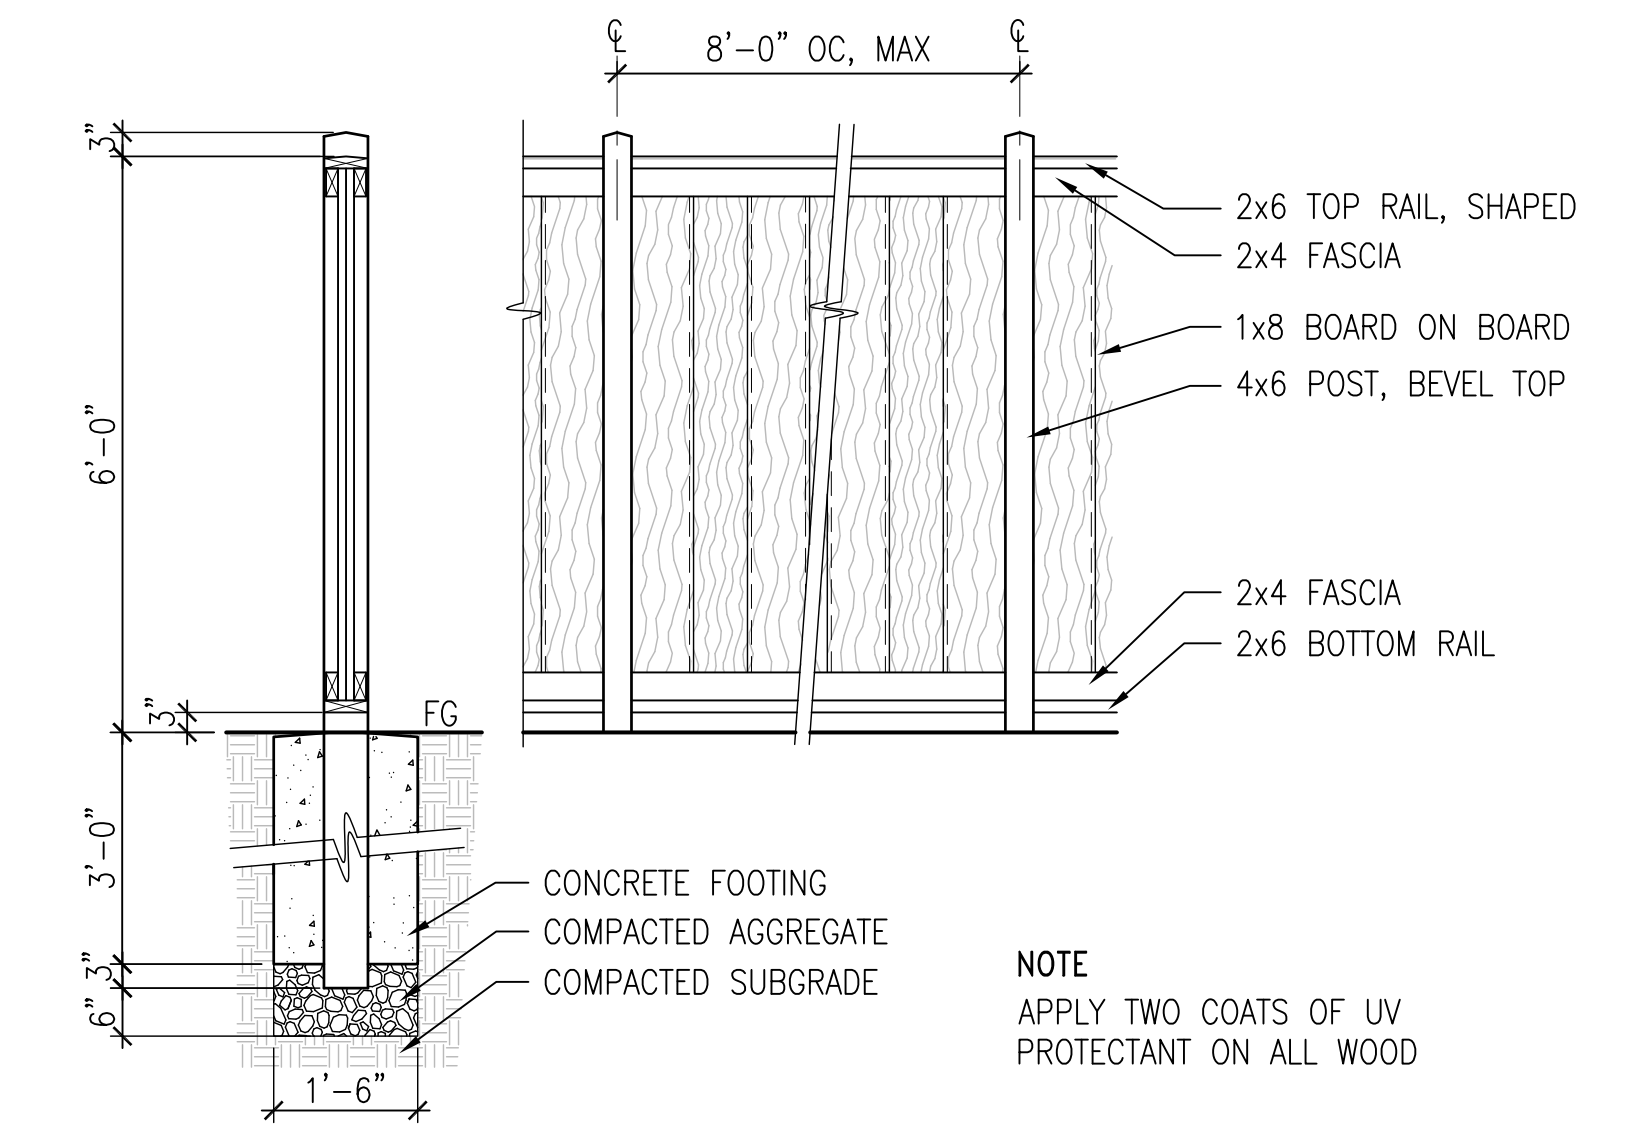

SCALE: 1/2"=1'-0"

4 **WOODEN FENCE**




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**330 DISTEL CIRCLE**  
LOS ALTOS # 2021-0042

**SUBMITTAL #2**  
APRIL 29, 2022




PLANT IMAGERY AND DETAILS

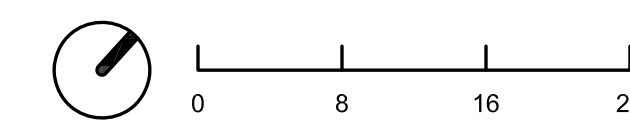**L3.1**


# 330 DISTEL CIRCLE LOS ALTOS, CA

## SITE INFORMATION

OWNER: EAH HOUSING  
 CONTACT: STEVE PRATT  
 ADDRESS: 330 DISTEL CIRCLE  
 ASSESSORS PARCEL NO: 170-04-051  
 NUMBER OF LOTS: EXISTING – ONE  
 PROPOSED – ONE  
 GROSS AREA: 38,030 SQUARE FEET  
 NET AREA: 38,030 SQUARE FEET  
 CIVIL ENGINEER: BKF ENGINEERS  
 1730 N. FIRST STREET, SUITE 600  
 SAN JOSE, CA 95112  
 CONTACT: SCOTT SCHORK (408) 467-9126  
 EXISTING ZONING: COMMERCIAL THOROUGHFARE  
 PROPOSED USE: AFFORDABLE MULTI-FAMILY  
 FLOOD ZONE: THIS PROPERTY IS LOCATED WITHIN ZONE X AS  
 SHOWN IN FLOOD INSURANCE RATE MAP  
 COMMUNITY PARCEL NO. 06085C0038H  
 WATER: CALIFORNIA WATER SERVICE COMPANY  
 SANITARY SEWER: CITY OF LOS ALTOS  
 STORM DRAIN: CITY OF LOS ALTOS  
 GAS/ELECTRIC: PACIFIC GAS & ELECTRIC  
 TELEPHONE: AT&T  
 CABLE TV: COMCAST

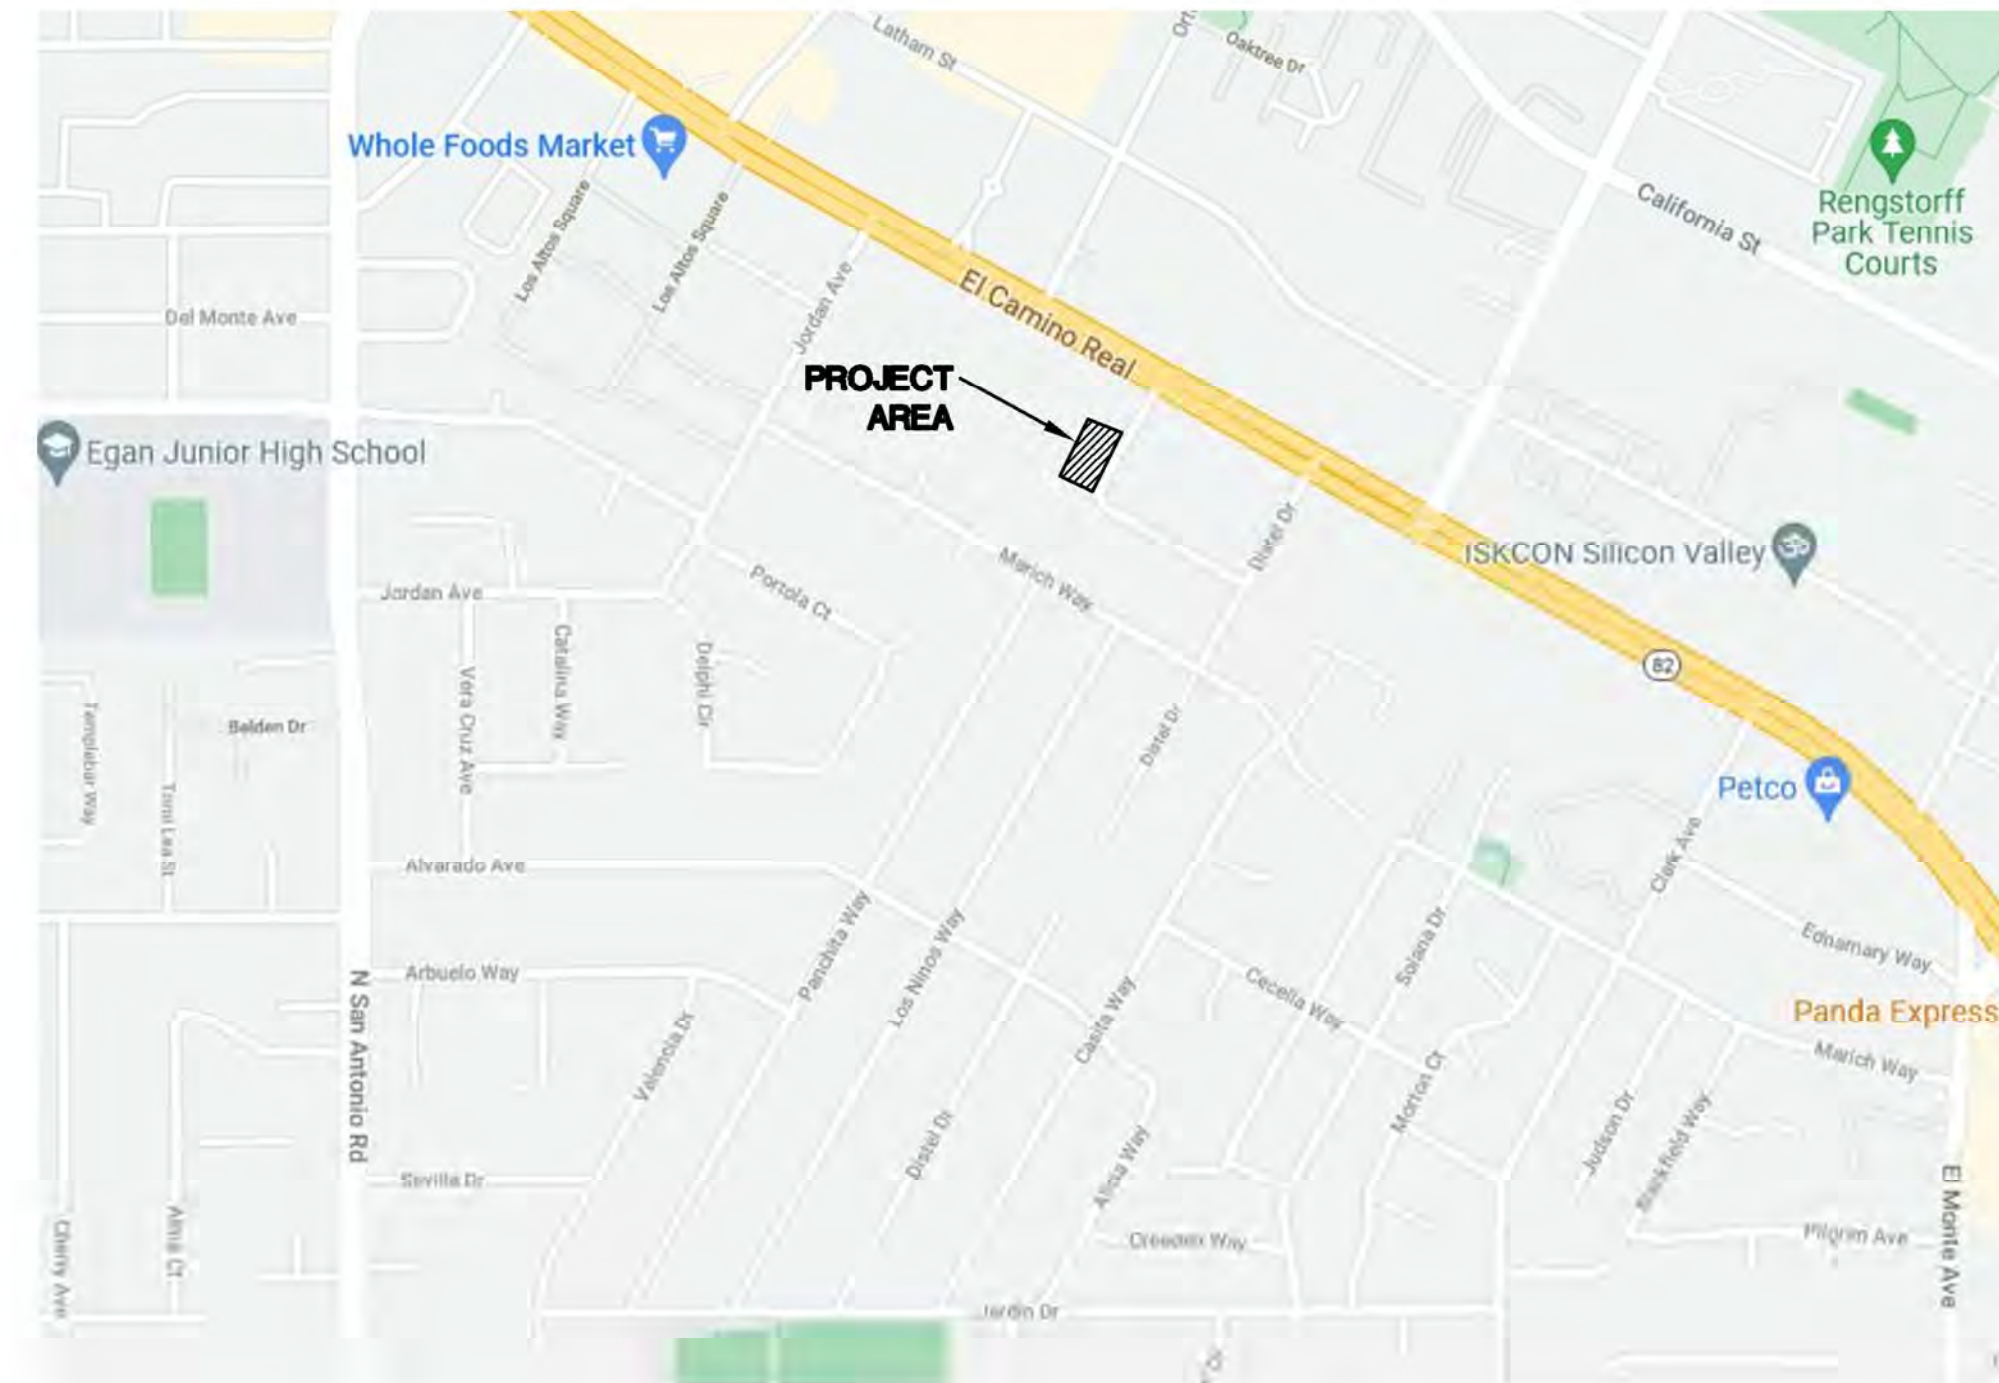

VICINITY MAP  
N.T.S.

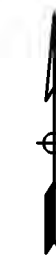

## BENCHMARK


CITY OF LOS ALTOS BENCHMARK NO. 03  
 3-1/2" BRASS DISK AT TOP OF CURB AT SOUTH SIDE OF EL  
 CAMINO REAL AND NORTHERLY EDGE OF DRIVEWAY AT 4984 EL  
 CAMINO REAL. HALF WAY BETWEEN ORTEGA AVENUE AND DISTEL  
 CIRCLE.  
 ELEVATION = 82.125 FEET (NAVD88 DATUM)

## BASIS OF BEARINGS

THE BEARING NORTH 29°23'20" EAST OF THE CENTERLINE OF DISTEL  
 CIRCLE, FORMERLY RUSHMORE DRIVE, BETWEEN FOUND MONUMENTS,  
 AS SAID MONUMENTS ARE SHOWN ON TRACT NO. 5060 ENTITLED  
 "PLAZA WEST", FILED FOR RECORD ON DECEMBER 26, 1972 IN BOOK  
 314 OF MAPS AT PAGE 17, RECORDS OF SANTA CLARA COUNTY,  
 WAS HELD AS THE BASIS OF BEARINGS FOR THE SURVEY.

## SHEET INDEX







C1.0	TITLE SHEET
C2.0	EXISTING CONDITIONS
C3.0	PRELIMINARY GRADING PLAN
C4.0	PRELIMINARY UTILITY PLAN
C5.0	PRELIMINARY STORMWATER CONTROL PLAN
C6.0	FIRE HOSE REACH PLAN

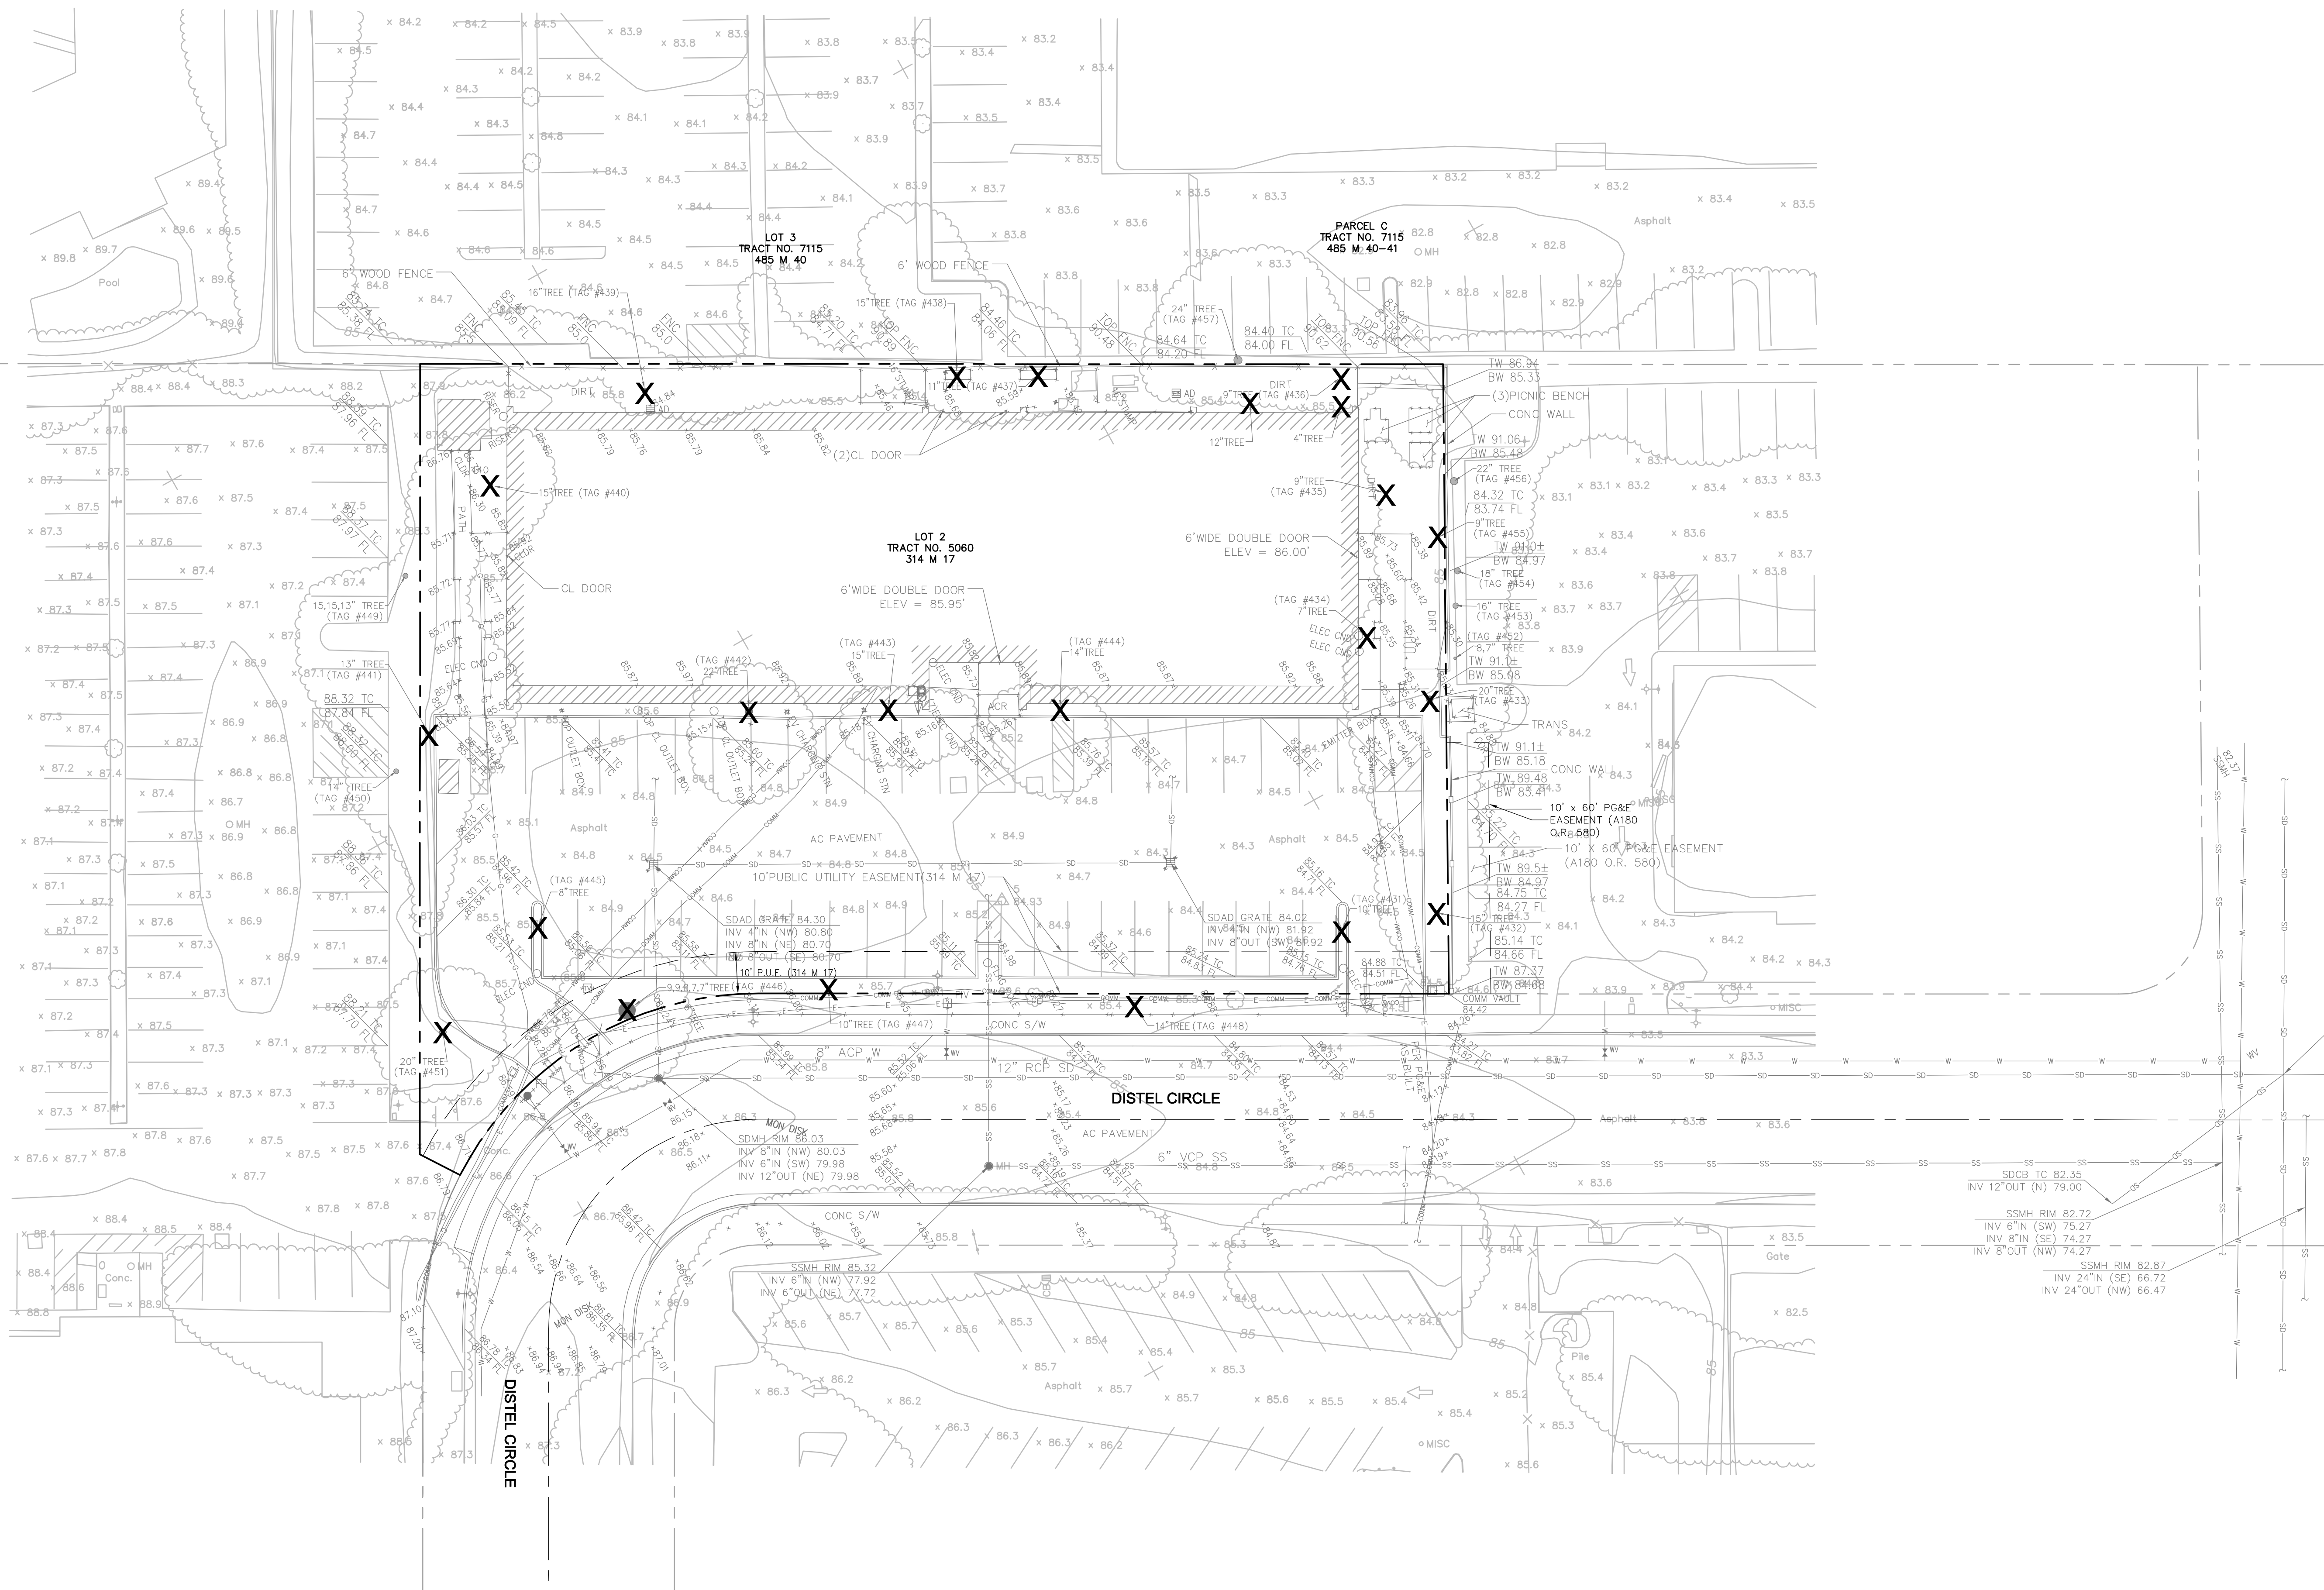

ABBREVIATIONS	
AC	ASPHALT CONCRETE
BFP	BACK FLOW PREVENTER
BW	BACK OF WALK
DCDA	DOUBLE CHECK DETECTOR ASSEMBLY
DW	DOMESTIC WATER
EX	EXISTING
FDC	FIRE DEPARTMENT CONTROL
FF	FINISHED FLOOR
FG	FINISHED GRADE
FH	FIRE HYDRANT
FL	FLOW LINE
FW	FIRE WATER
PUE	PUBLIC UTILITY EASEMENT
PV	PAVEMENT
RWL	RAIN WATER LEADER
SD	STORM DRAIN
SDAD	STORM DRAIN AREA DRAIN
SDDI	STORM DRAIN DRAINAGE INLET
SDJB	STORM DRAIN JUNCTION BOX
SDMH	STORM DRAIN MANHOLE
SS	SANITARY SEWER
SSCO	SANITARY SEWER CLEANOUT
SSMH	SANITARY SEWER MANHOLE
TC	TOP OF CURB
TW	TOP OF WALL
W	WATER
WH	WHARF HYDRANT
WM	WATER METER
WV	WATER VALVE


LEGEND	
	PROPERTY LINE
	EASEMENT
	CURB & GUTTER
	EXISTING TREE REMOVAL

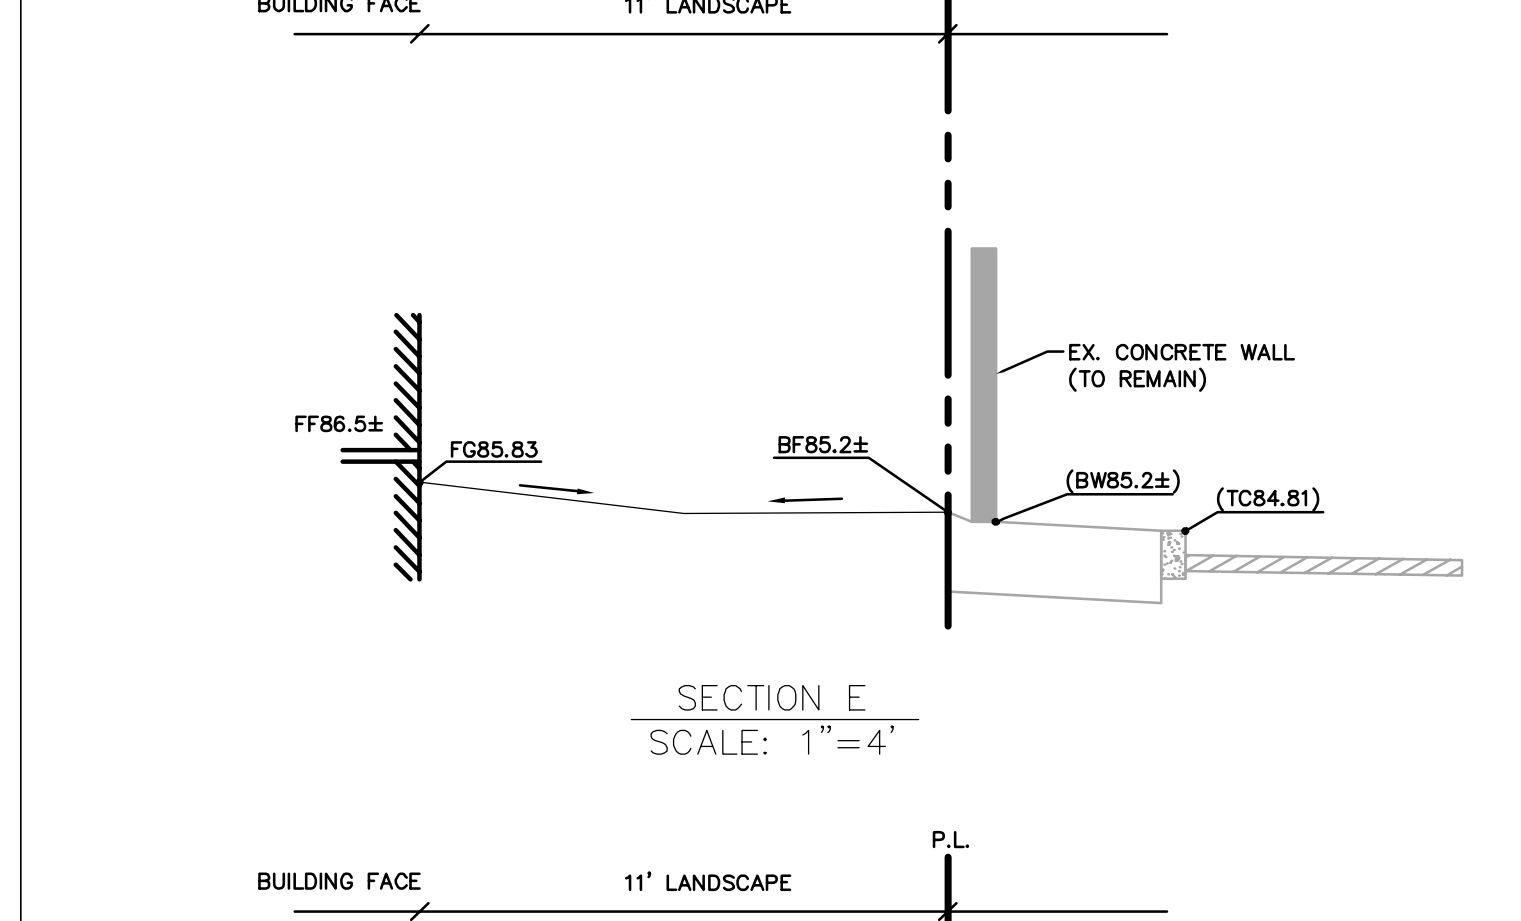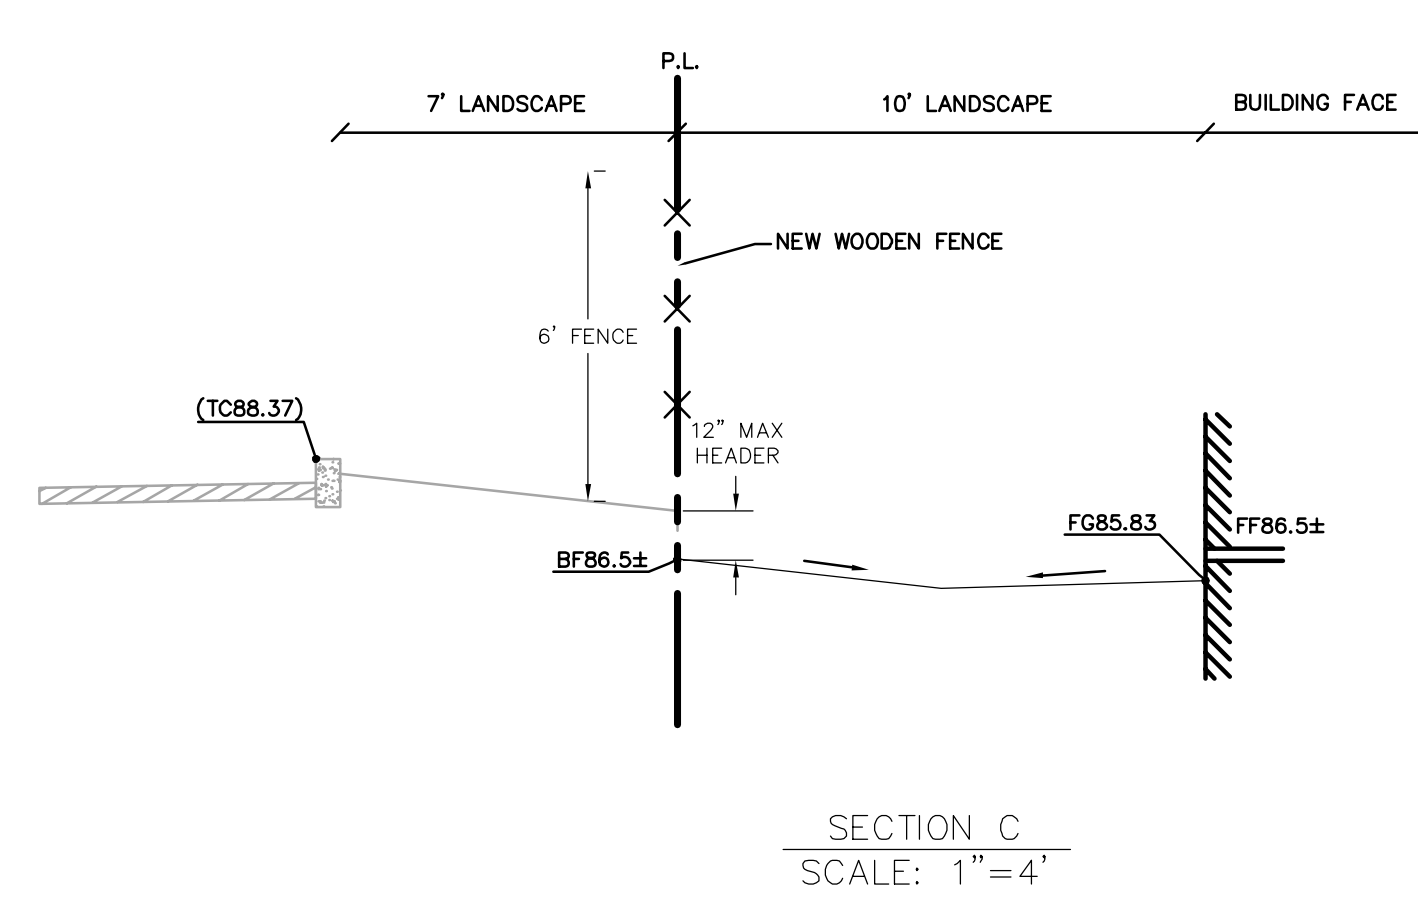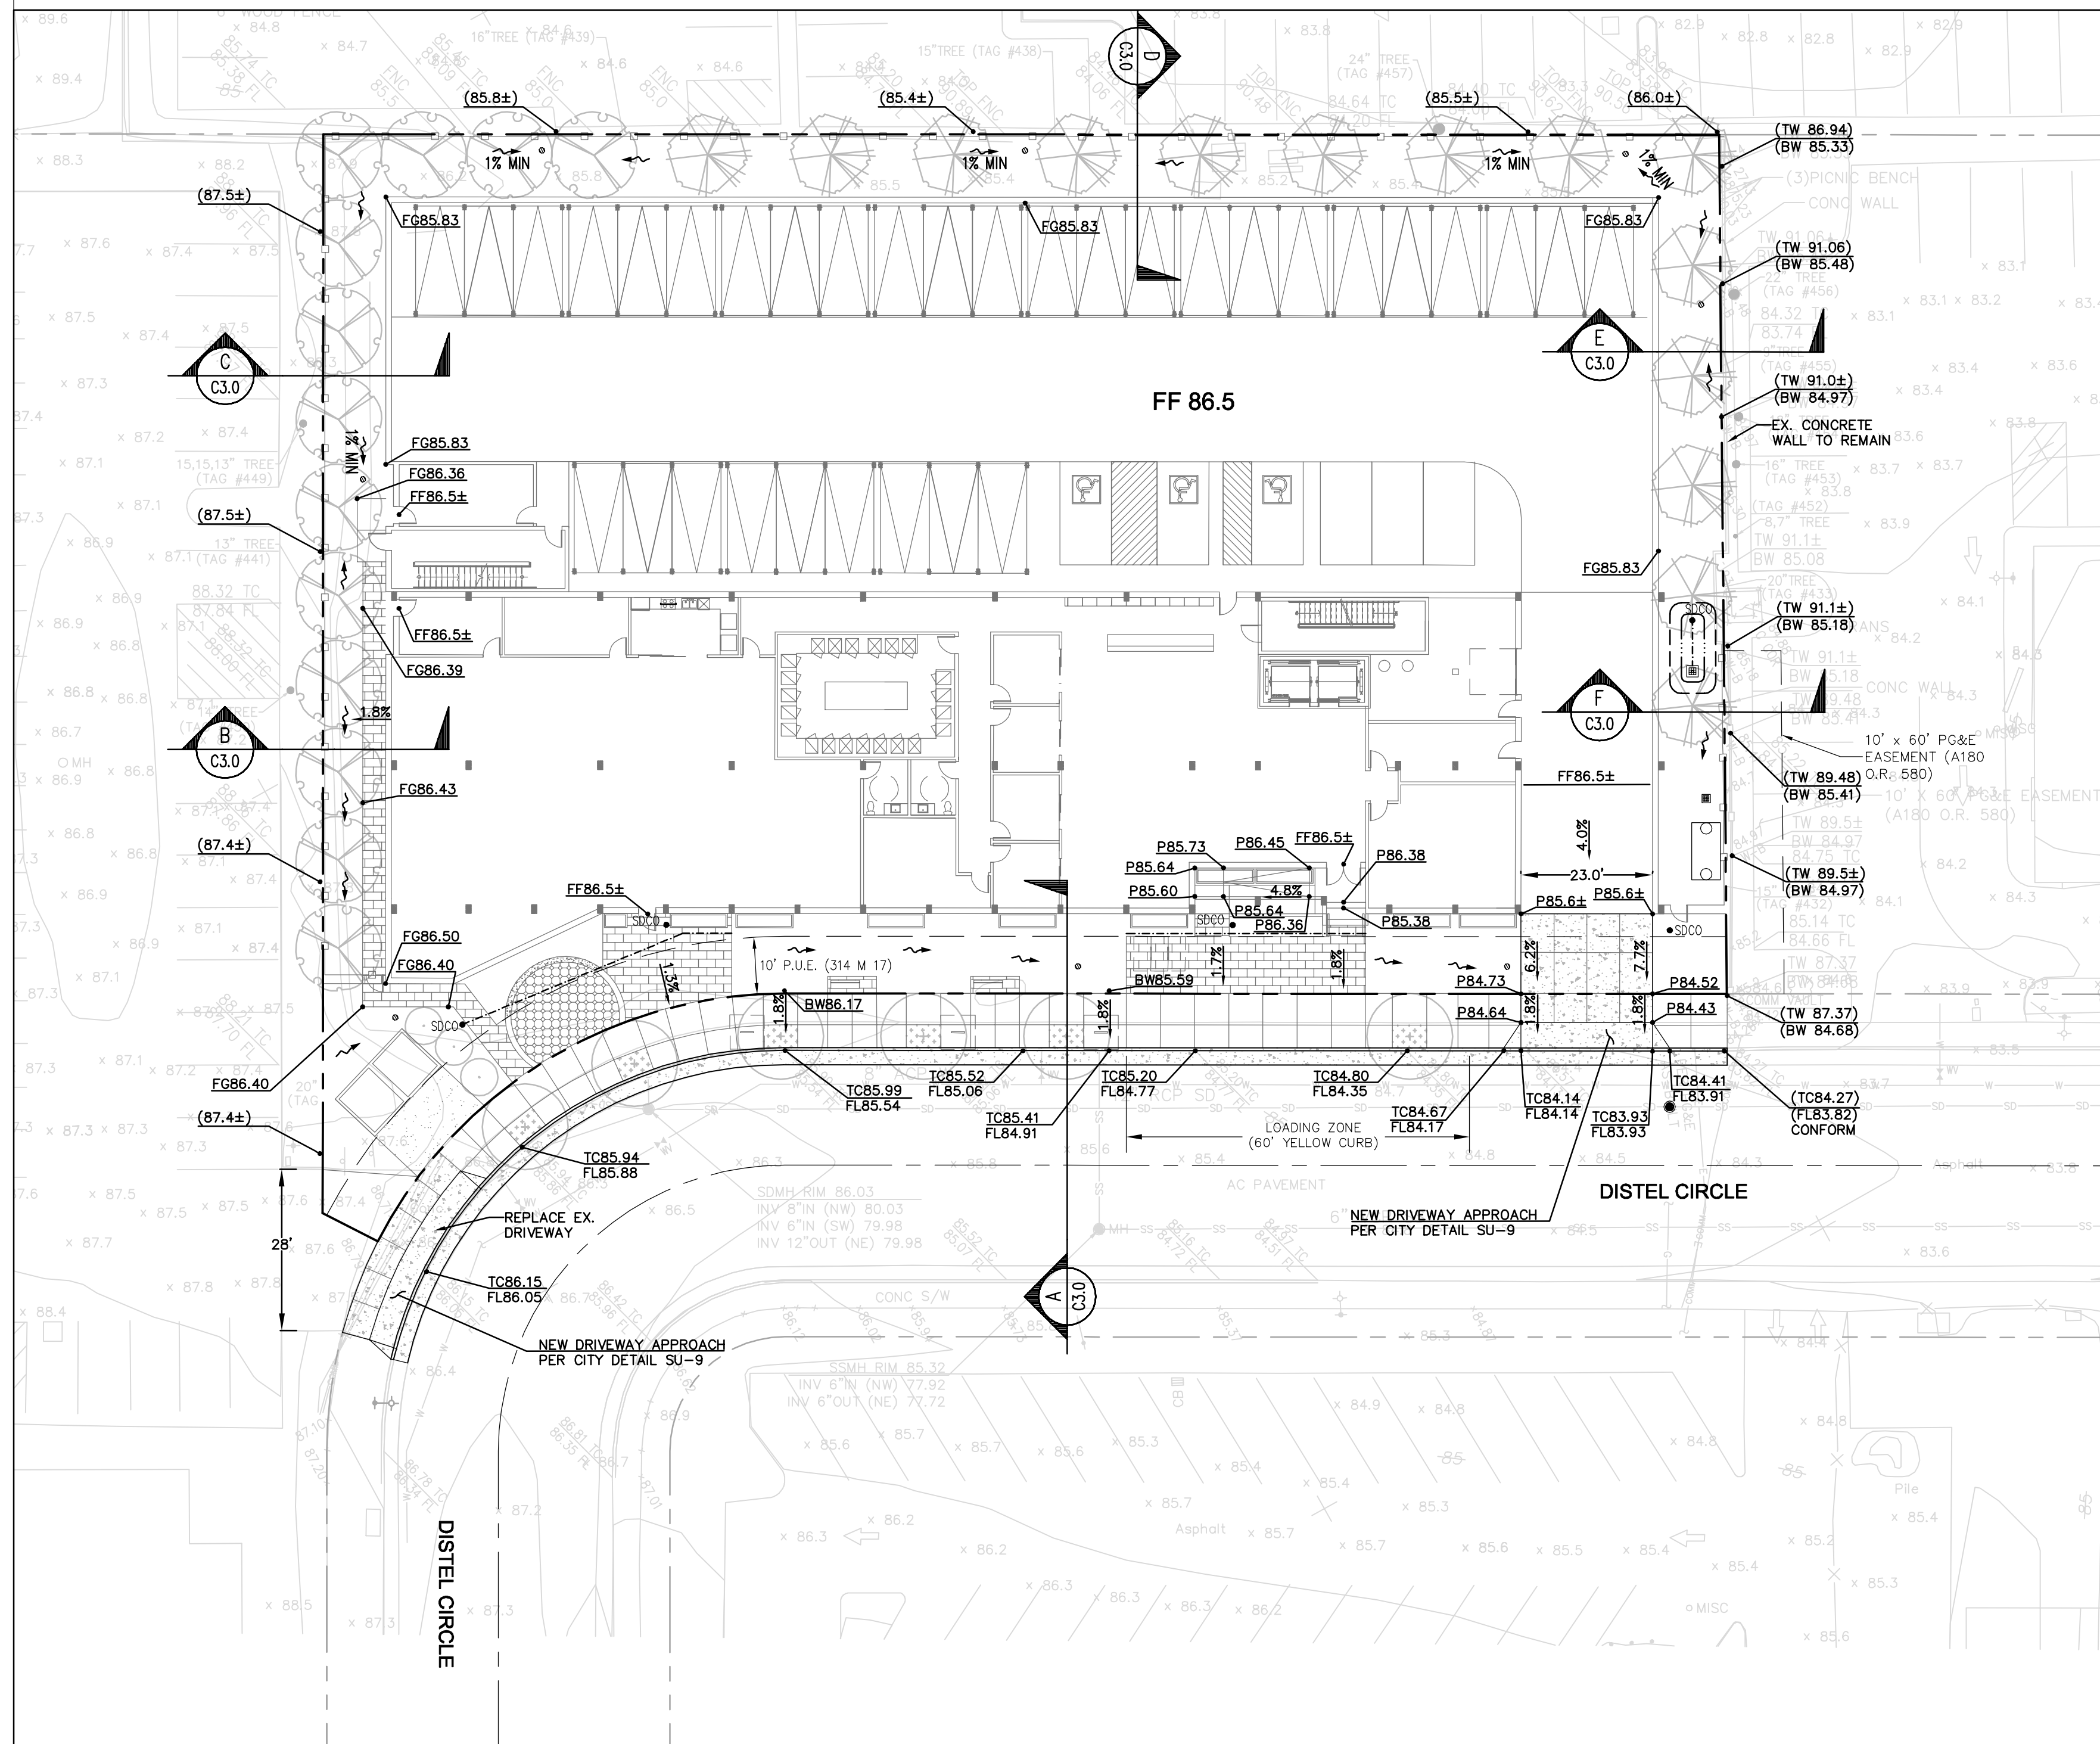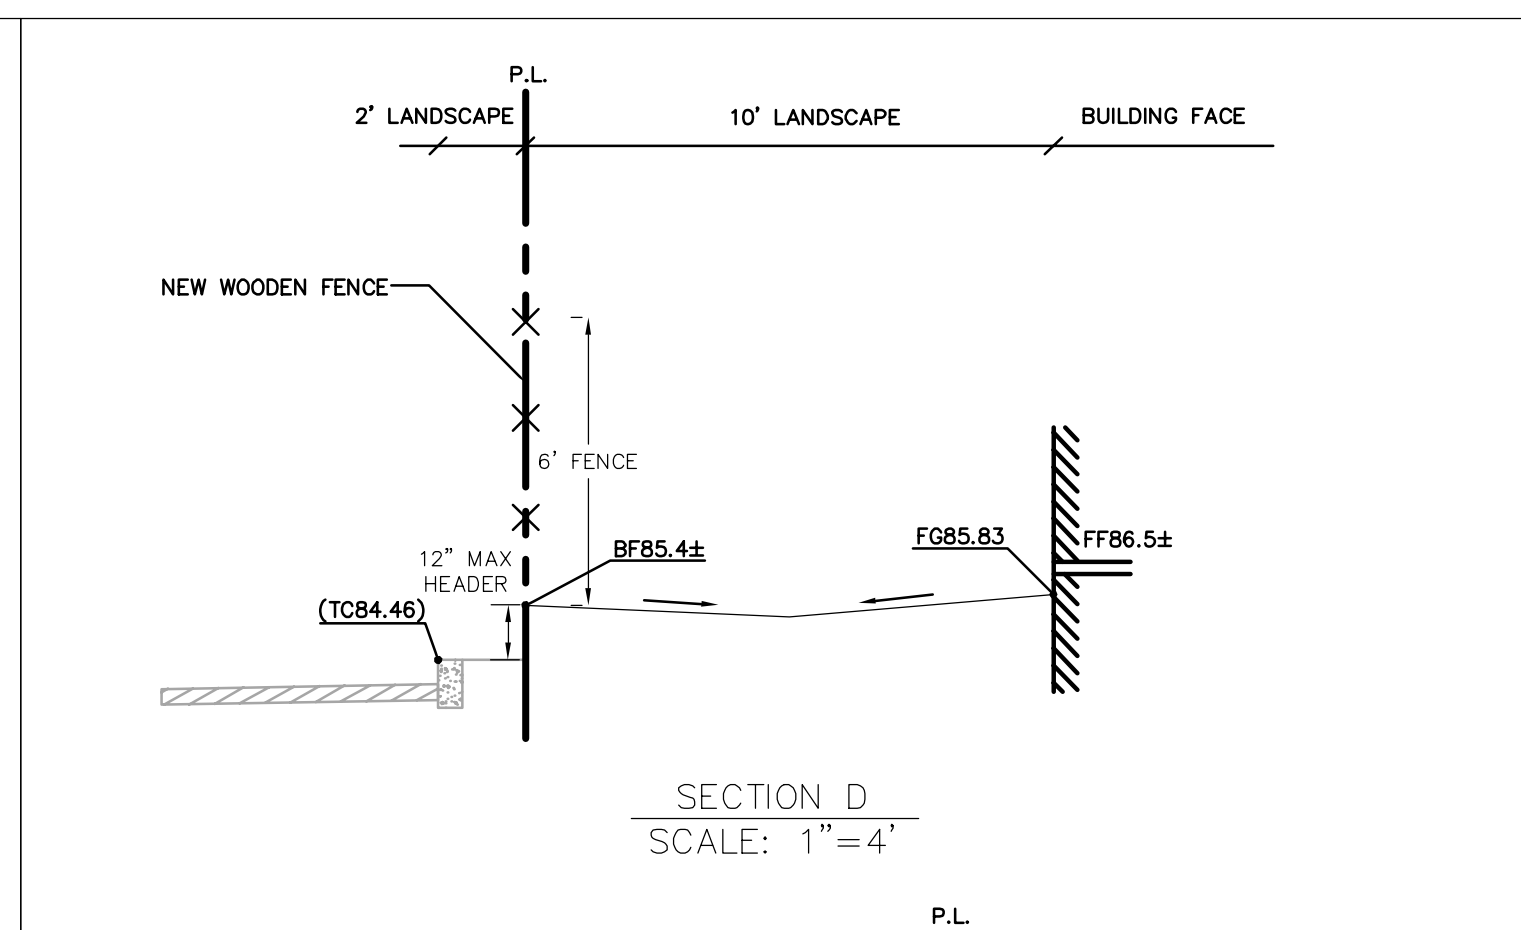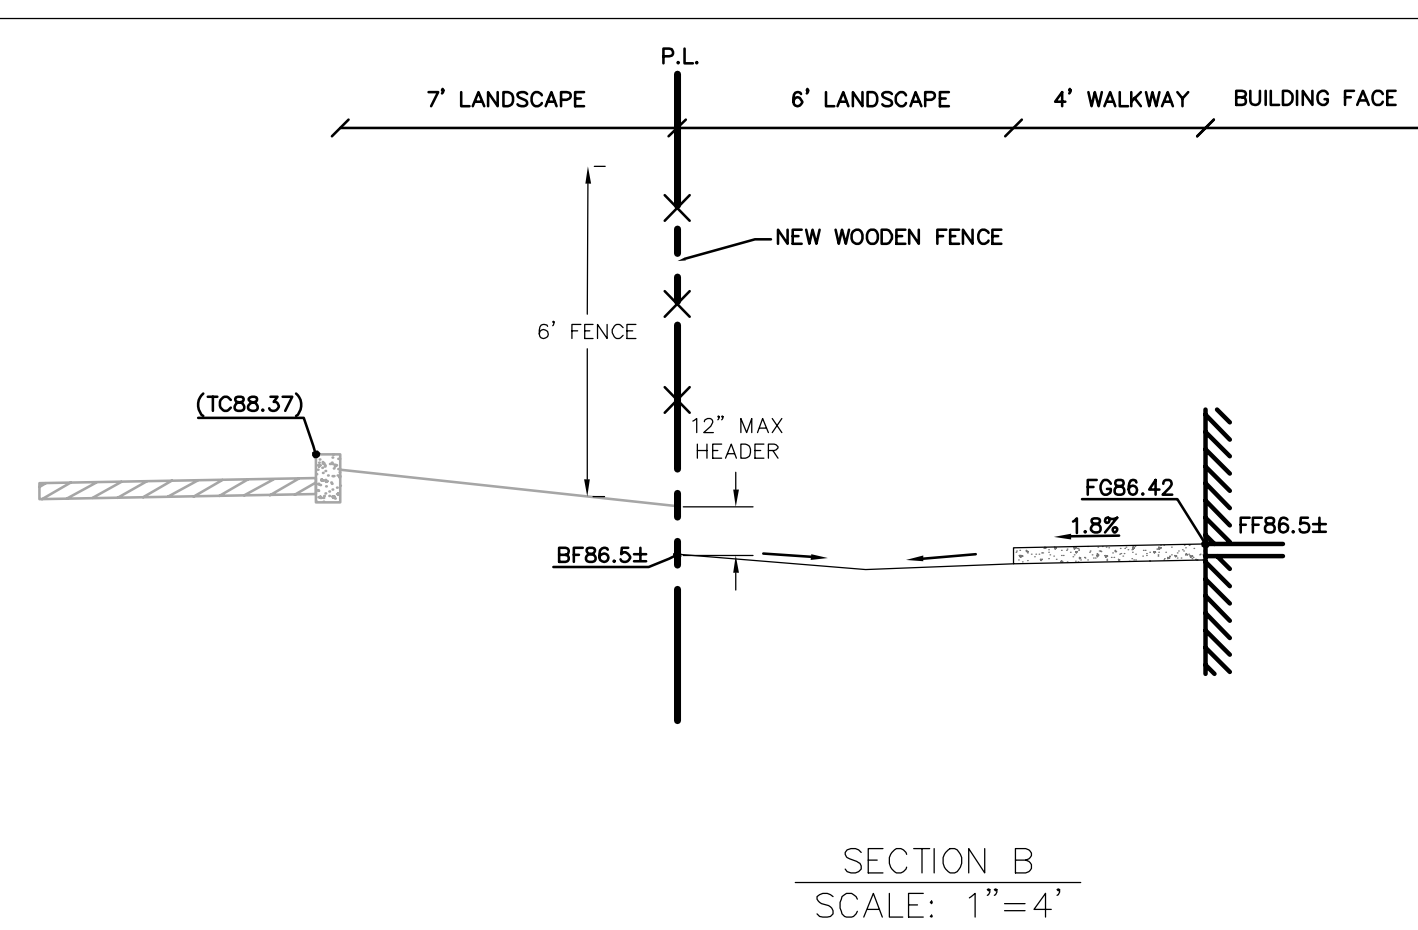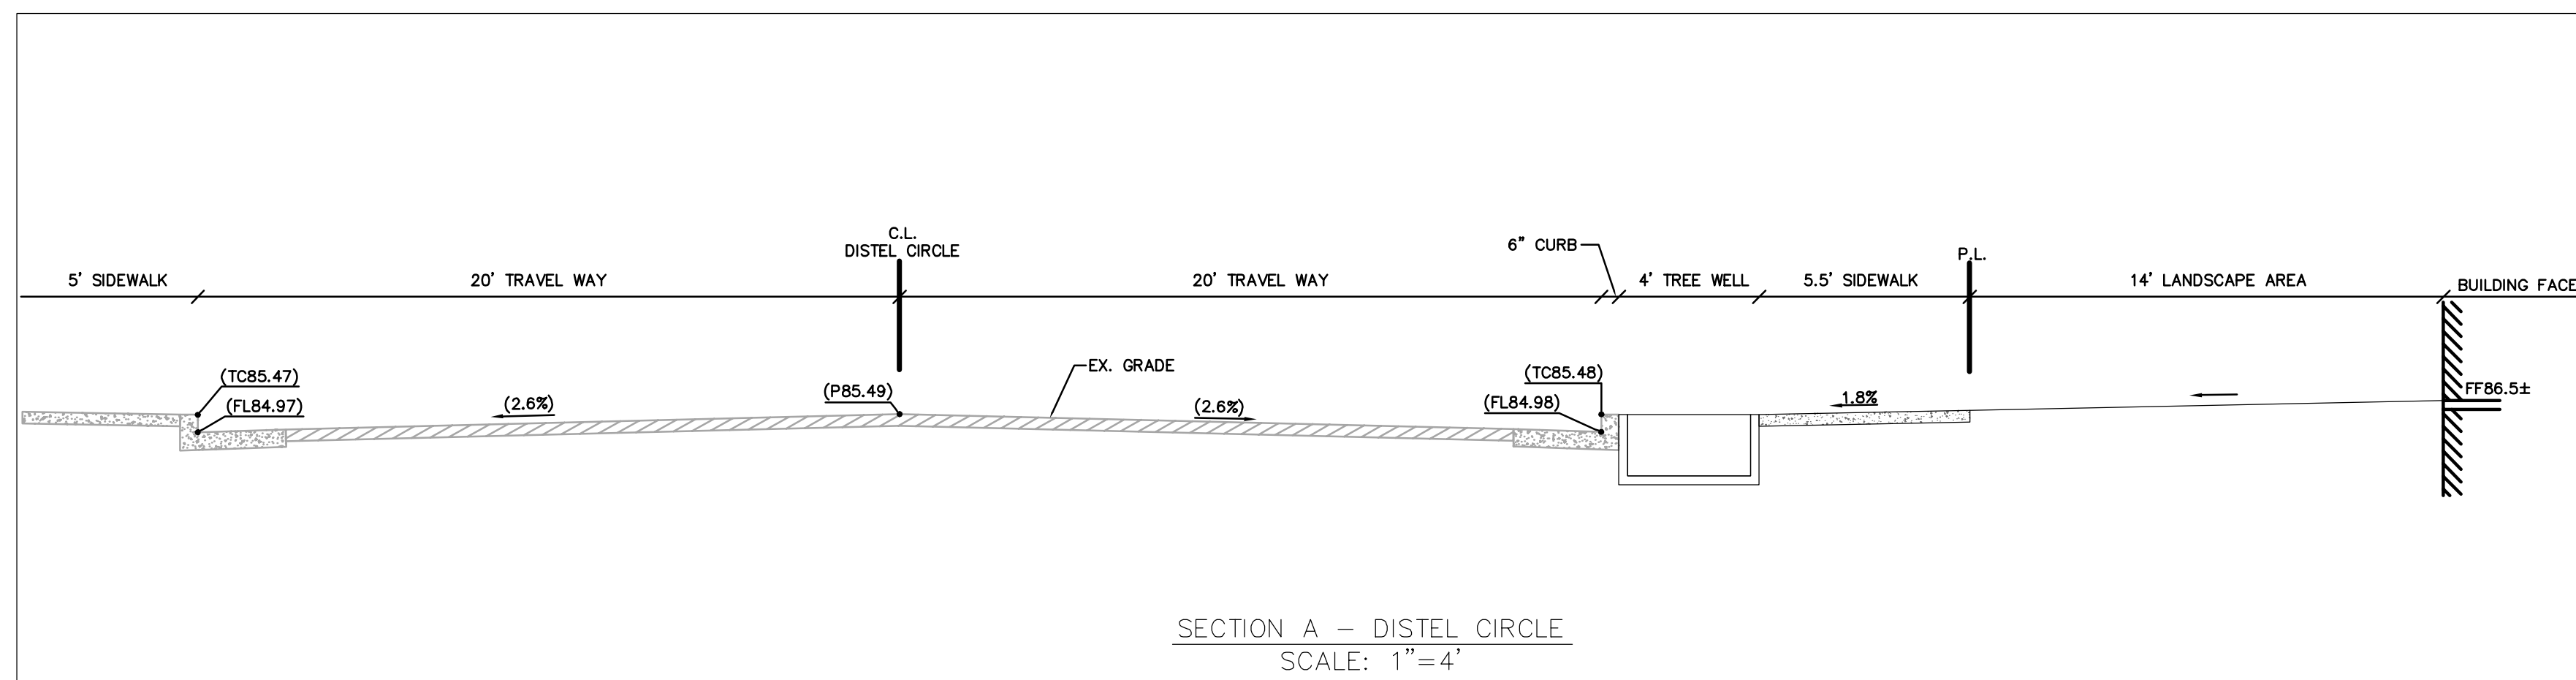

**EARTH WORK QUANTITIES**

CUT (ON & OFF SITE): 350 CY  
 FILL (ON & OFF SITE): 900 CY  
 NET (ON & OFF SITE): 550 CY (IMPORT)

NOTE: DOES NOT INCLUDE PAVEMENT AND CONCRETE FOUNDATIONS REMOVED DURING DEMOLITION. EARTHWORK QUANTITIES SHOWN ARE APPROXIMATE. IT SHALL BE THE CONTRACTOR'S RESPONSIBILITY TO INDEPENDENTLY ESTIMATE QUANTITIES FOR HIS/HER OWN USE.

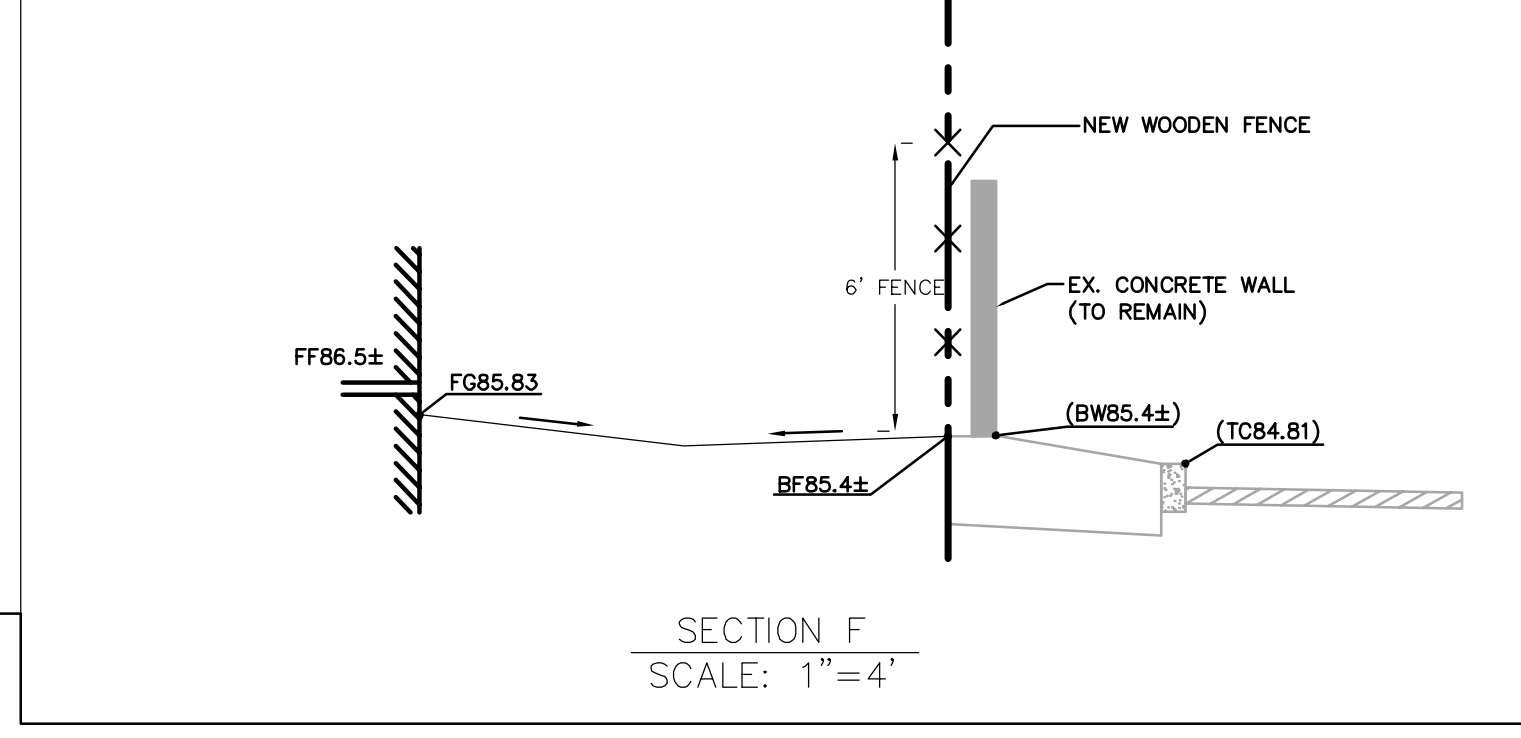


**LEGEND**

- PROPERTY LINE
- - - EASEMENT
- CURB & GUTTER
- (xx.xx) EXISTING GRADE
- [Pattern] NEW CONCRETE
- [Pattern] PAVERS (S.L.D.)
- [Pattern] DECOMPOSED GRANITE
- (Tree Symbol) TREES (S.L.D.)
- (Tree Well Symbol) TREE WELL (S.L.D.)
- (Fence Symbol) 6' WOOD FENCE (S.L.D.)


**ABBREVIATIONS**

- AC ASPHALT CONCRETE
- BF BOTTOM OF FENCE
- BFP BACK FLOW PREVENTER
- BW BACK OF WALK
- DCDA DOUBLE CHECK DETECTOR ASSEMBLY
- DW DOMESTIC WATER
- EX EXISTING
- FDC FIRE DEPARTMENT CONTROL
- FF FINISHED FLOOR
- FG FINISHED GRADE
- FH FIRE HYDRANT
- FL FLOW LINE
- FW FIRE WATER
- P PAVEMENT
- PUE PUBLIC UTILITY EASEMENT
- RWL RAIN WATER LEADER
- SD STORM DRAIN
- SDAD STORM DRAIN AREA DRAIN
- SDDI STORM DRAIN DRAINAGE INLET
- SDJB STORM DRAIN JUNCTION BOX
- SDMH STORM DRAIN MANHOLE
- S.L.D. SEE LANDSCAPE DRAWINGS
- SS SANITARY SEWER
- SSCO SANITARY SEWER CLEANOUT
- SSMH SANITARY SEWER MANHOLE
- TC TOP OF CURB
- TW TOP OF WALL
- W WATER
- WH WHARF HYDRANT
- WM WATER METER
- WV WATER VALVE

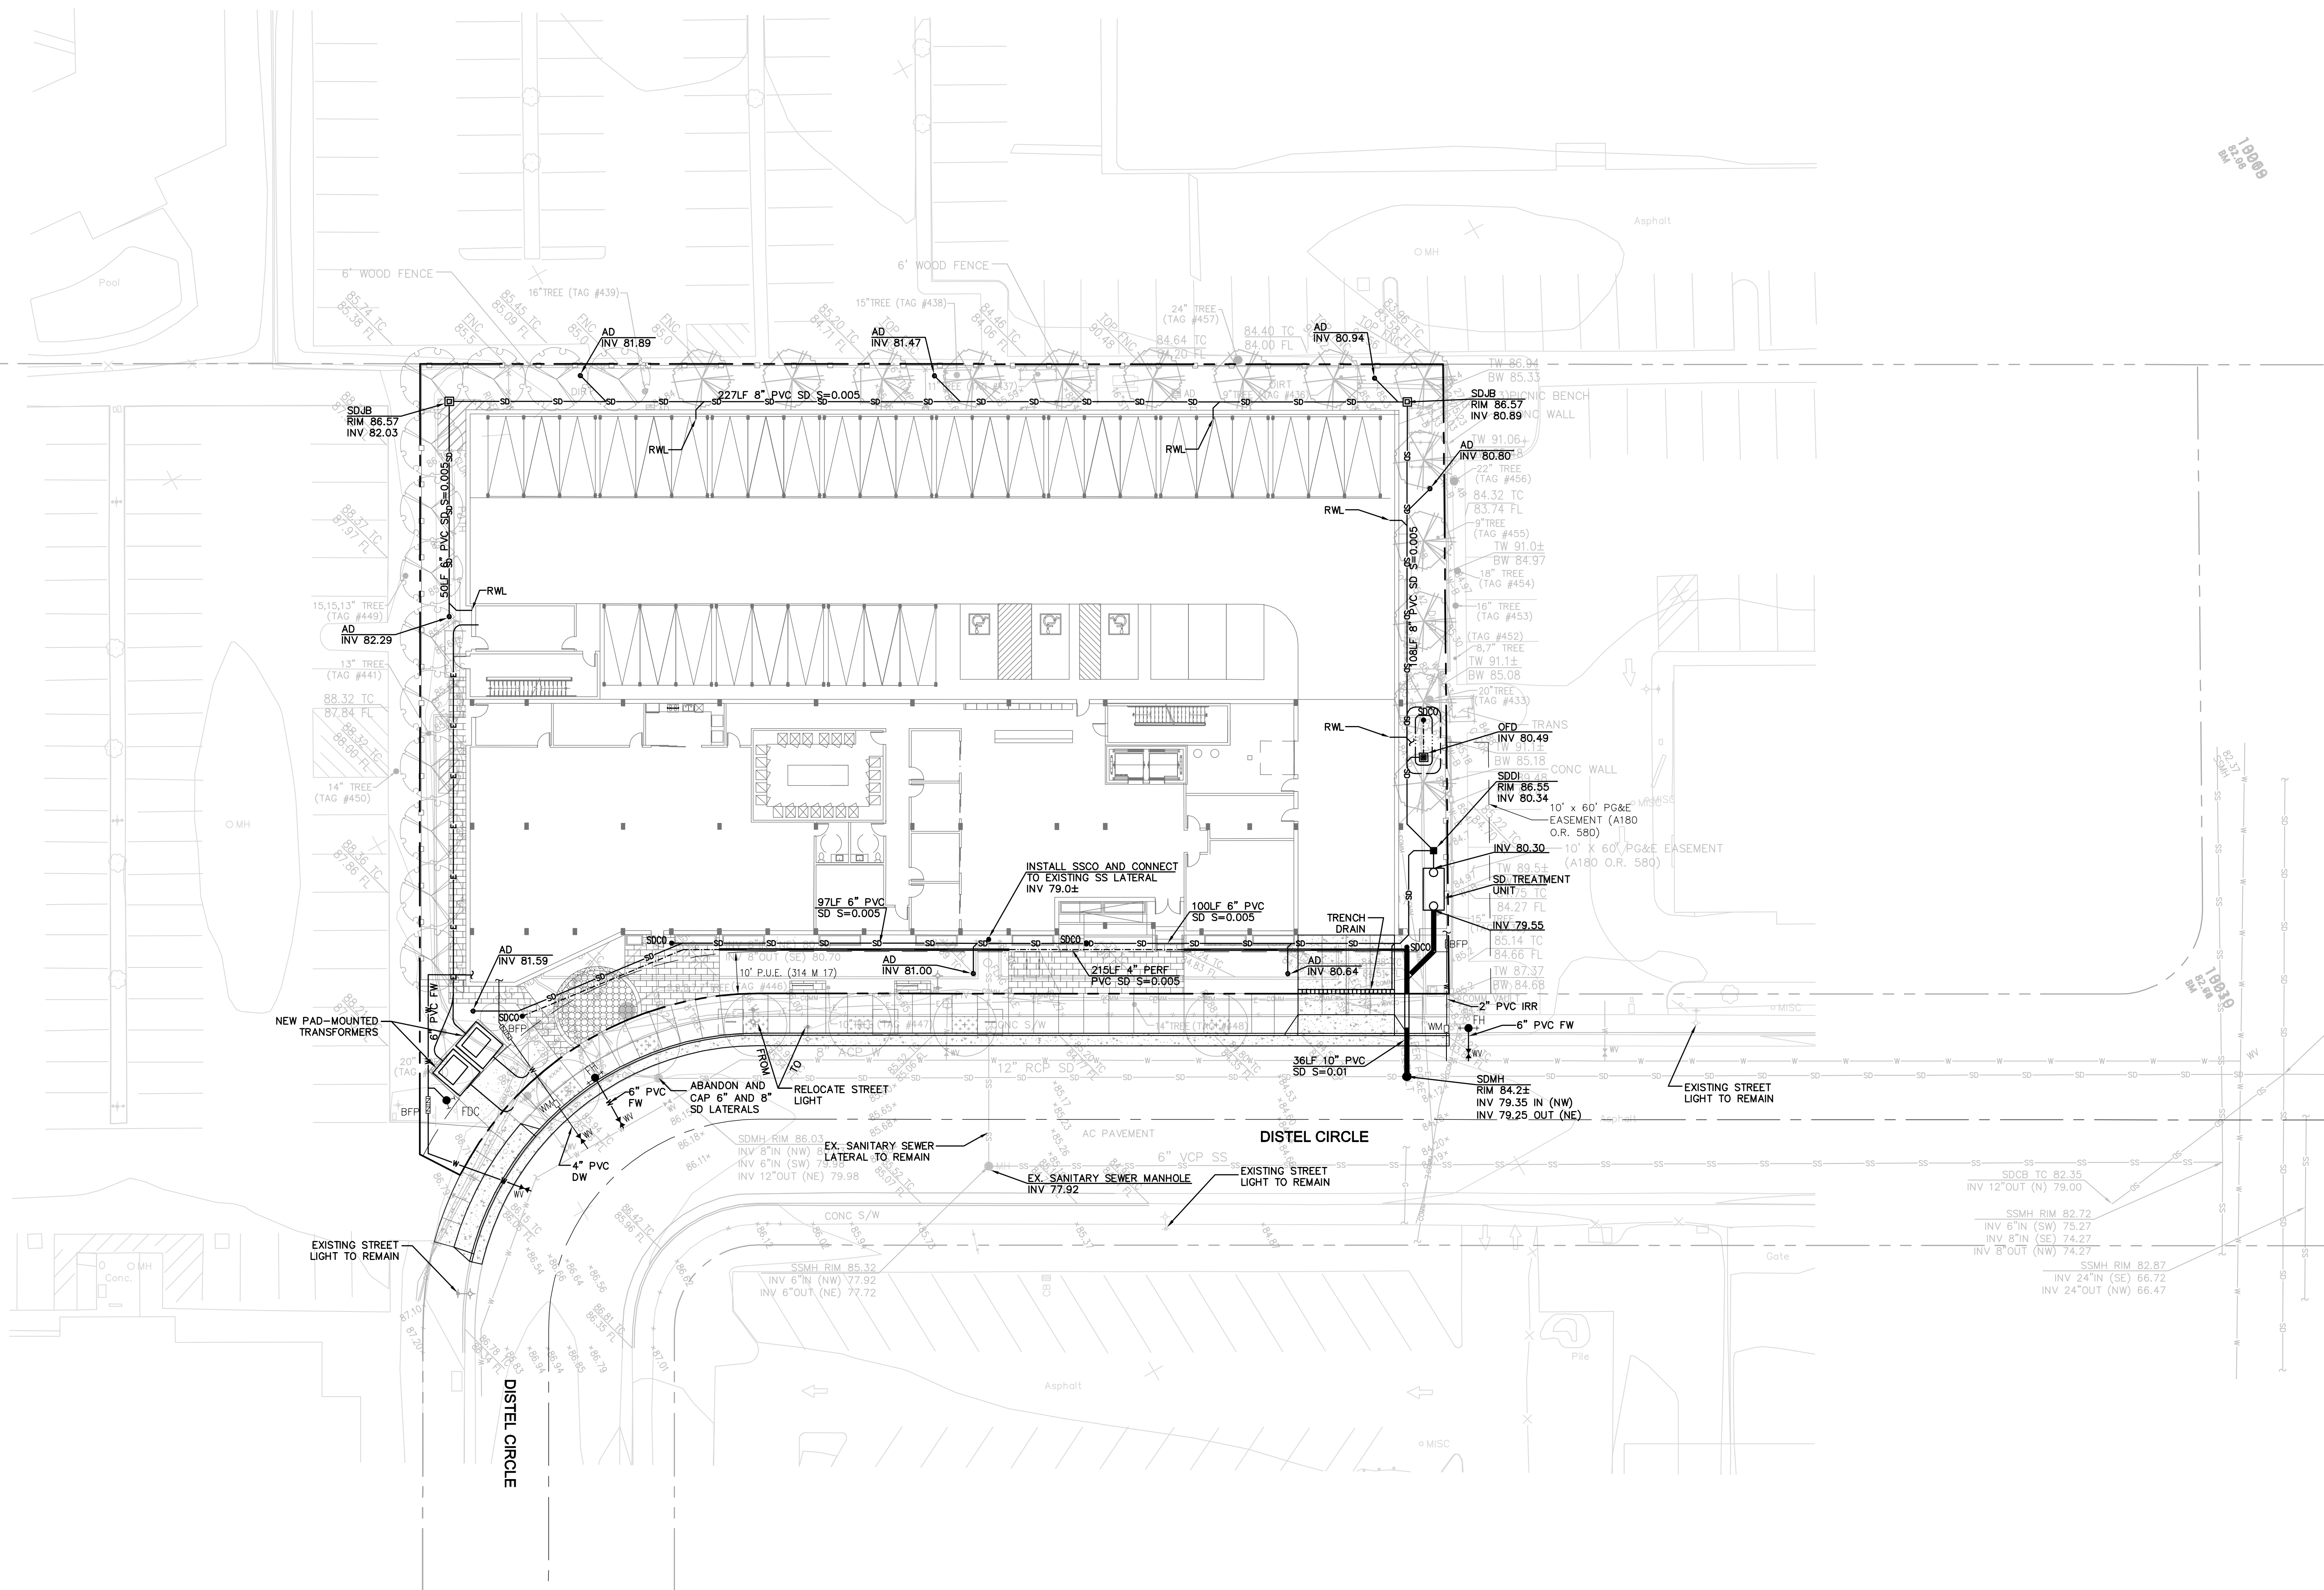

ABBREVIATIONS	
AC	ASPHALT CONCRETE
AD	AREA DRAIN
BFP	BACK FLOW PREVENTER
BW	BACK OF WALK
DCDA	DOUBLE CHECK DETECTOR ASSEMBLY
DW	DOMESTIC WATER
EX	EXISTING
FDC	FIRE DEPARTMENT CONTROL
FF	FINISHED FLOOR
FG	FINISHED GRADE
FH	FIRE HYDRANT
FL	FLOW LINE
FW	FIRE WATER
PUE	PUBLIC UTILITY EASEMENT
PV	PAVEMENT
RWL	RAIN WATER LEADER
SD	STORM DRAIN
SDDI	STORM DRAIN DRAINAGE INLET
SDJB	STORM DRAIN JUNCTION BOX
SDMH	STORM DRAIN MANHOLE
SS	SANITARY SEWER
SSCO	SANITARY SEWER CLEANOUT
SSMH	SANITARY SEWER MANHOLE
TC	TOP OF CURB
TW	TOP OF WALL
W	WATER
WH	WHARF HYDRANT
WM	WATER METER
WV	WATER VALVE

LEGEND	
---	PROPERTY LINE
---	EASEMENT
---	CURB & GUTTER
---	SANITARY SEWER LINE
---	STORM DRAIN LINE (PERFORATED)
---	STORM DRAIN LINE (UNTREATED)
---	STORM DRAIN LINE (TREATED)
---	GAS LINE
---	COMMUNICATIONS LINE
---	WATER LINE
---	ELECTRICAL LINE
●	MANHOLE
WV	WATER VALVE
SSCO	SANITARY SEWER CLEANOUT
SDCO	STORM DRAIN CLEANOUT
BFP	BACKFLOW PREVENTER
WM	WATER METER
SDJB	STORM DRAIN JUNCTION BOX
SDTU	STORM DRAIN TREATMENT UNIT
ET	ELECTRICAL TRANSFORMER
AD	STORM DRAIN AREA DRAIN
FDC	FIRE DEPARTMENT CONTROL
FH	FIRE HYDRANT
SDDI	STORM DRAIN DRAINAGE INLET
Trench	STORM DRAIN TRENCH DRAIN

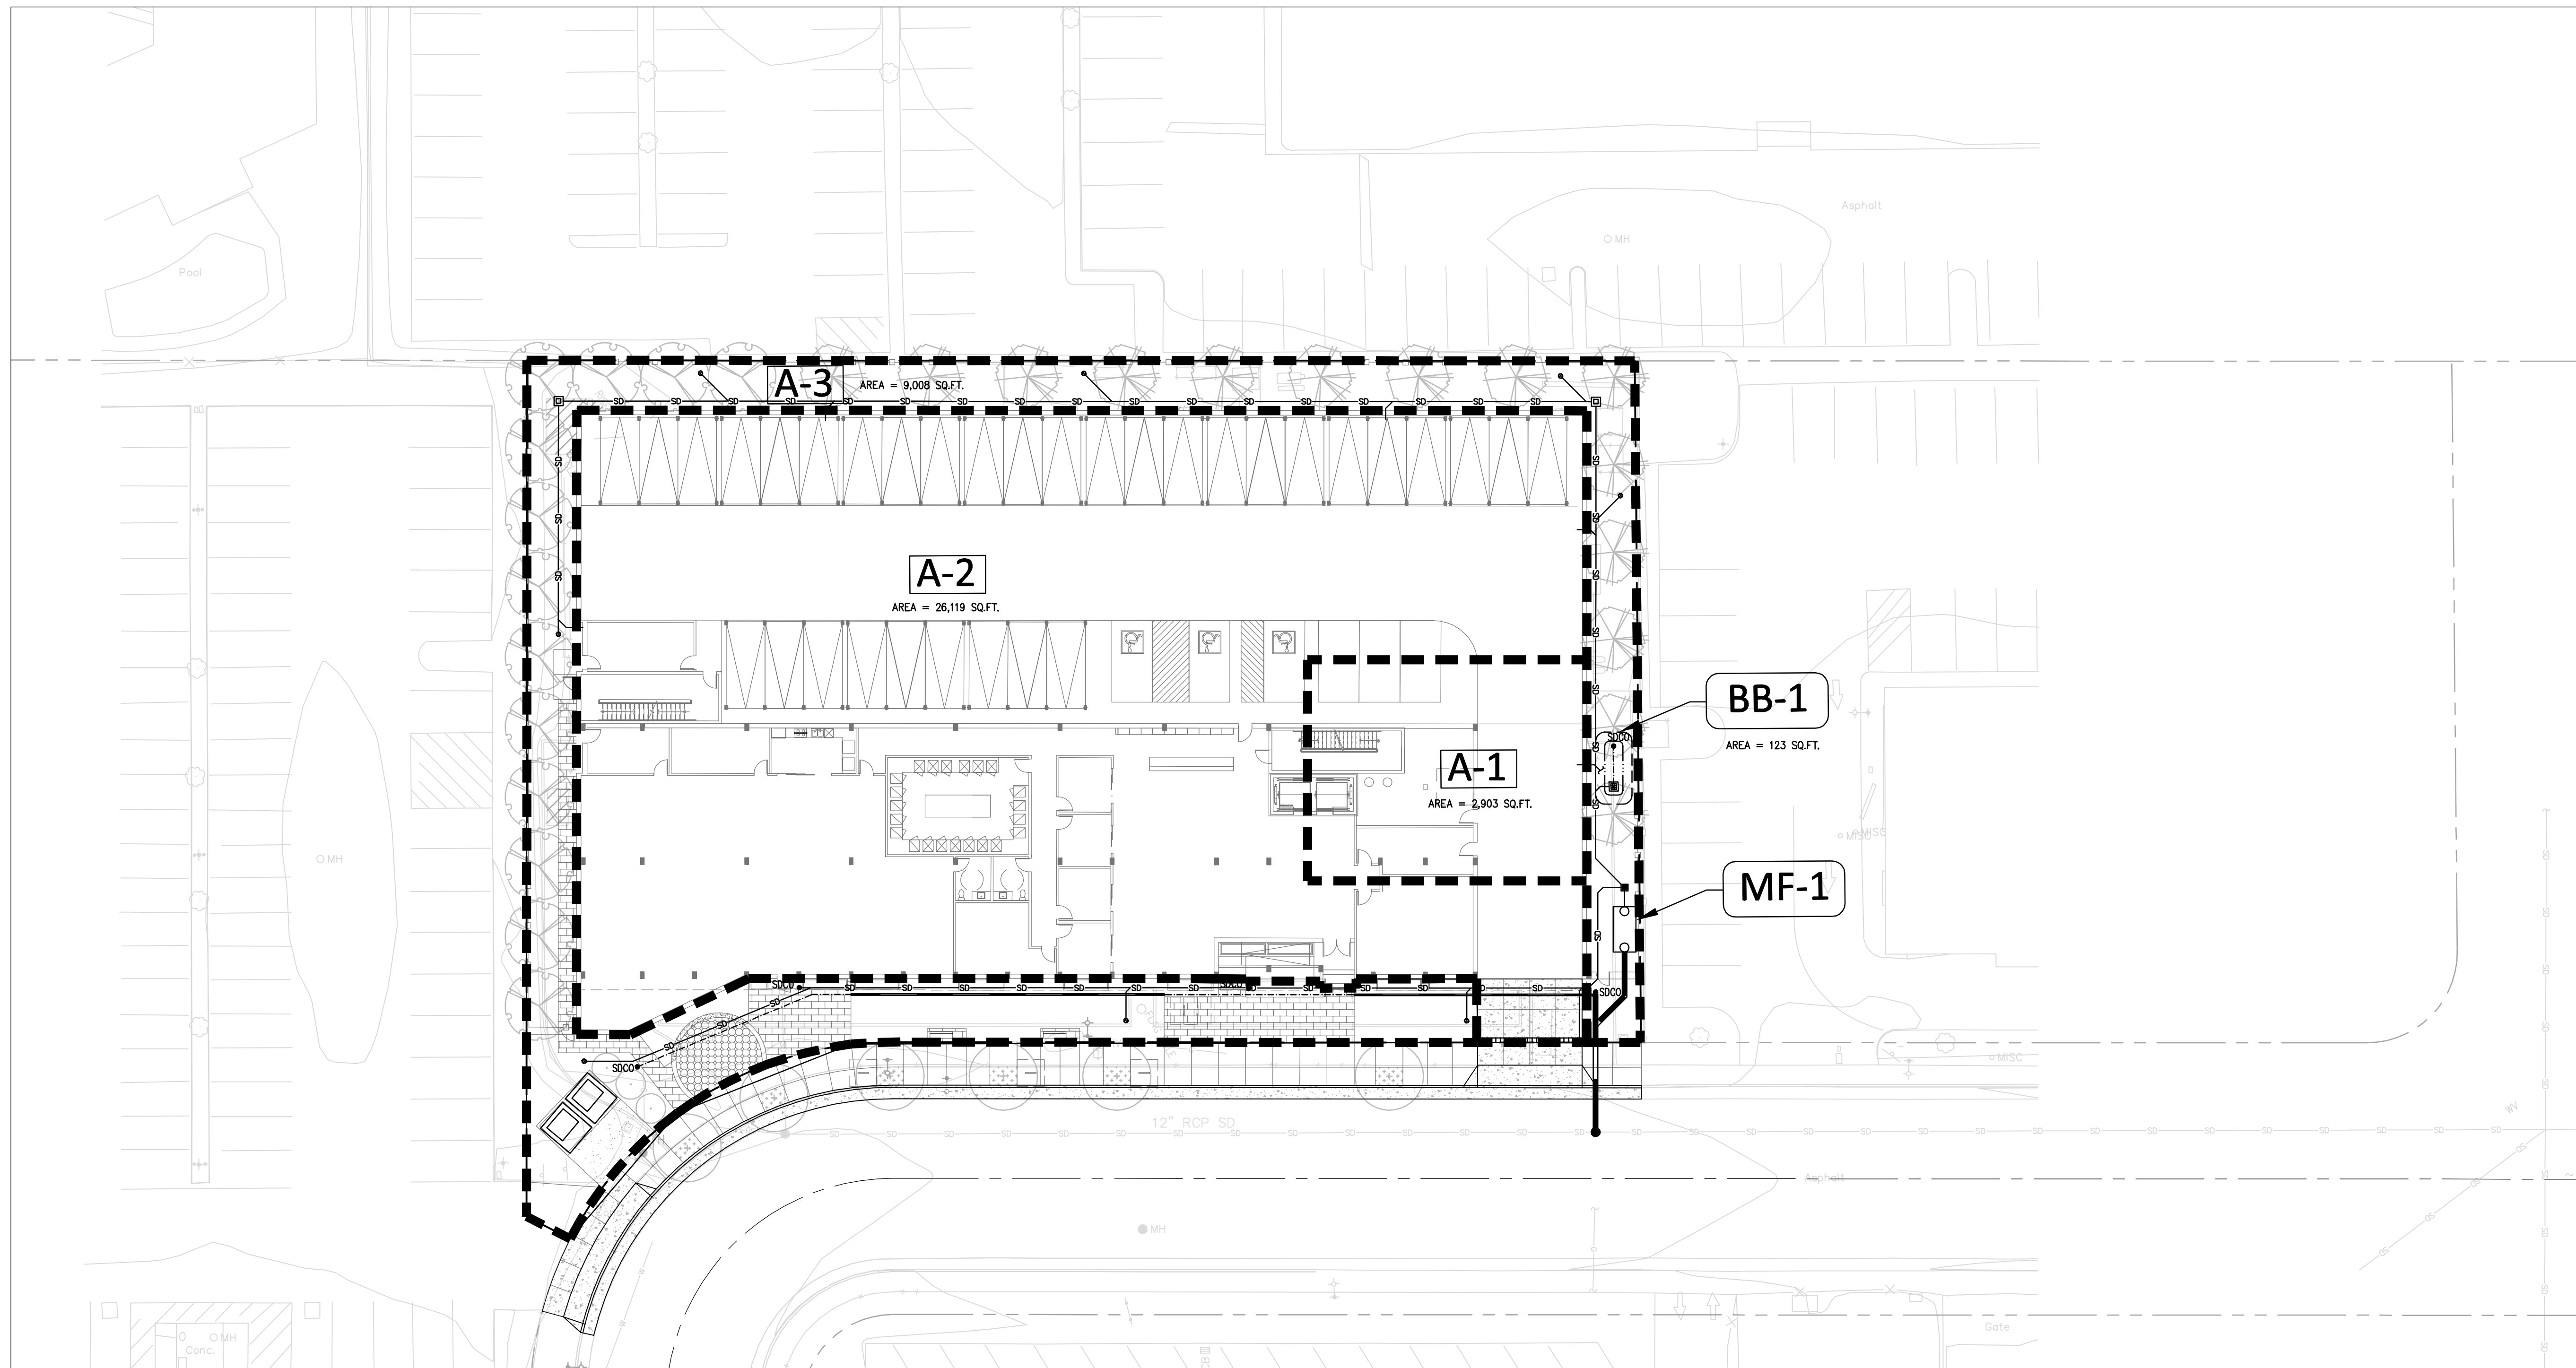

ABBREVIATIONS	
AC	ASPHALT CONCRETE
AD	AREA DRAIN
BFP	BACK FLOW PREVENTER
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FL	FLOW LINE
FW	FIRE WATER
PUE	PUBLIC UTILITY EASEMENT
PV	PAVEMENT
RWL	RAIN WATER LEADER
SD	STORM DRAIN
SDDI	STORM DRAIN DRAINAGE INLET
SDJB	STORM DRAIN JUNCTION BOX
SDMH	STORM DRAIN MANHOLE
SS	SANITARY SEWER
SSCO	SANITARY SEWER CLEANOUT
SSMH	SANITARY SEWER MANHOLE
TC	TOP OF CURB
TW	TOP OF WALL
W	WATER
WH	WHARF HYDRANT
WM	WATER METER
WV	WATER VALVE

LEGEND	
---	PROPERTY LINE
- - -	EASEMENT
■ ■ ■ ■	DRAINAGE AREA BOUNDARY
---	STORM DRAIN LINE (PERFORATED)
---	STORM DRAIN LINE (UNTREATED)
---	STORM DRAIN LINE (TREATED)
●	MANHOLE
SDCO ●	STORM DRAIN CLEANOUT
⊠	STORM DRAIN JUNCTION BOX
□	STORM DRAIN TREATMENT UNIT
○	STORM DRAIN AREA DRAIN
■	STORM DRAIN DRAINAGE INLET
---	STORM DRAIN TRENCH DRAIN
A-1	DRAINAGE AREA
BB-1	BIORETENTION BASIN TREATMENT AREA
MF-1	MEDIA FILTER TREATMENT AREA

**C.3 TREATMENT FACILITIES CONSTRUCTION NOTES:**

- DURING THE BEGINNING OF THE CONSTRUCTION, THE PROJECT APPLICANT SHALL ARRANGE FOR A SITE VISIT (INSPECTION) BY A THIRD-PARTY REVIEWER ACCEPTABLE TO THE CITY OF LOS ALTOS THAT THE INSTALLED STORMWATER TREATMENT MEASURES HAVE BEEN CONSTRUCTED IN ACCORDANCE WITH THE APPROVED BUILDING PLANS. THE THIRD-PARTY REVIEWER WILL RECOMMEND THE REQUIRED NUMBER OF SITE INSPECTIONS AT DIFFERENT INTERVALS OF CONSTRUCTION. THE THIRD-PARTY REVIEWER MUST BE A CIVIL ENGINEER, ARCHITECT OR LANDSCAPE ARCHITECT REGISTERED IN THE STATE OF CALIFORNIA AND MUST HAVE A CURRENT TRAINING ON STORMWATER TREATMENT DESIGN. A LIST OF QUALIFIED THIRD-PARTY REVIEWERS CAN BE FOUND ON THE SANTA CLARA VALLEY URBAN RUNOFF POLLUTION PREVENTION PROGRAM (SCVURPPP) WEBSITE AT: WWW.SCVURPPP-W2K.COM/CONSULTANTS\_LIST.SHTML
- INSTALLATION OF POROUS PAVEMENT AND/OR VAULTS SHALL BE DONE PER STANDARD DETAILS AND SPECIFICATIONS. THIRD PARTY REVIEWER OR VENDOR SHALL INSPECT THE POROUS PAVEMENT AND/OR VAULTS INSTALLATION (INCLUDING IF NECESSARY, PERFORMING PERCOLATION TEST) AND SUBMIT THEIR CONCURRENCE LETTER TO THE CITY OF LOS ALTOS.

DRAINAGE AREA	DRAINAGE AREA SIZE (SF)	PERVIOUS SURFACE (SF)	TYPE OF PERVIOUS SURFACE	IMPERVIOUS SURFACE (SF)	TYPE OF IMPERVIOUS SURFACE	4% RULE		PROPOSED TREATMENT CONTROLS
						REQUIRED	PROVIDED	
A1	2,903	0	LANDSCAPE	2903	ROOF	116	123	BB-1
A2	26,119	0	LANDSCAPE	26119	CONCRETE/ROOF	-	-	MF-1*
A3	9,008	9008	LANDSCAPE	0	LANDSCAPE/PERMEABLE PAVERS	-	-	-
<b>TOTALS</b>	<b>38030</b>	<b>9008</b>		<b>29022</b>		<b>116</b>	<b>123</b>	

\* THIS PROJECT MEETS THE SPECIAL PROJECT C: AFFORDABLE HOUSING DEVELOPMENT CRITERIA FROM THE MUNICIPAL REGIONAL PERMIT 3.0, WHICH IS TENTATIVELY SCHEDULED TO GO INTO EFFECT JULY 2022. THIS PROJECT IS ALLOWED UP TO 90% LID REDUCTION CREDITS.

**STORMWATER TREATMENT AREA DATA**

TOTAL SITE AREA = 38,030 SQ. FT.  
 TOTAL SITE IMPERVIOUS AREA = 29,022 SQ. FT.  
 % IMPERVIOUS AREA TREATED BY MEDIA FILTERS = 90%  
 % IMPERVIOUS AREA TREATED BY LID TREATMENT = 10%



**SPECIAL PROJECT C: AFFORDABLE HOUSING PROJECT CREDIT SUMMARY:**

AFFORDABLE HOUSING CREDIT: 70%  
 DENSITY CREDIT: 15%  
 • THIS PROJECT IS PROJECTED TO HAVE AT LEAST 100 DU/AC  
 MINIMIZED SURFACE PARKING CREDITS: 5%  
 • THIS PROJECT HAS NO SURFACE PARKING.  
 LOCATION CREDIT: N/A  
 • THIS PROJECT IS NOT LOCATED WITHIN A 1/4 MILE RADIUS OF AN EXISTING OR PLANNED TRANSIT HUB.  
 • THIS PROJECT IS NOT LOCATED WITHIN A PLANNED PRIORITY DEVELOPMENT AREA (PDA).  
**TOTAL LID REDUCTION CREDIT: 90%**



**330 DISTEL CIRCLE**  
 LOS ALTOS # 2021-0042


**SUBMITTAL #2**  
 APRIL 29, 2022

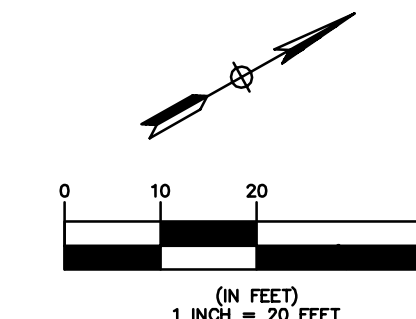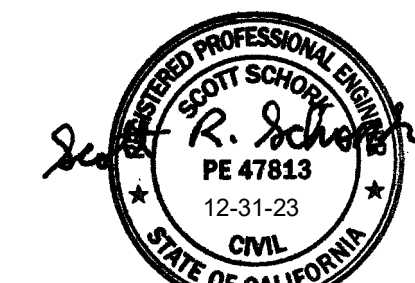


**PRELIMINARY STORMWATER CONTROL PLAN**

**C5.0**



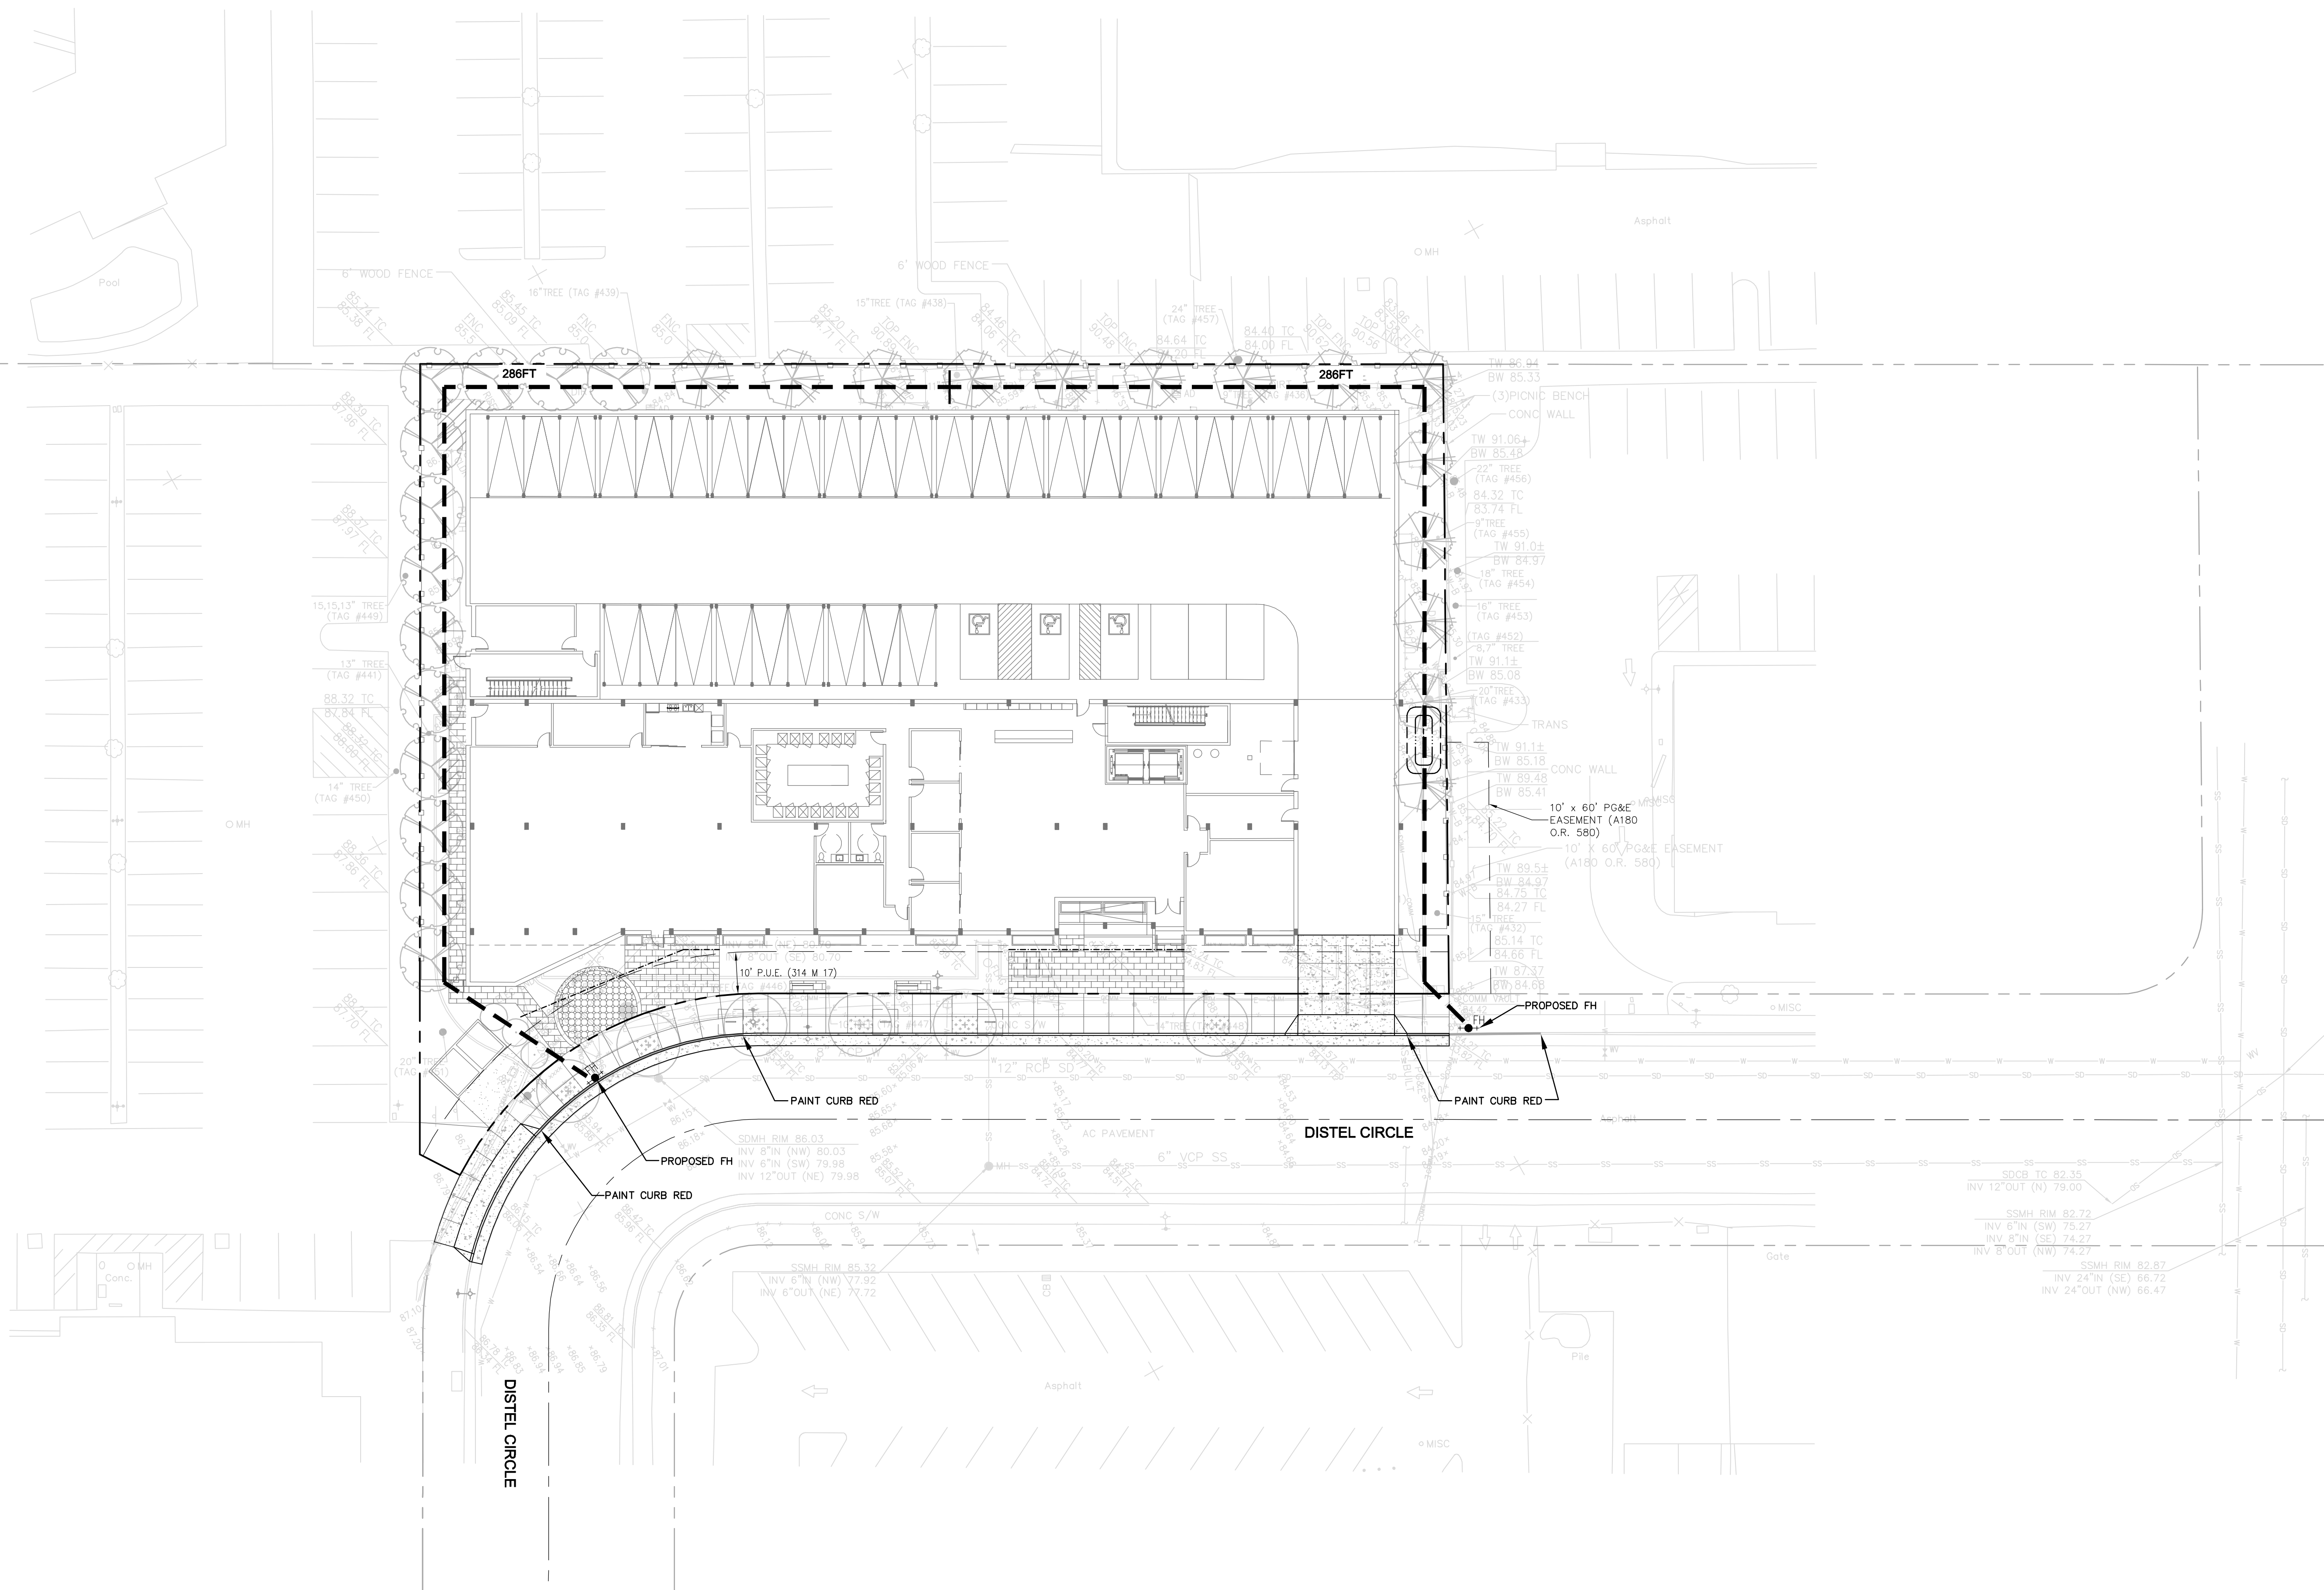

LEGEND	
	PROPERTY LINE
	EASEMENT
	CURB & GUTTER
	FIRE HOSE REACH

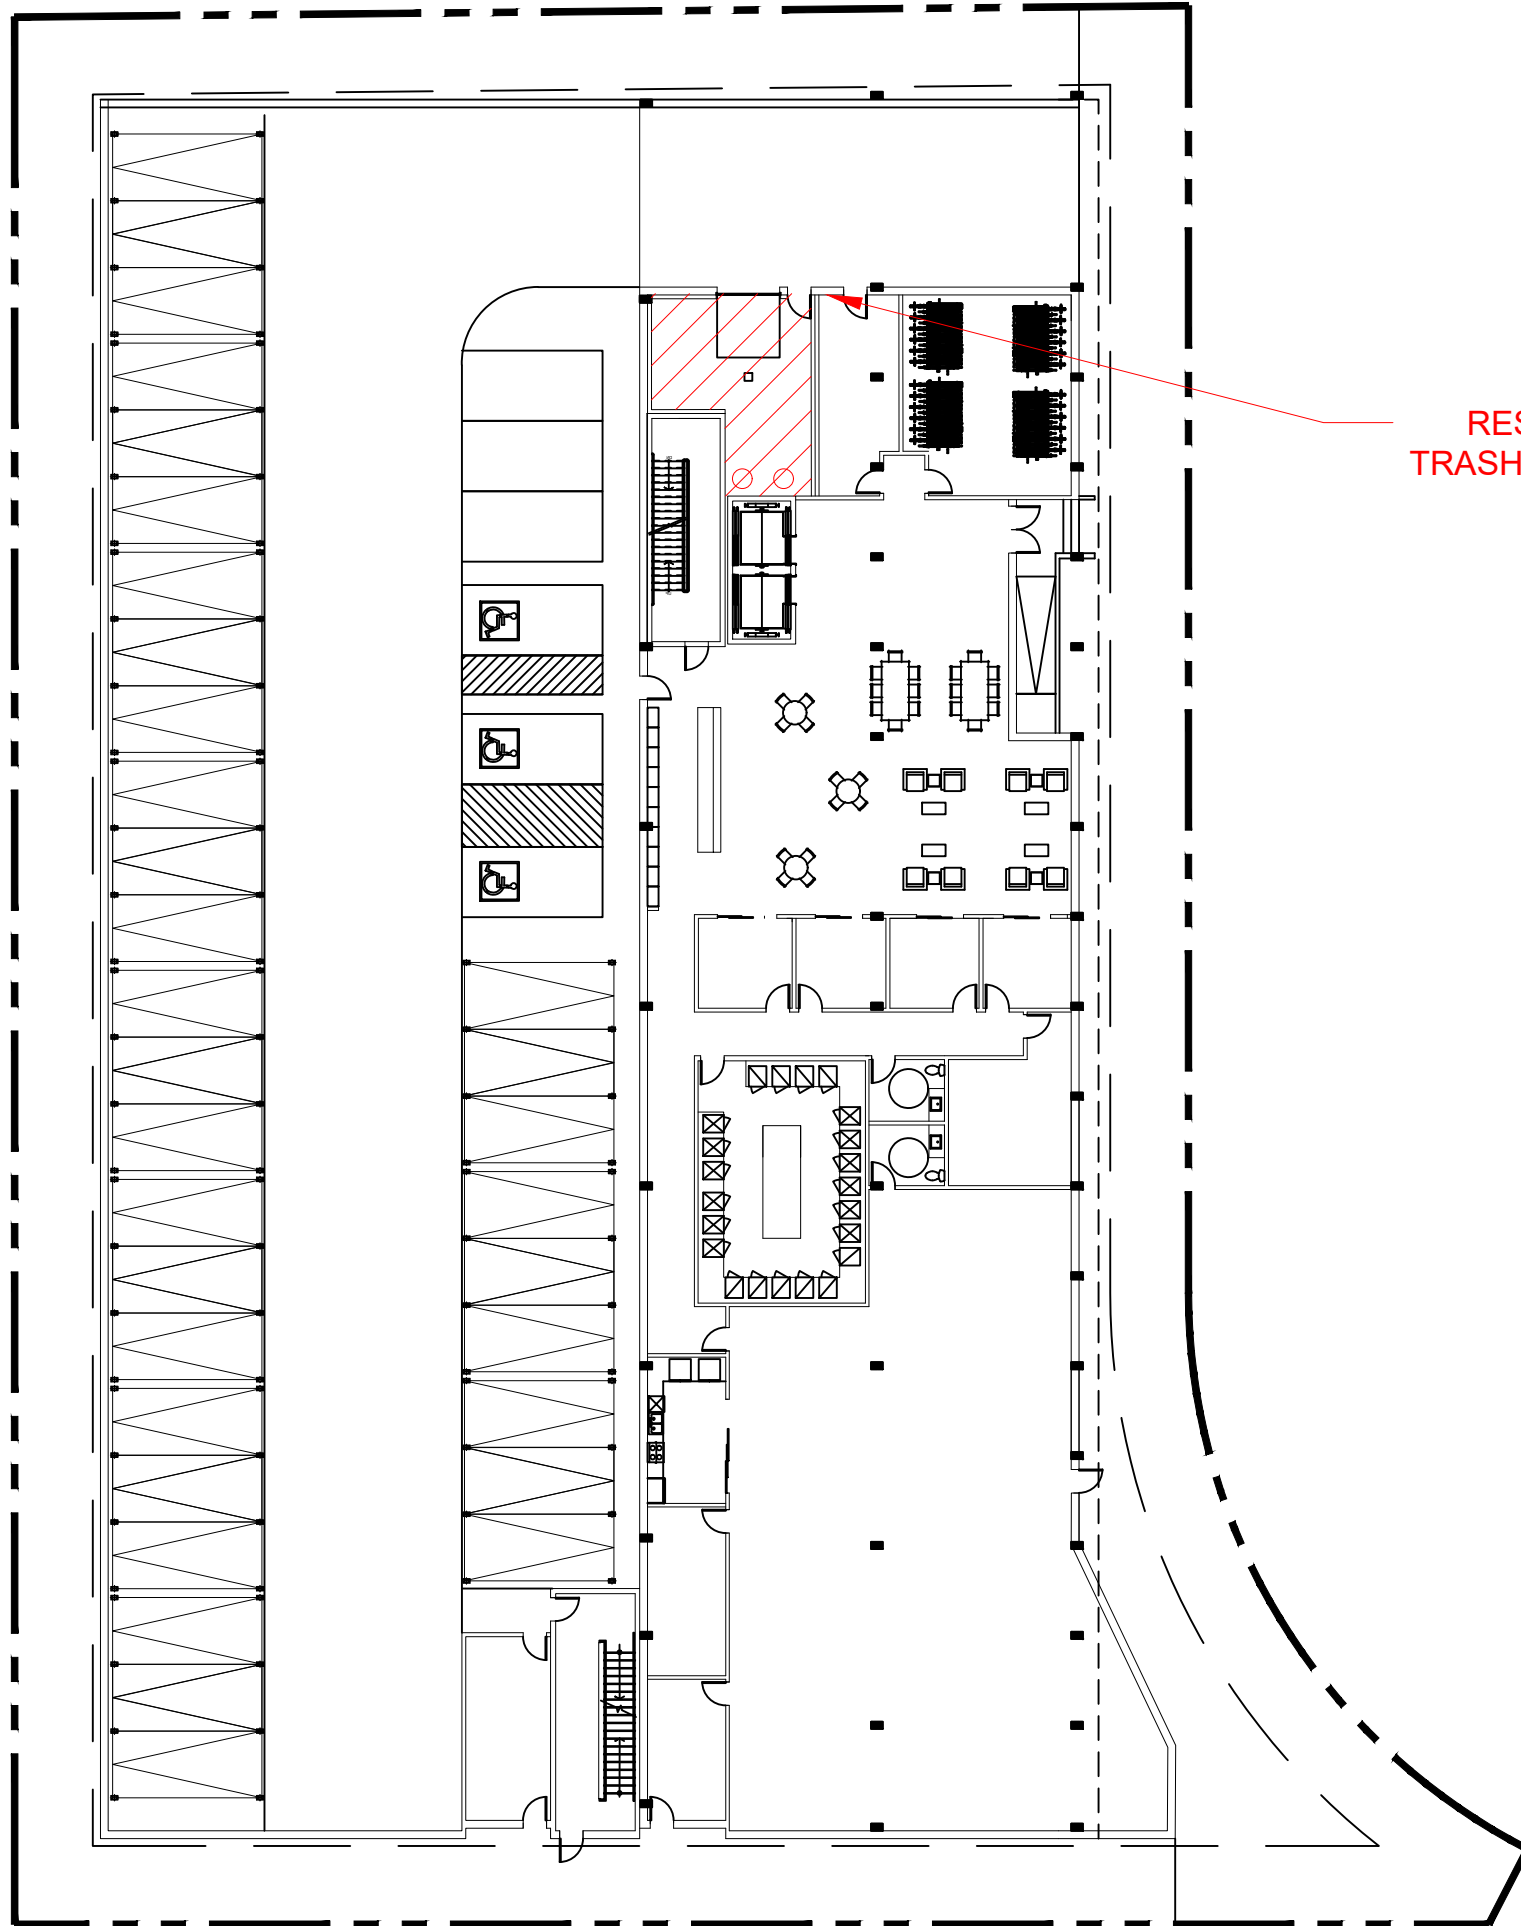

RESIDENTIAL  
TRASH COLLECTION  
ROOM



# AMERICAN TRASH MANAGEMENT

AMERICAN TRASH MANAGEMENT  
1900 POWELL STREET, SUITE 220  
EMERYVILLE, CALIFORNIA 94608  
P: 415.292.5400  
F: 415.292.5410  
SBROWN@TRASHMANAGE.COM

CONSULTANT

KTGY

ARCHITECT

EAH HOUSING

OWNER / DEVELOPER

NO.	DATE	ISSUE / REVISION	ISSUED BY

330 DISTEL CIRCLE  
LOS ALTOS

PROJECT

SITE PLAN

DRAWING TITLE

PROJECT NO.

DRAWN CS

APPROVED SB

DATE 03/02/2022

SCALE AS SHOWN

DRAWING NO.

TR0.0



UPPER FLOOR  
CHUTE VESTIBULE



# AMERICAN TRASH MANAGEMENT

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1900 POWELL STREET, SUITE 220  
EMERYVILLE, CALIFORNIA 94608  
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ARCHITECT

EAH HOUSING

OWNER / DEVELOPER

NO.	DATE	ISSUE / REVISION	ISSUED BY

330 DISTEL CIRCLE  
LOS ALTOS

PROJECT

UPPER FLOOR  
CHUTE VESTIBULE  
(TYP.)


DRAWING TITLE

PROJECT NO.	
DRAWN	CS
APPROVED	SB
DATE	03/02/2022
SCALE	AS SHOWN


DRAWING NO.

TR0.1

PROJECTED COLLECTION SCHEDULE: RESIDENTIAL TRASH ROOM		
SERVICE:	CONTAINER VOL / TYPE:	FREQUENCY:
WASTE	(1) 2CY FL COMPACTOR CONTAINER	2x/wk
RECYCLING	(1) 2CY FL LOOSE CONTAINERS	2x/wk
COMPOST	(4) 64G TOTE CARTS	1x/wk

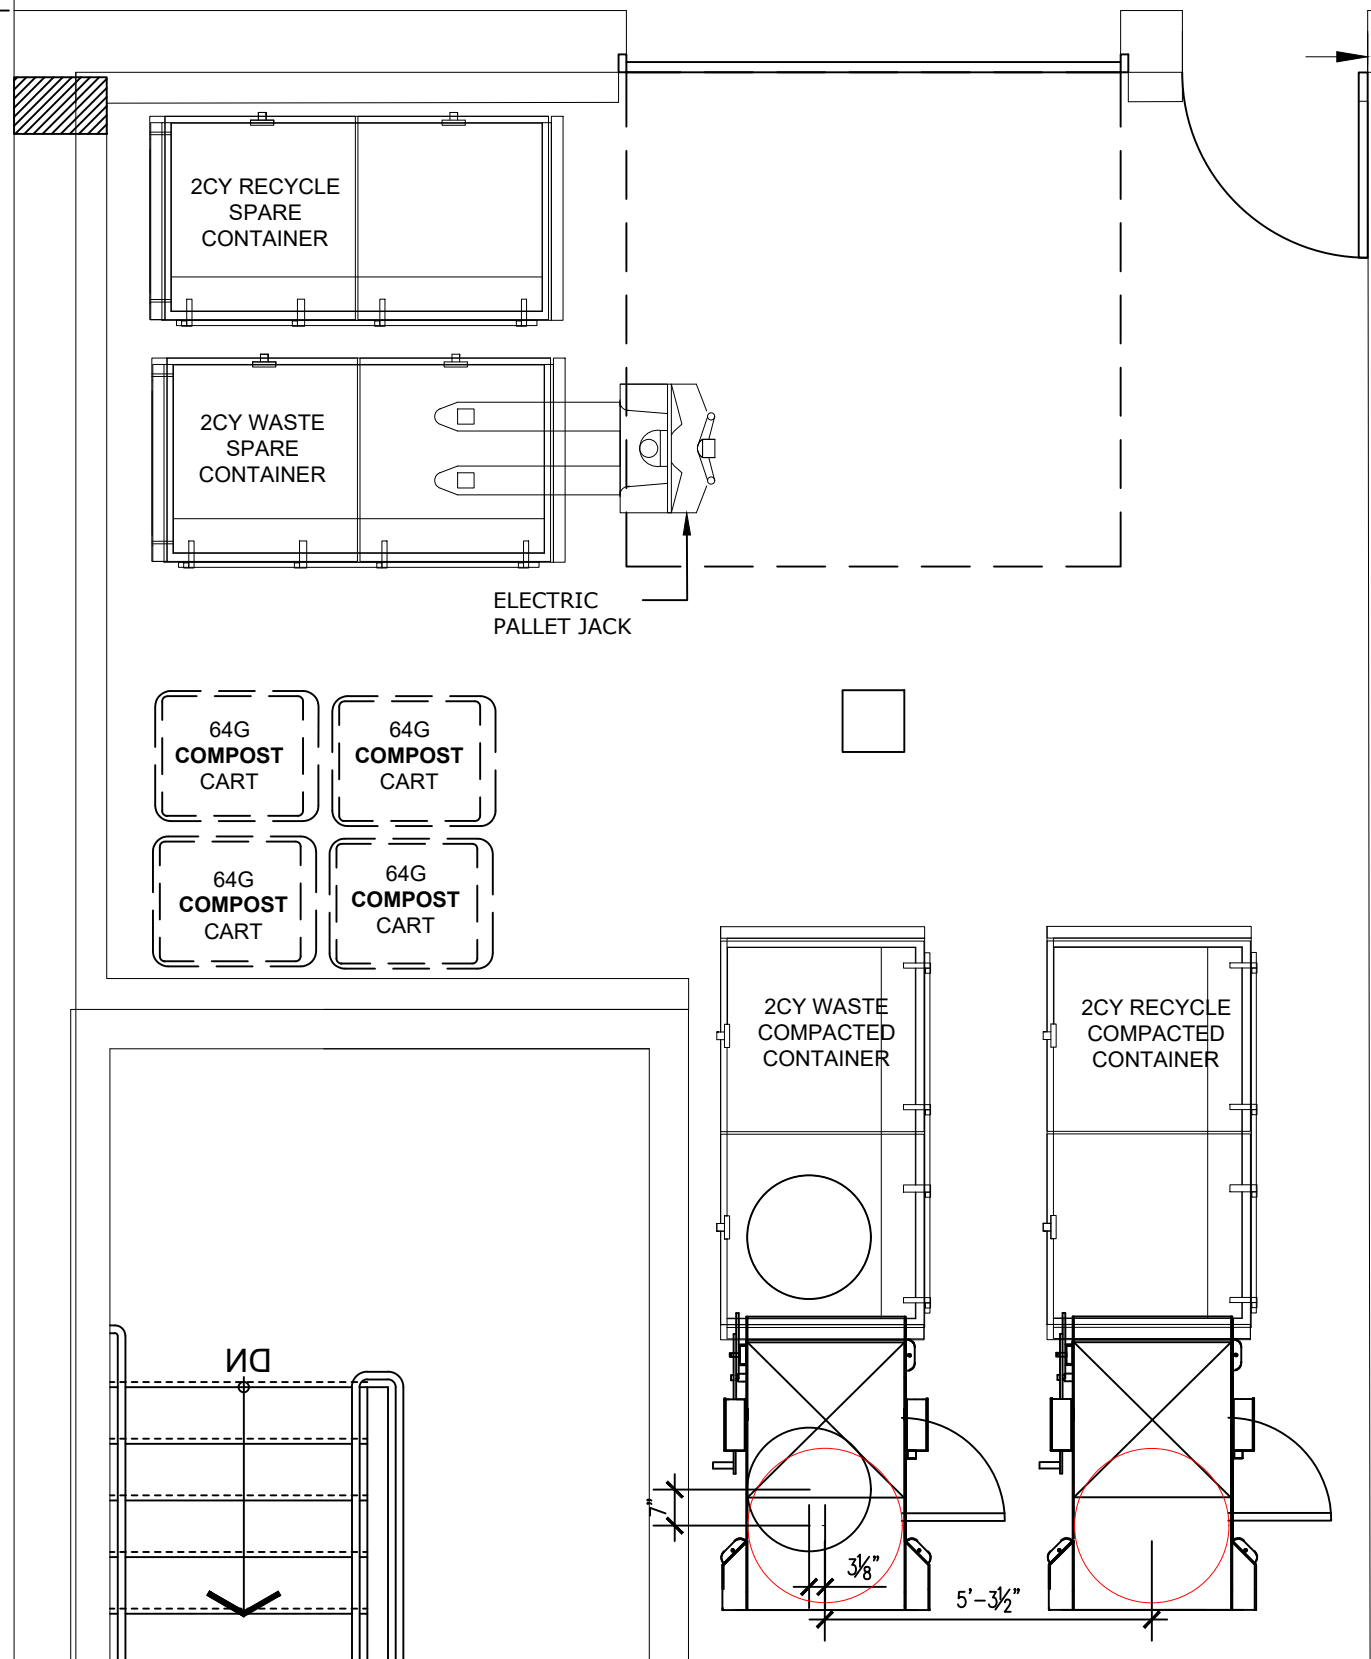

WE RECOMMEND ROTATING THE CHUTES IN ORDER TO ACCOMMODATE TRASH EQUIPMENT BELOW.  
**DESIGN ISSUE**

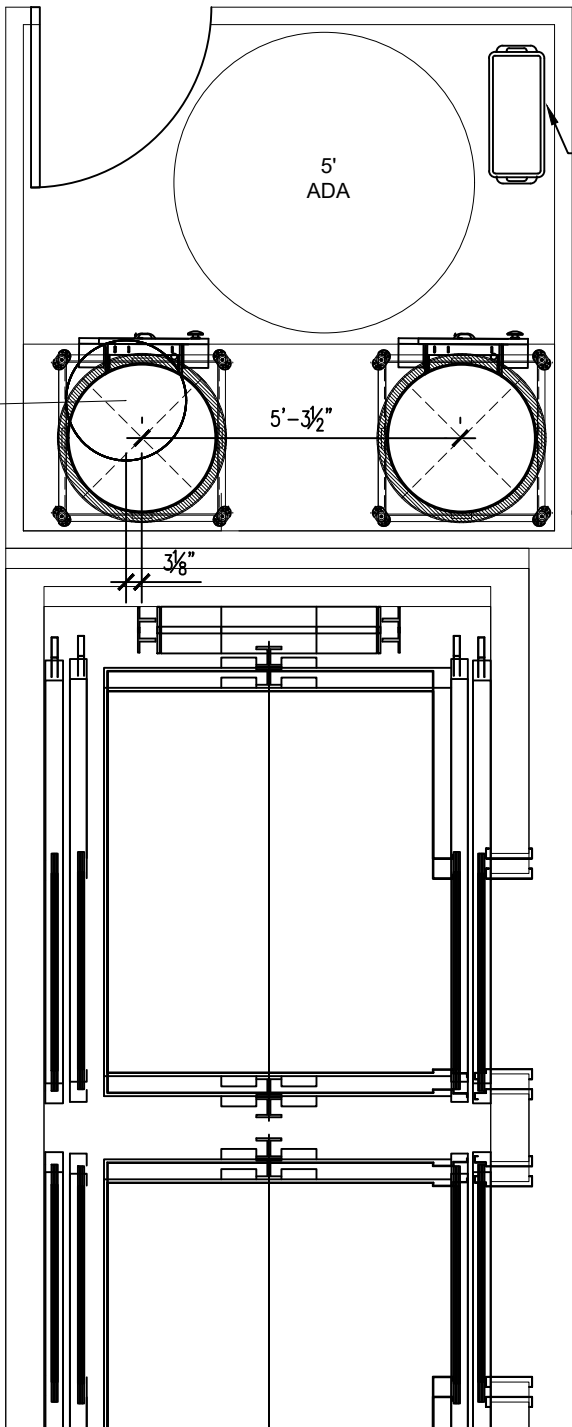

RUBBERMAID SLIM JIM FOR COMPOST. TO BE EMPTIED DAILY INTO TRASH COLLECTION ROOM COMPOST CONTAINER.



AMERICAN TRASH MANAGEMENT  
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SBROWN@TRASHMANAGE.COM

CONSULTANT

KTGY  
ARCHITECT

EAH HOUSING  
OWNER / DEVELOPER

NO.	DATE	ISSUE / REVISION	ISSUED BY

330 DISTEL CIRCLE  
LOS ALTOS  
PROJECT

RESIDENTIAL TRASH ROOM &  
CHUTE VESTIBULE  
(2 CHUTES W/ SLIM JIM)  
DRAWING TITLE

PROJECT NO.	DRAWING NO.
DRAWN CS	TR1.0
APPROVED SB	
DATE 03/02/2022	
SCALE AS SHOWN	