

PROJECT DATA

PROJECT DESCRIPTION: DEMOLISH EXISTING I-STORY HOUSE (± 1,354 SF) ∉ BUILD A NEW 2-STORY HOUSE WITH 2,605 SF OF LIVING AREA \$ 387 SF OF GARAGE

PROJECT ADDRESS: 318 S. CLARK AVE, LOS ALTOS, CA

PROJECT OWNER: SUBO (SUSAN) CHANG

APN: 189-53-071

GENERAL PLAN DESIGNATION: SINGLE FAMILY, SMALL LOT (4 du / NET ACRE)

ZONING: R-I-IO

LOT SIZE: 8,550 SF

TYPE OF CONSTRUCTION: V-B, SPRINKLERED

BUILDING OCCUPANCY: R-3 / U

ALLOWABLE FLOOR AREA: 35%

ZONING COMPLIANCE EXISTING PROPOSED ALLOWED / REQ'D LOT COVERAGE 1,404 SF 2,218 SF 30% MAX. = 2,565 SF (16.4 %) (25.94 %) FLOOR AREA I ST FLR 1,354 ± SF 1,972 SF 2ND FLR 1,020 SF 0 1,354 SF 2,992 SF TOTAL SF 2,992.5 (15.8%) (34.99 %) (35%) 50 SF ± PORCHES 245.9 SF SETBACKS FRONT 25.25' 25'-9" 25'-0" REAR 71.28' 64'-1" 25'-0" RIGHT SIDE (1ST / 2ND) 9.07' 6'-0" / 15'-7" 6'-0" / 13'-6" 8.69' LEFT SIDE (1ST / 2ND) 6'-0" / 16'-5" 6'-0" / 13'-6" HEIGHT 27' |5.|5'± 26'-10"

DRAWING INDEX

EXIST. HOUSE FLOOR PLAN

ELEVATIONS

SHEET A4 SECTIONS AND ROOF PLAN

EXISTING SITUATION

HARDSCAPE DESIGN

LANDSCAPE DESIGN

IRRIGATION PLAN

ARCHITECTURAL

SHEET A2

SHEET A3

SHEET LI

SHEET L2

SHEET L3

SHEET L4

LANDSCAPE DRAWINGS

SHEET A2.1

SQUARE FOOTAGE BREAKDOWN						
	EXISTING		CHANGE	EIN	TOTAL PI	ROPOSED
HABITABLE LIVING AREA	1,174 5	F ±	1,431	SF	2,605	SF
NON-HABITABLE AREA	180 5	F±	207	SF	387	SF

L	OT CALCUL	ATIONS	
NET LOT AREA		8,550 SF	
FRONT YARD HARDSCAPE AREA		545 SF	(6.5 %)
LANDSCAPING BREAKDOWN TOTAL HARDSCAPE AREA		2,975	SF
TOTAL SOFTSCAPE AREA		5,575	SF

VICINITY MAP




TREE PROTECTION FENCING NOTES:

TREE PROTECTION FENCING SHALL BE A MIN. OF 5' HIGH CHAIN LINK MOUNTED ON 2"Ø GALVINIZED STEEL POSTS DRIVEN 2' MIN. INTO THE GROUND AT A 10' MAX. SPACING TREE PROTECTION FENCING TO REMAIN IN PLACE THROUGHT CONSTRUCTION AND SHALL NOT BE REMOVED UNTIL APPROVED BY ARBORIST OR RECORD.

Tree Protection Plan (318 S Clark Ave)

Tree number	Tree Name	DBH	Ht/Sp	Retain/move
1 *	Coast live Oak	46″	40/50'	Retain
2	Birch	28″	26/18	Retain

*Neighbor's tree, please see Arborist report regarding this tree

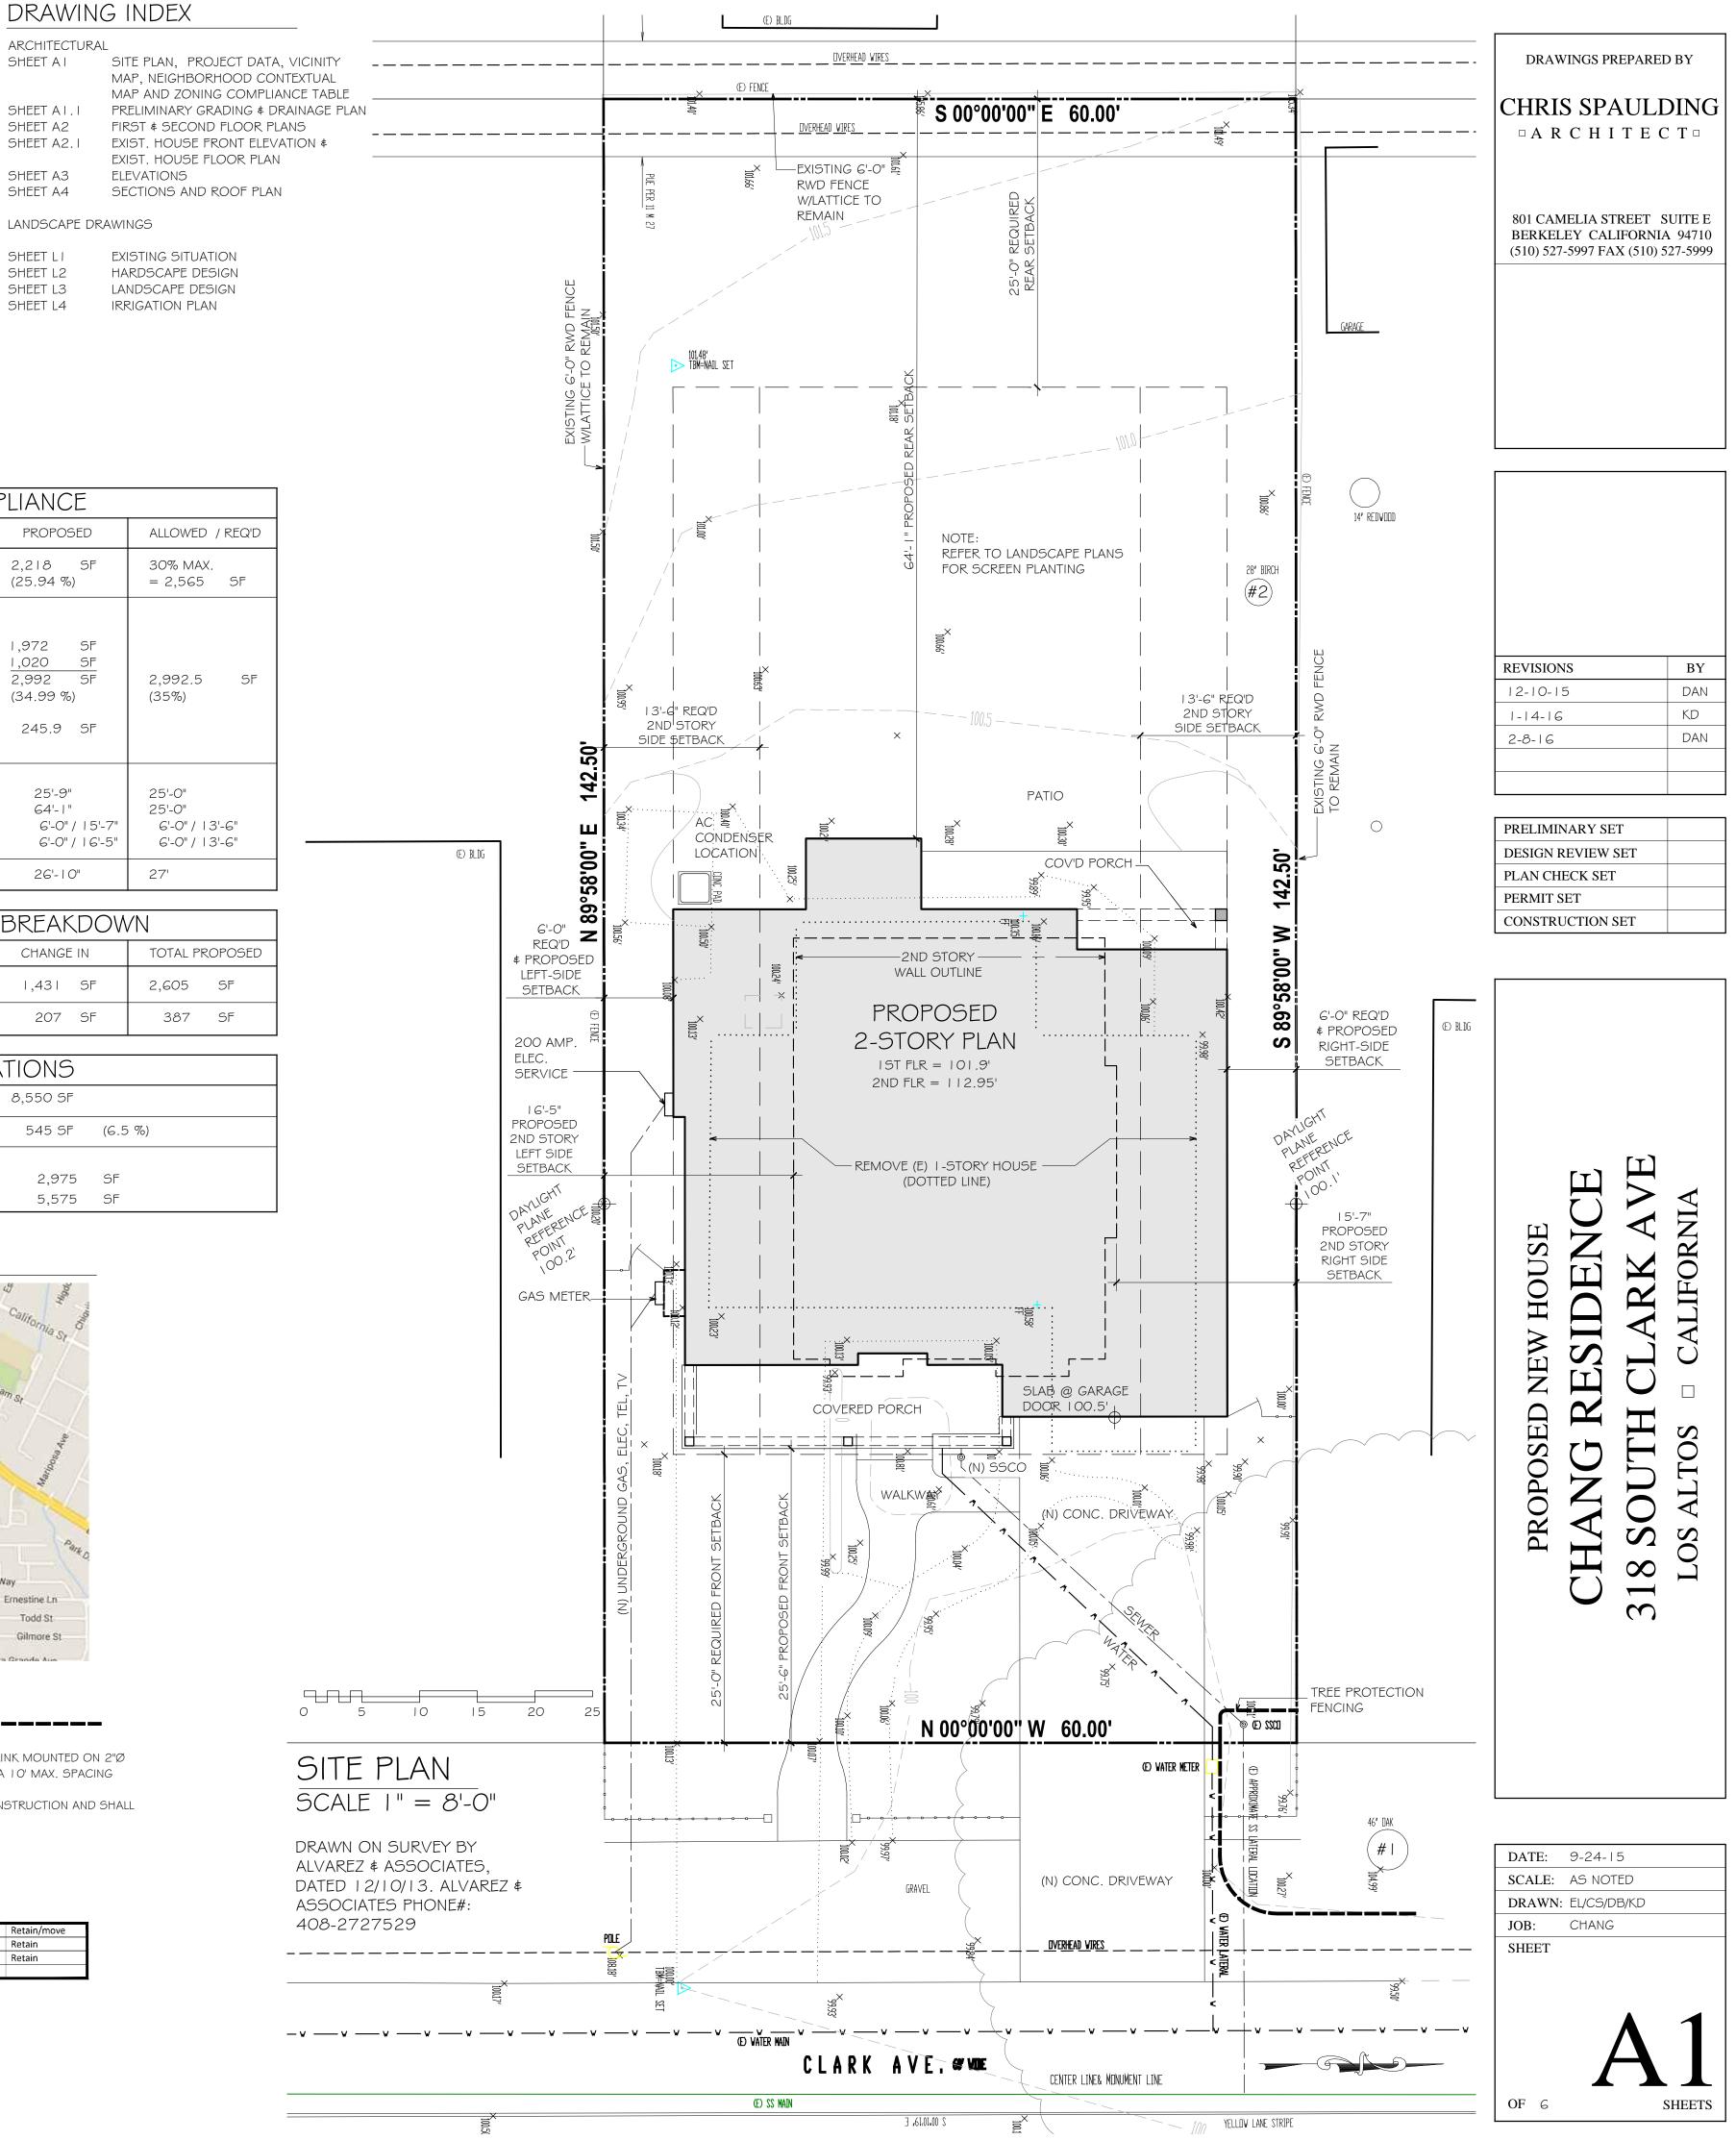

GRADING & DRAINAGE NOTES

NO GRADING REQUIRED EXCEPT FOR FOUNDATION & CRAWLSPACE EXCAVATIONS, & THE SHAPING OF FINAL GRADES FOR PROPER DRAINAGE

DOWNSPOUTS TO DISCHARGE ACROSS SPLASHBLOCKS & INTO LANDSCAPED AREAS AWAY FROM STRUCTURES

SHAPE I % BIO SWALES ACROSS REAR ∉ SIDES OF BUILDING

DRIVEWAY TO DRAIN IN SHEET-FLOW TO LANDSCAPED AREAS

SHAPE FINAL GRADES TO SLOPE 5% AWAY FROM BUILDING (PAVEMENTS TO SLOPE 2%) FOR A MINIMUM OF 10', OR INTO BIOSWALE

WATER SHALL NOT BE ALLOWED TO POND ADJACENT TO FOUNDATIONS

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TREE PROTECTION FENCING TO REMAIN IN PLACE THROUGHT CONSTRUCTION AND SHALL NOT BE REMOVED UNTIL APPROVED BY ARBORIST OR RECORD.

EACH TREE FENCE SHALL HAVE A PROMINENTLY DISPLACED 8½" X11" SIGN STATING: "WARNING - TREE PROTECTION ZONE - THIS FENCE SHALL NOT BE REMOVED AND IS SUBJECT TO PENALTY ACCORDING TO TOWN CODE 29.10.1025"

Tree Protection Plan (318 S Clark Ave)


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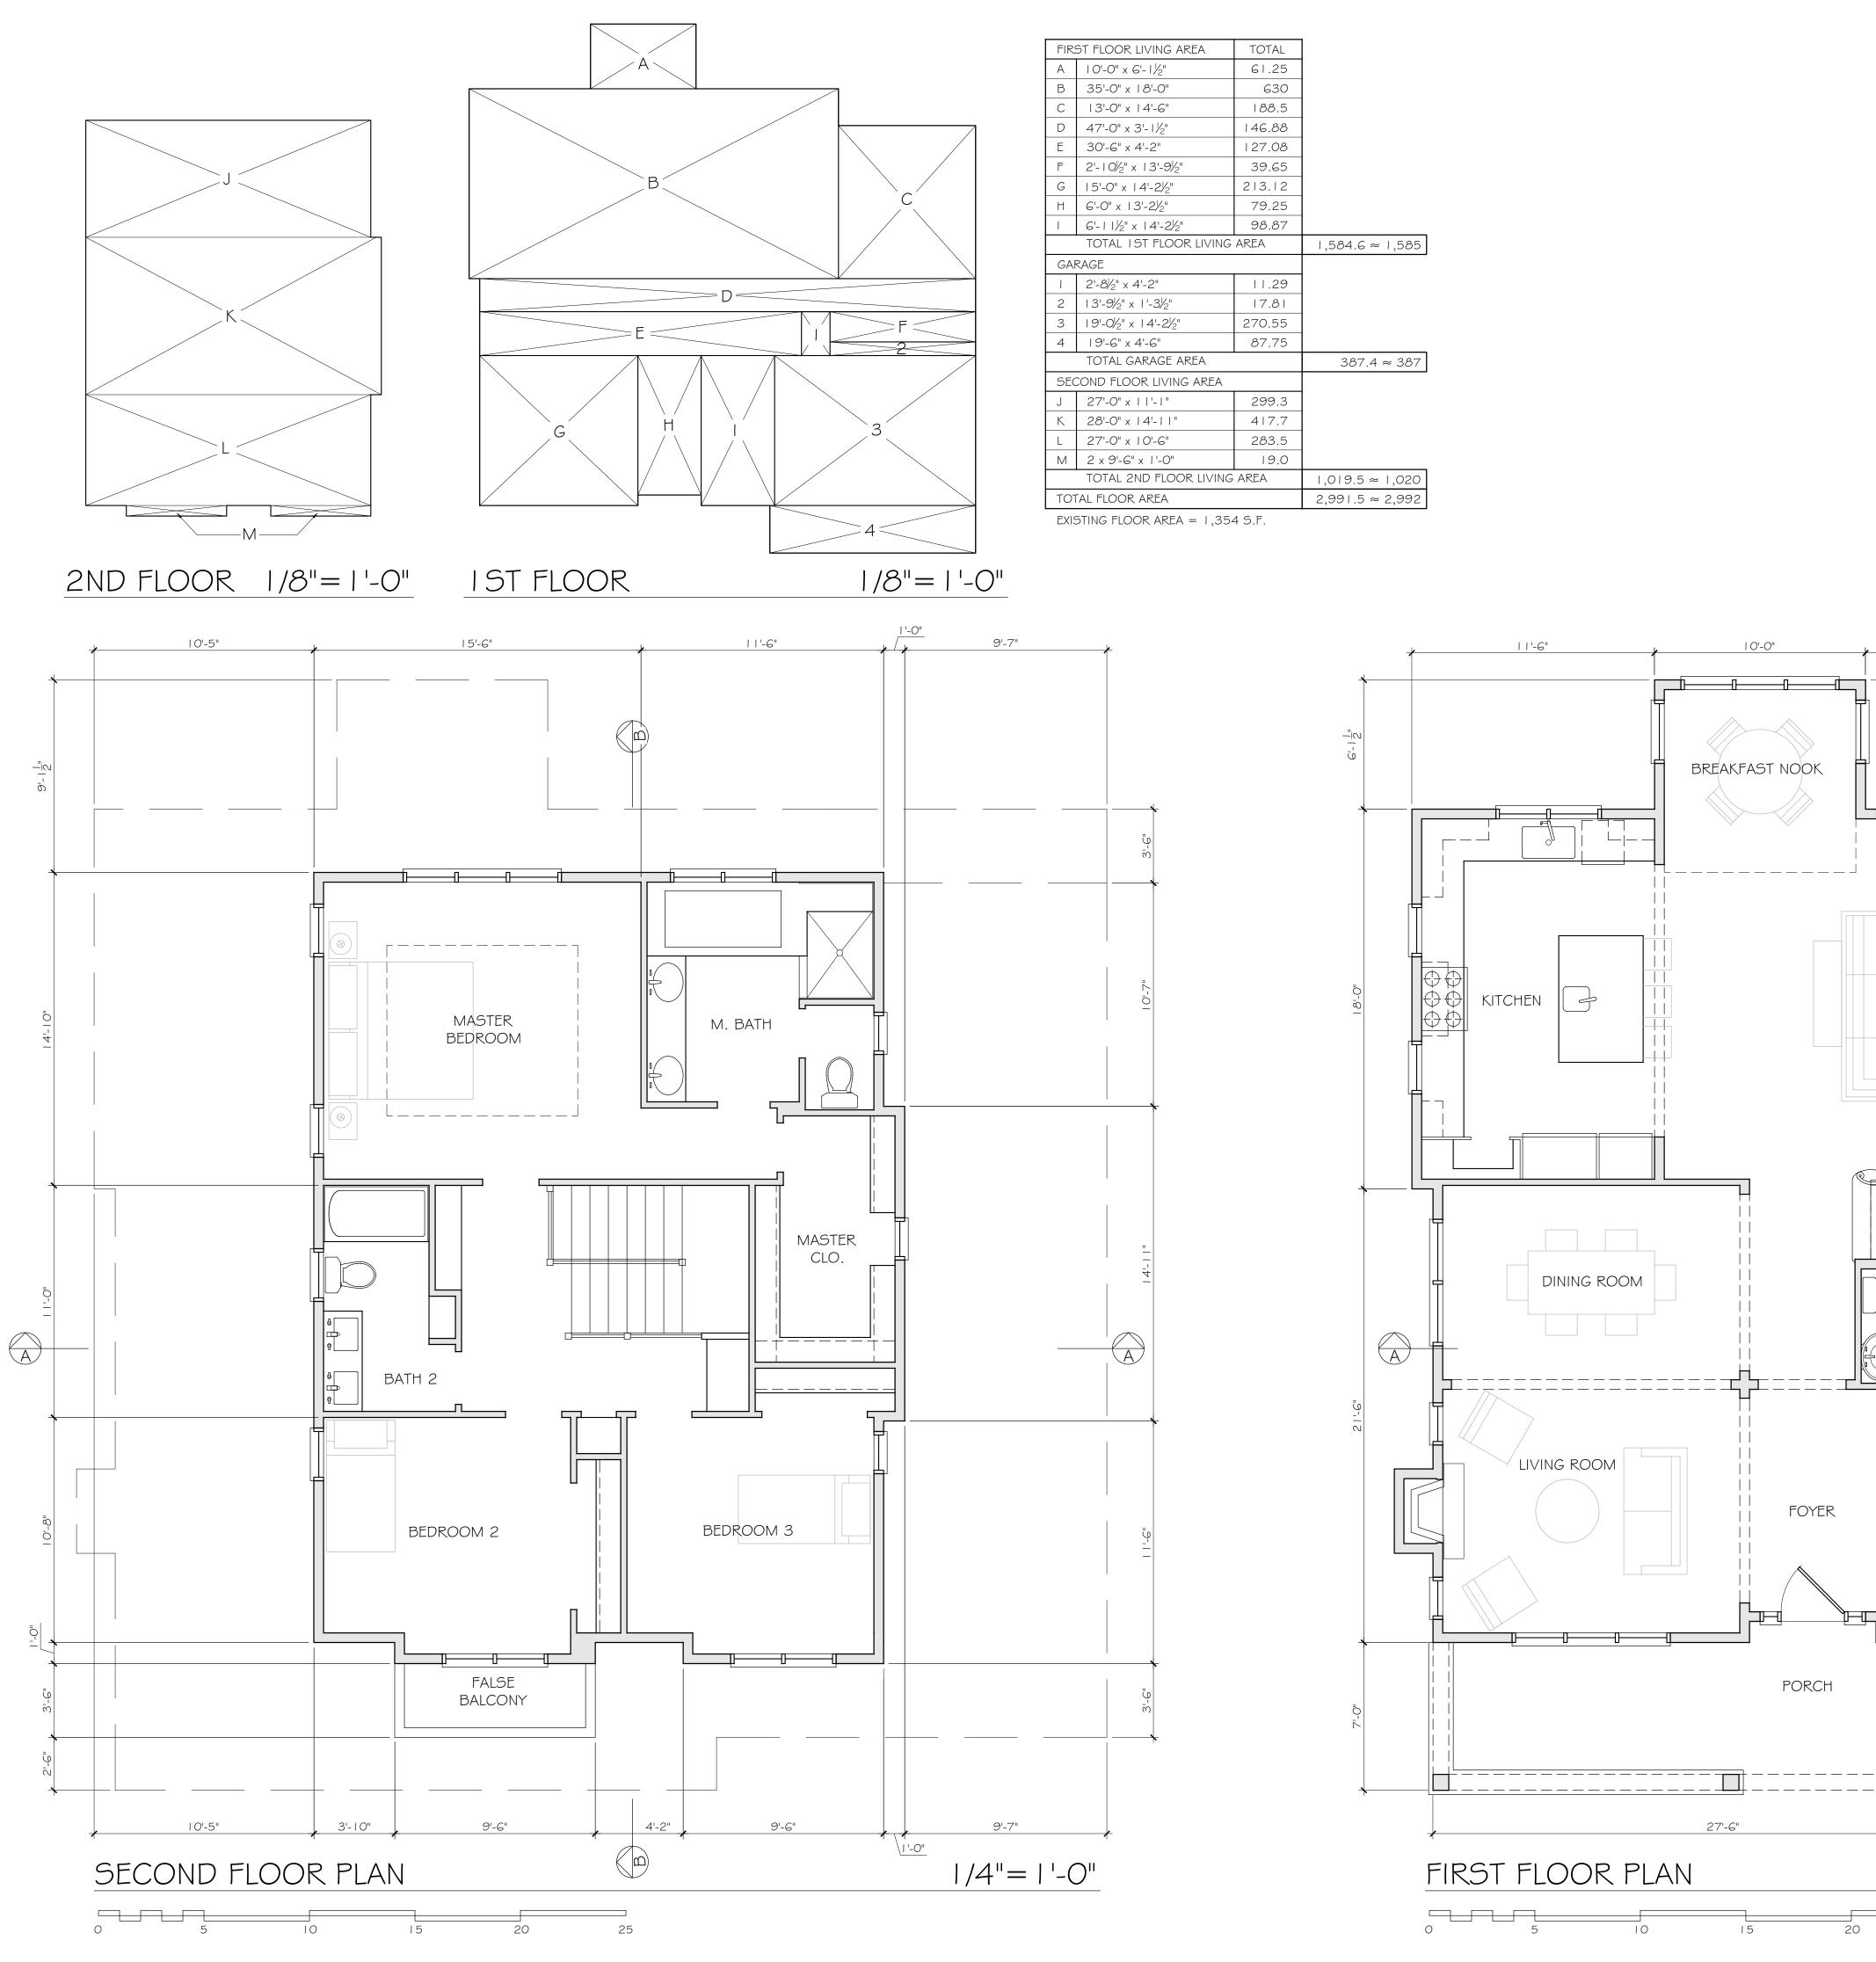
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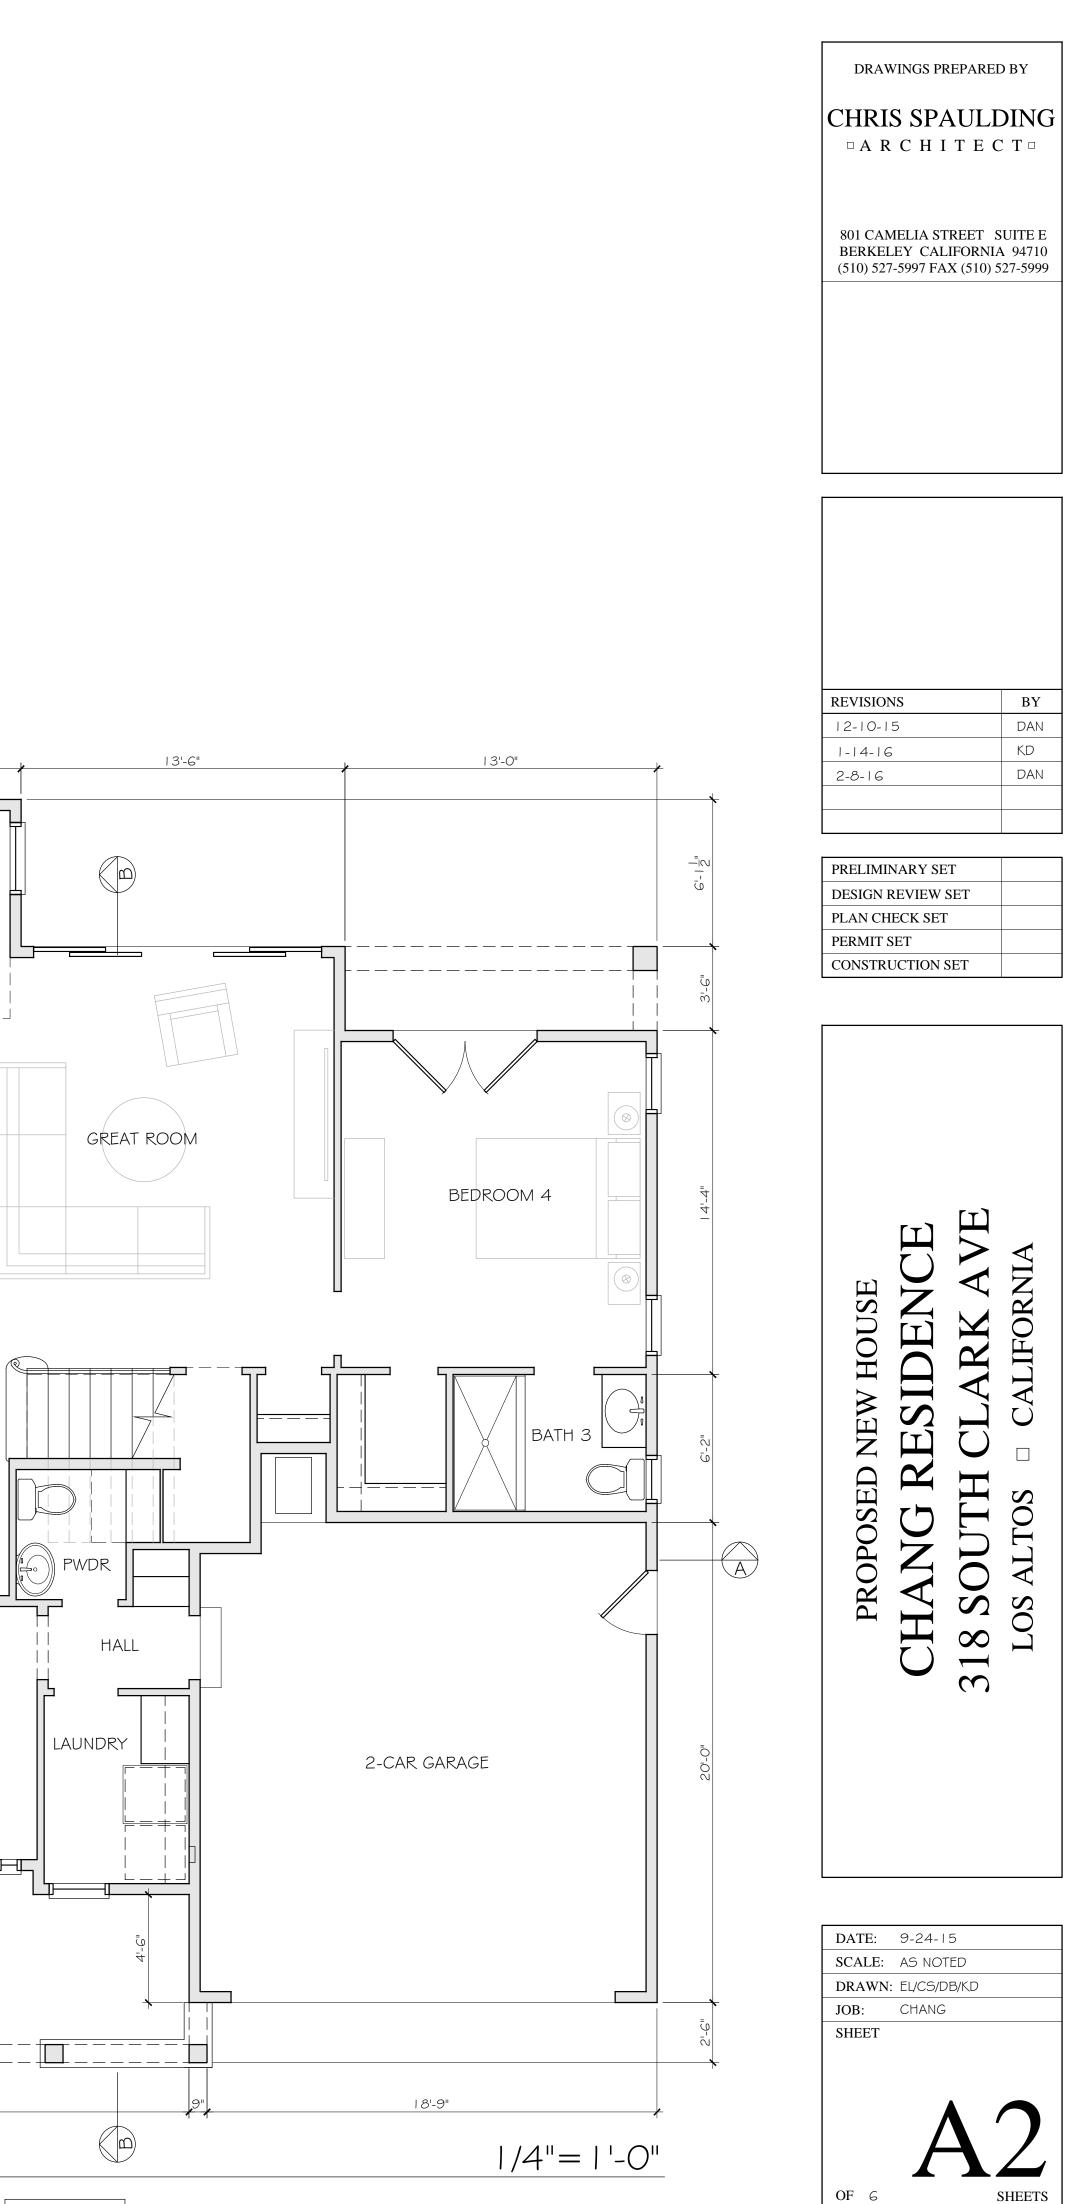
10 15 20 25


DRAWN ON SURVEY BY ALVAREZ & ASSOCIATES, DATED 12/10/13. ALVAREZ & ASSOCIATES PHONE#: 408-2727529






			_	
FIR	ST FLOOR LIVING AREA	TOTAL		
А	10'-0" x 6'-1/2"	61.25		
В	35'-0" x 1 <i>8</i> '-0"	630		
С	3'-0" x 4'-6"	188.5		
D	47'-0" x 3'- 1½"	146.88		
E	30'-6" x 4'-2"	127.08		
F	2'-10 ¹ / ₂ " x 13'-9 ¹ / ₂ "	39.65		
G	5'-0" x 4'-2 ¹ / ₂ "	213.12		
Н	6'-0" x 3'-2 ¹ / ₂ "	79.25		
I	6'-11½" x 14'-2½"	98.87		
	TOTAL IST FLOOR LIVING	AREA	,584.6 ≈ ,585	
GAI	RAGE			
1	2'-8 ¹ / ₂ " x 4'-2"	11.29]	
2	3'-9 / ₂ " x '-3 / ₂ "	17.81		
3	9'-0½" x 4'-2½"	270.55		
4	19'-6" x 4'-6"	87.75		
	TOTAL GARAGE AREA		387.4 ≈ 387	
SEC	COND FLOOR LIVING AREA			
J	27'-0" x '- "	299.3		
К	28'-0" x 4'- "	417.7		
L	27'-0" x 10'-6"	283.5]	
Μ	2 x 9'-6" x 1'-0"	19.0	1	
	TOTAL 2ND FLOOR LIVING	AREA	1,019.5 ≈ 1,020	
TOT	TAL FLOOR AREA		2,991.5 ≈ 2,992	
EXISTING FLOOR AREA = $1,354$ S.F.				

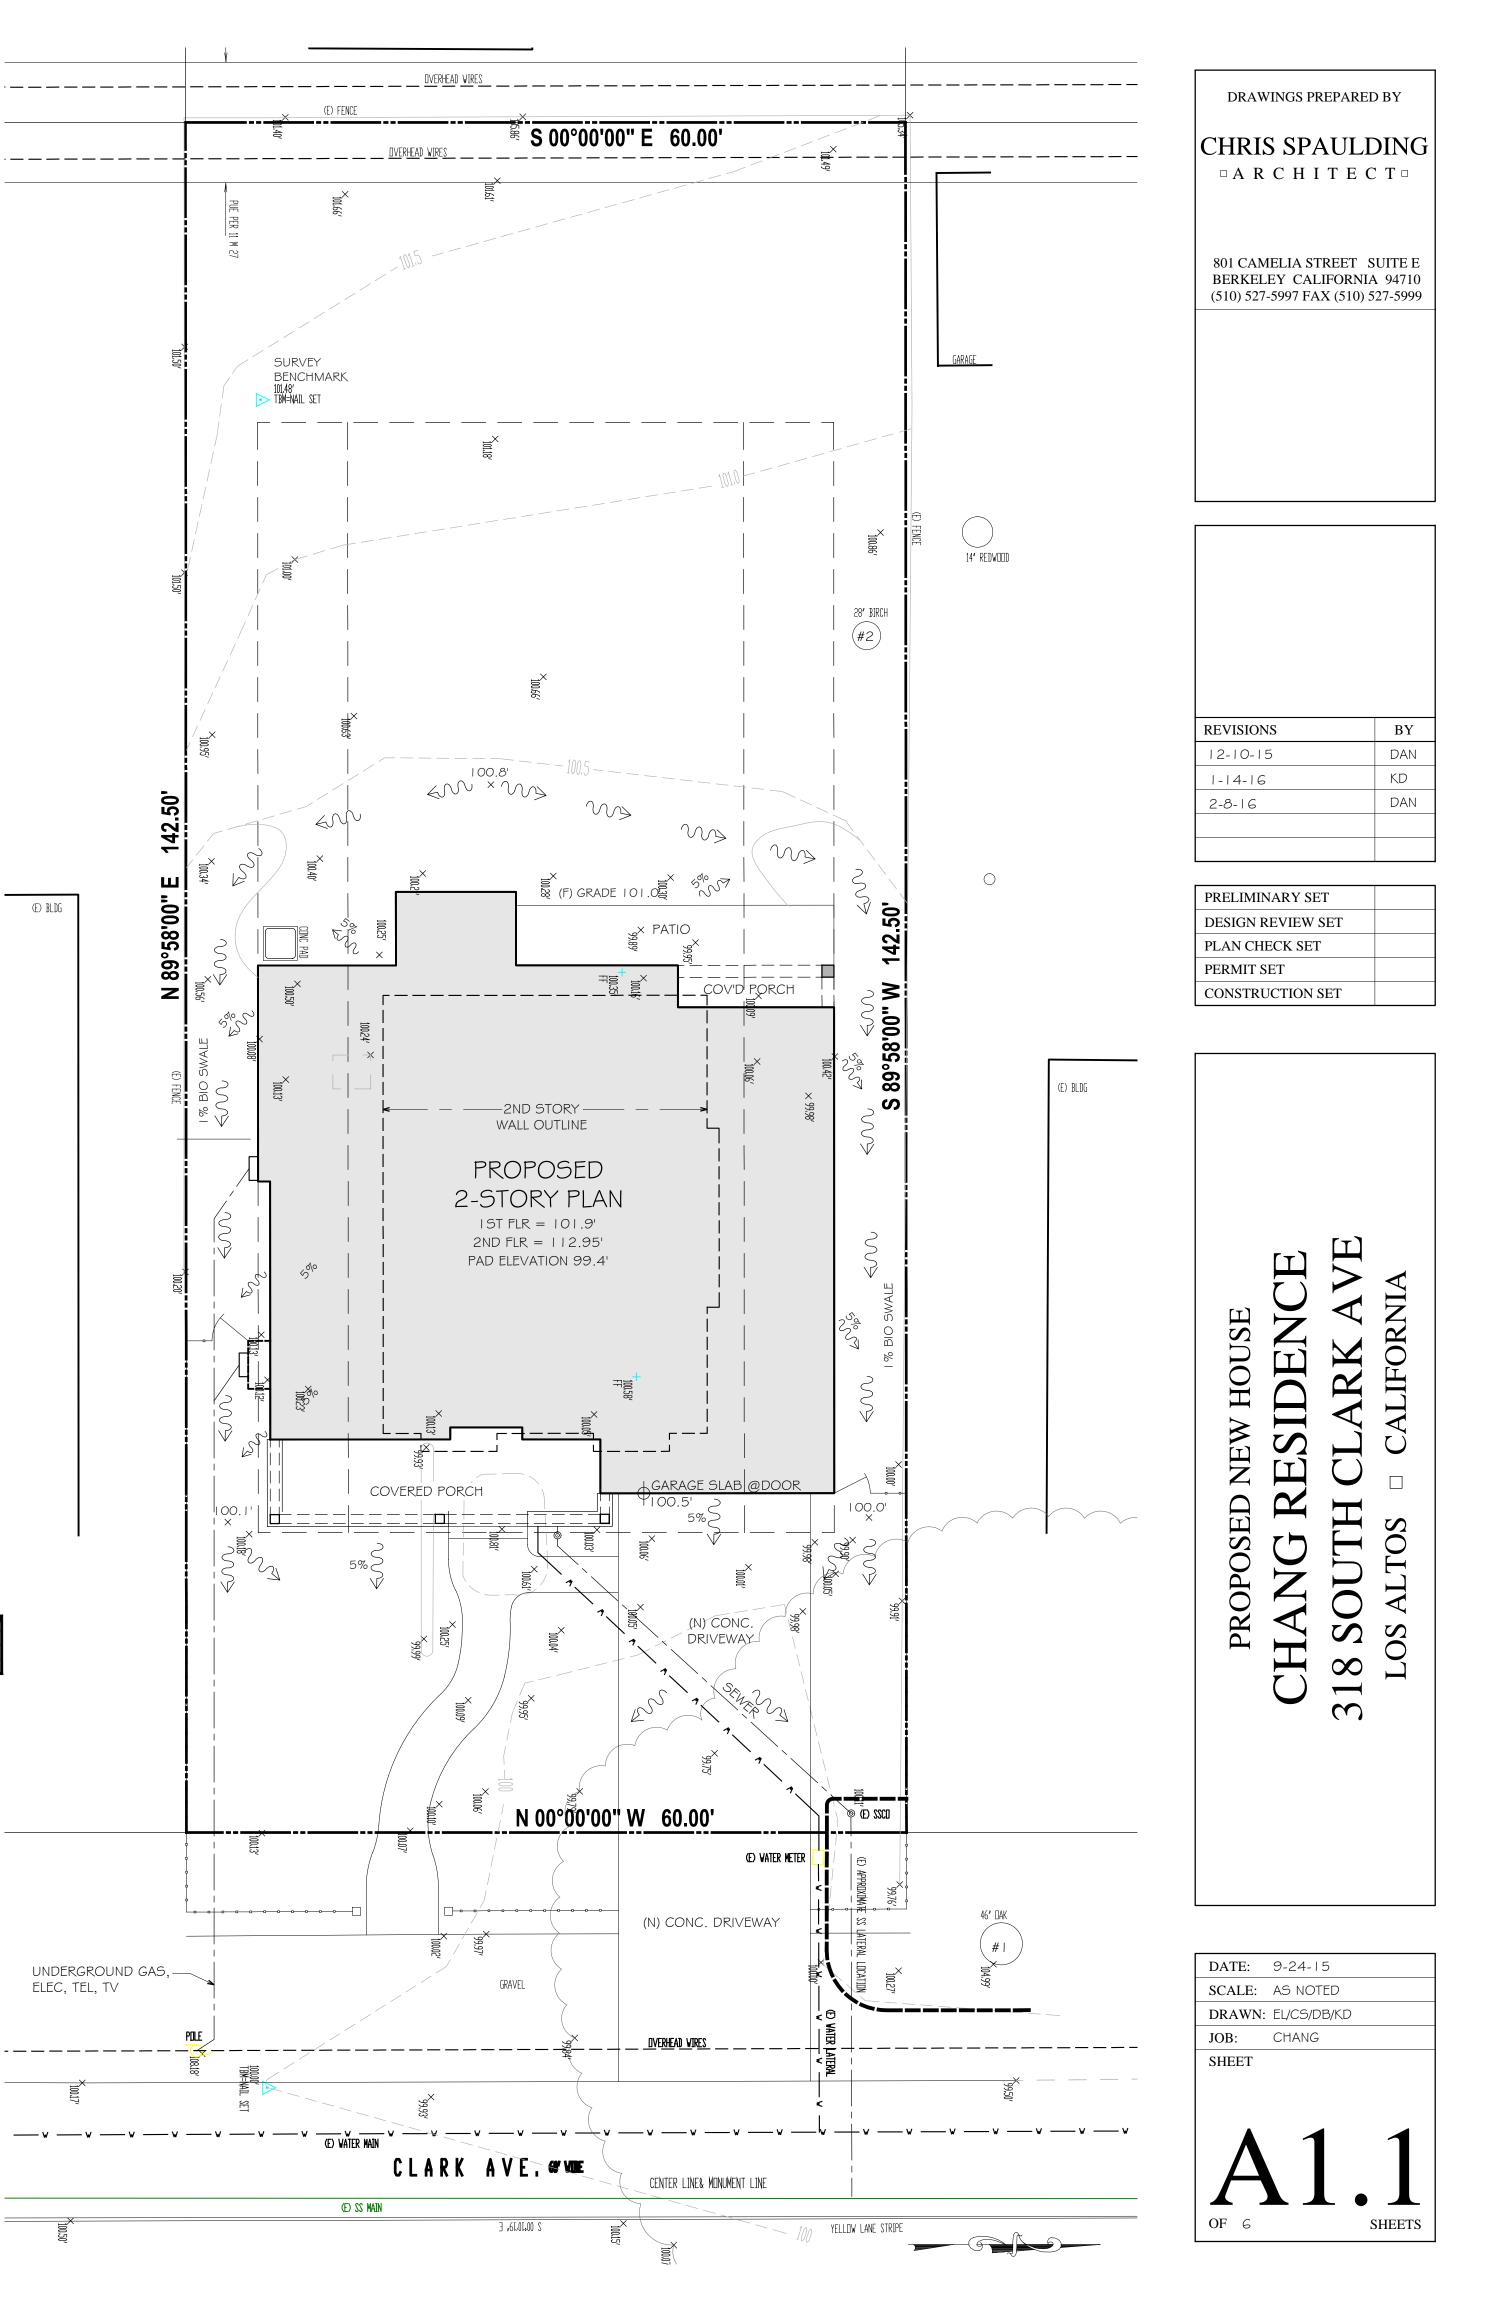

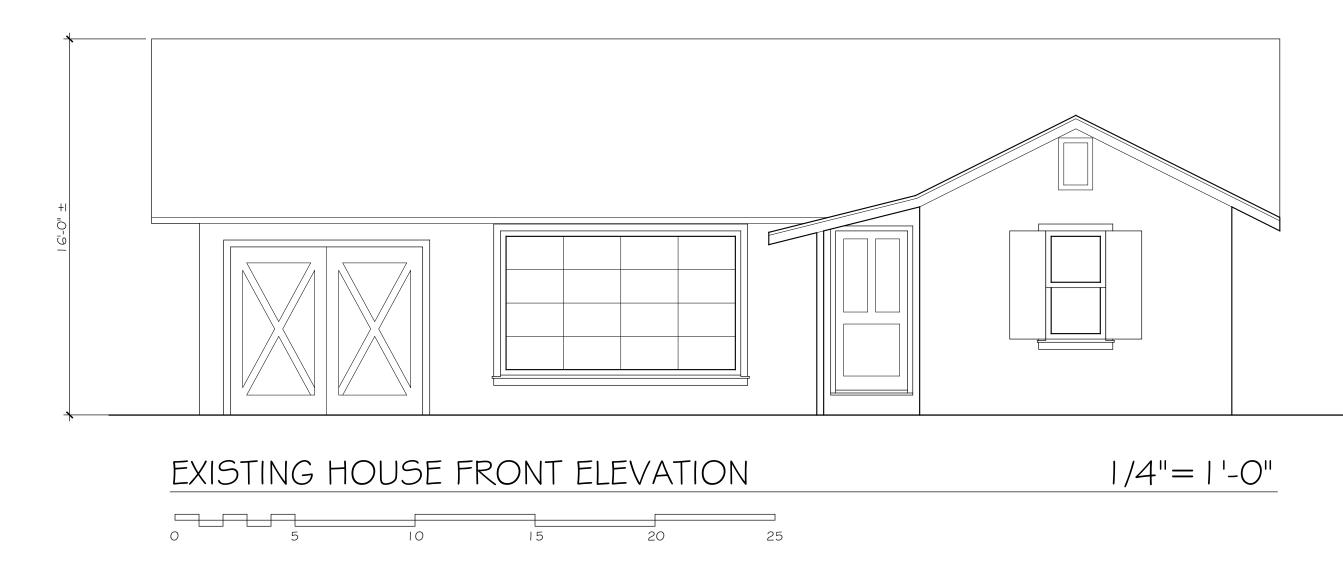

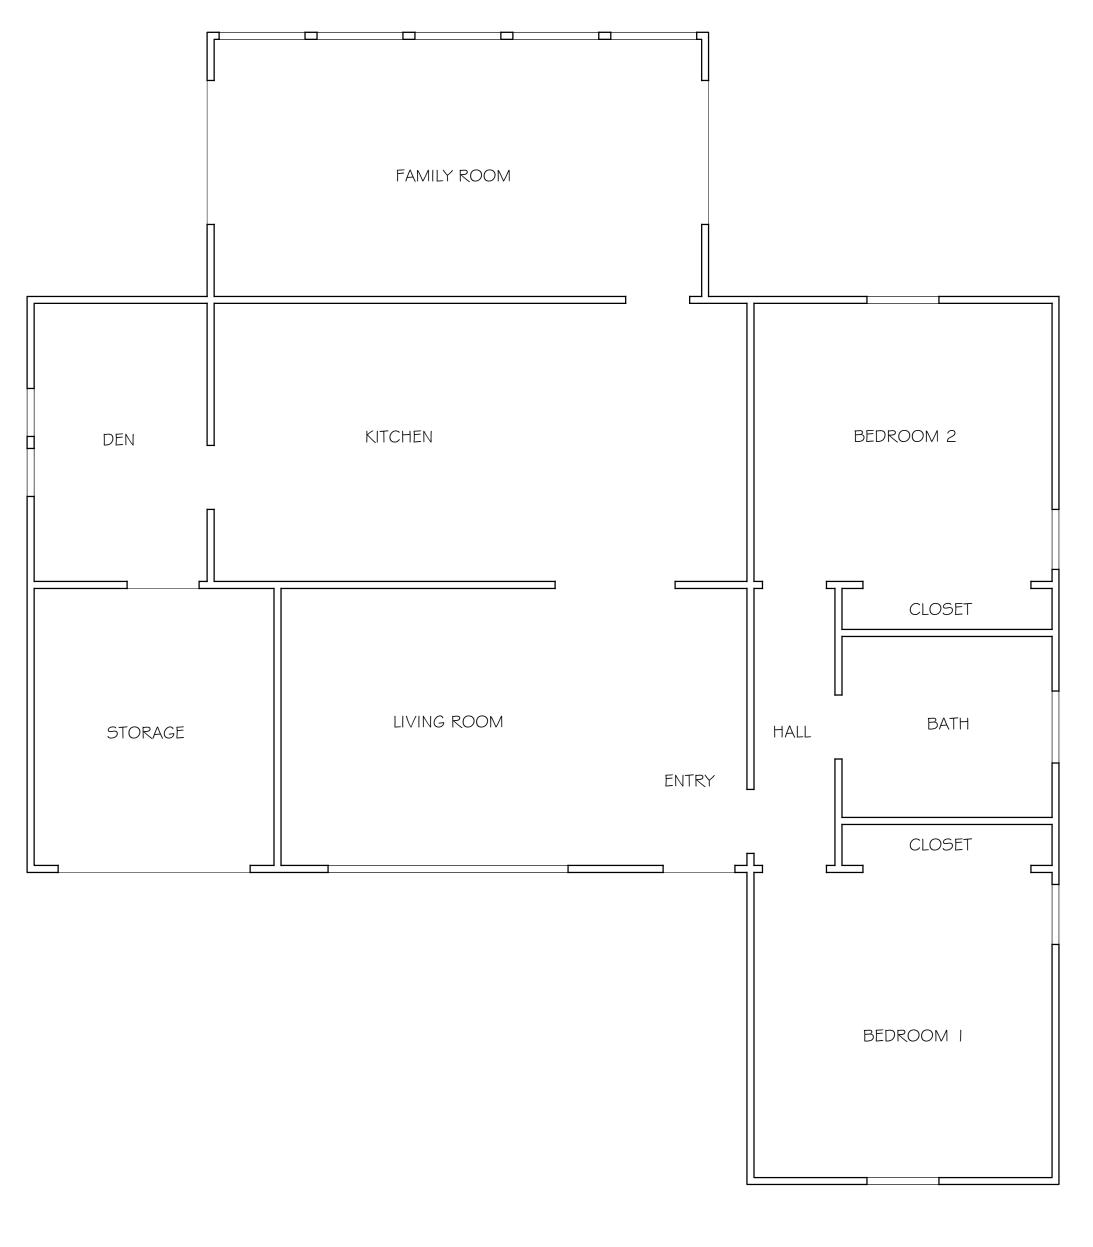

EXISTING HOUSE FLOOR PLAN

0	5	10	I 5	20
NOTE:	EXISTING	HOUSE PL	AN PRO	VIDED
TOTAL	AREA =	1,354 SQ.	FT. (FR	OM SU

|/4"=|'-0"



PRELIMINARY SET	
DESIGN REVIEW SET	
PLAN CHECK SET	
PERMIT SET	
CONSTRUCTION SET	


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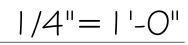
DATE:	9-24-15
SCALE:	AS NOTED
DRAWN:	EL/CS/DB/KD
JOB:	CHANG
SHEET	
A	2.2

LEFT-SIDE ELEVATION




RIGHT-SIDE ELEVATION



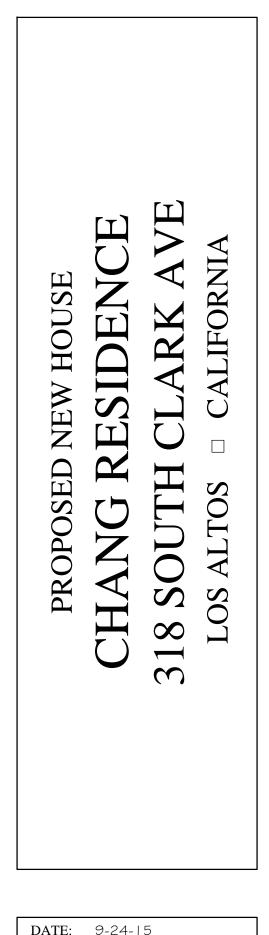



REAR ELEVATION

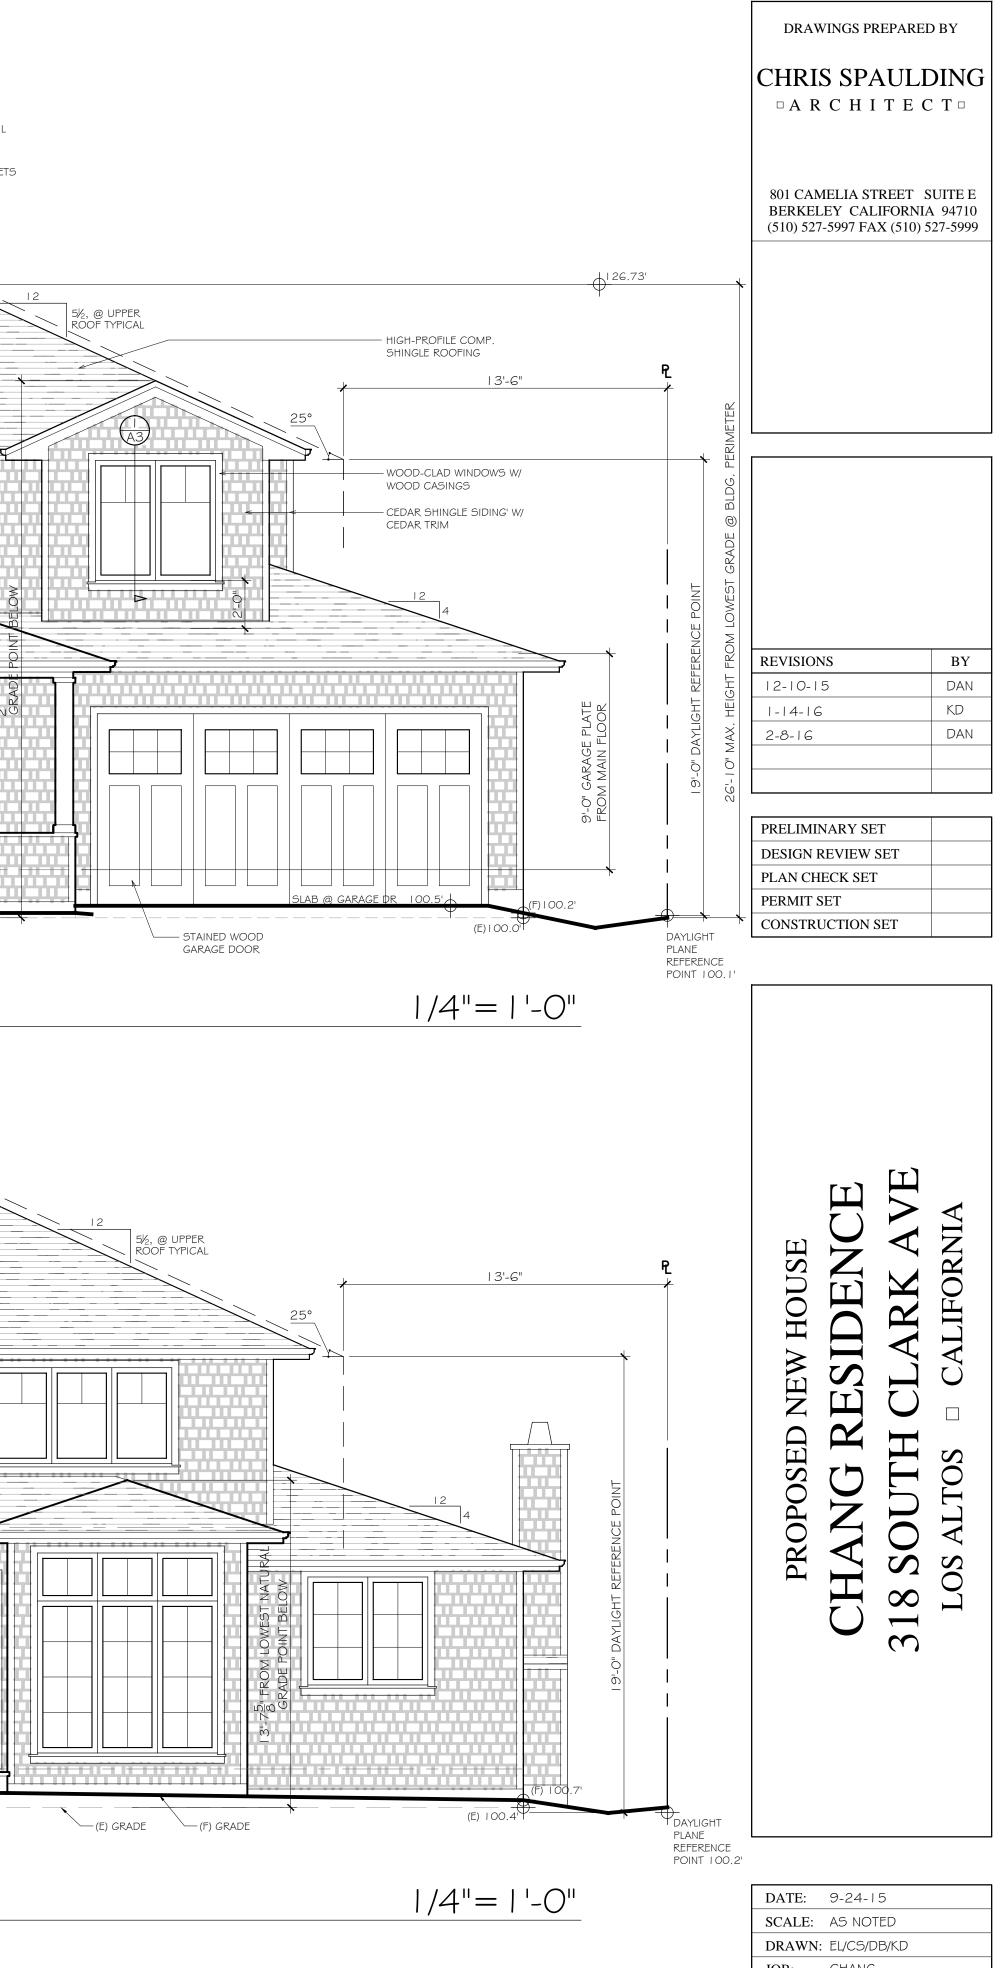


SCALE:	AS NOTED
DRAWN:	EL/CS/DB/KD
JOB:	CHANG
SHEET	
OF G	SHEETS




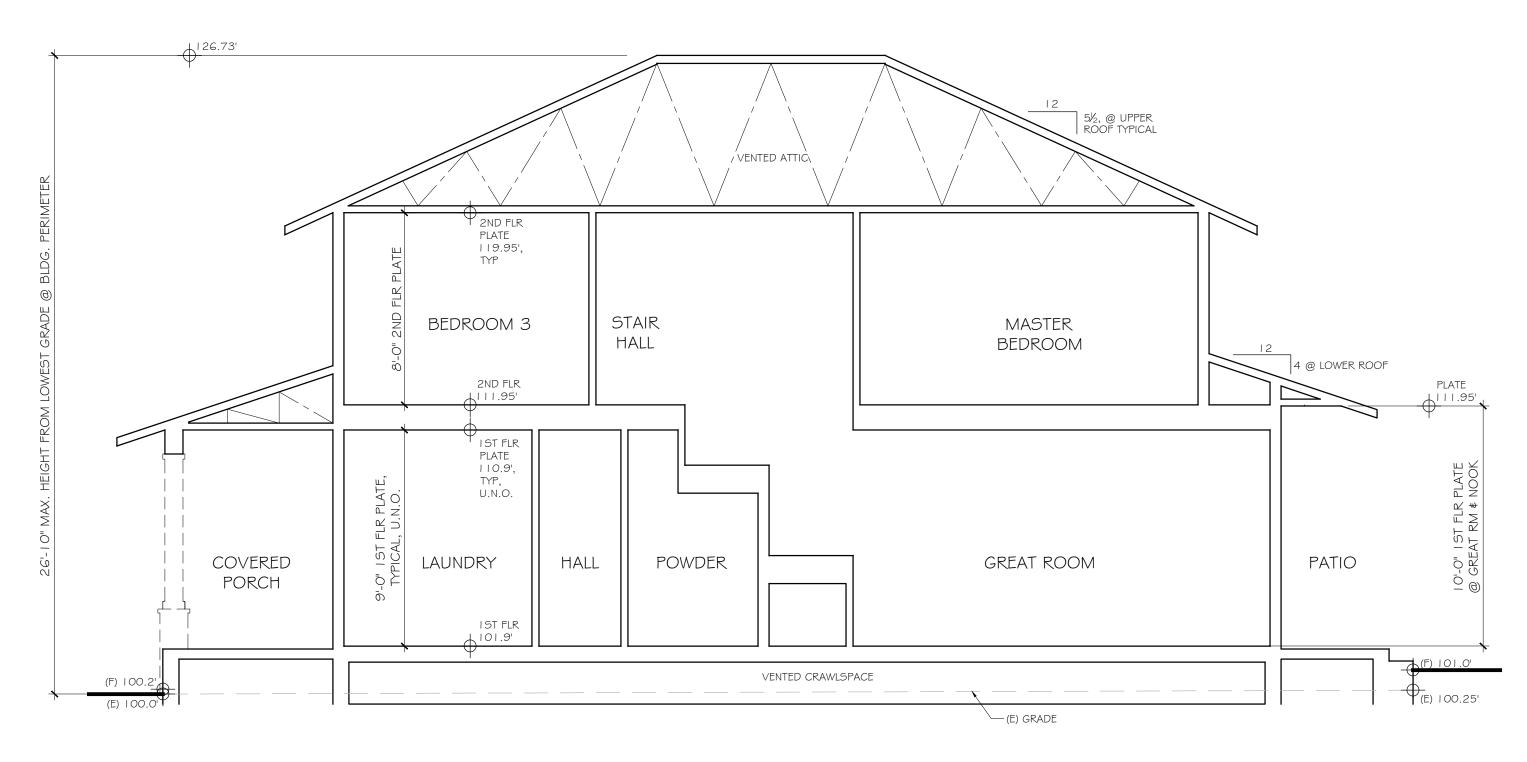

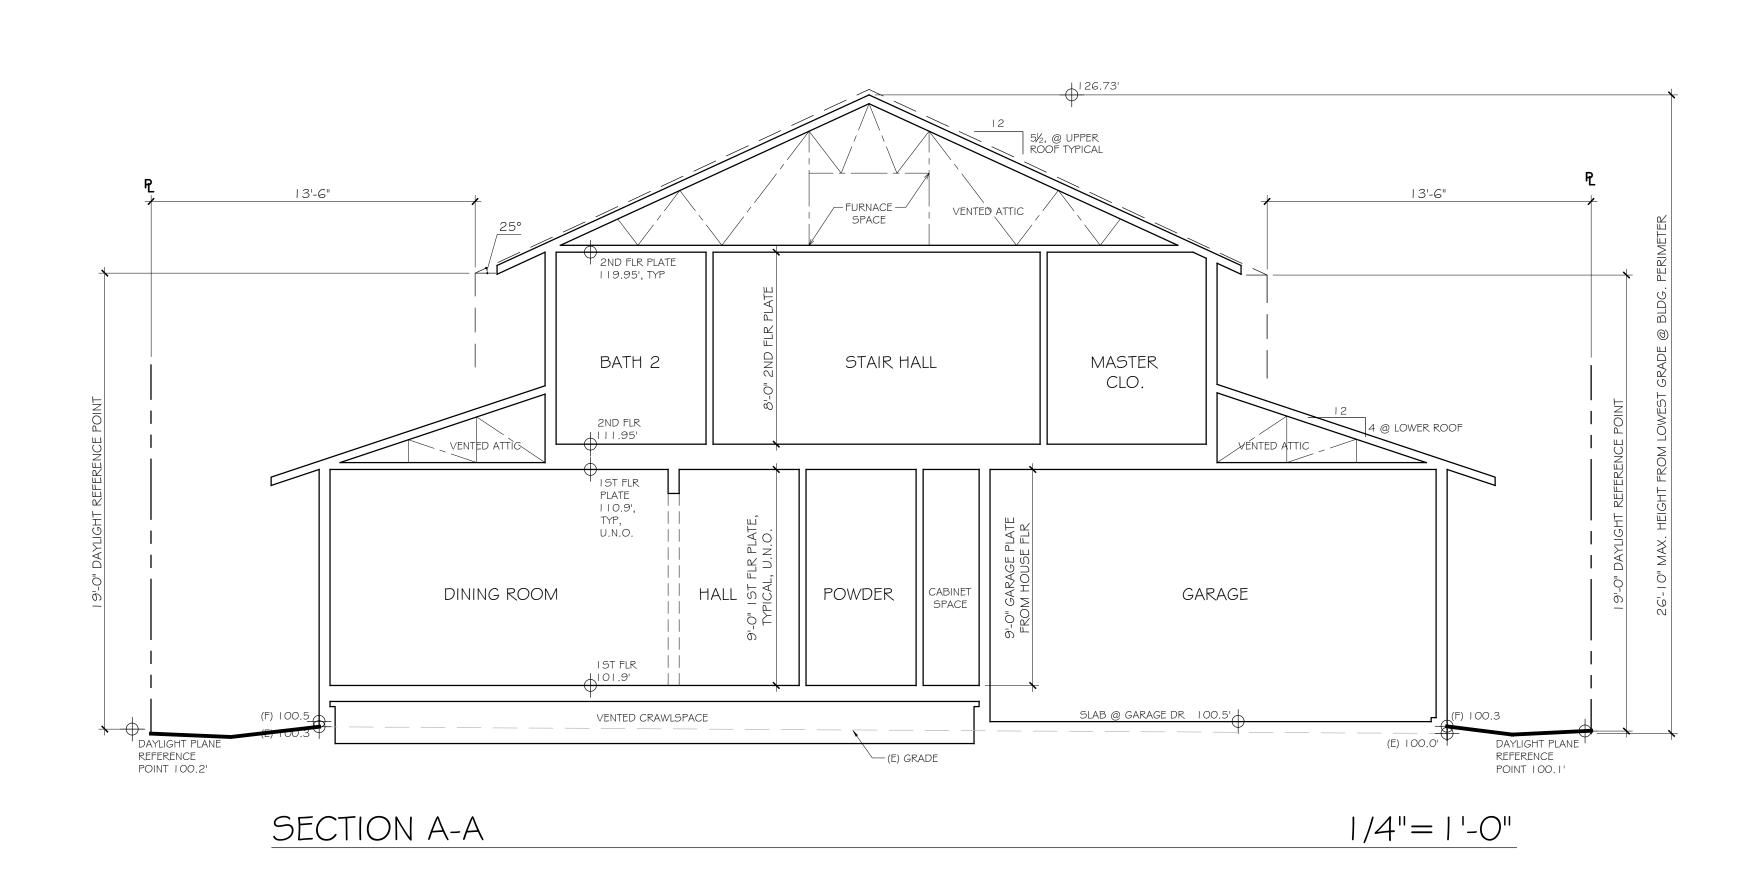

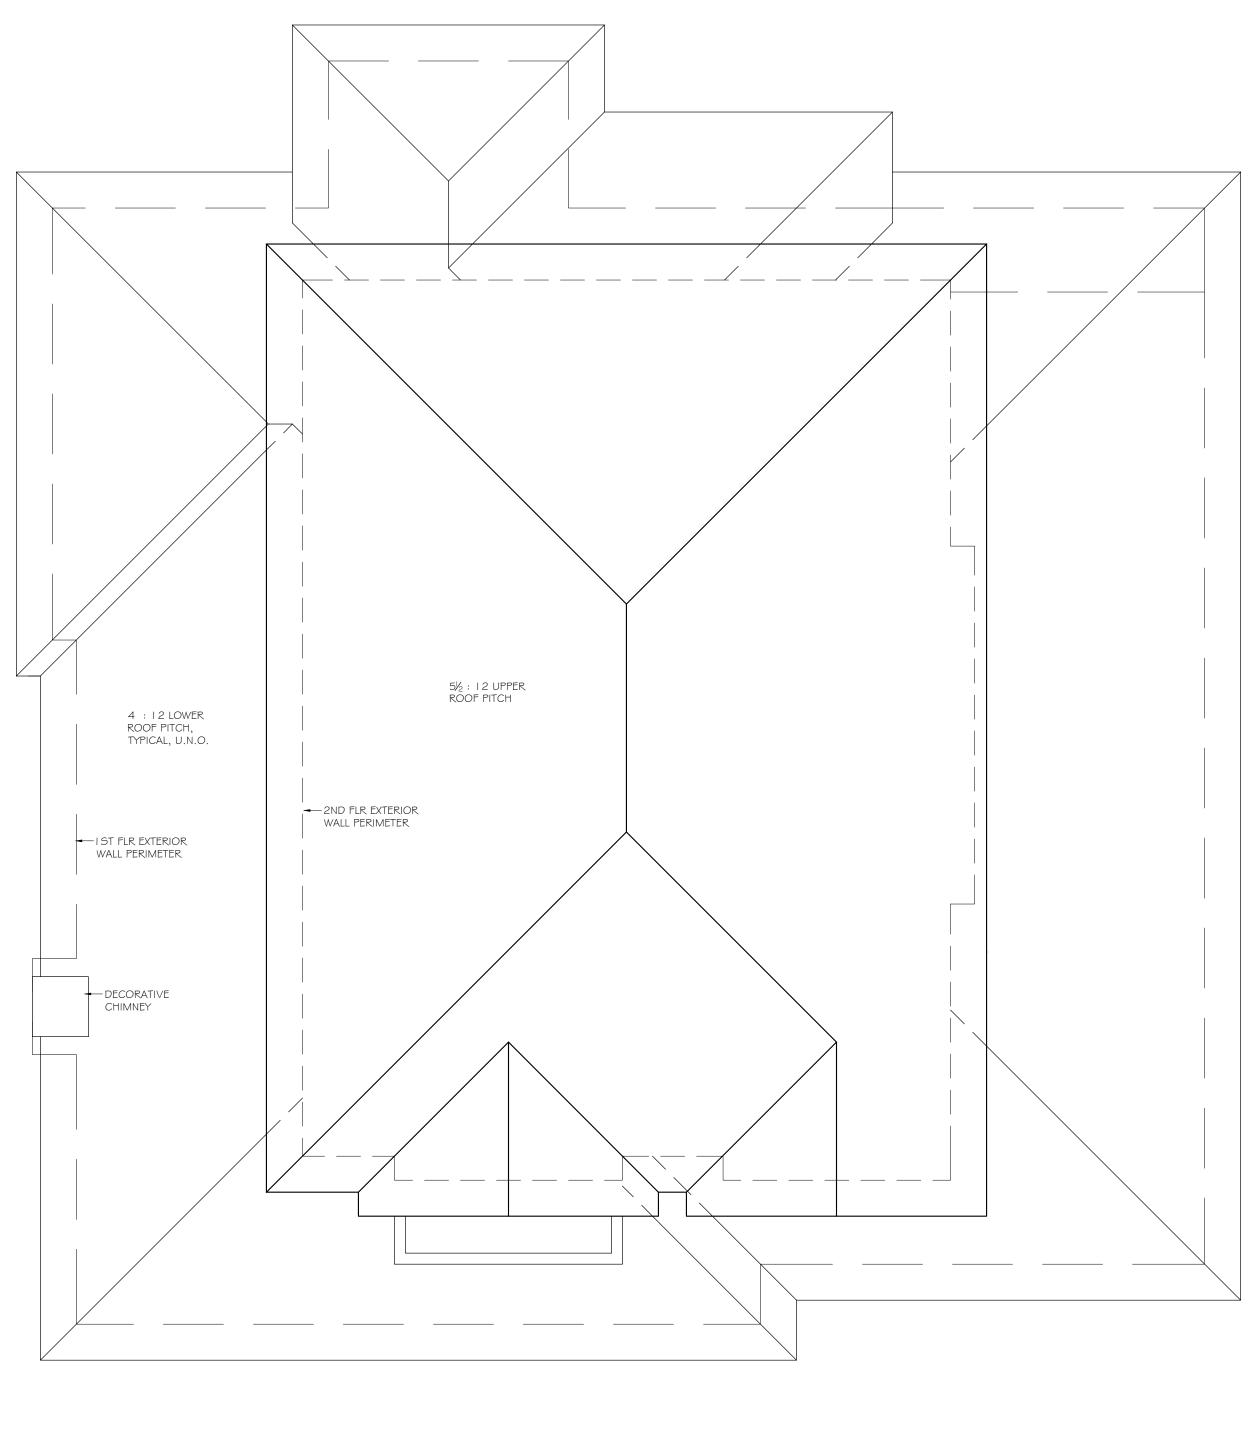





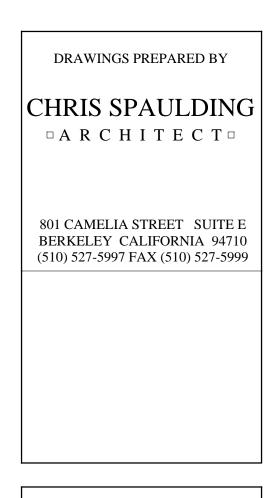


REVISIONS	BY
2- 0- 5	DAN
2- 0- 5 - 4- 6	DAN KD

PRELIMINARY SET	
DESIGN REVIEW SET	
PLAN CHECK SET	
PERMIT SET	
CONSTRUCTION SET	

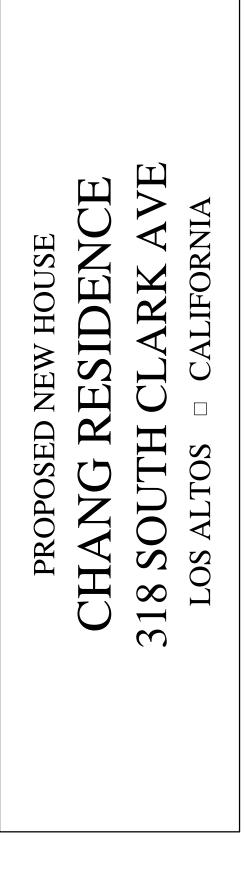

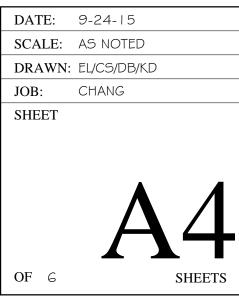

|/4"=|'-0"

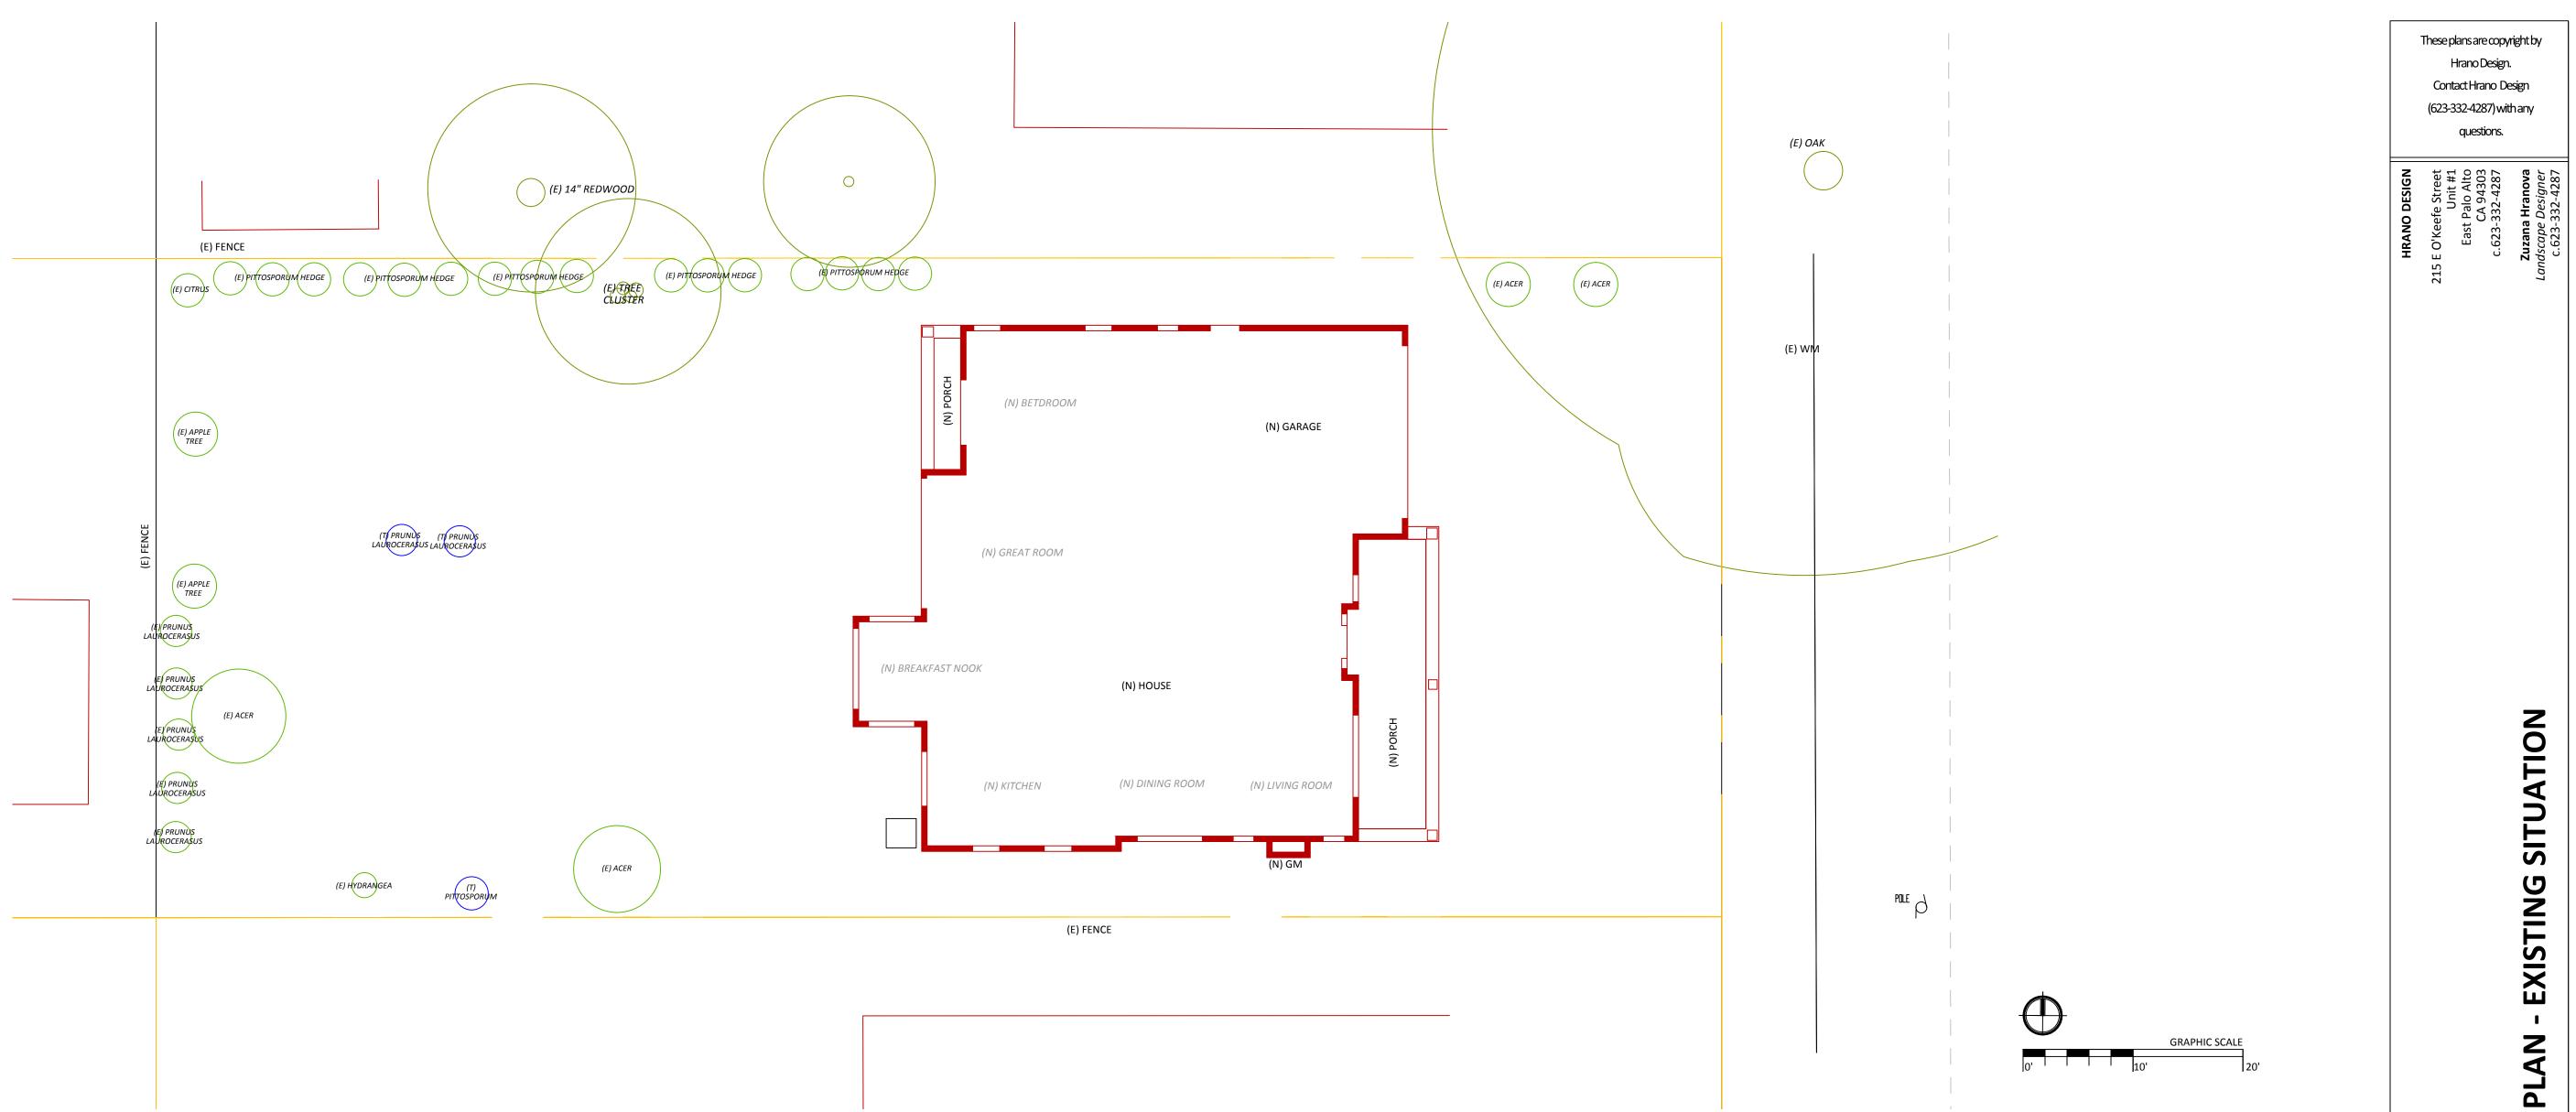

TAKE-OFF AND NOTES: PROPERTY LINES BASED ON SITE SURVEY PLAN.

ABBREVIATION:

- DS DOWNSPOUT
- EL ELECTRIC SOURCE/PLUG
- GM GAS METER HB HOUSE BIB
- S SEWER
- TR LIGHT TRANSFORMER WM WATER METER
- (E) EXISTING PLANT/MATERIAL
- (N) NEW PLANT/MATERIAL (R) REMOVAL PLANT/MATERIAL
- (T) TRANSPLANT PLANT/MATERIAL

DISCLAIMER: ALL PLANT LISTS AND PLANS ARE CONCEPTUAL IN NATURE. THE LANDSCAPE DESIGNER ASSUMES NO RESPONSIBILITY FOR ACCURACY OF SAID BOUNDARIES OR MEASUREMENTS. BEFORE THE COMMENCEMENT OF WORK, THE LANDSCAPE CONTRACTOR SHOULD VERIFY MEASUREMENTS, OBTAIN PERMITS, LOCATE AND MARK ANY PERTINENT PROPERTY LINES, UNDERGROUND UTILITIES, AND EASEMENTS. THE CLIENT MUST INFORM IN WRITING, ANY PERTINENT CONDITIONS, COVENANTS , AND RESTRICTIONS (CC&R'S). THE CLIENT IS RESPONSIBLE FOR COMPLIANCE WITH ALL EASEMENTS, PROPERTY LINE SETBACK REQUIREMENTS, AND NECESSARY PERMITS AND INSPECTIONS. ALL PLANTING MATERIAL RECOMMENDED BY DESIGNER ARE SUBJECT TO THE AFFECTS OF NATURE INCLUDING, BUT NOT LIMITED TO FIRE, FLOOD, FREEZE, AND DROUGHT. HRANO DESIGN DOES NOT GUARANTEE, WARRANTY OR IMPLY RESPONSIBILITY FOR PLANT SURVIVAL OR ADVERSE PLANT REACTIONS TO HUMAN, PETS OR WILDLIFE.

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Los Altos, CA SHEET CONTENTS: GROUNDPLAN scale 1/8"= 1'-0" **DESIGNED BY:** Zuzana Hranova

318 South Clark Avenue

JOB LOCATION:

CONCEPT


CHANG RESIDENCE

DATE: 12-11-2015

PAPER SIZE: 36"x 24"

PLAN NUMBER: 15-023 L1

REVISIONS	BY
1/11/2016	ZH
2/5/2016	ZH

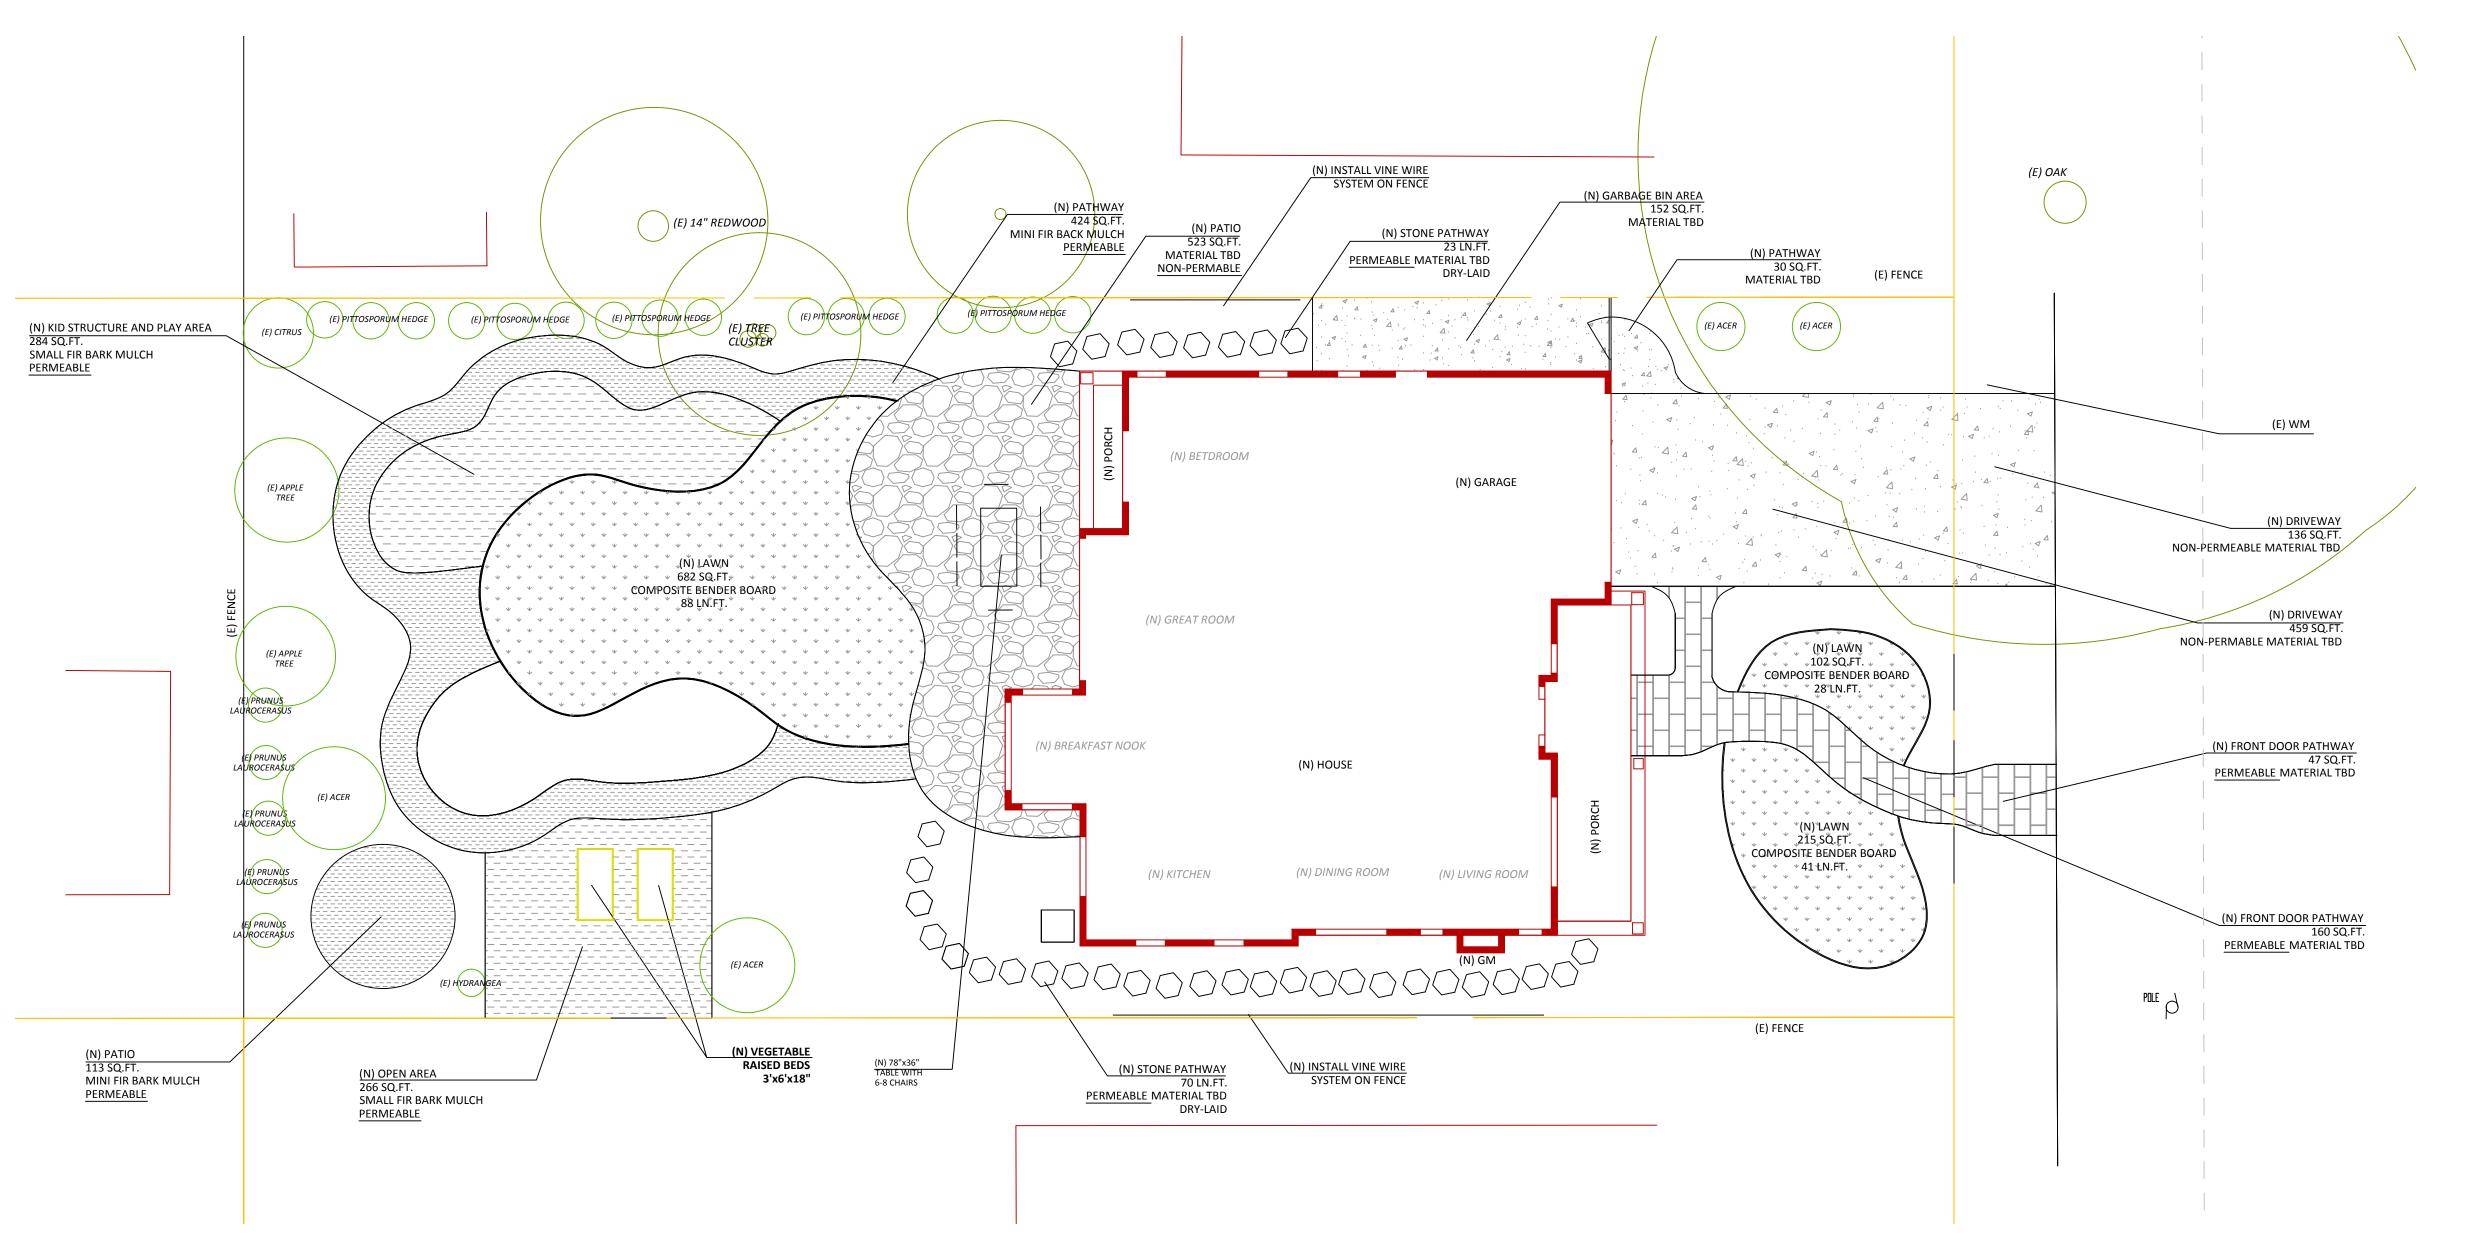


HARDSCAPE AND GRADING NOTES:

- MEET EXISTING GRADES AT PROPERTY LINES AND STREET.

- ALL HARDSCAPE AREAS TO COMPLY WITH THE CITY CODES - HARDSCAPE WITHIN SETBACK AREAS MAY NOT EXCEED A MAXIMUM HEIGHT OF SIX INCHES ABOVE GRADE. - ALL HARDSCAPE FINAL LEVEL SHOULD BE AT THE SAME LEVEL AS FINAL SOIL/MULCH OR LAWN LEVEL.

- AT BUILDING FOUNDATION, SLOPE GRADE AWAY FROM WALLS AT A MIN. OF 2% (OR SLOPE REQUIRED BY CITY). KEEP SOIL 6" MIN. (OR DISTANCE REQUIRED BY CITY) BELOW STUCCO/WOOD OF BUILDING.

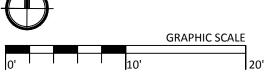

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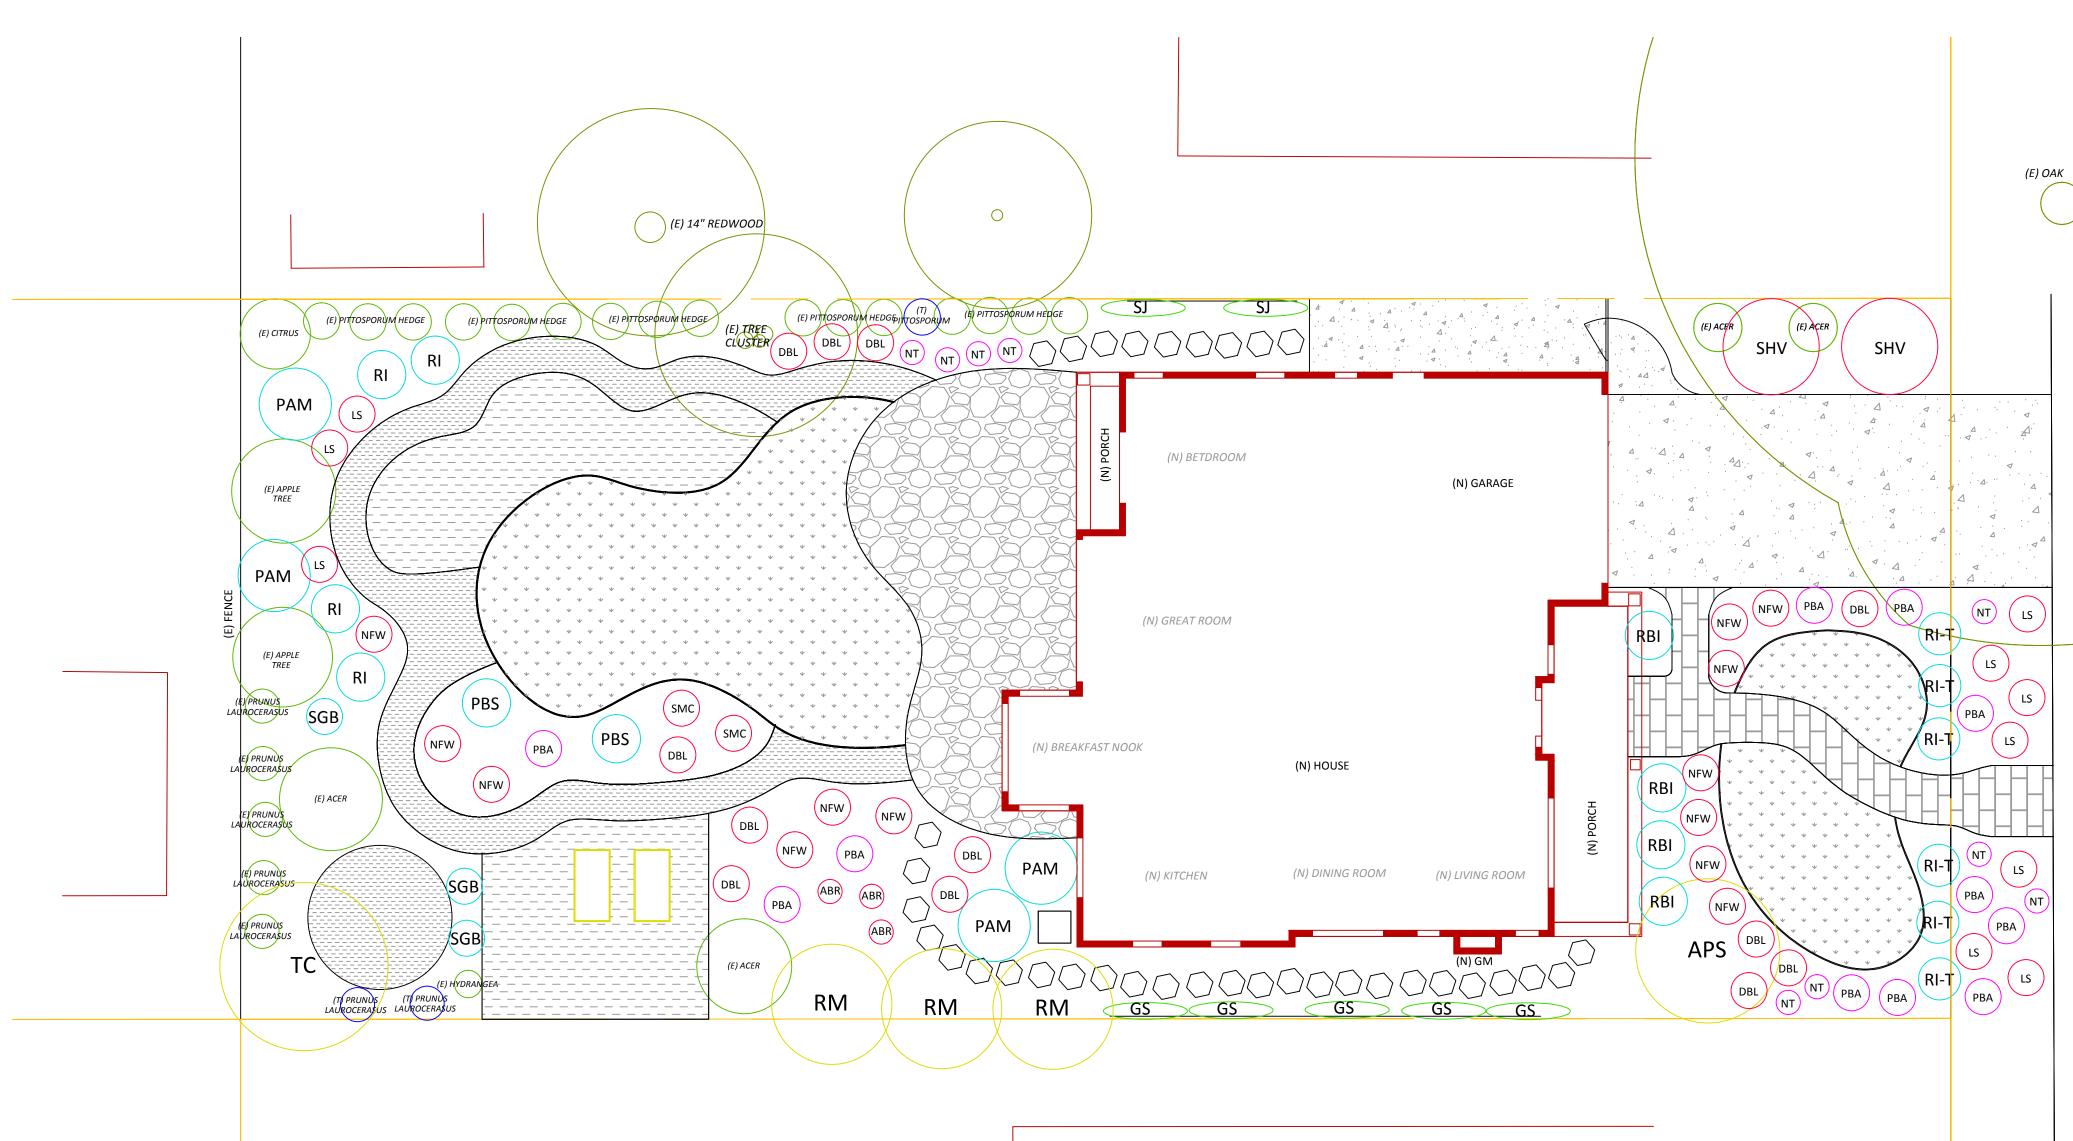
HRANO DESIGN	-	c.623-332-4287	Zuzana Hranova Landscape Designer c.623-332-4287
			CONCEPT PLAN - HARDSCAPE DESIGN
	B LOCA	FION: Clark A	venue
318 Los SHI GR(Altos, (EET COI OUNDP le 1/8"=	NTENTS LAN	:

1/11/2016

2/5/2016

ZH

ΖH



LANDSCAPE LEGEND

SYMBOL	QTY	SIZE	PLANT NAME (height x width)
			TREES:
APS	1	24" box	Acer palmatum - variety to be determine by client
		or 15gal	JAPANESE MAPLE (15'x12') deciduous, all year round interest
тс	1	24" box	Tristania conferta
			BRISBANE BOX (30'x15') evergreen tree
RM	3	15gal	Rhaphiolepis x 'Montic' - STANDARD
		or 24" box	MAJESTIC BEAUTY INDIAN HAWTHORN (20'x10') evergreen, pink fragrant flowers - spring
			SHRUBS:
PBS	2	1gal	Perovskia 'Blue Spire'
			RUSSIAN SAGE (4'x4') evergreen, blue flowers - spring/summer
PAM	4	5gal	Plumbago auriculata 'Monott'
			ROYAL CAPE PLUMBAGO (5'x6') evergreen, blue flowers - sprin/winter
RBI	8	5gal	Rosa x 'Burgundy Iceberg' - SHRUB FORM
			ICEBERG SHRUB ROSE (maintain 4'x4') deciduous, white flowers - spring/fall
RI-T	6	5gal	Rosa x 'Iceberg' - 36" TREE FORM
			ICEBERG SHRUB ROSE (maintain tree form) deciduous, white flowers - spring/fall
SGB	3	1gal	Salvia guaranitica 'Black and Blue'
			ANISE-SCENTED SAGE (4'x3') herbaceous, deep blue flowers - summer/fall
			GROUNDCOVERS/PERENNIALS:
ABR	3	1gal	Anigozanthos 'Big Red'
			KANGAROO PAW (2'x2', flowers up to 5') evergreen, red flowers - spring/fall
DBL	12	1gal	Dietes bicolor 'Liz's Selection' (Moraea b.)
			FORTNIGHT LILY (3'x3') evergreen, yellowish flowers - spring/fall
LS	10	1gal	Lantana sellowiana - color to be determine by client
			TRAILING LANTANA (10"x3') evergreen, purple flowers - all year round
NFW	13	1gal	Nepeta x faassenii 'Walker's Low'
			WALKER'S LOW CATMINT (2'x3') evergreen, violet flowers - summer
SHV	2	1gal	Sarcococca hookeriana var. humilis
			HIMALAYAN SWEET BOX (2'x6') evergreen, white fragrant flowers - spring
SMC	2	1gal	Scaevola 'Mauve Clusters'
			FAIRY FAN FLOWER (1.5'x3') evergreen, blue flowers - year-round

SYMBOL	QTY	SIZE	PLANT NAME (height x width)
			ORNAMENTAL GRASSES:
NT	9	1gal	Nassella tenuissima
			MEXICAN FEATHER GRASS (2'x2') evergreen, movement in wind
PBA	11	5gal	Phormium 'Black Adder'
			BLACK ADDER FLAX (4'x3') evergreen, burgundy leaves
			<u>VINES</u> :
GS	5	1gal	Gelsemium sempervirens
			CAROLINA JESSAMINE (install wire system on fence), evergreen, yellow fragr
SJ	2	1gal	Solanum jasminoides
			POTATO VINE (install wire system on fence), evergreen, white flowers - sprin
			SOIL AMENDMENT:
	4,249	sq.ft.	AMENDMENT MIX (available at Lyngso)
	26	cubic yards	install 2" layer in all planting areas, mix well with existing soil,
			to improve soils for water retention and aeration
	36	sq.ft.	LYNGSO VEGETABLE BLEND (available at Lyngso)
	2	cubic yards	install in vegetable raised beds
			MULCH:
	537	sq.ft.	MINI FIR BARK MULCH (1/2"-1" IN SIZE)
	3.5	cubic yards	2" layer, mulch pathway in backyard and small patio at rear end of garden
	4,560	sq.ft.	SMALL FIR BARK MULCH (1/4"-3/8" IN SIZE)
	42	cubic yards	3" layer, mulch all planting areas PLUS OPEN AREA AND KID PLAY AREA

	HRANO DESIGN	215 E O'Keefe Street Unit #1 East Palo Alto	C.62	ANDSCAPE DESIGN Landscape Designer C.623-332-4287
PILE		RESIDENCE		CONCEPT PLAN - LANI

agrant flowers - spring/summer

ring and fall

TAKE-OFF AND NOTES: PROPERTY LINES BASED ON SITE SURVEY PLAN.

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JOB LOCATION: 318 South Clark Avenue Los Altos, CA

SHEET CONTENTS:

GROUNDPLAN scale 1/8"= 1'-0"


DESIGNED BY:

Zuzana Hranova DATE: 12-11-2015

PAPER SIZE: 36"x 24"

PLAN NUMBER: 15-023 L3

REVISIONS	BY
1/11/2016	ZH
2/5/2016	ZH

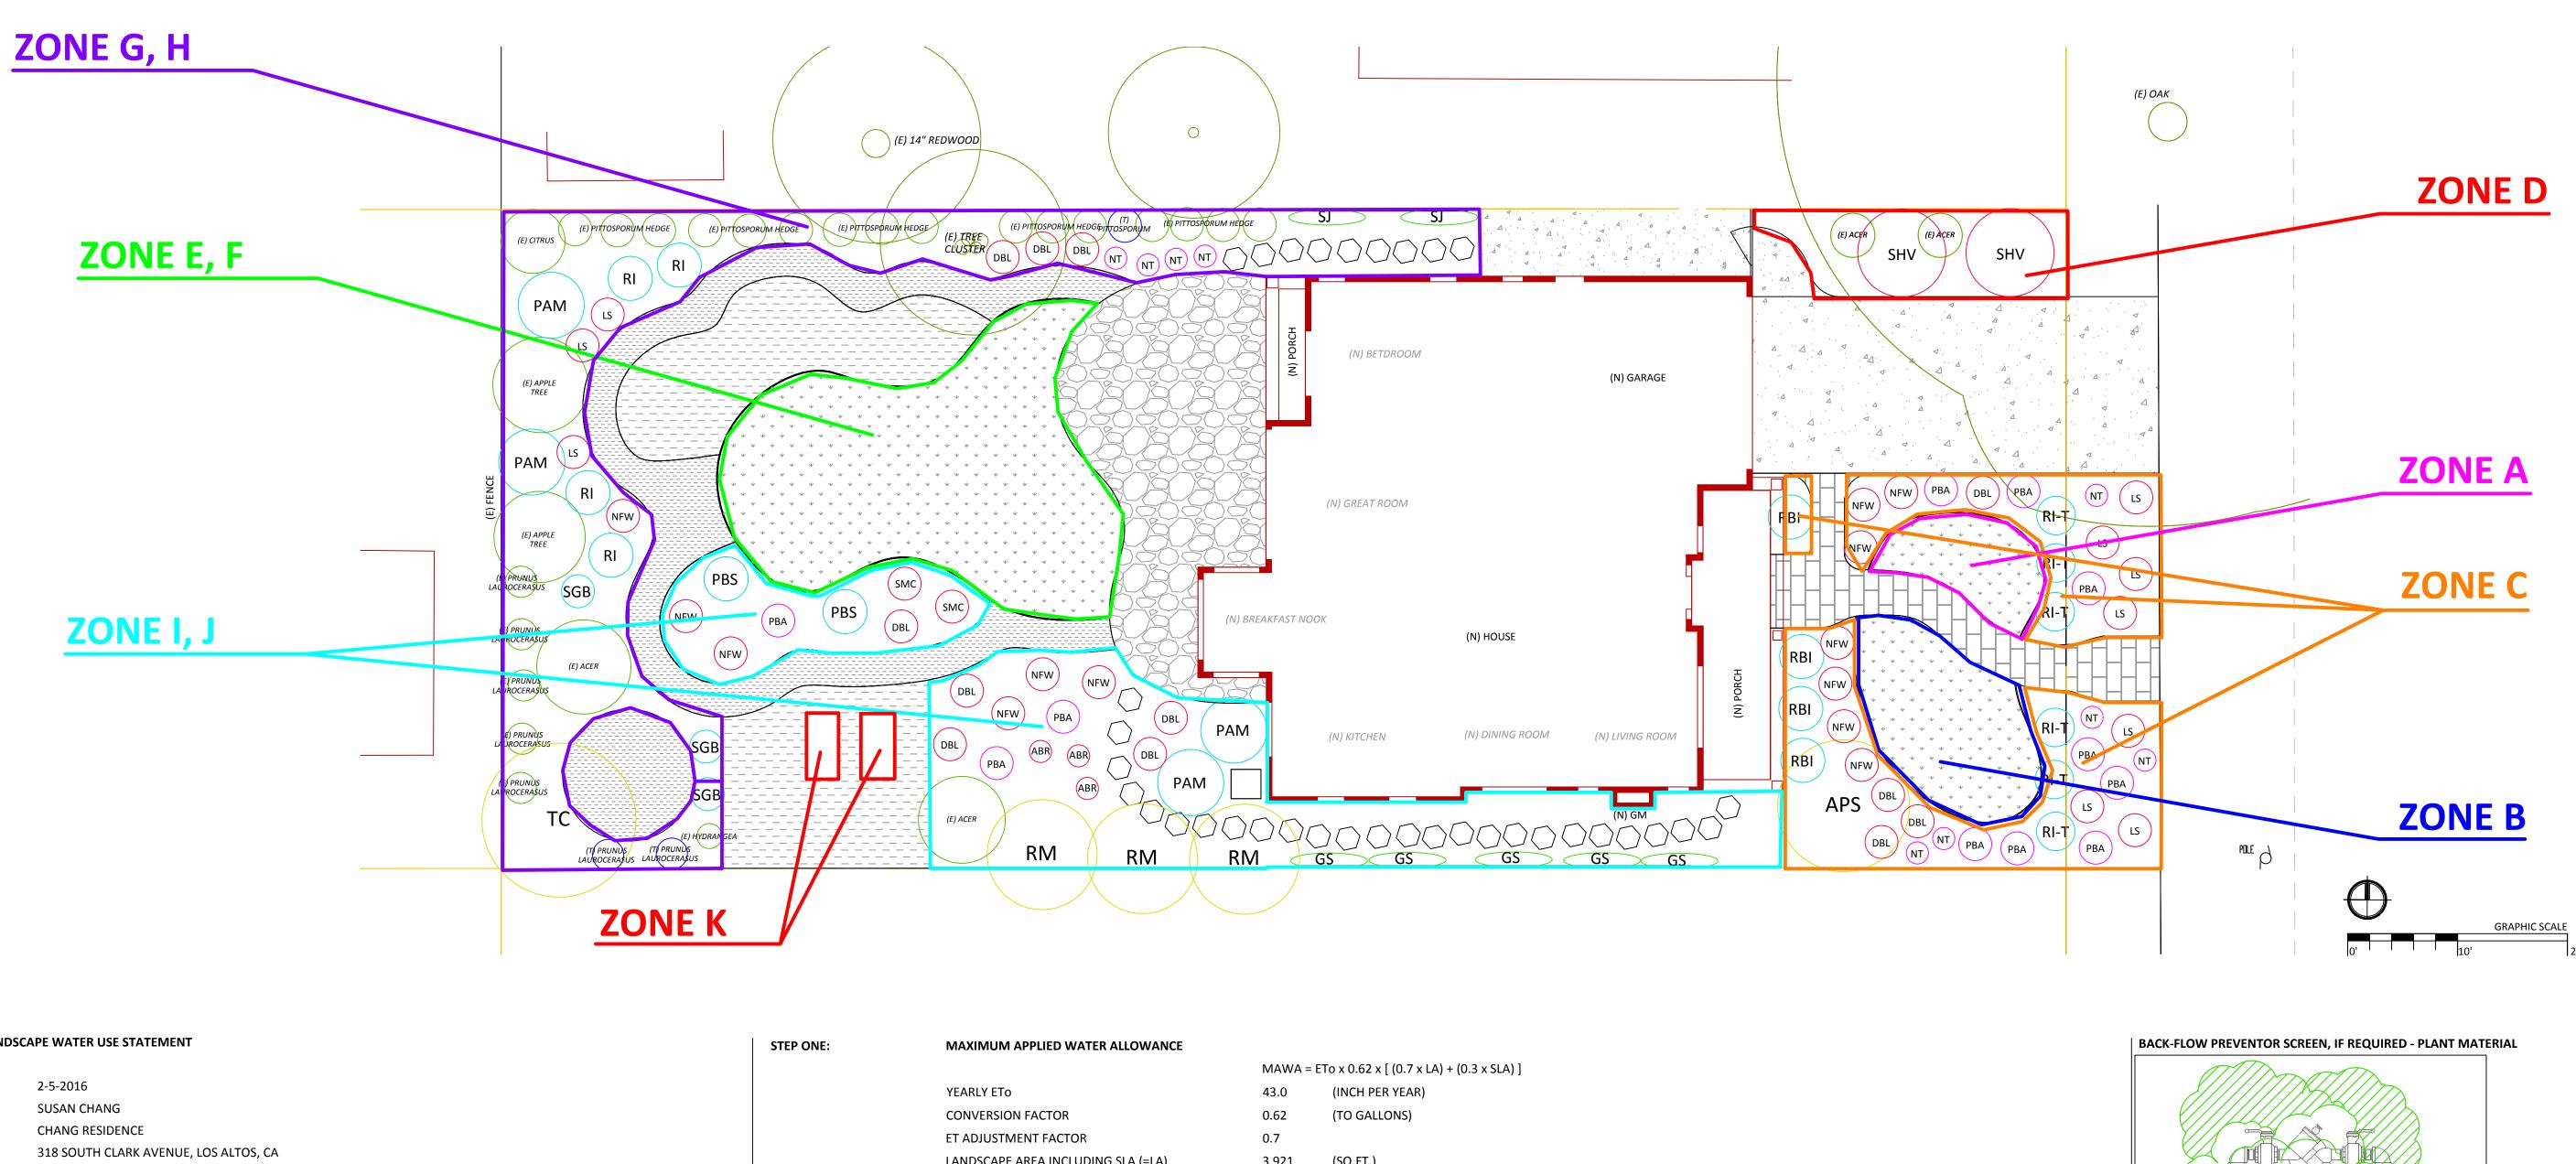

CITY OF LOS ALTOS - LANDSCAPE WATER USE STATEMENT

DATE: PROJECT APPLICANT: PROJECT NAME: PROJECT ADDRESS: LOT SIZE: TOTAL LANDSCAPE AREA: PROJECT TYPE: WATER SUPPLY:

8,550 SQ.FT. 3,921 SQ.FT. (999 SQ.FT. OF TURF AND 2,922 SQ.FT. OF LANDSCAPE) RESIDENTIAL, DEMOLISH EXISTING 1-STORY HOUSE AND BUILD A NEW 2-STORY HOUSE POTABLE

AREA	PERMEABLE OR NON-PERMEABLE	(SQ.FT.)
TOTAL LOT		8,550.00
HARDSCAPE		4,629.00
LANDSCAPE		3,921.00
HARDSCAP	E BREAK DOWN	
HOUSE		1,585.00
GARAGE		387.00
PORCHES		246.00
DRIVEWAY	NON-PERMEABLE	459.00
FRONT PATHWAY	PERMEABLE	160.00
SIDE GARBAGE PATHWAY	NON-PERMEABLE	30.00
GARBAGE BIN AREA	NON-PERMEABLE	152.00
ΒΑϹΚ ΡΑΤΙΟ	NON-PERMEABLE	523.00
BACK PATHWAY	PERMEABLE	424.00
ΒΑϹΚ ΡΑΤΙΟ	PERMEABLE	113.00
OPEN AREA BY VEGETABLE BEDS	PERMEABLE	266.00
KID PLAY AREA	PERMEABLE	284.00

CALCULATION:

HYDROZONE TABLE AND ETWU

HYDROZC

IRRIGATIO MULTI-STRE

SPRAY ROTOR BUBLLER DRIP IN-LINE DRI

OTHER

STEP TWO:

CALCULATION:

LANDSCAPE AREA INCLUDING SLA (=LA) ADDITIONAL WATER ALLOWANCE FOR SLA SPECIAL LANDSCAPE AREA (=SLA) LANDSCAPE WATER ALLOWANCE TOTAL HUNDRED-CUBIC-FEET PER YEAR

3,921 (SQ.FT.) 0.3 (SQ.FT.) 36 73,461.63 (GALLONS PER YEAR) 98.21 (HUNDRED-CUBIC-FEET PER YEAR)

MAWA = 43 x 0.62 x [(0.7 x 3,921) + (0.3 x 36)] =73,461.63


			н	IYDROZONE TAB	LE			
				% OF LANDSCAPE	PLANT WATER USE		HYDROZONE AREA	
ZONE TABLE	ZONE OR VALVE	IRRIGATION METHOD	AREA (SQ.FT.)	AREA	ТҮРЕ	PLANT FACTOR (PF)	(HA) (SQ.FT.)	PF x HA (SQ.FT.)
HW	ZONE A, B	MSR	317.00	8.08%	high	0.7	317.00	221.9
MW	ZONE C	D	504.00	12.85%	medium	0.5	504.00	252
LW	ZONE D	D	200.00	5.10%	low	0.3	200.00	60
HW	ZONE E, F	MSR	682.00	17.39%	high	0.7	682.00	477.4
MW	ZONE G, H,	D	1,167.00	29.76%	medium	0.5	1,167.00	583.5
LW	ZONE I, J	D	1,015.00	25.89%	low	0.3	1,015.00	304.5
		SUM	3,885.00	99.08%		SUM	3,885.00	1,899.30
SLA	ZONE K	ILD	36.00	0.92%	SLA	1	36	36
		SUM	3,921.00	100.00%				
			% OF LANDSCAPE]	PLANT WATER USE			% OF LANDSCAPE
ION METHOD		TOTAL SQ.FT.	AREA		ТҮРЕ		TOTAL SQ.FT.	AREA
REAM ROTOR	MSR	999.00	25.48%		COOL SEASON TURF	CST	0	0.00%
	S	0	0.00%		WARM SEASON TURF	WST	999.00	25.48%
	R	0	0.00%		HIGH WATER USE	HW	0	0.00%
	В	0	0.00%		MEDIUM WATER USE	MW	1,671.00	42.62%
	D	2,886.00	73.60%]	LOW WATER USE	LW	1,215.00	30.99%
DRIP	ILD	36.00	0.92%]	SPECIAL LAND. AREA	SLA	36.00	0.92%
	0	0.00	0.00%					

ESTIMATED TOTAL WATER USE

ETWU = ETo x 0.62 { [(PF x HA) / IE] + SL }

ETWU = 43 x 0.62 { [1,899.3 / 0.71] + 36} = 72,277.13

ESTIMATED TOTAL WATER USE TOTAL HUNDRED-CUBIC-FEET PER YEAR 72,277.13 (GALLONS PER YEAR) 96.63 (HUNDRED-CUBIC-FEET PER YEAR)

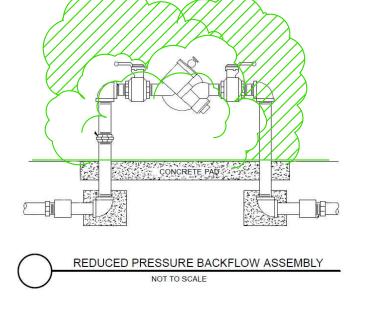

TAKE-OFF AND NOTES: PROPERTY LINES BASED ON SITE SURVEY PLAN.

ABBREVIATION:

DS	DOWNSPOUT

- EL ELECTRIC SOURCE/PLUG GM GAS METER
- HB HOUSE BIB

DISCLAIMER:

- S SEWER TR LIGHT TRANSFORMER
- WM WATER METER
- (E) EXISTING PLANT/MATERIAL (N) NEW PLANT/MATERIAL
- (R) REMOVAL PLANT/MATERIAL
- (T) TRANSPLANT PLANT/MATERIAL

ALL PLANT LISTS AND PLANS ARE CONCEPTUAL IN NATURE. THE LANDSCAPE DESIGNER ASSUMES NO RESPONSIBILITY FOR ACCURACY OF SAID BOUNDARIES OR MEASUREMENTS. BEFORE THE COMMENCEMENT OF WORK, THE LANDSCAPE CONTRACTOR SHOULD VERIFY MEASUREMENTS, OBTAIN PERMITS, LOCATE AND MARK ANY PERTINENT PROPERTY LINES, UNDERGROUND UTILITIES, AND EASEMENTS. THE CLIENT MUST INFORM IN WRITING, ANY PERTINENT CONDITIONS, COVENANTS , AND RESTRICTIONS (CC&R'S). THE CLIENT IS RESPONSIBLE FOR COMPLIANCE WITH ALL EASEMENTS, PROPERTY LINE SETBACK REQUIREMENTS, AND NECESSARY PERMITS AND INSPECTIONS. ALL PLANTING MATERIAL RECOMMENDED BY DESIGNER ARE SUBJECT TO THE AFFECTS OF NATURE INCLUDING, BUT NOT LIMITED TO FIRE, FLOOD, FREEZE, AND DROUGHT. HRANO DESIGN DOES NOT GUARANTEE, WARRANTY OR IMPLY RESPONSIBILITY FOR PLANT SURVIVAL OR ADVERSE PLANT REACTIONS TO HUMAN, PETS OR WILDLIFE. PLANT LIST:

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HRANO DESIGN 215 E O'Keefe Street Unit #1 East Palo Alto CA 94303 C.623-332-4287 C.623-332-4287 Landscape Designer C.623-332-4287				
CHANG RESIDENCE CONCEPT PLAN - SIMPLIFIED IRRIGATION PLAN				
JOB LOCATION: 318 South Clark Avenue Los Altos, CA				

SHEET CONTENTS: GROUNDPLAN scale 1/8"= 1'-0"

DESIGNED BY:

Zuzana Hranova DATE: 12-11-2015

PAPER SIZE: 36"x 24"

PLAN NUMBER: 15-02314

	r
REVISIONS	BY
1/11/2016	ZH
2/5/2016	ZH